

ddr edc PN: VYV

Tel: (928) 607-7092



JOB NO:	21-38
DRAWN BY:	JS/BL
DATE:	7-27-2021
SCALE:	1" = 20'
REVISIONS:	

SHEET

Field measurements used to prepare this plat were made during July, 2021. Basis of Bearing and/or Coordinates: All dimensions shown on this plat are measured and based on the following projection information. Linear Unit: International Foot Geodetic Datum: North American Datum of 1983(NAD83)

Projection: Sedona Low Distortion Projection (Transverse Mercator) Latitude of Grid Origin: N 34°44'00" Longitude of Grid Origin: W 111°48'00" Northing at Grid Origin: 50000.000 ft. Easting at Grid Origin: 0.000 ft.

Combined Scale Factor = 1.000206 Vertical Datum: NAVD 88 Geoid Model = GEOID18

The basis of bearings is true geodetic north. Grid bearings shown hereon do not equal geodetic bearings due to meridian convergence. All bearings shown are grid bearings.

This survey was conducted using GPS referenced to the National Spatial Reference System. Coordinates for GPS control points were derived using the Nation Geodetic Survey's, Online Positioning User Service (OPUS) REF FRAME: NAD_83(2011)(EPOCH:2010.0000).

The following documents were referred to during the course of the survey and preparation of this plat:

R1) Warranty Deed, Instrument No. 2017-0053440 R2) Record of Survey, Book 123 of Land Surveys, Page 12

R3) Record of Survey, Book 74 of Land Surveys, Page 83 R3) Record of Survey, Book 198 of Land Surveys, Page 26

Field measurements included locations of readily visible surface appurtenances of underground utilities, and evidence of utilities on or above the surface of the surveyed property as observed in the process of conducting the fieldwork, which evidence may indicate utilities located on, over or beneath the surveyed property. No record as-built utility information was provided therefore none is shown hereon. No excavations or other direct determinations of underground utility locations were made.

Documents used to prepare this survey were referenced in the Commitment for Title Insurance issued by Stewart Title Guaranty Company, File No. 154677EW, with a Commitment date of June 23, 2021 at 7:30 AM.

The following listing of Schedule B - Section 2 exceptions are from the above stated Commitment for Title Insurance. No attempt was made to resolve discrepancies if any, in easement documents. No attempt was made to research recorded or unrecorded easements, other than those listed in Schedule B - Section 2 exceptions of the above stated commitment for title insurance.

Following are the Schedule B - Section 2 exceptions listed: <u>Item No. – Instrument Type; Recording reference; Status for this</u>

Item 1 Not Survey Related. Items 2 to 5 — Deleted Intentionally in the Commitment. Items 6 to 7 - Not Survey Related. Item 8 - Deleted Intentionally in the Commitment. Items 9 to 10 - Not Survey Related.

Items 11 to 12 - Deleted Intentionally in the Commitment. Item 13 - Easement(s) for telephone lines and incidental purposes; Book 517, Page 90 of Official Records; This instrument describes an easement 40' in width centered on a telephone line which existed in the vicinity of the Subject Parcel in 1967. The location map attached is to this instrument is illegible and therefor the easement is not plottable and Not Shown Hereon.

Item 14 - Easement(s) for road and incidental purposes; Book 519, Page 520 of Official Records. This instrument describes a right of way 66' in width for an existing roadway as shown on an attached map. The map does not specify which roadway the easement applies to therefor the easement is Not Shown Hereon.

Item 15 - Easement(s) for road and incidental purposes; Book 521, Page 521 of Official Records. This instrument describes a right of way 24' in width for an existing roadway as shown on an attached map. The map does not specify which roadway the easement applies to, however other recorded instruments indicate that this is the original easement for Posse Ground Road. Records indicate that the 24' is the easterly portion of the current 50' wide right of way with an additional 36' taken from the parcel on the west side of the right of way. The easement is Shown Hereon.

Item 16 - Easement for sign and incidental purposes; Book 524, Page 377 of Official Records: This instrument describes an easement for a sign that existed in the vicinity of the subject parcel in 1967; Not Shown Hereon. Item 17 - Easement for highway and incidental purposes; Recorded in Book 520 of Surveys, Page 585; This instrument describes an easement for SR89A in the SE1/4 of Section 12; The document is somewhat illegible and not plottable. This easement has been superseded by current SR89A right of way; Not Shown Hereon.

Item 18 - Deleted Intentionally in the Commitment.

Item 19 - Easement(s) for electric lines and incidental purposes; Book 811, Page 650 of Official Records; This instrument describes an easement for electric lines 6' in width along the easterly boundary of the Subject Parcel. Shown Hereon.

Item 20 - Easement(s) for electric lines and incidental purposes; Book 1351, Page 182 of Official Records; Blanket easement, not definable; Not Shown

Item 21 - Easement(s) for electric lines and incidental purposes; Book 1351, Page 321 of Official Records; Blanket easement, not definable; Not Shown

Items 22 to 25 - Deleted Intentionally in the Commitment.

Special Survey Note: Arizona Department of Transportation through the resolution of abandonment recorded in Book 4803, Page 741 transfered the right of way for SR89A in the vicinity of the Subject Parcel to the City of Sedona. The abandonment however did not reference the most current set of right of way plans. The most current right of way plans referenced hereon shows what appears to be ADOT right of way projecting into the Posse Ground Road right of way. The ADOT right of way projecting into the Posse Ground Road right of way overlaps the Subject Parcel's westerly line per the R1 deed by ~1.0'. It is unclear as to the underlying rights of the portion of the Posse Ground Road shown on the ADOT right of way plans. It's our opinion that the deed for the Subject Parcel is senior and correct and takes precedence over the monumentation set by ADOT in this location.

Certification :

To Durban Development and Stewart Title Guaranty Company: This is to certify that this map or plat and the survey on which it is based were made in accordance with the 2021 Minimum Standard Detail Requirements for ALTA/NSPS Land Title Surveys, jointly established and adopted by ALTA and NSPS, and includes Items 1, 2, 3, 4, 5, 6(b), 7(a), 8, 9, 11(a), 13, 16, and 17 of Table A thereof. The fieldwork was completed on February 17th, 2021.

tolut kida 7-27-2021

Legal Description:


Referenced in the commitment for title insurance issued by Stewart Title Guaranty Company, File No. 154677EW, with a commitment date of June 23, 2021 at 7:30 AM.


Description for a portion of Lot 1 and Lot 2 of Section 12, Township 17 North, Range 5 East of the Gila and Salt River Base and Meridian, Yavapai County, Arizona, more particularly described as follows: To find the TRUE POINT OF BEGINNING begin at the Southwest corner of Lot 1 of


said Section 12: THENCE North 00 degrees, 39 minutes, 00 seconds East, 133.36 feet to a point on the Northerly right of way line of Highway 89A; THENCE South 81 degrees, 10 minutes, 00 seconds East, 218.70 feet along said Northerly right of way line of Highway 89A to the Southwest corner of the


McFadden property and the TRUE POINT OF BEGINNING, THENCE North 18 degrees, 40 minutes, 00 seconds East, 167.45 feet along the East side of Posse Ground Road; THENCE South 81 degrees, 10 minutes, 00


seconds East, 97.40 feet;

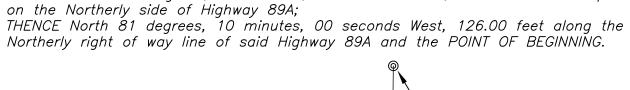


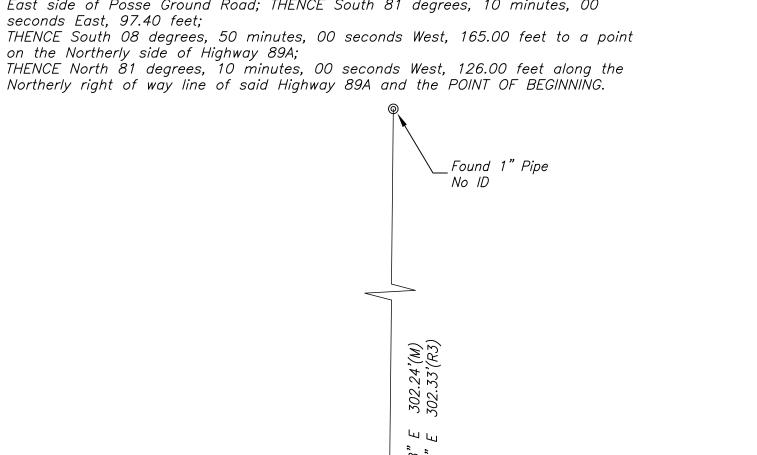

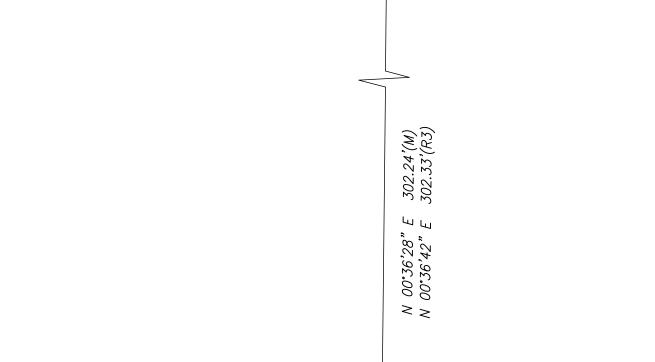

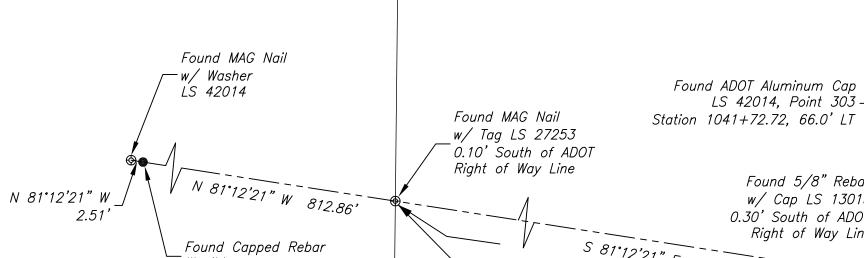

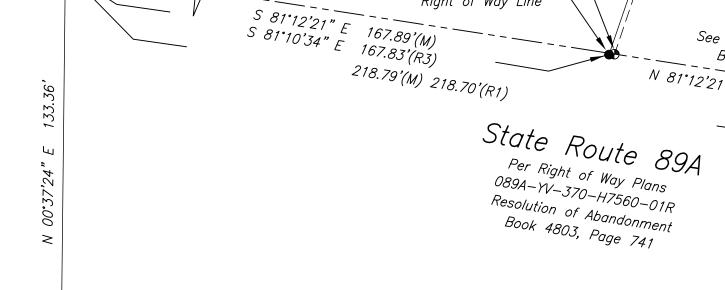

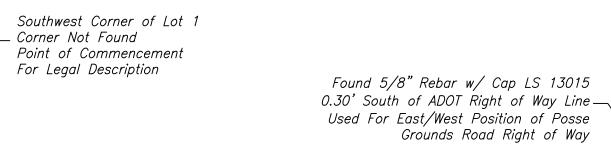

Found ADOT Aluminum Cap

LS 42014, Point 303 —

Found 5/8" Rebar

w/ Cap LS 13015

0.30' South of ADOT —


Right of Way Line

Per Right of Way Plans

089A-YV-370-H7560-01R

Resolution of Abandonment

Book 4803, Page 741

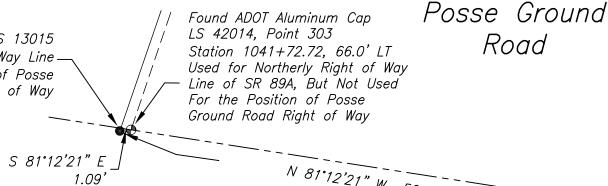

S 81°16'24" E 264.43'(M)

S 81°15'09" E 264.42'(R3)

Found 5/8" Rebar

w/ Cap LS 13015

Found 1" Pipe

No ID

Project

Location

Robinson John M. & Vivian A.

Family Trust

Book 4057, Page 613

APN: 408-25-038

Found ADOT Aluminum Cap

Station 1041+94.76, 193.43 LT

LS 42014, Point 7169 —

See Detail A

N 81°12'21" W 50.90'

Found ADOT Aluminum Cap LS 42014, Point 235 Station 1042+23.46, 66.0' LT — Used for Northerly Right of Way Line of SR 89A, But Not Used N 81°12'21" W 50.90' State Route 89A

N 81°44'17" W 49.70'

N 81°22'07" W 73.91'(M&R2)

Calculated Position

Marley-Dog Holdings LLC

Instrument 2017-0027617

APN: 408-25-038D

S 81.11'18" E 97.54'(M)

S 81°10'00" E 97.40'(R1)

Found Capper Rebar

LS 14184

Found ADOT Aluminum Cap

Station 1042+44.03, 184.91 LT

Subject Parcel

Instrument No. 2017-0053440

 $Area = 18409 \ Sq. \ Ft.(0.423 \ Acres \pm)$

Flood Zone X (Area of Minimal Flood Hazard)

Community Panel: 04025C1435G

Zoning Setback: Not Provided by Client

No Evidence of Recent Earth Movina

Found ADOT Aluminum Cap

Station 1043+49.20, 66.0' LT

LS 42014, Point 8554 —

LS 42014, Point 7168

See Special Survey Notes

N 71°28'13" W

Found ADOT Aluminum Cap

See Special Survey Notes

Station 1042+23.46, 66.0' LT

LS 42014, Point 235

Set 1/2" Rebar w/

R2 and R3

_ Aluminum Cap LS18297

Position Established Per

Nothing Found or Set

S 81°06'36" E 149.76'(M) S 81°09'06" E 150.00'(R4)

Found Capped Rebar

LS 29263

Found Nail w/

Washer LS 29263

Fun Properties LLC

Instrument 2021-0019528

APN: 408-25-367A

Found Capper Rebar

_ _LS 14184`

Schedule B, Part II

Found Capped Rebar

On Property Line, 4.85'

From Calculated Position

N 81°12'21" W 150.07'(M)

N 81°09'07" W 150.07 ("")

Found Capped Rebar

0.22' South of ADOT

Right of Way Line

LS 21283

6.0' Wide Electric Easement

Item 19

LS 14184

Calculated Position

Nothing Found or Set

For the Position of Posse Ground Road Right of Way

Set 1/2" Rebar w/

Aluminum Cap LS18297 Position Established Per R2 and R3

Road


N 81°12'21" W 125.90'(M)

N 81°10'00" W 126.00'(R1)

John A. Luckow

Date

1 of 3

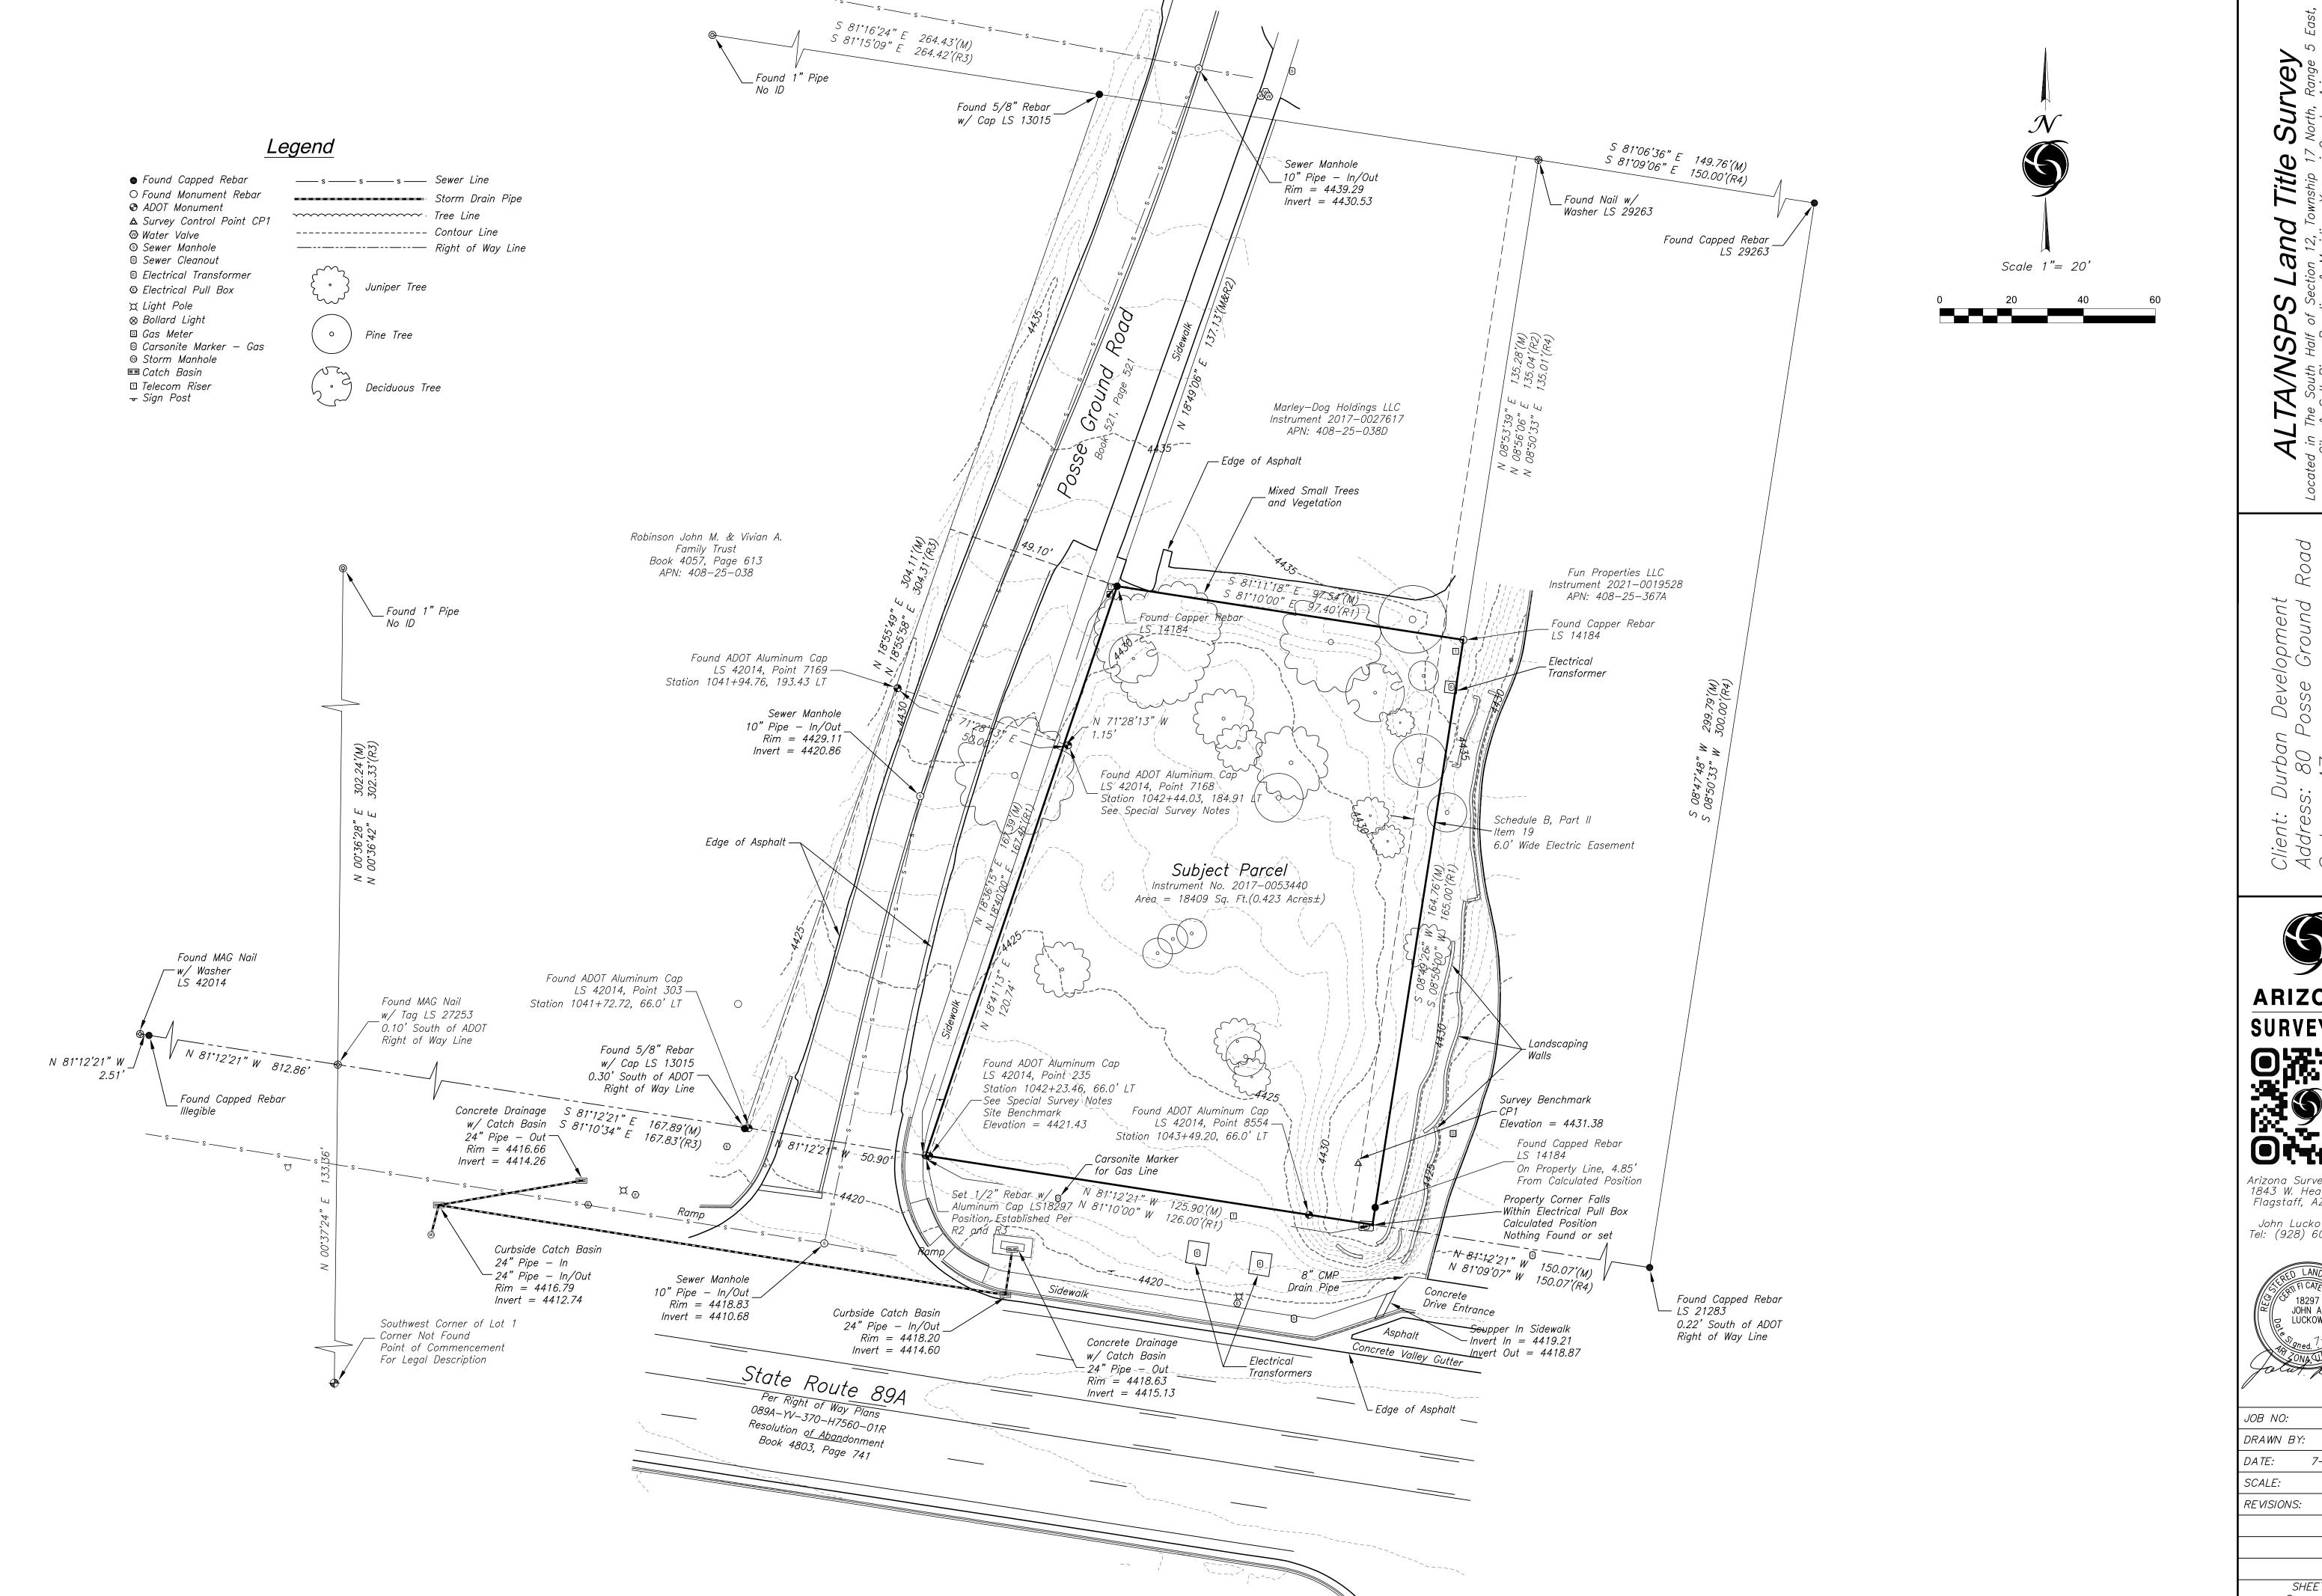

Survey
7 North, Range 5
County, Arizona **and** ALTA/NSPS , sed in The South Half of Sec Gila & Salt River Baseline

Client: Durban Development Address: 80 Posse Ground F Sedona, AZ APN: 408-25-038R





Arizona Surveying, Inc 1843 W. Heavenly Ct Flagstaff, AZ 86001 John Luckow, RLS Tel: (928) 607-7092



JOB NO:	21–38
DRAWN BY:	JS/BL
DATE:	7-27-2021
SCALE:	1" = 20'
REVISIONS:	

SHEET 2 of 3

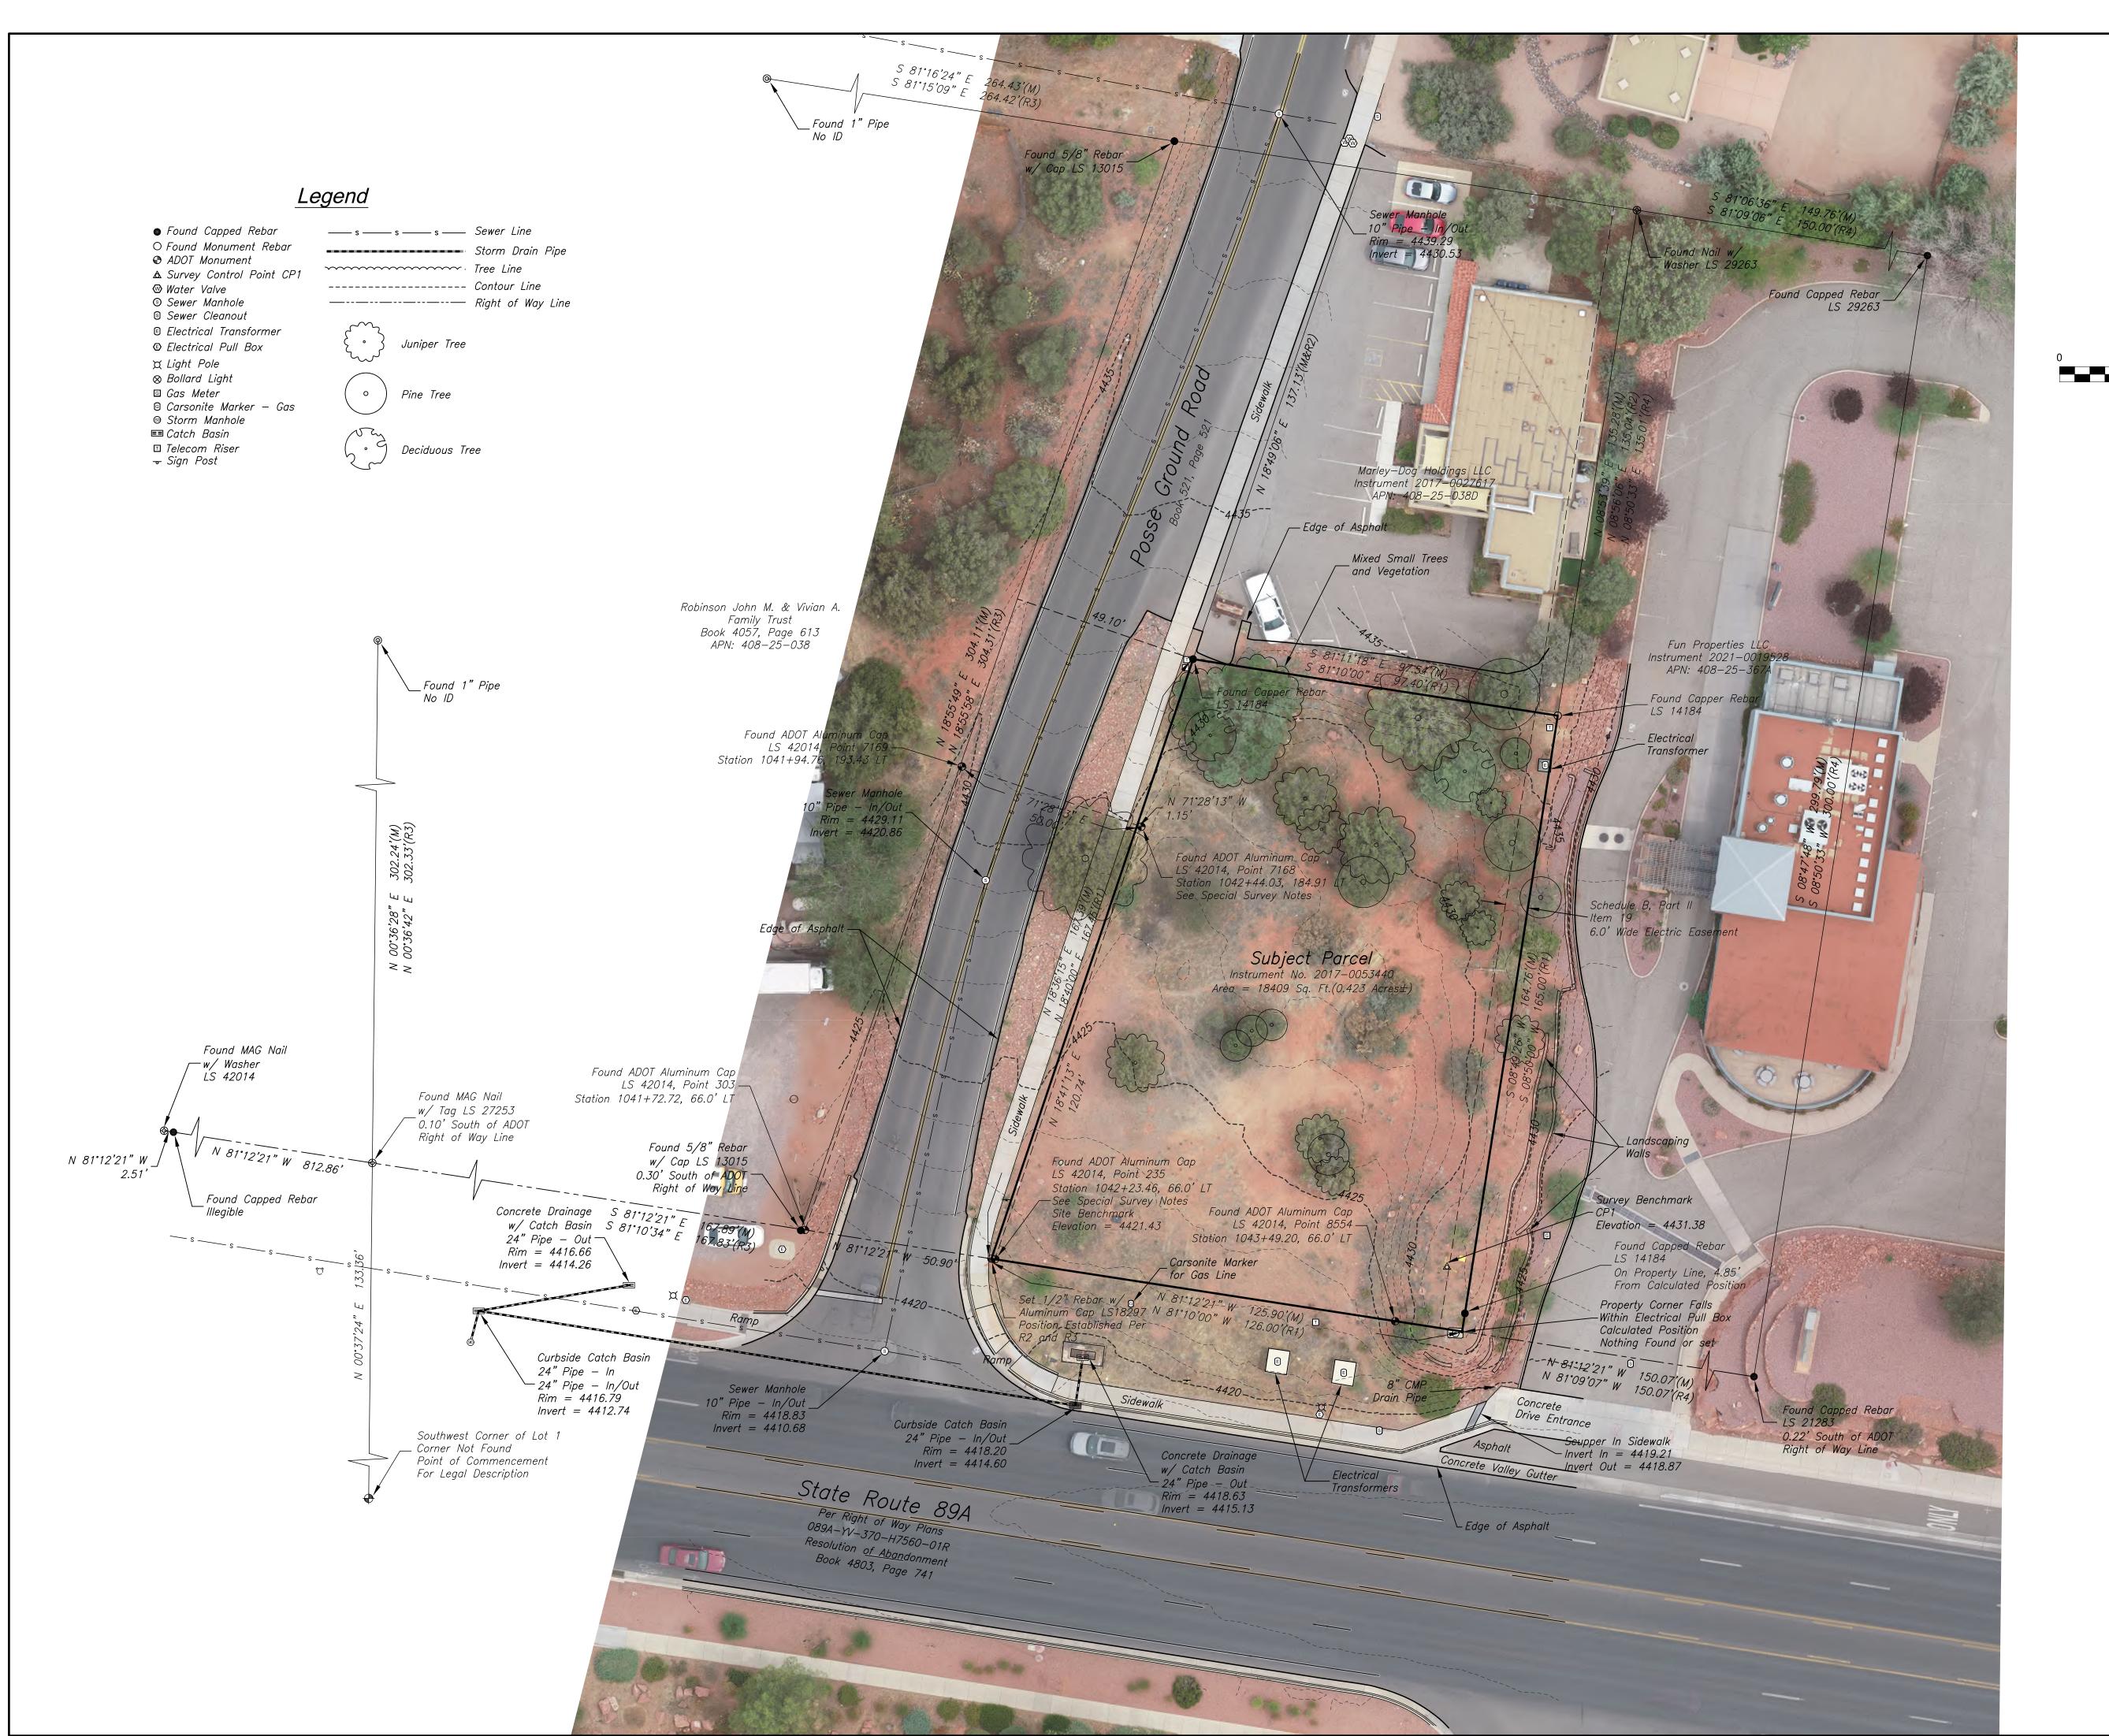

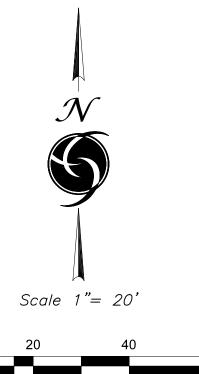

Client: Dur Address: 8 Sedona, A_L APN: 408-

Survey


North, Range 5

Title

and


ALTA/NSPS , sid in The South Half of Sec


Arizona Surveying, Inc 1843 W. Heavenly Ct Flagstaff, AZ 86001 John Luckow, RLS Tel: (928) 607-7092

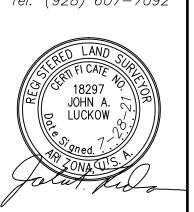


JOB NO:	21-38
DRAWN BY:	JS/BL
DATE:	7-27-2021
SCALE:	1" = 20'
REVISIONS:	

SHEET 3 OF 3

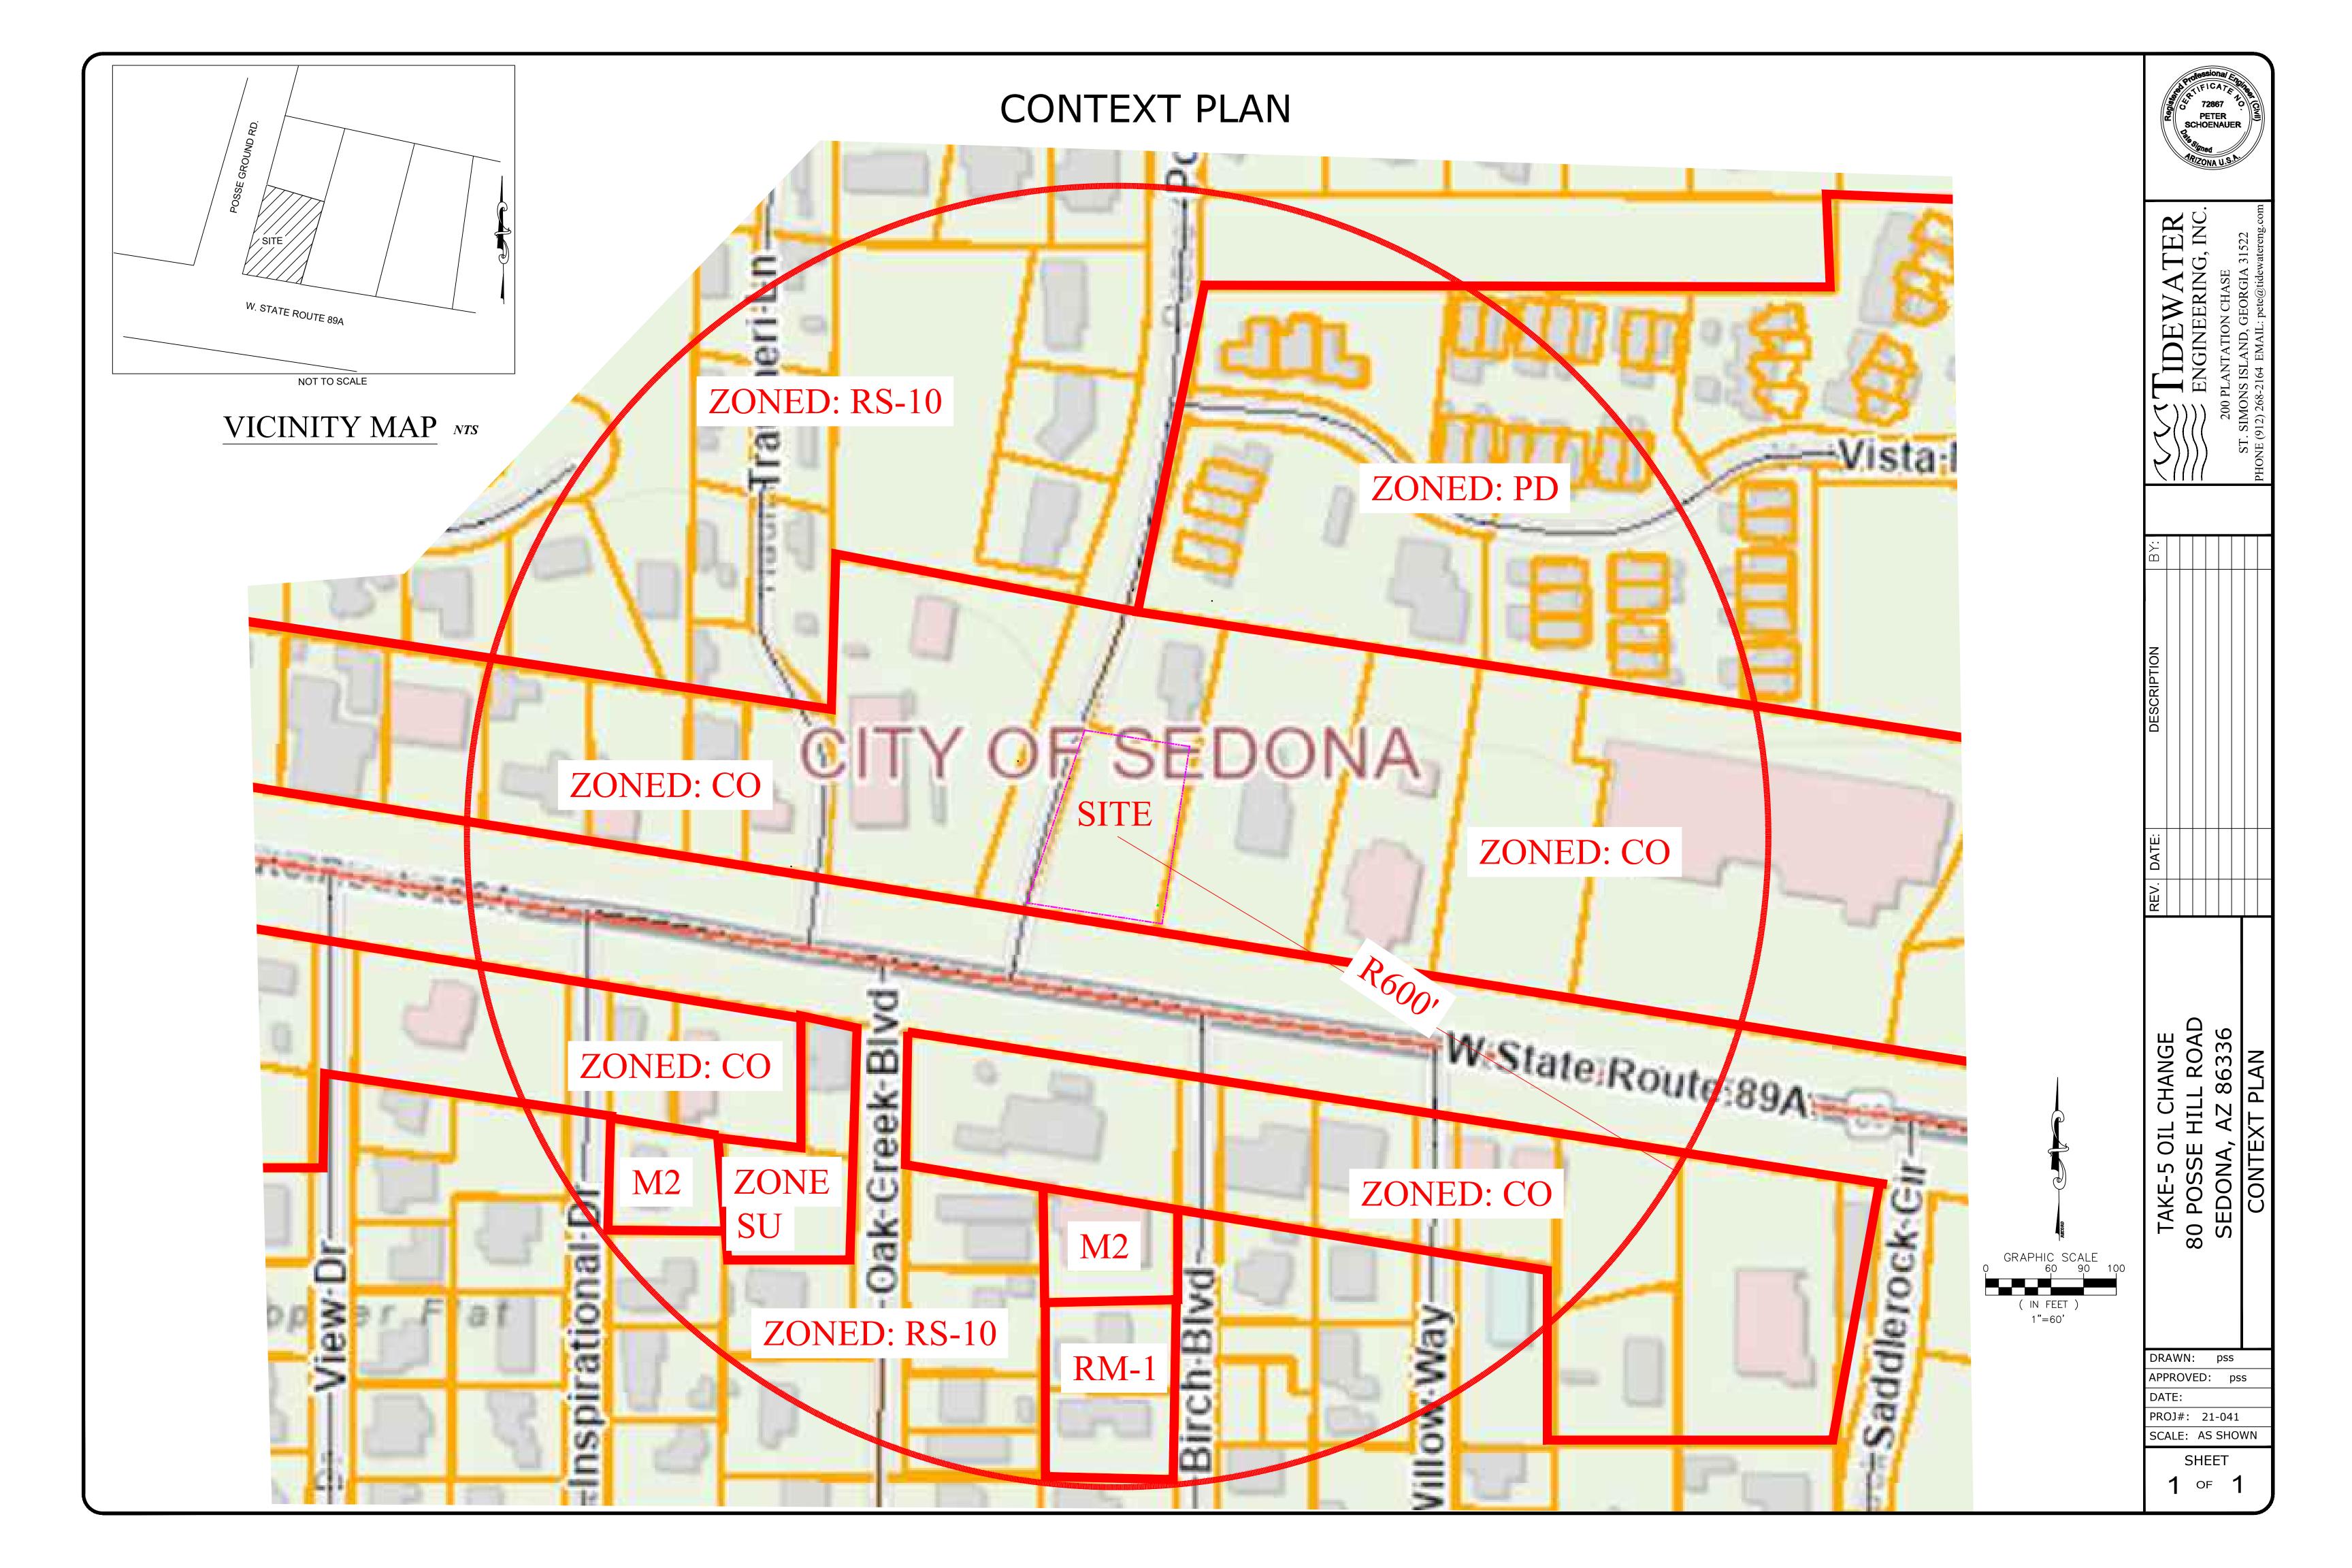


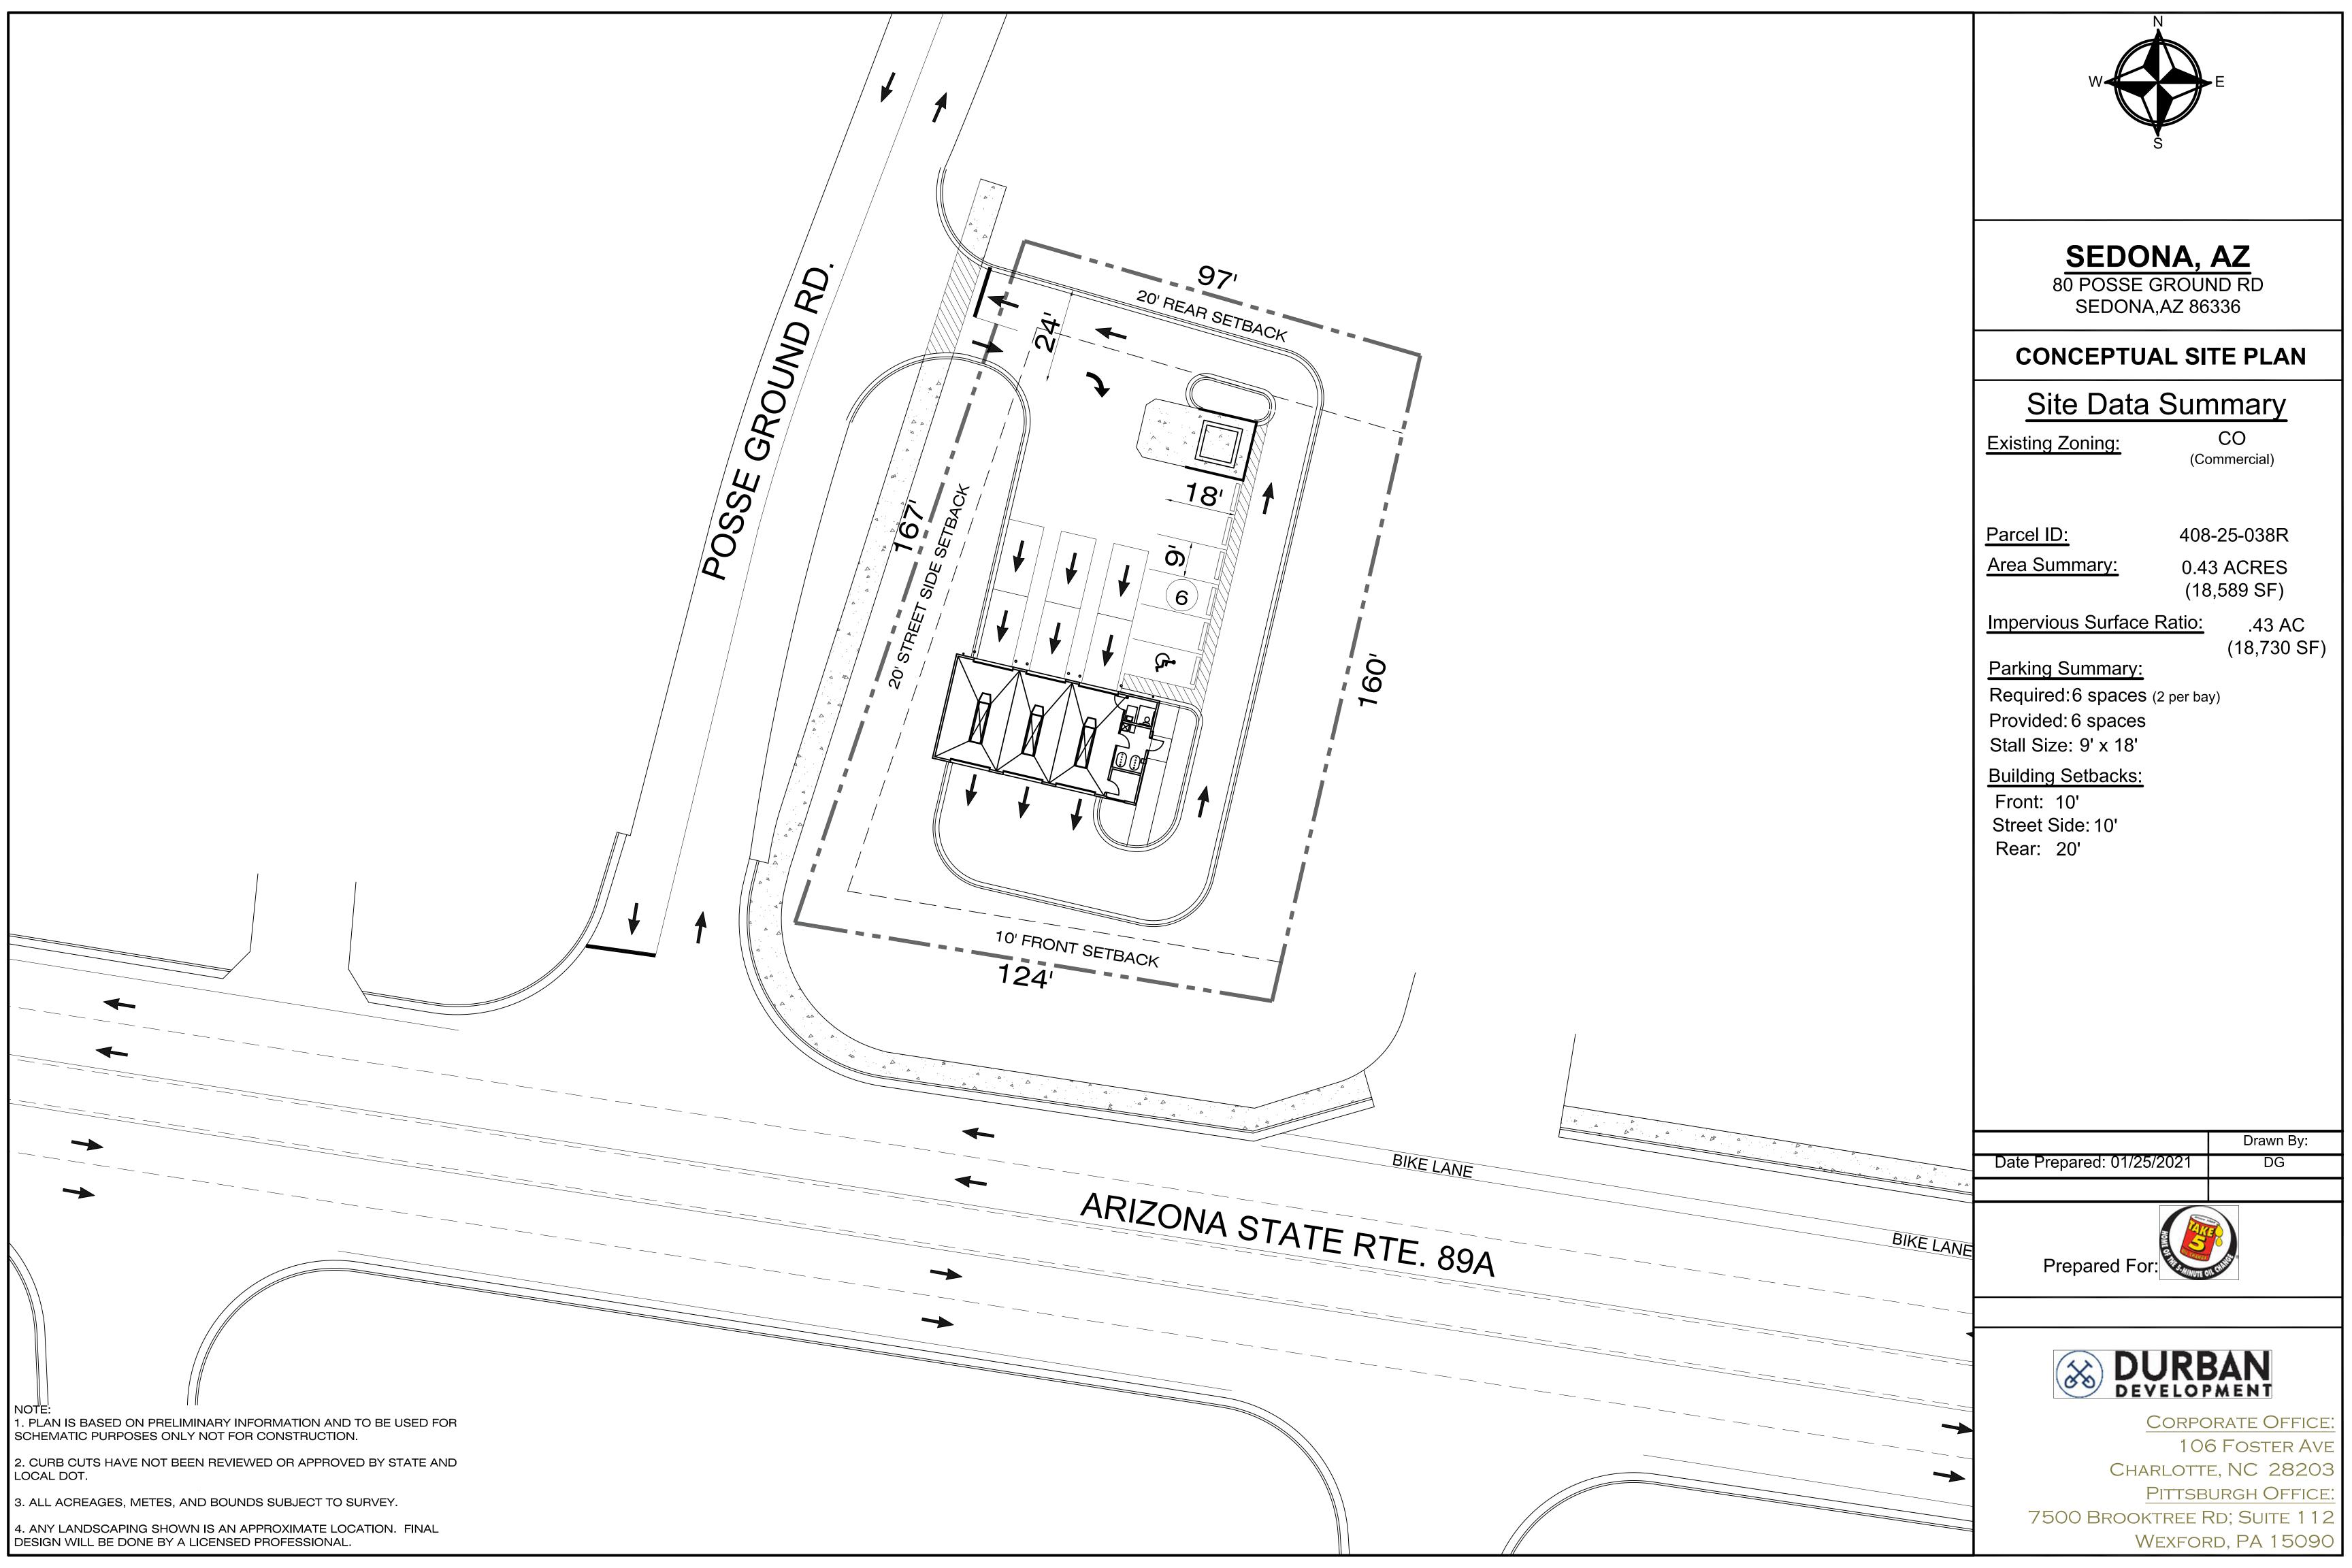

ALTA/NSPS LAND TITLE AND TOPOGRAPHICAL SURVEY SCALE: 1"=20' DATE: 04/28/2021 PORTION OF LOT 1 AND LOT 2 OF SECTION 12, T 17N, R 5E, G. & S.R.M., YAVAPAI COUNTY, ARIZONA. (R)=EMPIRE WEST TITLE AGENCY FILE NO. 78003 PARCEL #408-28-038R (R1)= BK. 4186, PG. 324 REBAR (M)=MEASURED LS 14184 (P.S.) (C)=CALCULATED REBAR LS 14184 (P.S.)= PREVIOUS SURVEY TOPOGRAPHICAL DATA IS FROM A SURVEY DONE ON JANUARY 14, 2013. NO ATTEMPT WAS MADE TO UPDATE SCHEDULE B EXCEPTION NOTES: Schedule B of the policy or policies to be issued will contain exceptions to the following matters unless the same CONTOUR INTERVALS: are disposed of to the satisfaction of the Company: MAJOR=2 FT. A. Defects, liens, encumbrances, adverse claims or other matters, if any, created, first appearing in the public MINOR= 1 FT. records or attaching subsequent to the Effective Date but prior to the date the proposed Insured acquires for value of record the estate or interest or mortgage thereon covered by this Commitment. CONTOURS ARE FROM GPS MEASUREMENTS 1. Water rights, claims or title to water, whether or not shown by the public records. AND NOT TIED TO ANY PARTICULAR DATUM. 2. Reservations or exceptions in Patents, or in Acts authorizing the issuance thereof. 3. Liabilities and Obligations imposed upon said land by reason of its inclusion within water, improvement, fire or other districts or associations, if any. 4. Taxes for the second half of 2017. (The second half is due March 1, 2018 and is delinquent May 1, 2018). 5. Any action by the County Assessor and/or Treasurer, altering the current or prior tax assessment, subsequent to the date of the Policy of Title Insurance. 6. Easement(s) for telephone lines and incidental purposes, recorded in Book 517, page 90 of Official Records. "easement is for a right-o-way 40 feet in width, 20 feet each side of centerline, for an existing telephone line as shown on a map designated 5430" map is unlegibal. SITE MAP 7. Easement(s) for road and incidental purposes, recorded in Book 519, page 520 of Official Records. "easement is for a right-of-way 66 feet in width, 33 feet on each side of centerline, for a existing road as shown on a map designated 5430" map is unlegible. 8. Easement(s) for road and incidental purposes, recorded in Book 521, page 521 of Official Records. "easement is for a sign and right-of-way 24 feet in width, 12 feet each side of centerline of an existing road as shown on a map designated 5430" map is unlegible. 9. Easement(s) for sign and incidental purposes, recorded in Book 524, page 377 of Official Records. FD. 1/2" REBAR "easement is for a sign as shown on a map designated 5430" not enough data provided to located. 10. Easement(s) for highway and incidental purposes, recorded in Book 520, page 585 of Official Records. LS 14184 BENT OVER 11. Easement(s) for water main and incidental purposes, recorded in Book 638, page 768 of Official Records Does not reach subject property. 12. Easement(s) for electric lines and incidental purposes, recorded in Book 811, page 650 of Official Records. 13. Easement(s) for electric lines and incidental purposes, recorded in Book 1351, page 182 of Official Records. "to place, construct, operate, repair, maintain, relocate and re-place thereon and in or upon all streets, RR-TIES roads or highways abutting said lnads an electric transmission of destribution line or system, and to cut and EDGE OF ROCK REBAR NO I.D. √RÓAD ; trim trees and shrubbery to the extent necessary to keep them clear of said electric line or system and to cut DRAINAGE AREA \$ 20 41"55" W down from time to time all dead, weak, leaning or dangerous trees that are tall enough to strike the wire in falling." SUBJECT 14. Easement(s) for electric lines and incidental purposes, recorded in Book 1351, page 321 of Official Records. PROPERTY LS 14184 "to place, construct, operate, repair, maintain, relocate and re-place thereon and in or upon all streets, roads or highways abutting said lnads an electric transmission of destribution line or system, and to cut and FD. 1/2" REBAR NO ID. trim trees and shrubbery to the extent necessary to keep them clear of said electric line or system and to cut S 46 21' 33" E 0.96 down from time to time all dead, weak, leaning or dangerous trees that are tall enough to strike the wire in falling." 15. All matters as set forth in recorded Disclosure for Territory in the vicinity of Sedona Public Airport HOLE Airport recorded in Book 57 of Maps, Page 22. 16. Matters as shown on survey recorded in Book 175 of Land Surveys, page(s) 36. Reviewed map. W. STATE ROUTE 89A 17. Matters as shown on survey recorded in Book 183 of Land Surveys, page(s) 94. Reviewed map. NOT TO SCALE 408-25-038F Cc-Fast Casual Food LLC 0.42 acres INSTR. #2017-0053457 18328 sq ft MORE OR LESS SMALL TREES IN THIS AREA FD. NAIL/TAG LS 27253 (P.S.) 6' ELETRIC LINES AND INCIDENTAL SIGN FOUNDATIONS PURPOSES BK. 811, PG. 650 CAP 2012 1042+23.46 N 81°05′11″ W(M) LS 42014 $\sqrt{N81^{\circ}10'}W(R)$ REBAR SIGN FOR LS 14184 BURIED GAS NOTHING FD. OR SET $^{\triangle}$ SIGN EDGE OF SIDE WALK SEWER THIS PLAT IS SUBJECT TO ALL CONDITIONS, SURVEYOR'S CERTIFICATE: CENTERLINE STATE ROUTE 89A 120' WIDE 66' EACH SIDE Bk. 520, Pg. 585 RESERVATIONS, AND OTHER ITEMS OF PUBLIC THIS RESULTS OF SURVEY MAP AND THE FIELD SURVEY RECORD ON THIS 28th DAY OF APRIL, 2021. ON WHICH IT IS BASED WERE CONDUCTED DURING THE FD. G.L.O. CAP MONTH OF APRIL, 2021, UNDER MY DIRECT SUPERVISION SW COR. LOT 1 IN ACCORDANCE WITH THE STANDARDS GOVERNING THE THIS PLAT DOES NOT PURPORT TO VERIFY THE SEC. 12 (P.S.) CREATION OF LAND SURVEY BOUNDARIES WITHIN THE STATE OWNERSHIP OF ANY PROPERTY SHOWN OR OF ARIZONA AND IS TRUE AND ACCURATE TO THE BEST OF INVOLVED IN THIS SURVEY. ANY EASEMENTS OR MY KNOWLEDGE AND BELIEF. OTHER INCUMBRANCES SHOULD BE DETERMINED BY A TITLE SEARCH. CERTIFICATION TABLE A ITEMS To: Farshid Paydar, and Empire West Title Agency 1. Monuments placed (or a reference monument or witness to the corner) at all major This is to certify that this map or plat and the survey on which it is based were made in accordance SURVEYOR'S NOTES: corners of the boundary of the property, unless already marked or referenced by existing with the 2016 Minimum Standard Detail Requirements for ALTA/NSPS Land Title Surveys, jointly 1. THE WORD CERTIFY AS SHOWN OR USED HEREON MEANS AN monuments or witnesses in close proximity to the corner., SEE PLAT. NOTE: TREES AS SHOWN ON THIS PLAT AND ACCOMPANING 4. Gross land area (and other areas if specified by the client)., SEE PLAT. established and adopted by ALTA and NSPS, and includes Items 1,4,7,8,9,11 & 13 of Table A thereof. EXPRESSION OR PROFESSIONAL OPINION REGARDING THE FACTS DIGITIZED FILE ARE FOR GRAPHIC REFERENCE. CANOPY DISTANCES The fieldwork was completed on 04/26/2021. 7. Exterior dimensions of all buildings at ground level. ,7.1 exterior footprint of all buildings OF THIS SURVEY AND DOES NOT CONSTITUTE A WARRANTY OR ARE AVERAGED FOR EACH TREE. PLEASE NOTIFY SURVEYOR FOR THIS MAP WAS PREPARED FOR A SPECIFIC PURPOSE GUARANTEE, EXPRESSED OR IMPLIED. at ground level. No buildings observed. Date of Plat or Map: 04/28/2027 SPECIFIC TREE LOCATION OF ANY TREE FOR CONSTRUCTION PURSUANT TO AN AGREEMENT WITH THE CLIENT. ONLY 8. Substantial features observed in the process of conducting the fieldwork (in addition to PURPOSES AT NO ADDITIONAL CHARGE. 04/28/2021 THOSE EASEMENTS INDICATED IN THE EMPIRE WEST TITLE the improvements and features required pursuant to Section 5 above) (e.g., parking lots, 2. THE INTENT OF THIS SURVEY IS TO PROVIDE A ALTA/NSPS AGENCY INC FILE NO. 78003, ARE INDICATED ON SURVEY OF THE REFERENCED PROPERTY. billboards, signs, swimming pools, landscaped areas, substantial areas of refuse)., SEE PLAT. THIS PLAT. NO ATTEMPT WAS MADE BY THIS SURVEYOR OR 9. Number and type (e.g., disabled, motorcycle, regular and other marked specialized THIS PDF FILE IS NOT TO BE USED FOR DESIGN HAMMES SURVEYING LLC. TO DETERMINE IF ANY ADDITIONAL HAMMES SURVEYING LLC 3. DECLARATION IS MADE TO THE ORIGINAL PURCHASER OF THIS types) of clearly identifiable parking spaces on surface parking areas, lots and in parking OR CONSTRUCTION PURPOSES. IT IS A GRAPHIC EASEMENTS OR ENCUMBRANCES EXIST. THIS SURVEYOR AND structures. Striping of clearly identifiable parking spaces on surface parking areas and 2100 VIA SILVERADO SURVEY. IT IS NOT TRANSFERABLE TO ADDTIONAL INSTITUTIONS Timothy L. Hammes, RLS 29263 REPRESENTATION OF THE ORIGINAL PLAT. HAMMES SURVEYING LLC WILL NOT ACCEPT ANY LIABILITY FOR OR SUBSEQUENT OWNERS. lots. No parking spaces observed. CAMP VERDE, AZ. 86322 CONTACT SURVEYOR FOR AN ORIGINAL HARD COPY LOSS OR DAMAGES DUE TO ANY EASEMENTS, ENCUMBRANCES, 11. Location of utilities existing on or serving the surveyed property (observed evidence). SEE PLAT. OR DWG FILE FOR DESIGN WORK. (928) 282- 5686 (928) 567-2833 SUBSURFACE CONDITIONS, STRUCTURES AND OR UTILITIES NOT 13. Names of adjoining owners according to current tax records. SEE PLAT. 4. GROSS LAND AREA. 0.42 ACRES, 18328 SQ FT. MORE OR LESS. INDICATED ON THIS PLAT.

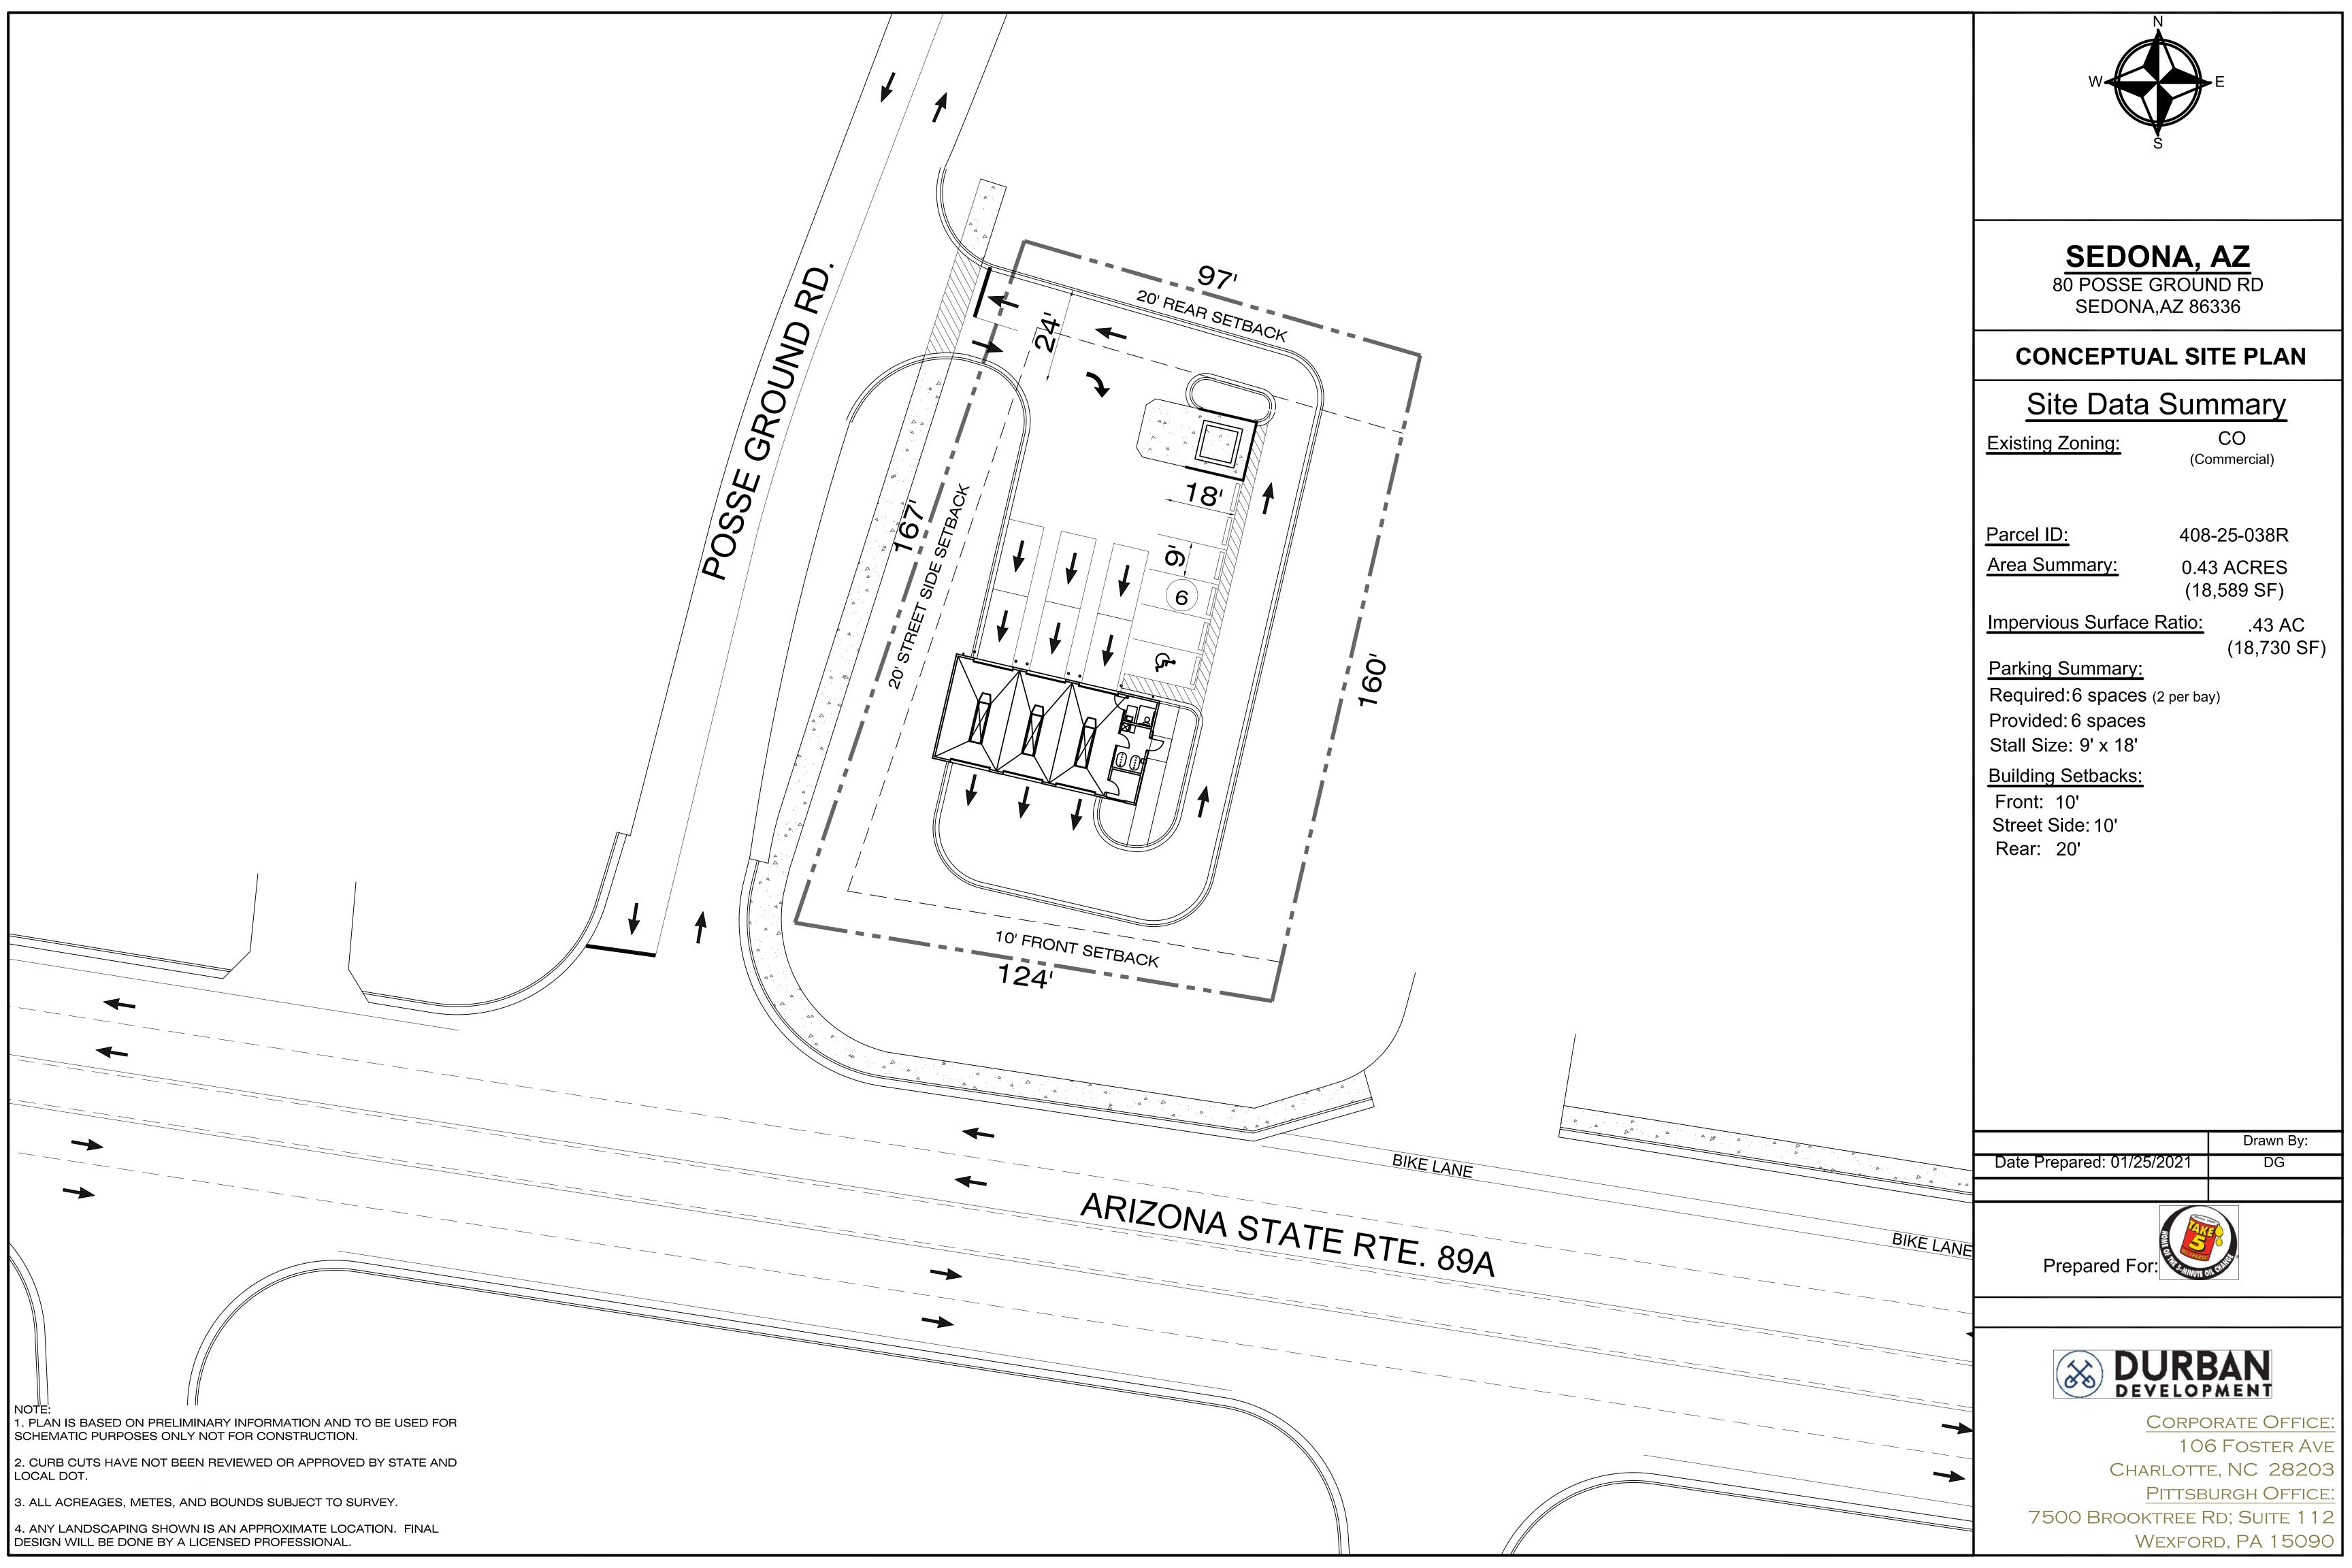



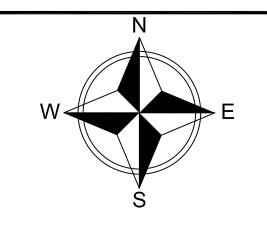

SEDONA, AZ

80 POSSE GROUND RD SEDONA,AZ 86336

CONCEPTUAL SITE PLAN

Site Data Summary

Existing Zoning:

CO (Commercial)

408-25-038R

Area Summary:

0.43 ACRES (18,589 SF)

Impervious Surface Ratio:

.43 AC (18,730 SF)

Parking Summary:

Required: 6 spaces (2 per bay)

Provided: 6 spaces Stall Size: 9' x 18'

Front: 10'

Street Side: 10' Rear: 20'

Drawn By: Date Prepared: 01/25/2021 DG





CORPORATE OFFICE: 106 Foster Ave CHARLOTTE, NC 28203 PITTSBURGH OFFICE:

7500 BROOKTREE RD; SUITE 112 WEXFORD, PA 15090



DURBAN GROUP

CLIENT / DEVELOPER
106 Foster Avenue
Charlotte, NC 28203
Telephone: 704.319.8330

Gensler

ARCHITECT
2575 E Camelback Rd Suite
175, Phoenix, AZ 85016
Telephone: 602.523.4900

Britt, Peters, and Associates, Inc.

STRUCTURAL ENGINEER 1307 West Morehead Street Charlotte, NC 28208 Telephone: 980.999.6122

Allied Consulting Engineers

M/E/P ENGINEER 2905-D Queen City Dr. Charlotte, NC 28208 Telephone: 704.399.3943

Tidewater Engineering, Inc.


CIVIL ENGINEER
200 Plantation Chase, #16
St. Simons Island, GA 31522
Telephone: 912.268.2164

Take 5 Oil Change


80 Posse Ground Rd Sedona AZ 86336 G0.000

59.6678.008


ISSUE FOR CONSTRUCTION | 10.08.2021

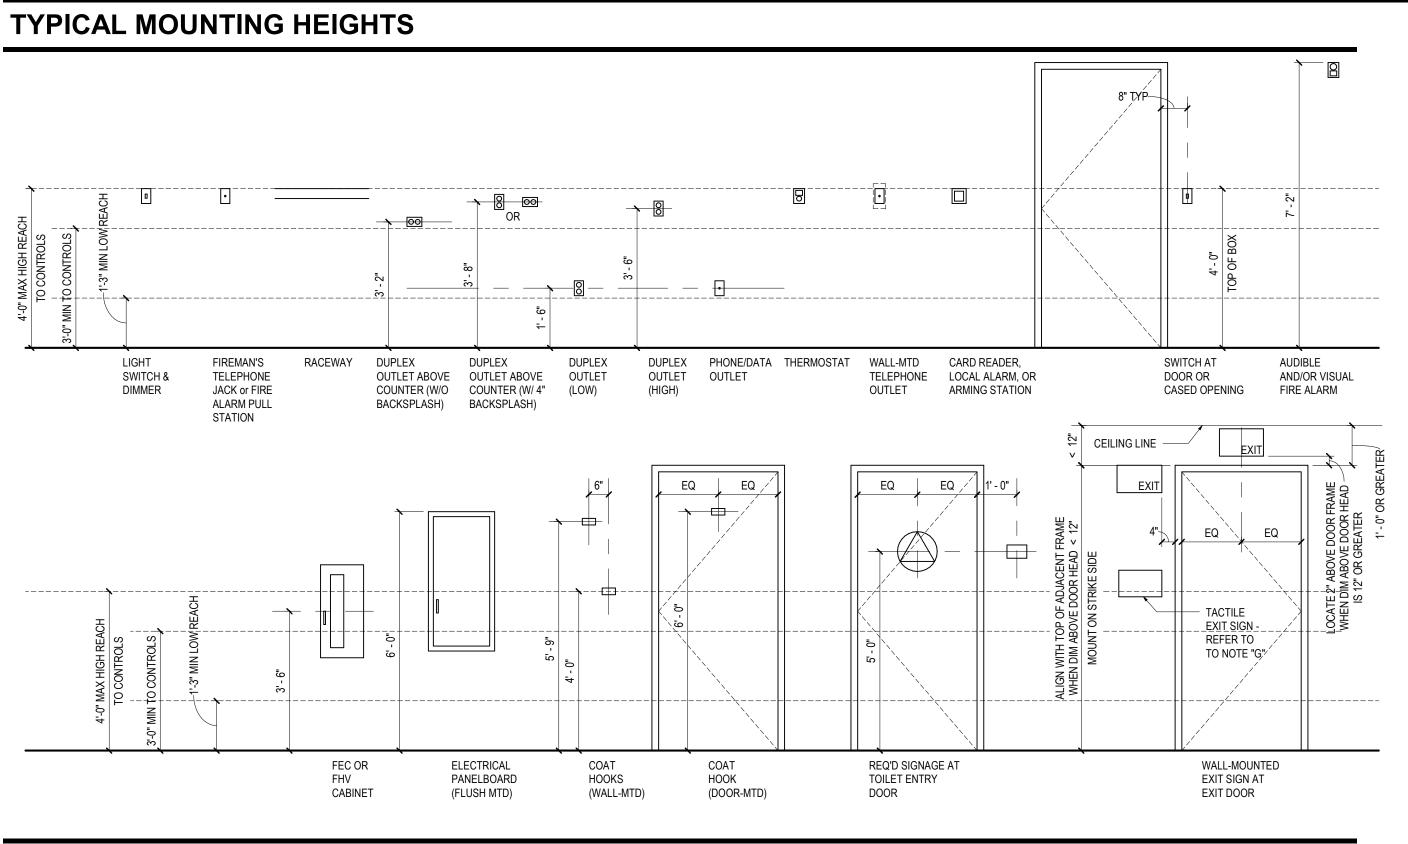

TYPICAL MOUNTING LOCATION DIAGRAMS

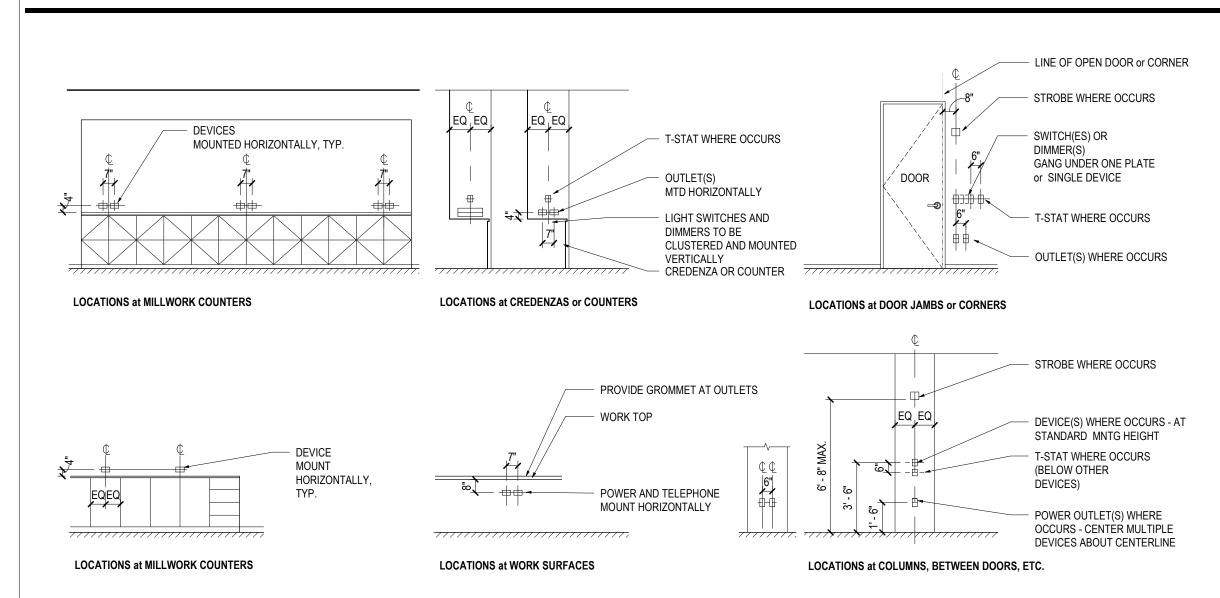

CODE REQUIRED SIGNAGE

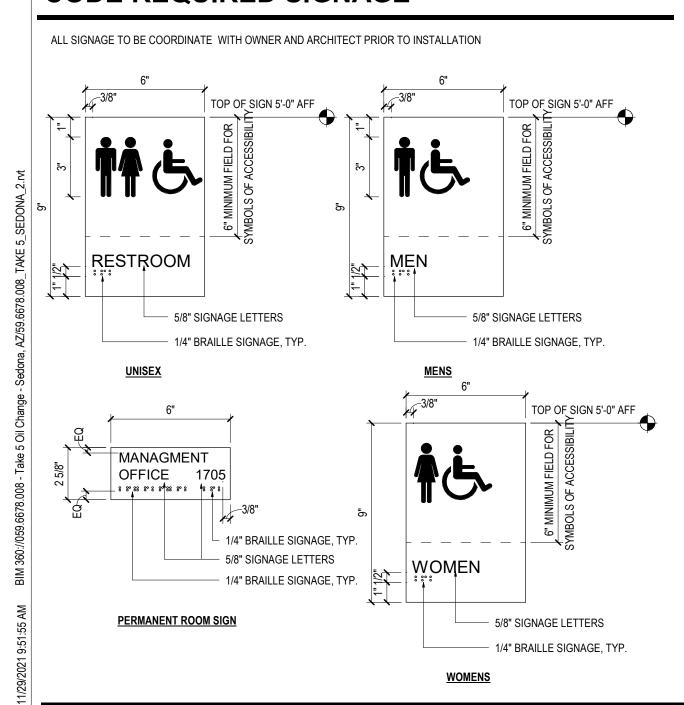

DRAWING INDEX

Sheet			Revisions	
Number	Sheet Name	Latest	Description	Date
SENERAI				
30.000	COVER	1	ISSUE FOR CONSTRUCTION	10.08.2021
31.001	SHEET INDEX, PROJECT INFORMATION AND TYPICAL SIGNAGE DETAILS	1	ISSUE FOR CONSTRUCTION	10.08.2021
1.002	ABBREVIATIONS, GRAPHIC SYMBOLS, AND GENERAL NOTES	1	ISSUE FOR CONSTRUCTION	10.08.2021
3.001	DOOR SCHEDULE, WINDOW SCHEDULE, DOOR TYPES, INTERIOR AND EXTERIOR WALL TYPES	1	ISSUE FOR CONSTRUCTION	10.08.2021
IVIL	DOOK SOFIEDOLE, WINDOW SOFIEDOLE, DOOK THE EG, INTERIOR AND EXTERIOR WALL THE EG		1000L FOR CONCINCOTION	10.00.2021
-01	COVER SHEET	1	ISSUE FOR CONSTRUCTION	10.08.2021
-02	STANDARD NOTES	1	ISSUE FOR CONSTRUCTION	10.08.2021
-03	EXISTING CONDITIONS / DEMO PLAN	1	ISSUE FOR CONSTRUCTION	10.08.2021
-04	STAKING PLAN	1	ISSUE FOR CONSTRUCTION	10.08.2021
-0 4 -05	GRADING AND DRAINAGE PLAN	1	ISSUE FOR CONSTRUCTION	10.08.2021
-05 -06	UTILITY PLAN	1	ISSUE FOR CONSTRUCTION	10.08.2021
	SITE DETAILS 1	1	ISSUE FOR CONSTRUCTION	10.08.2021
-07		1		
-08	SITE DETAILS 2 UTILITY DETAILS	1	ISSUE FOR CONSTRUCTION	10.08.2021
C-09		1	ISSUE FOR CONSTRUCTION	10.08.2021
-10	LANDSCAPE PLAN	1	ISSUE FOR CONSTRUCTION	10.08.2021
ANDSCA		1	ICCLIE FOR CONCERNATION	10.00.0004
-1	LANDSCAPE PLAN	1	ISSUE FOR CONSTRUCTION	10.08.2021
-2	IRRIGATION PLAN	1	ISSUE FOR CONSTRUCTION	10.08.2021
3	IRRIGATION DETAILS	1	ISSUE FOR CONSTRUCTION	10.08.2021
RCHITE		1.	I.a	I
0.100	ARCHITECTURAL SITE PLAN	1	ISSUE FOR CONSTRUCTION	10.08.2021
1.101	CONSTRUCTION PLAN, EQUIPMENT PLAN & SCHEDULE, ENLARGED TOILET ROOM PLAN, AND INTERIOR ELEVATIONS	1	ISSUE FOR CONSTRUCTION	10.08.2021
1.102	CONSTRUCTION PLAN - ROOF, ATTIC, & COUPLA	1	ISSUE FOR CONSTRUCTION	10.08.2021
2.101	BUILDING ELEVATIONS	1	ISSUE FOR CONSTRUCTION	10.08.2021
3.101	BUILDING SECTIONS	1	ISSUE FOR CONSTRUCTION	10.08.2021
4.101	WALL SECTIONS & EXTERIOR DETAILS	1	ISSUE FOR CONSTRUCTION	10.08.2021
4.102	WALL SECTIONS & EXTERIOR DETAILS	1	ISSUE FOR CONSTRUCTION	10.08.2021
4.201	ENLARGED EXTERIOR DETAILS	1	ISSUE FOR CONSTRUCTION	10.08.2021
5.101	OIL LUBE PIT DETAILS & DUMPSTER SCREEN PLAN, SECTIONS, DETAILS	1	ISSUE FOR CONSTRUCTION	10.08.2021
TRUCTU			1000L FOR CONCINCOTION	10.00.2021
0.000	GENERAL NOTES	1	ISSUE FOR CONSTRUCTION	10 08 2021
0.010	SPECIAL INSPECTIONS	1	ISSUE FOR CONSTRUCTION	10.08.2021
1.001	STRUCTURAL PLANS	1	ISSUE FOR CONSTRUCTION	10.08.2021
3.001	SECTION AND DETAILS	1	ISSUE FOR CONSTRUCTION	10.08.2021
3.002	SECTION AND DETAILS	1	ISSUE FOR CONSTRUCTION	10.08.2021
LUMBIN		1'	1000E FOR CONCINCOTION	10.00.2021
0.01	PLUMBING NOTES, LEGENDS AND SCHEDULES	1	ISSUE FOR CONSTRUCTION	10.08.2021
P1.01	PLUMBING FLOOR PLANS	1	ISSUE FOR CONSTRUCTION	10.08.2021
ECHAN			IOOOL I OK OONOTKOOTION	10.00.2021
11.01	MECHANICAL NOTES, DETAILS, SCHEDULES AND FLOOR PLANS	1	ISSUE FOR CONSTRUCTION	10 08 2021
LECTRI	, ,		IOOOL I OK OONOTKOOTION	10.00.2021
0.01	ELECTRICAL SPECIFICATIONS & SYMBOLS	1	ISSUE FOR CONSTRUCTION	10.08.2021
1.01	ELECTRICAL SPECIFICATIONS & STIMBOLS ELECTRICAL FLOOR PLAN LIGHTING & POWER	1	ISSUE FOR CONSTRUCTION	
2.01	PANEL SCHEDULE & RISER DIAGRAM	1	ISSUE FOR CONSTRUCTION	
	PANEL SCHEDULE & RISER DIAGRAM TECTION	1	IOSUE FUR CUNSTRUCTION	10.00.2021
P0.01	FIRE PROTECTION PLAN	1	ICCLIE EOD CONCEDITOTION	10.00.2021
ru.u I	FIRE PROTECTION PLAN	l I	ISSUE FOR CONSTRUCTION	10.00.2021

GENERAL NOTES: ALL ITEMS ARE TO BE PURCHASED, PROVIDED AND INSTALLED BY THE GENERAL CONTRACTOR. UNLESS NOTED OTHERWISE GENERAL CONTRACTOR SHALL USE NATIONAL PURCHASING ACCOUNTS FOR VENDORS LISTED BELOW.

#	EQUIPMENT SCHEDULE	PURCHASED BY	INSTALLED BY	VENDOR
1.	NEW OIL TANKS	OWNER	OWNER	
2.	USED OIL TANKS	OWNER	OWNER	
3.	PIT FRAMES	GC	GC	
4.	ROLLING DRAIN PANS	GC	GC	
5.	OFFICE SHELVING	GC	GC	
6.	OIL SEPARATOR	GC	GC	
7.	COOLANT MACHINE	OWNER	OWNER	
8.	PODIUM WORK STATIONS	OWNER	OWNER	
9.	COMPUTERS	OWNER	OWNER	
10.	COMPUTER MONITORS	OWNER	OWNER	
11.	DROP SAFE	OWNER	OWNER	
12.	AIR COMPRESSOR	OWNER	OWNER	
13.	USED OIL PUMP	OWNER	OWNER	
14.	SERVICE AREA SHELVING	GC	GC	
15.	BACK ROOM SHELVING	GC	GC	
16.	SECURITY CAMERAS	OWNER	OWNER	
17.	BUILDING SIGNS	OWNER	OWNER	

GENERAL CONTRACTOR

OWNER

GC OWNER

LIFE SAFETY PLAN - LEVEL 01

PER IBC TABLE 601 FIRE-RESISTANCE RATING REQUIREMEN ELEMENTS (HOURS) - TYPE <u>VB</u>	TS FOR BUILDING	FUNCTION OF SPACE LEGEND	333	EXITING PATH OF TRAVEL — SPACE EXIT
BUILDING ELEMENT PRIMARY STRUCTURAL FRAME: BEARING WALLS EXTERIOR: INTERIOR:	REQUIRED RATING 0 HRS 0 HRS	Business Areas Accessory Storage areas, Mechanical Equipment room	FEC □ AREA NAME 2000 SF (B) 1/100	FIRE EXTINGUISHER CABINET COORDINATE FINAL LOCATION WITH ARCHITECT AND FIRE INSPECTOR AREA IDENTIFICATION AREA SQUARE FOOTAGE OCCUPANT GROUP/AREA RATIO
NONBEARING WALLS & PARTITIONS EXTERIOR: INTERIOR: FLOOR CONSTRUCTION AND ASSOCIATED SECONDARY MEMBERS: ROOF CONSTRUCTION AND ASSOCIATED SECONDARY MEMBER	0 HRS 0 HRS 0 HRS 0 HRS 0 HRS	1,203 SF 100 GSF EXIT EXIT	T	TOTAL AREA OCCUPANTS TO ELECTRICAL DRAWINGS FOR LOCATIONS OF EXITS
REFER TO OCCUPANCY, EGRESS AND PLUMBING CALCULAT SHEET FOR ADDITIONAL INFORMATION OCCUPANT LOAD SUMMARY OCCUPANT OCCUPANCY CLASSIFICATION OCCUPANT LOAD		EXIT EXIT		
LEVEL 01 B Occupancy 13				NOTE: DESIGN INTENT IS FOR ALL GARAGE DOORS TO REMAIN FULLY OPEN WHILE BUILDING IS STAFFED AND DURING HOURS OF OPERATION TO ALLOW FOR NATURAL VENTILATION INTO SUB-SURFACE PITS AS
Grand total 14	EN	TRY ENTRY ENTRY		NOTE: TABLE 1006.2.1 NOTES SPACES WITH ONE EXIT OR EXIT ACCESS DOORWAY. B OCCUPANCY LIMITED TO 49 OCCUPANTS AND 100' TRAVEL DISTANCE

CODE AND LIFE SAFETY DATA

2018 INTERNATIONAL BUILDING CODE

2018 INTERNATIONAL PLUMBING CODE

2018 INTERNATIONAL MECHANICAL CODE

2018 INTERNATIONAL FUEL GAS CODE

TIDEWATER ENGINEERING, INC PETER SCHOENAUER 26615 864.271.8896 pete@tidewatereng.com

☐ II-A ☐ III-A ☐ IV

28-7" 1 STORY (2 STORY ALLOWED PER 503)

NEW (SQ.FT

1,407

■ V-B

9,000

ALLOWABLE (506.2)

Plumbing: ALLIED ENGINEERS E. DEAN BELK 53752 704.399.3943 Dbelk@allied-engineers.com

 Mechanical:
 ALLIED ENGINEERS
 E. DEAN BELK
 53752
 704.399.3943
 Dbelk@allied-engineers.com

Structural: BRITT PETERS & ASSOCIATES DAVID IMPSOM 67704 864.271.8869 dimpsom@BrittPeters.com

☐ I-B ☐ II-B ☐ III-B

Sprinklers: (Chapter 9) No Partial Yes NFPA 13 NFPA 13R NFPA 13D

2018 INTERNATIONAL ENERGY CONSERVATION CODE

2017 NATIONAL ELECTRICAL CODE

2012 INTERNATIONAL FIRE CODE

2010 ADAAG MANUAL

BUILDING

PLUMBING CODE:

ENERGY CODE: MECHANICAL CODE:

OTHER CODE:

Construction Type: (Table 601)

Gross Building Area:

EXIT REQUIREMENTS

FLOOR

Current list of Equipment Installers

Texas, Oklahoma and Lousiana

KT Equipment Services Inc

Take 5 Oil Change

February 11, 2019

Tim Harryman

214-675-9516

Glenn Best P.O Box 819

Equipment

Mark Holden

8015 Maxwell Road

Wade, NC 28395

910-591-8915

1530 Rutherford Rd,

Waxahachie, TX 75165

Tim@ktequipserv.com

Florida up to Atlanta

Sharpes, FL 32959 321-261-6450

Glennbest1@gmail.com

Virginia and Tennessee

Mark@Promainequip.com

Best Lubrication Equipment LLC

LEVEL 01

FIRE CODE:

ELECTRICAL CODE:

ACCESSIBILITY STANDARD:

LEAD DESIGN PROFESSIONAL: GENSLER

Standpipes: (Section 905) ■ No ☐ Yes

NUMBER AND ARRANGEMENT OF EXITS

DESIGNATION REQUIRED ON PLANS

FLOOR, ROOM, OR OF EXITS

Occupancies : B (PRIMARY) WITH S-1 (ACCESSORY)

EXISTING (SF)

Building Height : (Stories) ____

80 Posse Ground Rd PROJECT INFORMATION Sedona AZ 86336 Project Name: Take 5 Oil Change Project Description: Ground Up Construction, including Site Work of Single Story, 3 Service Bay Take 5 Oil Change with restroom, storage and support space. Project Address: 80 Posse Ground Rd Proposed Use/ Sedona AZ 86336 Occupancy: (B) Business APPLICABLE CODES

Gensler

2575 E Camelback Rd Tel 602.523.4900 Fax 602.523.4949 Suite 175 Phoenix, AZ 85016 United States

Take 5 Oil Change



Structural Engineer 1307 W. Morehead Street Suite 205 Charlotte, NC 28208 Telephone 980.999.6122



MEP Engineer 709 Catawba Street Belmont, NC 28012

Telephone 704.399.3943

Date Description
 Description

1 10.08.2021 ISSUE FOR CONSTRUCTION


						PLANS	5 22001.0			
EVEL 01		1	1 100'-0" MAX		100'-0" MAX		100'-0" MAX)"	
CCUPANT LOAD AND EXIT WIDTH										
	(a)	(b)		(c)		Exit Wid	th (in)		
SE GROUP OR SPACE ESCRIPTION	AREA (sq. ft.	. 1 DE	R	ALCULATED OCCUPANT	EGRESS V		REQUIRED WIDTH (a/b) x c	ACTUAL WIDTH SHOWN ON PLANS		

14 0.3 0.2 N/A 2.8" N/A 36" PLUMBING FIXTURE CALCULATIONS FOR OCCUPANT LOAD OF 14 OCC.


		WATERO	CLOSET	ΓS	LAVATORIES				DRINKING FOUNTAINS	
LEVEL	REQUIRED		PROVIDED		REQUIRED		PROVIDED		REQUIRED	DBOVIDED.
	MALE	FEMALE	MALE	FEMALE	MALE	FEMALE	MALE			PROVIDED
LEVEL 01	1	1	*1	*1	1	1	*1	*1		

*UNISEX RESTROOM WILL SATISFY PLUMBING FIXUTRE COUNT. PER SECTION 2902.2 EXCEPTION 2 SEPERATE FACILIITIES SHALL NOT BE REQUIRED IN STRUCTURES OR TENANT SPACE WITH A TOTAL

VICINITY MAP

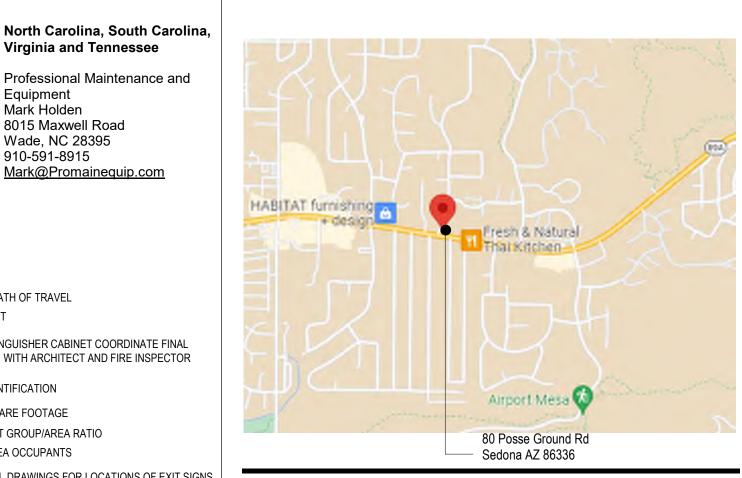

LOCATION MAP

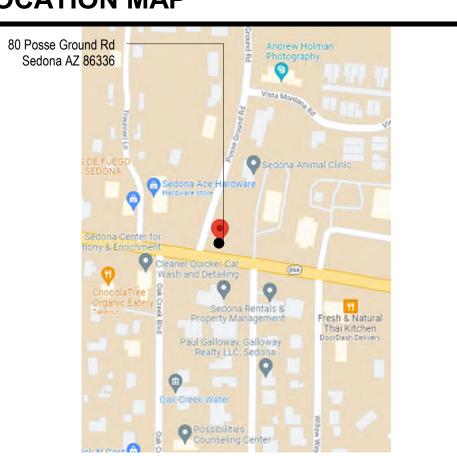

Project Name Take 5 Oil Change

Project Number 59.6678.008

Seal / Signature

Description SHEET INDEX, PROJECT INFORMATION AND TYPICAL SIGNAGE DETAILS

As indicated


G1.001

Drawing North

SITE IMPROVEMENT PLANS TAKE-5 OIL CHANGE

80 POSSE GROUND ROAD SEDONA, AZ 86336

PARCEL ID: 408-25-038R ZONED: CO (COMMERCIAL) SITE AREA: 0.43 AC

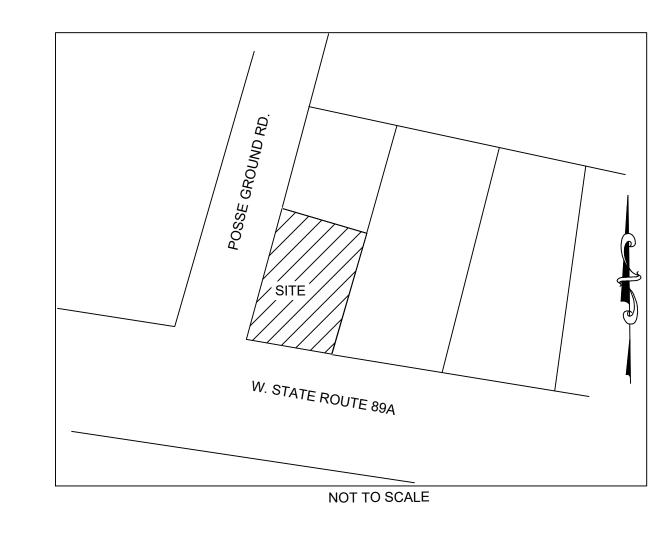

VICINITY MAP NTS

PROJECT CONTACT INFORMATION:

ENGINEER:

TIDEWATERENGINEERNIG, INC PETER SCHOENAUER, PE 200 PLANTATION CHASE ST. SIMONS ISLAND, GA 31522 PHONE: (912) 268-2164 pete@tidewatereng.com

DEVELOPER/PROPERTY OWNER:

SEDONA TAKE FIVE, LLC


STEPHEN KNUDSEN
106 FOSTER AVENUE
CHARLOTTE, NC 28203
PHONE: (704) 496-7120
stephen.knudsen@durbandevelopment.com

SURVEYOR:


ARIZONA SURVEYING, INC. JOHN LUCKOW 1843 HEAVENLY COURT FLAGSTAFF, AZ 86001 PHONE: (928) 607-7092 john.luckow@azscorp.com

UTILITY PROVIDERS:

WATER: ARIZONA WATER
SEWER: CITY OF SEDONA
ELECTRIC: ARIZONA PUBLIC SERVICE (APS)
GAS: UNISOURCE ENERGY

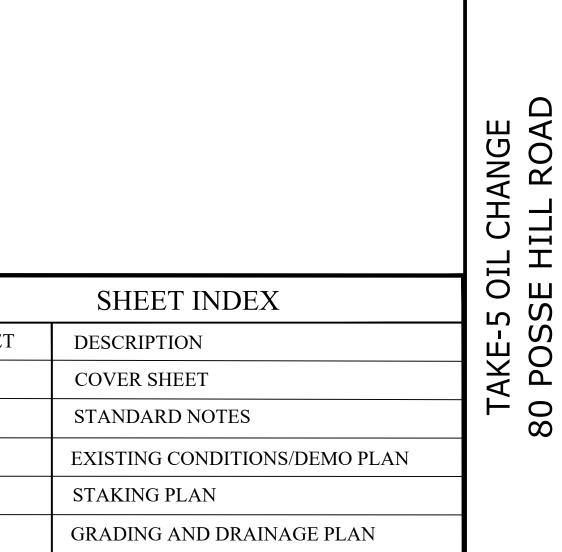



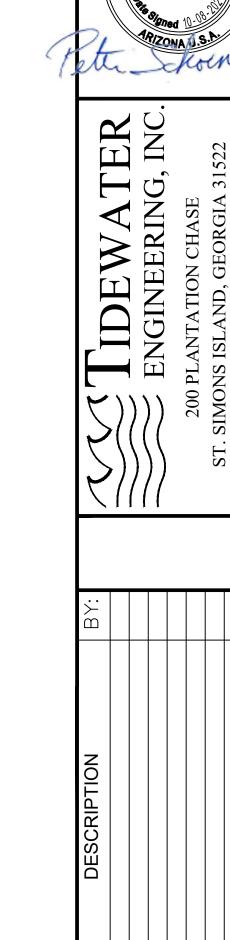

	SHEET INDEX	SSE SSE SNA
SHEET	DESCRIPTION	AKE-5 POSS EDON
1	COVER SHEET	TAKE- 0 POS SEDO
2	STANDARD NOTES	
3	EXISTING CONDITIONS/DEMO PLAN	
4	STAKING PLAN	
5	GRADING AND DRAINAGE PLAN	
6	EROSION CONTROL PLAN / DETAILS	
7	SITE DETAILS 1	DRAWN: pss APPROVED: pss
8	SITE DETAILS 1	, in the table pas
9	UTILITY DETAILS	PROJ#: 21-041
10	UNDERGROUND DETENTION DETAILS 1	SCALE: AS SHOWN
11	UNDERGROUND DETENTION DETAILS 2	SHEET 1 OF 11

SEWER NOTES:

- Engineering Department's Civil/Site Inspection Staff shall be notified 48 hours before any construction begins telephone (928) 282-1154.
- 2. All construction to conform to M.A.G. Specifications and Details and city of Sedona Specifications and Details, unless modified on the plans.
- 3. Compaction shall comply with M.A.G. Section 601 & City of Sedona requirements.
- 4. All lines must be tested for uniform slope by lamp lighting or remote camera before they are accepted as complete. Testing method must be approved in advance by the Engineering Department. The results shall be recorded and submitted to the engineer for review and approval.
- 5. Deflection testing for the entire length of PVC sewer lines shall be performed in accordance with MAG Standard Specification 615.11(c) and AAC R18-9-E301(D)(2)(i).
- 6. All manholes shall be tested using one of the following procedures:
- A. Water Testing

In accordance with AAC R-18-9-E301(D)(3)(e), the entire manhole shall be filled with water and exfiltration shall be limited to 0.0034 of the total manhole volume in one hour.

B. Vacuum Testing

In accordance with AAC R-18-9-E301(D)(3)(e), manholes shall be tested in accordance with ASTM C- 1244-02, "Standard Test Method for Concrete Sewer Manholes by Negative Air Pressure (Vacuum) Test Prior to Backfill".

- 10. The contractor shall perform manhole testing after installation of the manhole cone to verify water tightness of the manhole from the top cone down. Upon satisfactory test results, the contractor shall install the manhole rings and spacers, complete with the joints and seal the manhole to a Water tight condition.
- 11. The entire sewer line shall be tested for tightness for each pipe material in accordance with AAC R18-9-E301(D)(2)(j).
- 12. All work must comply with requirements of the Manual on Uniform Traffic Control Devices (MUTCD)
- 13. New manholes are to be built without steps.
- 14. A six (6) foot minimum horizontal separation from any underground utility shall be provided for sewer mains, and water mains. The minimum horizontal separation is measured from outside of sewer main, or water main to outside of underground utility.
- 15. A one (1) foot minimum vertical separation from any dry underground utility crossing shall be provided for sewer mains, sewer services, water mains, and water services. The minimum vertical separation is measured from outside of sewer main, sewer service, water main, or water service to outside of dry underground utility.
- 16. A two (2) foot minimum vertical separation shall be provided between any water main or storm drain crossing a sewer main. The minimum vertical separation is measured from outside of sewer main to outside of water main or storm drain main.
- 17. Exceptions or deviations from the above minimum clearances must be approved and shown on the approved water and sewer plans. When utility conflicts are found during construction, all changes and revisions must be preceded by an approved plan revision.
- 18. Any and all more stringent requirements required by Federal, State, County, or Local codes or ordinances take precedence.
- 19. Any sewer lines that are installed with less than .004 ft/ft slope must be installed using a laser. 20. When DIP sewer pipe is used, an epoxy lining is required as approved by the City Engineer.
- 21. Concrete or asphalt damaged during the course of construction shall be removed and replaced in kind prior to final inspection.
- 22. Plan approval is valid for one year.

WATER NOTES:

- 1. Engineering Department's Civil/Site Inspection Staff shall be notified 48 hours before any construction begins telephone (928) 282-1154.
- 2. All construction to conform to M.A.G. Specifications and Details, City of Sedona and Arizona Water details and specifications.
- 3. Compaction shall comply with M.A.G. Section 601.
- 4. Pipe deflection shall not exceed one-half (½) the manufacturers' recommendations.
- 5. All work must comply with requirements of the Manual on Uniform Traffic Control Devices (MLTCD)
- 6. The contractor is to notify the public that will be affected by any shutdowns a minimum of 48 hours in advance.
- 7. A six (6) foot minimum horizontal separation from any underground utility shall be provided for sewer mains and water mains. The minimum horizontal separation is measured from outside of sewer main or water main to outside of underground utility.
- 8. A one (1) foot minimum vertical separation from any dry underground utility crossing shall be provided for sewer mains, sewer services, water mains, and water services. The minimum vertical separation is measured from outside of sewer main, sewer service, water main, or water service to outside of dry underground utility.
- 9. A two (2) foot minimum vertical separation shall be provided between any sewer main and storm drain crossing a water main. The minimum vertical separation is measured from outside of water main to outside of sewer main or storm drain main.
- 10. Exceptions or deviations from the above minimum clearances must be approved and shown on the approved water and sewer plans. When utility conflicts are found during construction, all changes and revisions must be preceded by an approved plan revision.
- 11. Any and all more stringent requirements required by Federal, State, County, or Local codes or ordinances take precedence.
- 12. Water services shall be installed perpendicular to the water main. Water services at the end of cul-de sacs may vary as necessary, but will be approved on a case by case basis.
- 13. All services shall run in a straight line from the water main to the meter box.
- 14. Neither water service meter box nor any portion of a water service shall be installed under an existing or proposed driveway or sidewalk ramp.
- 15. Concrete or asphalt damaged during the course of construction shall be removed and replaced in kind prior to final inspection.

STREET / PAVING NOTES:

- 1. Engineering Department's Civil/Site Inspection Staff shall be notified 48 hours before any construction begins telephone (928) 282-1154.
- 2. All construction to conform to M.A.G. Specifications and Details and City of Sedona
- 3. Compaction shall comply with M.A.G. Section 601
- 4. Construction quantities on these plans are not verified by the city.
- 5. All work must comply with requirements of the Manual on Uniform Traffic Control Devices (MUTCD)
- 6. Existing or newly damaged and/or displaced concrete curb, gutter, sidewalk, or driveway slab that is within the right-of-way shall be repaired or replaced, as noted by city inspectors, before final acceptance of the work.
- 7. Exact point of pavement matching, termination and overlay, if necessary shall be determined in the field by the City Engineer or his/her authorized representative.
- 8. An approved Paving Plan shall be on the job site at all times. Deviations from the plan must be preceded by an approved plan revision.
- Obstructions to proposed improvements in the right-of-way shall be removed or relocated before beginning construction of the proposed improvements.
- 10. All existing catch basins must be re-located when they are shown in a newly proposed driveway.
- 11. Any and all more stringent requirements required by Federal, State, County, or Local codes or ordinances take precedence.
- 12. No paving construction shall be started until all utility lines are completed under proposed
- 13. The permit holder shall arrange for the relocation and relocation costs of all utilities, including any street lights, and submit a utility relocation schedule prior to the issuance of a construction permit
- 14. Utility facilities in conflict with this work shall be relocated by the developer. This activity shall be coordinated with the owner of the utility to prevent any unnecessary interruption of service.
- 15. The paving contractor shall be responsible for the adjustment and placement of concrete collars, frames, covers, and valve boxes as necessary for a complete job as approved by the City Engineer or his/her authorized representative.
- 16. Concrete or asphalt damaged during the course of construction shall be removed and replaced in kind prior to final inspection.
- 17. Grading between back of curb and property line shall be limited to 4:1 slope
- 18. Base course shall not be placed until sub-grade has been approved by the City Engineer or his/her authorized representative.
- 19. No job will be considered completed until, curbs, pavements and sidewalks have been swept clean of all dirt and debris; and survey monuments are installed.
- 20. The location of all water valves, fire hydrants and manholes must at all times during construction be referenced by the contractor and made available to the City.
- contractor as directed by the City Engineer or his/her authorized representative.

21. Existing street and traffic signs will be maintained during construction and relocated by the

- 22. Certificate of Occupancy (C of O) and/or final electrical clearance for any building is denied until all offsite improvements are completed.
- 23. Trees and shrubbery in the right-of-way that conflict with proposed improvements shall not be removed without approval of the Engineering Inspector.

DRY UTILITIES NOTES:

- 1. Engineering Department's Civil/Site Inspection Staff shall be notified 48 hours before any construction begins telephone (928) 282-1154.
- 2. All construction to conform to M.A.G. Specifications and Details and City of Sedona specifications.
- 3. Compaction shall comply with M.A.G. Section 601
- 4. All work must comply with requirements of the Manual on Uniform Traffic Control Devices (MUTCD).
- 5. Any and all more stringent requirements required by Federal, State, County, or Local codes or ordinances take precedence.
- 6. Concrete or asphalt damaged during the course of construction shall be removed and replaced in kind prior to final inspection.
- 7. The contractor shall have a copy of the approved construction plans and approved traffic control plan at the project site at all times
- 8. All utilities crossing existing City streets must be bored unless permission to open cut has been given in writing by the City Engineer or his authorized representative. Before starting any street cut or bore that crosses a major roadway, the contractor must schedule a separate field meeting with the project inspector to verify that all Blue Stake and design requirements are met.
- 9. Alignment on plans may not deviate more than 1' without getting approval of the City Engineer.
- All work requiring asphalt replacement, concrete replacement, or resurfacing alleys in City right of way will require a final inspection with the utility company representative at time of completion.
- 11. Abandoned facilities shall be removed unless otherwise approved by the City Engineer.




INC X IDEWATEI NGINEERING, IN HANGE OIL E H TAKE. DRAWN: pss APPROVED: pss

APPROVED: pss DATE: PROJ#: 21-041

SCALE: AS SHOWN

SHEET 2 of 1

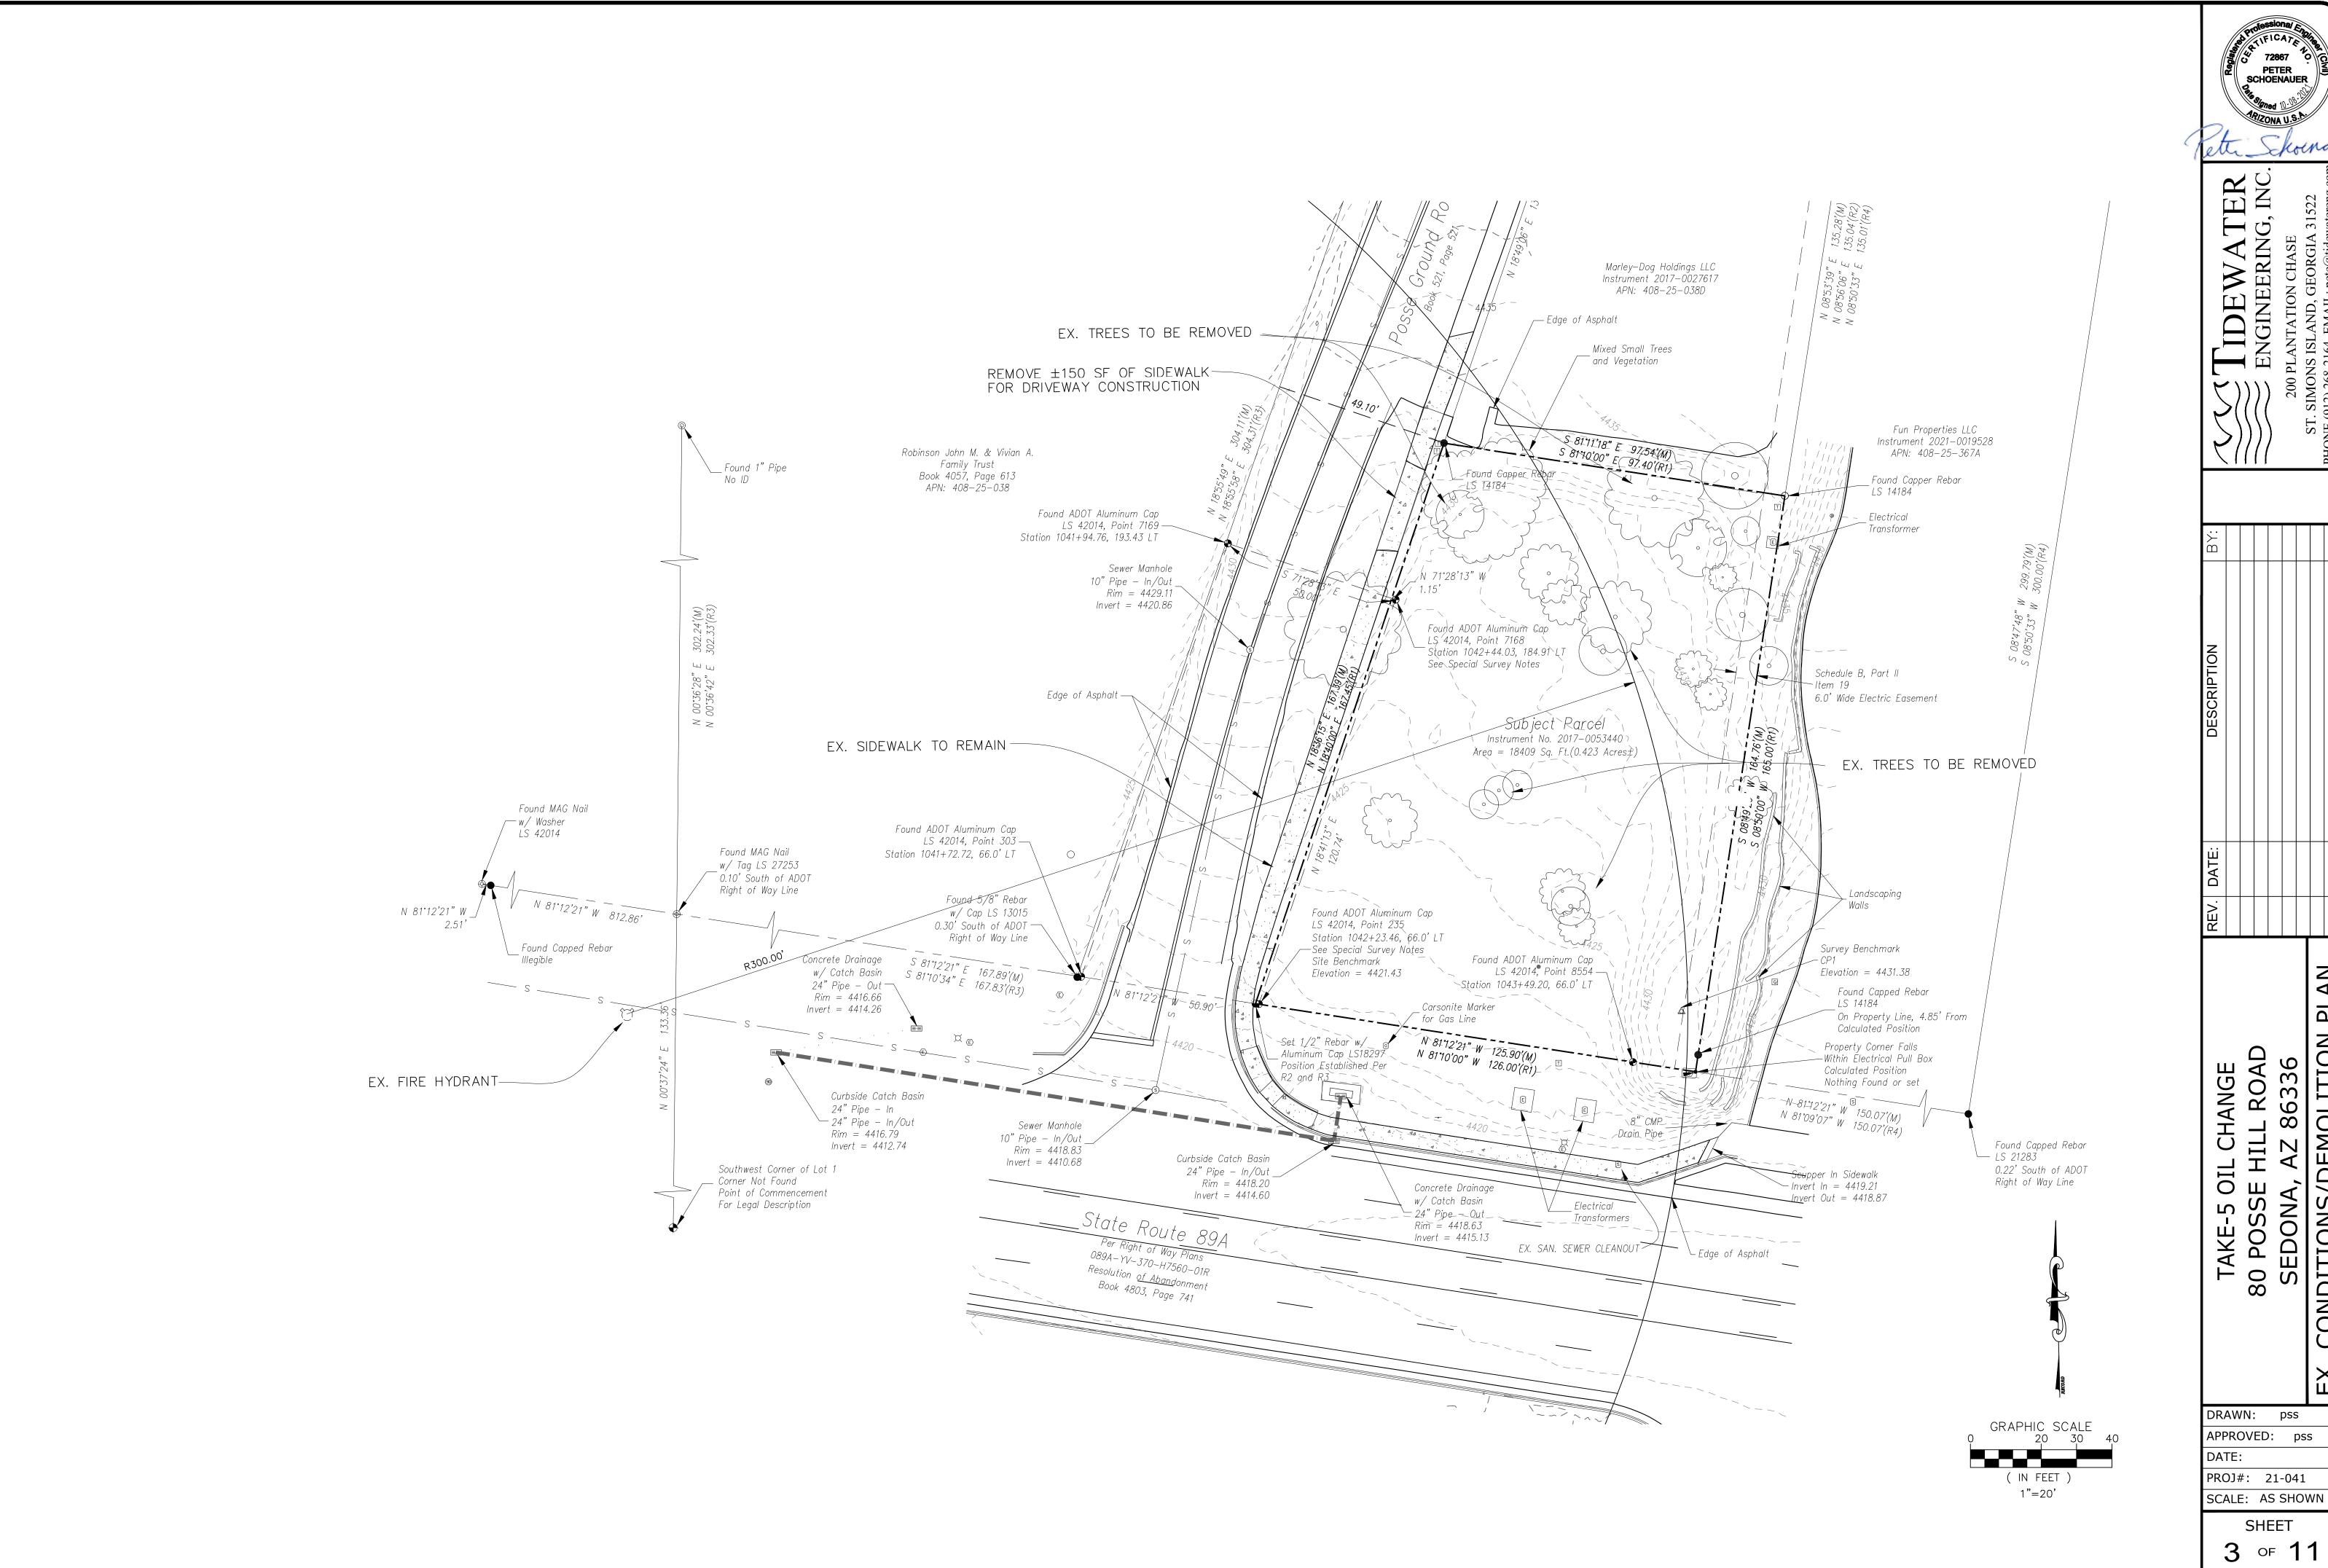




TAKE-5 OIL CHANGE 80 POSSE HILL ROAD SEDONA, AZ 86336

DRAWN: pss APPROVED: pss

PROJ#: 21-041


SHEET

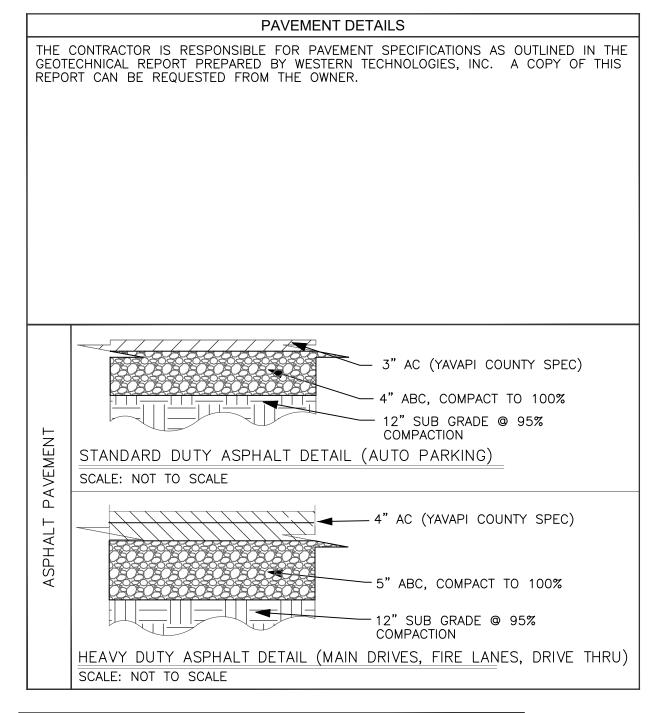

CONCRETE PAVEMENT SPECS: HEAVY DUTY- LOADING AREA, DUMPSTER PAD AND APRON: MINIMUM 6" THICK, CLASS AA PORTLAND CEMENT CONCRETE OVER 4 INCHES OF AGGREGATE BASE COURSE.


HEAVY DUTY AC PAVEMENT

STANDARD DUTY AC PAVEMENT

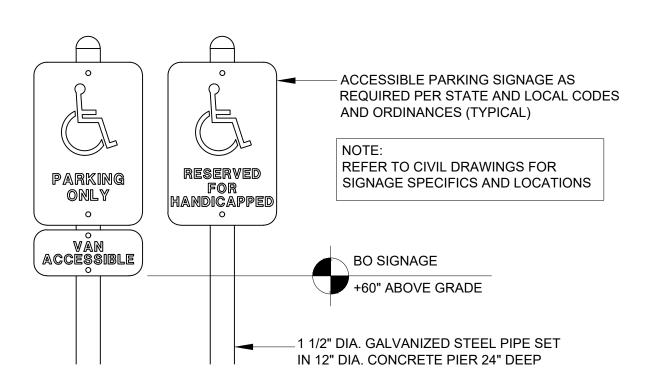

ACCESSIBLE PARKING SIGNAGE N.T.S.



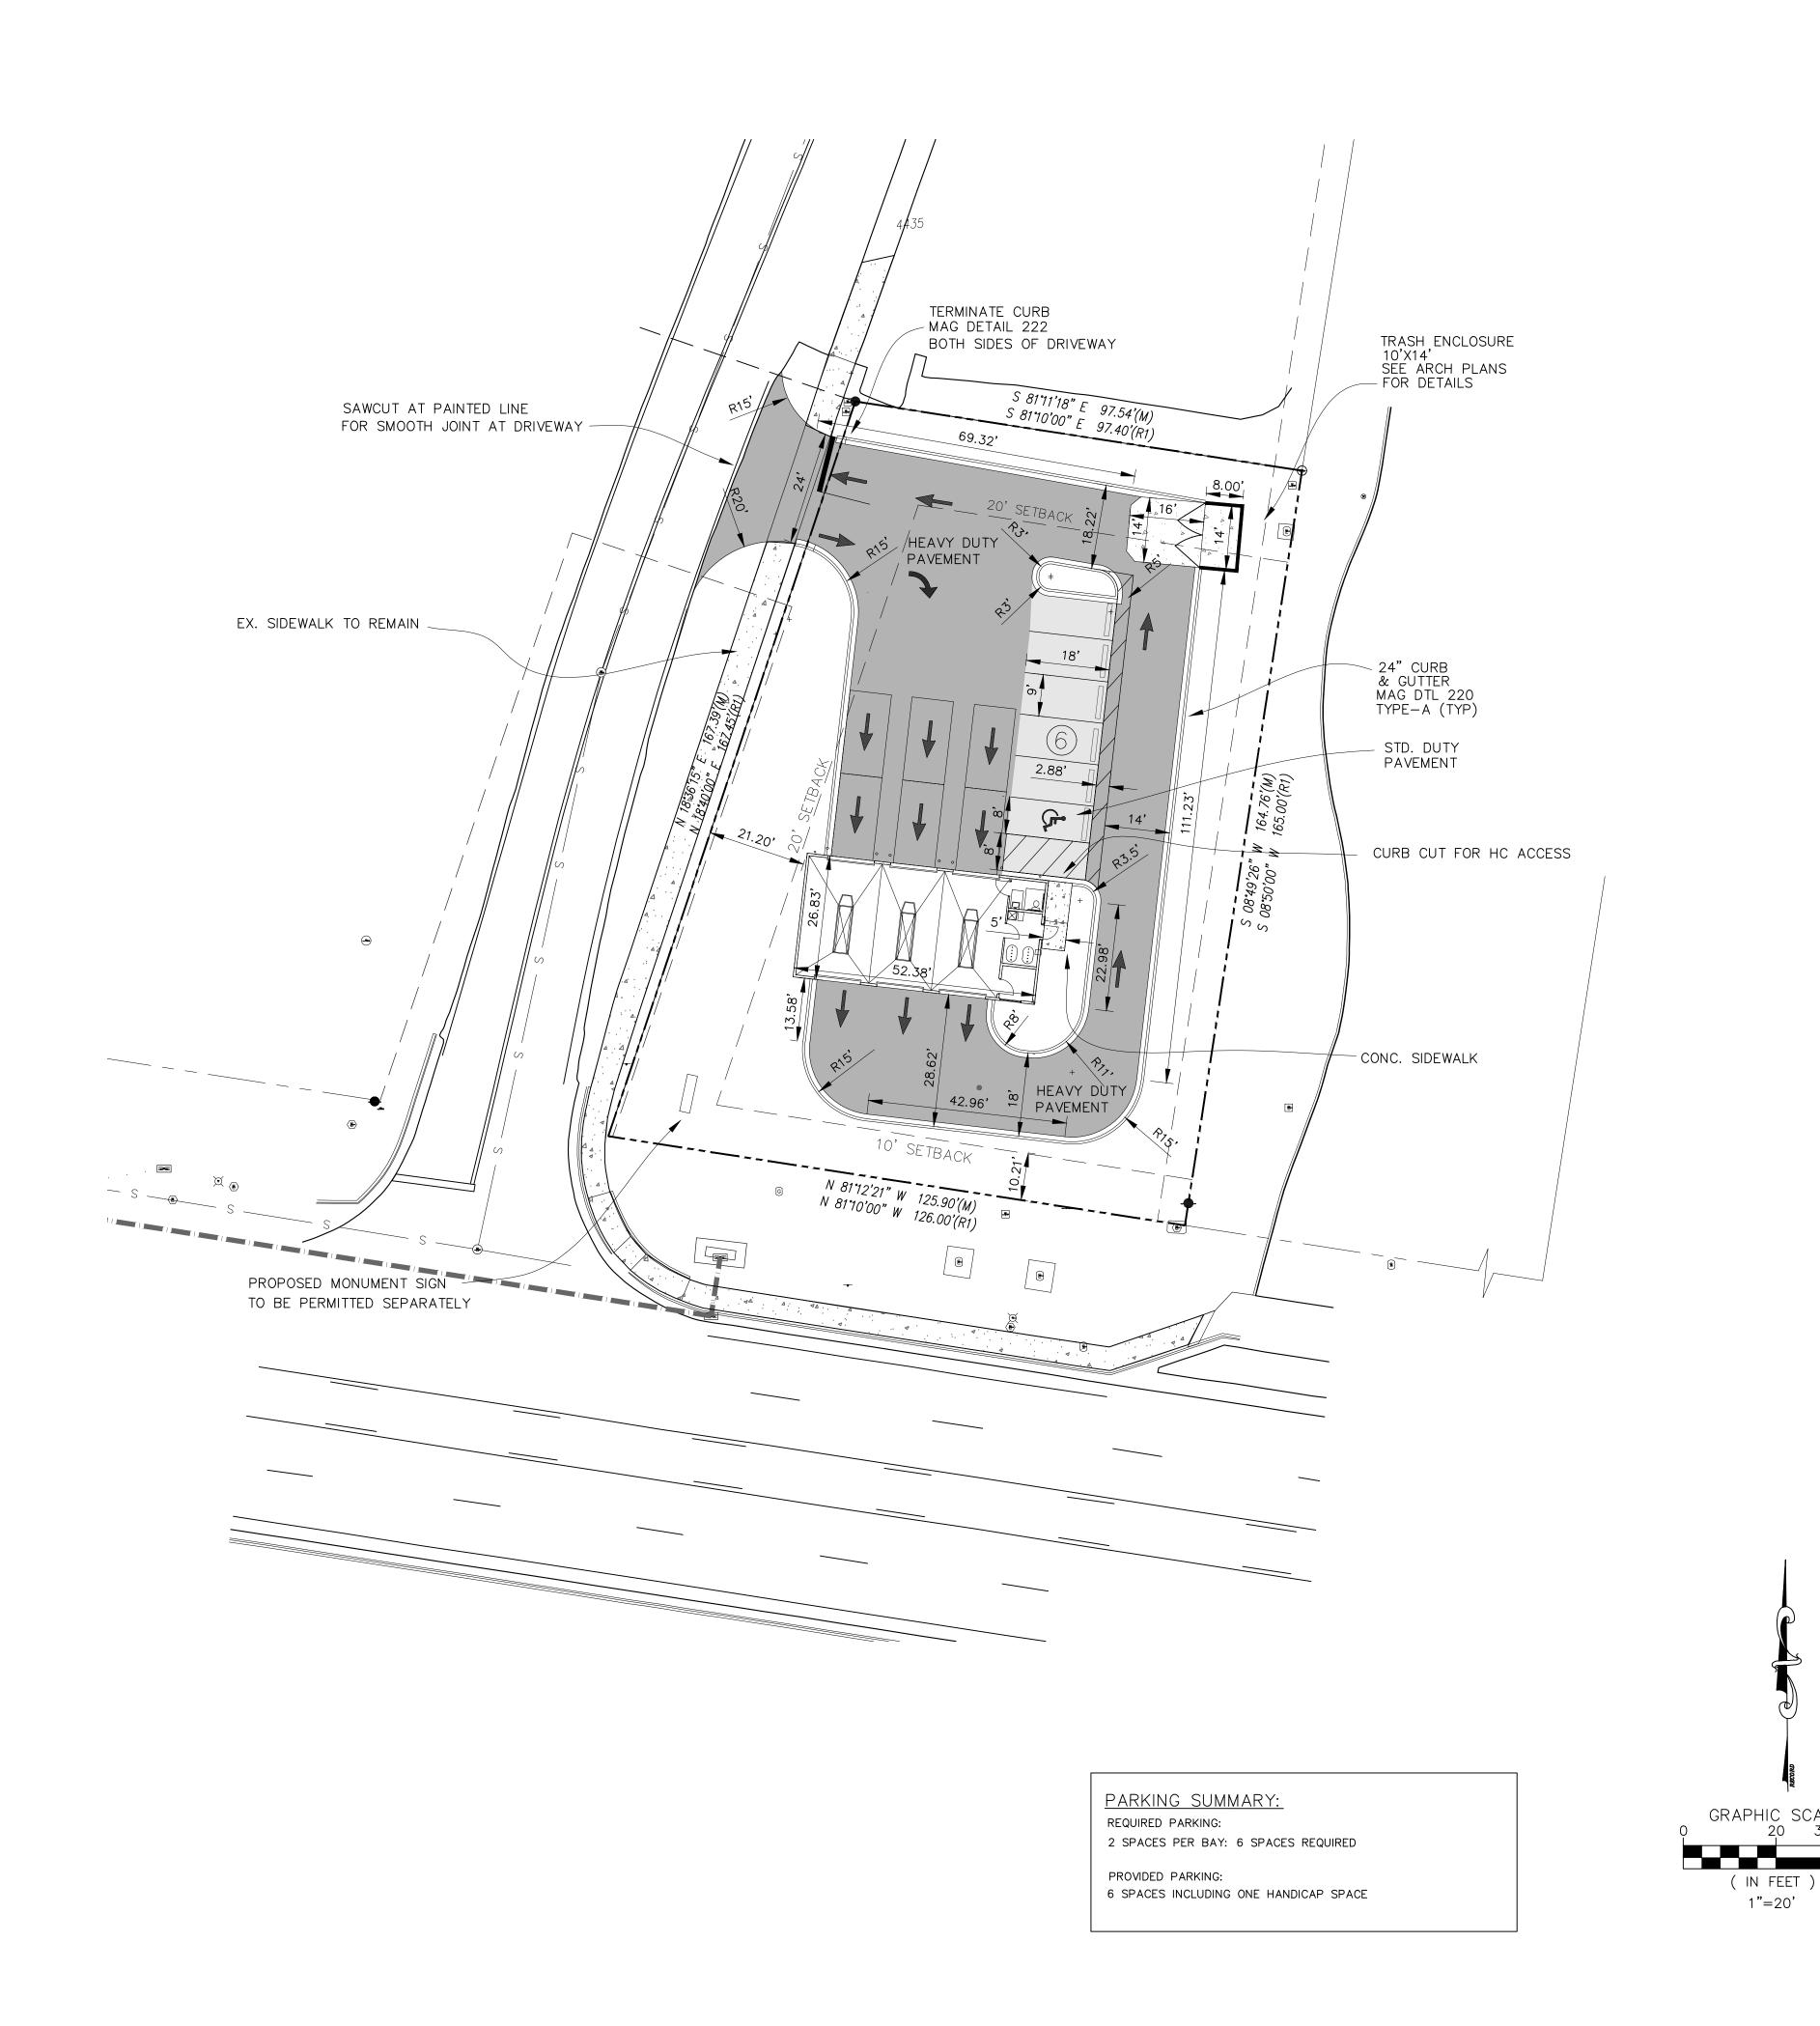



IL CHANGE HILL ROAD , AZ 86336 TAKE-80 PC SF


> DRAWN: pss APPROVED: pss

DATE: PROJ#: 21-041


1"=20'


SCALE: AS SHOWN

SHEET 4 of 11

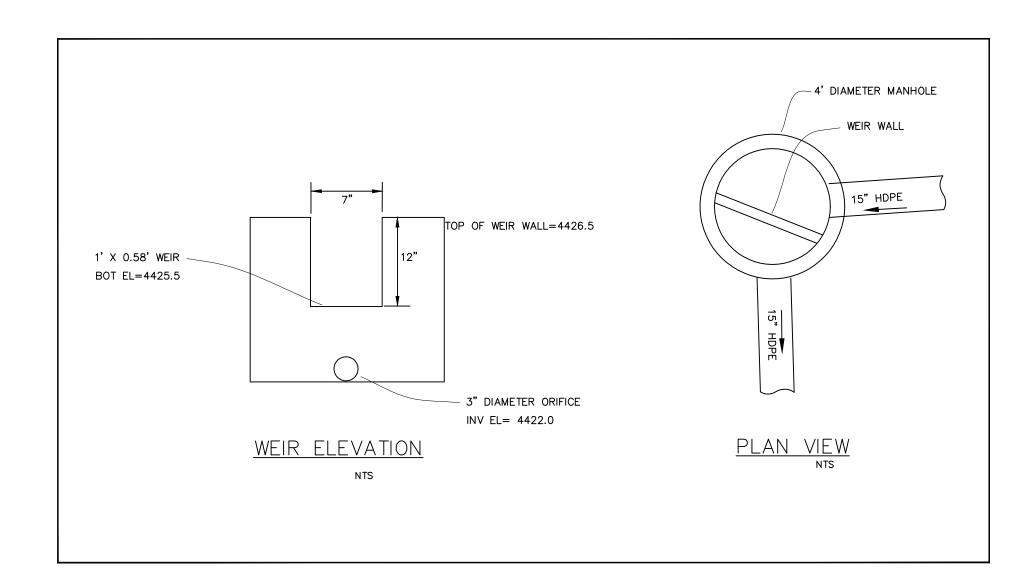

OUTLET CONTROL STRUCTURE

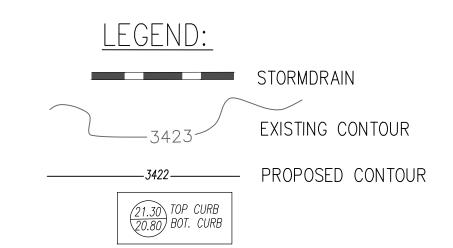

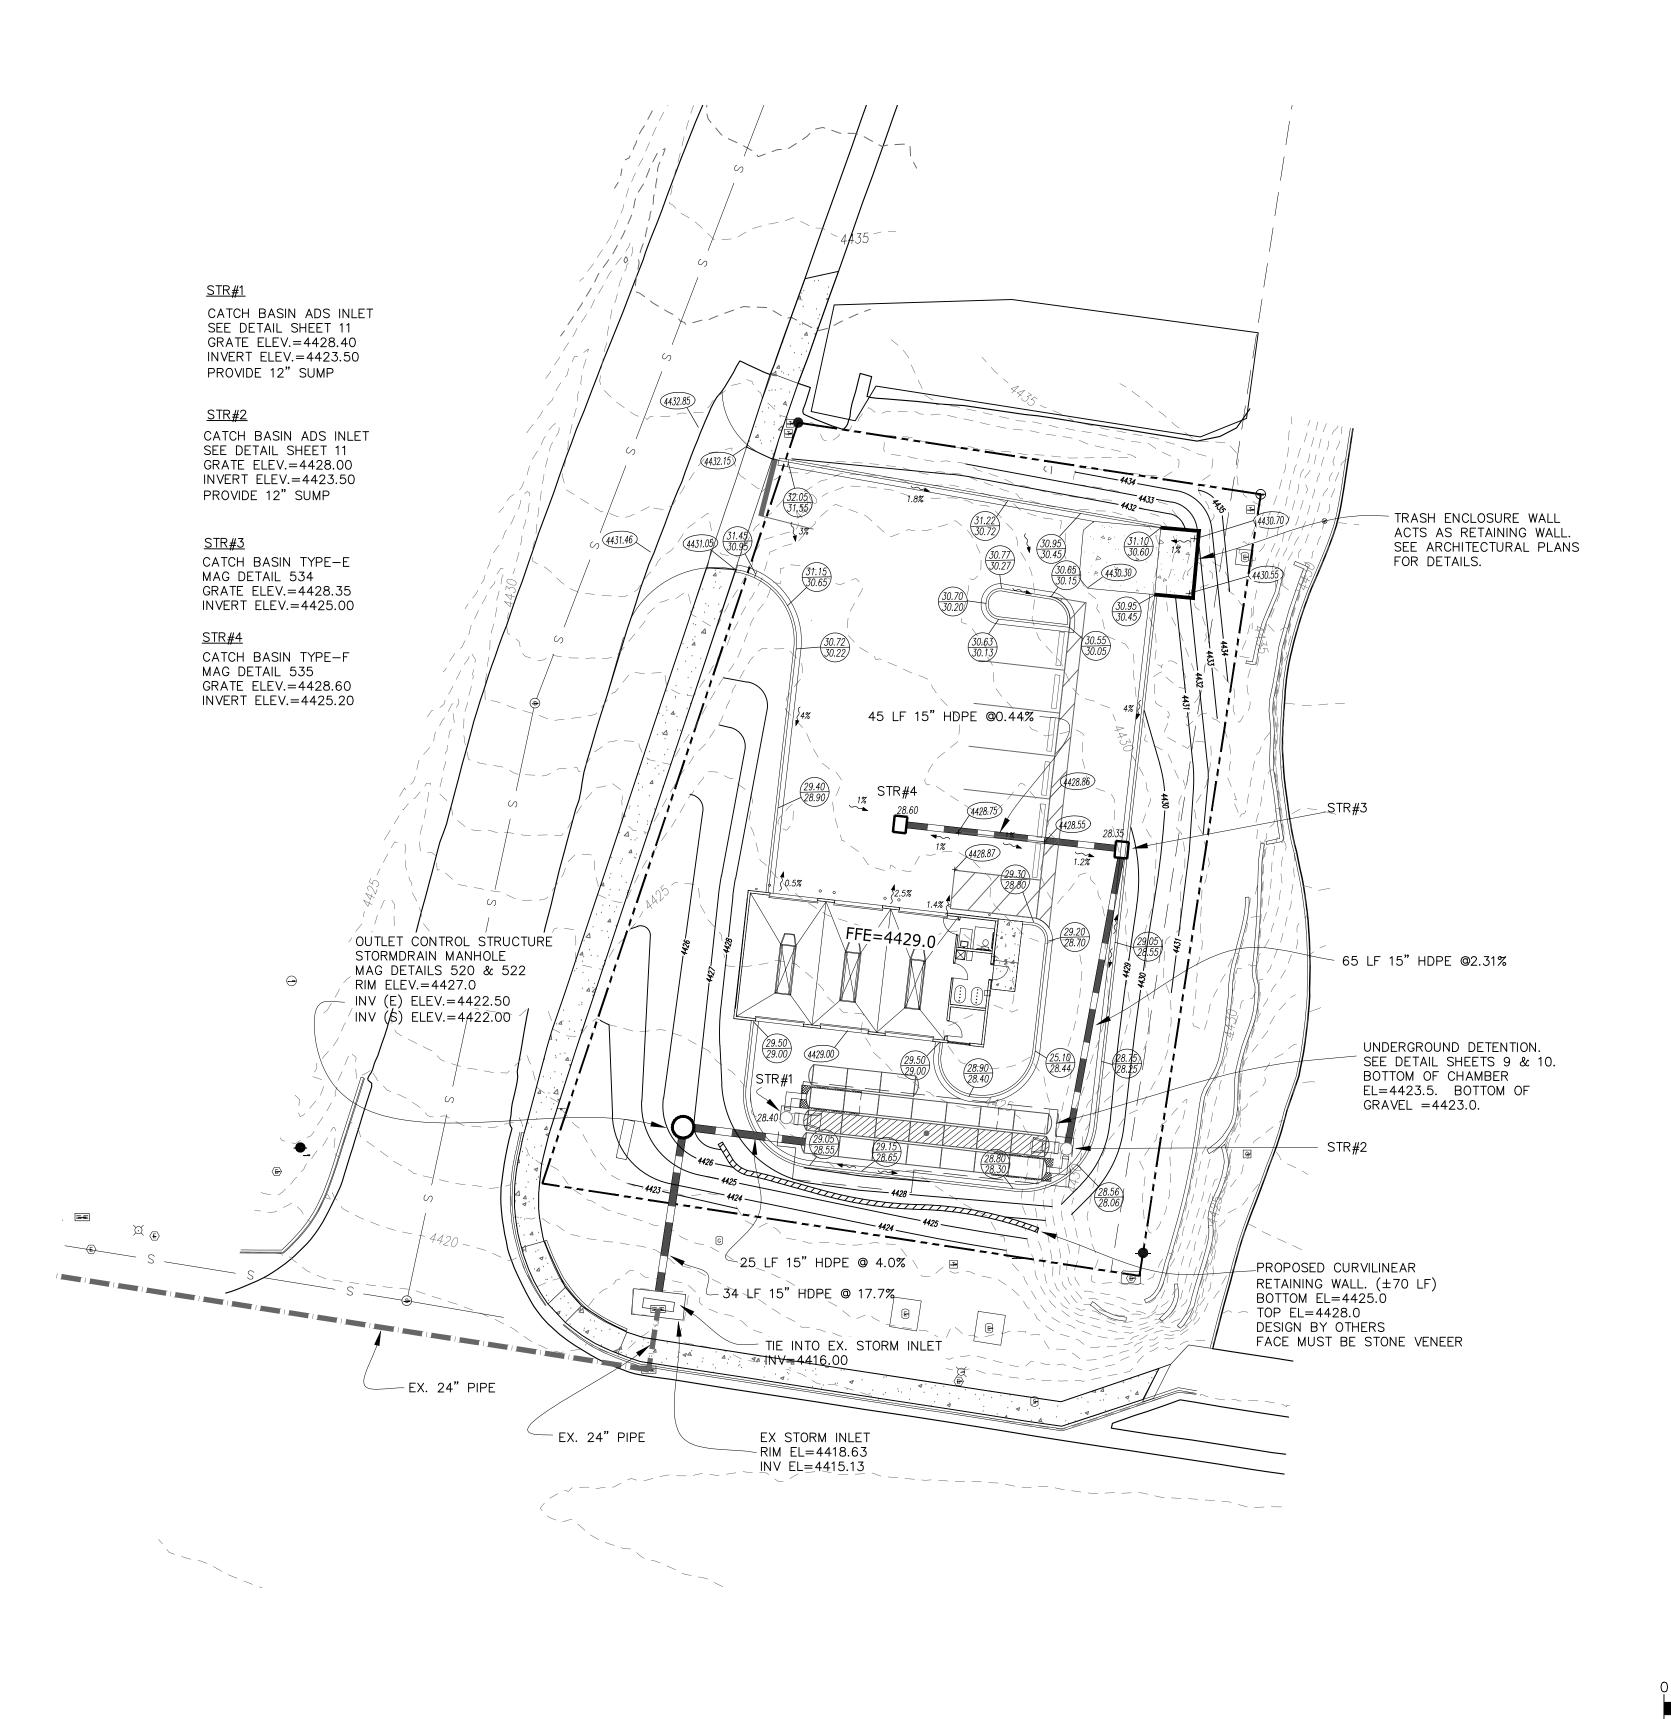



CHANGE

ILL ROAD

AZ 86336

AZ 86336

AZ 86336

ATMINE DI ANI

TAKE-5 OIL CHANGE 80 POSSE HILL ROAD

GRAPHIC SCALE 20 30

(IN FEET)

1"=20'

DRAWN: pss
APPROVED: pss
DATE:


PROJ#: 21-041
SCALE: AS SHOWN


SHEET **5** OF **11**


Contact Arizona 311 at least two full working days before you begin exeavation


ARIZONASII.

Call 311 or eliek Arizona311.com

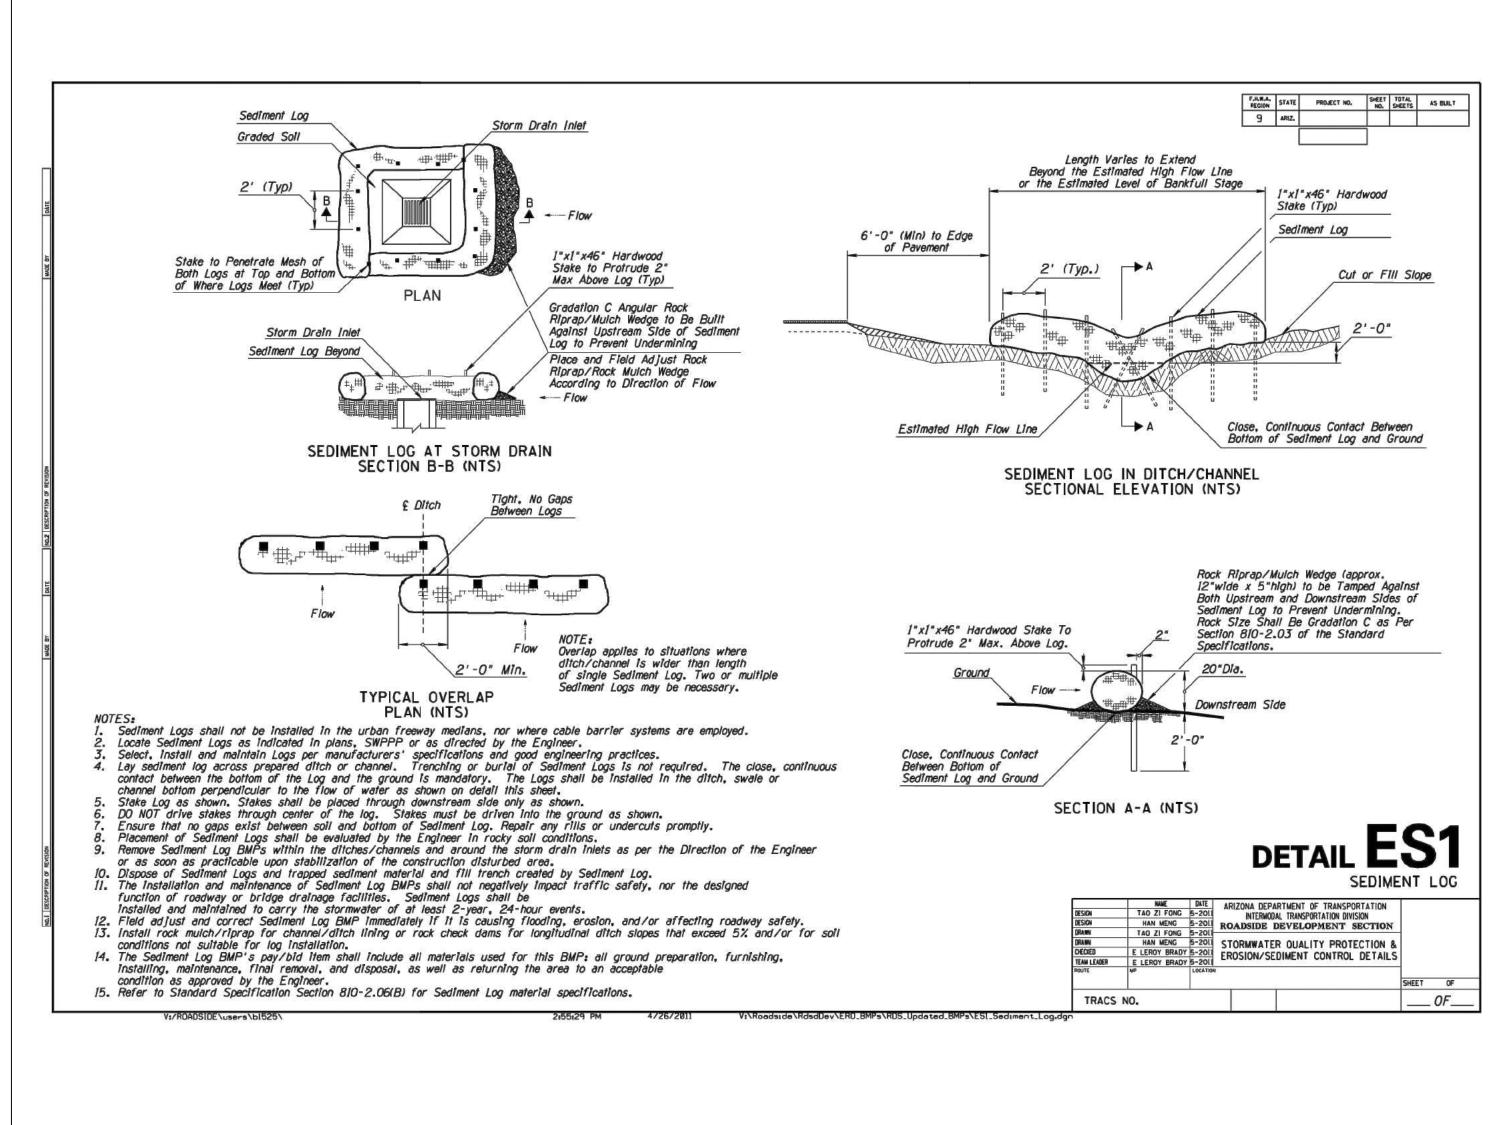

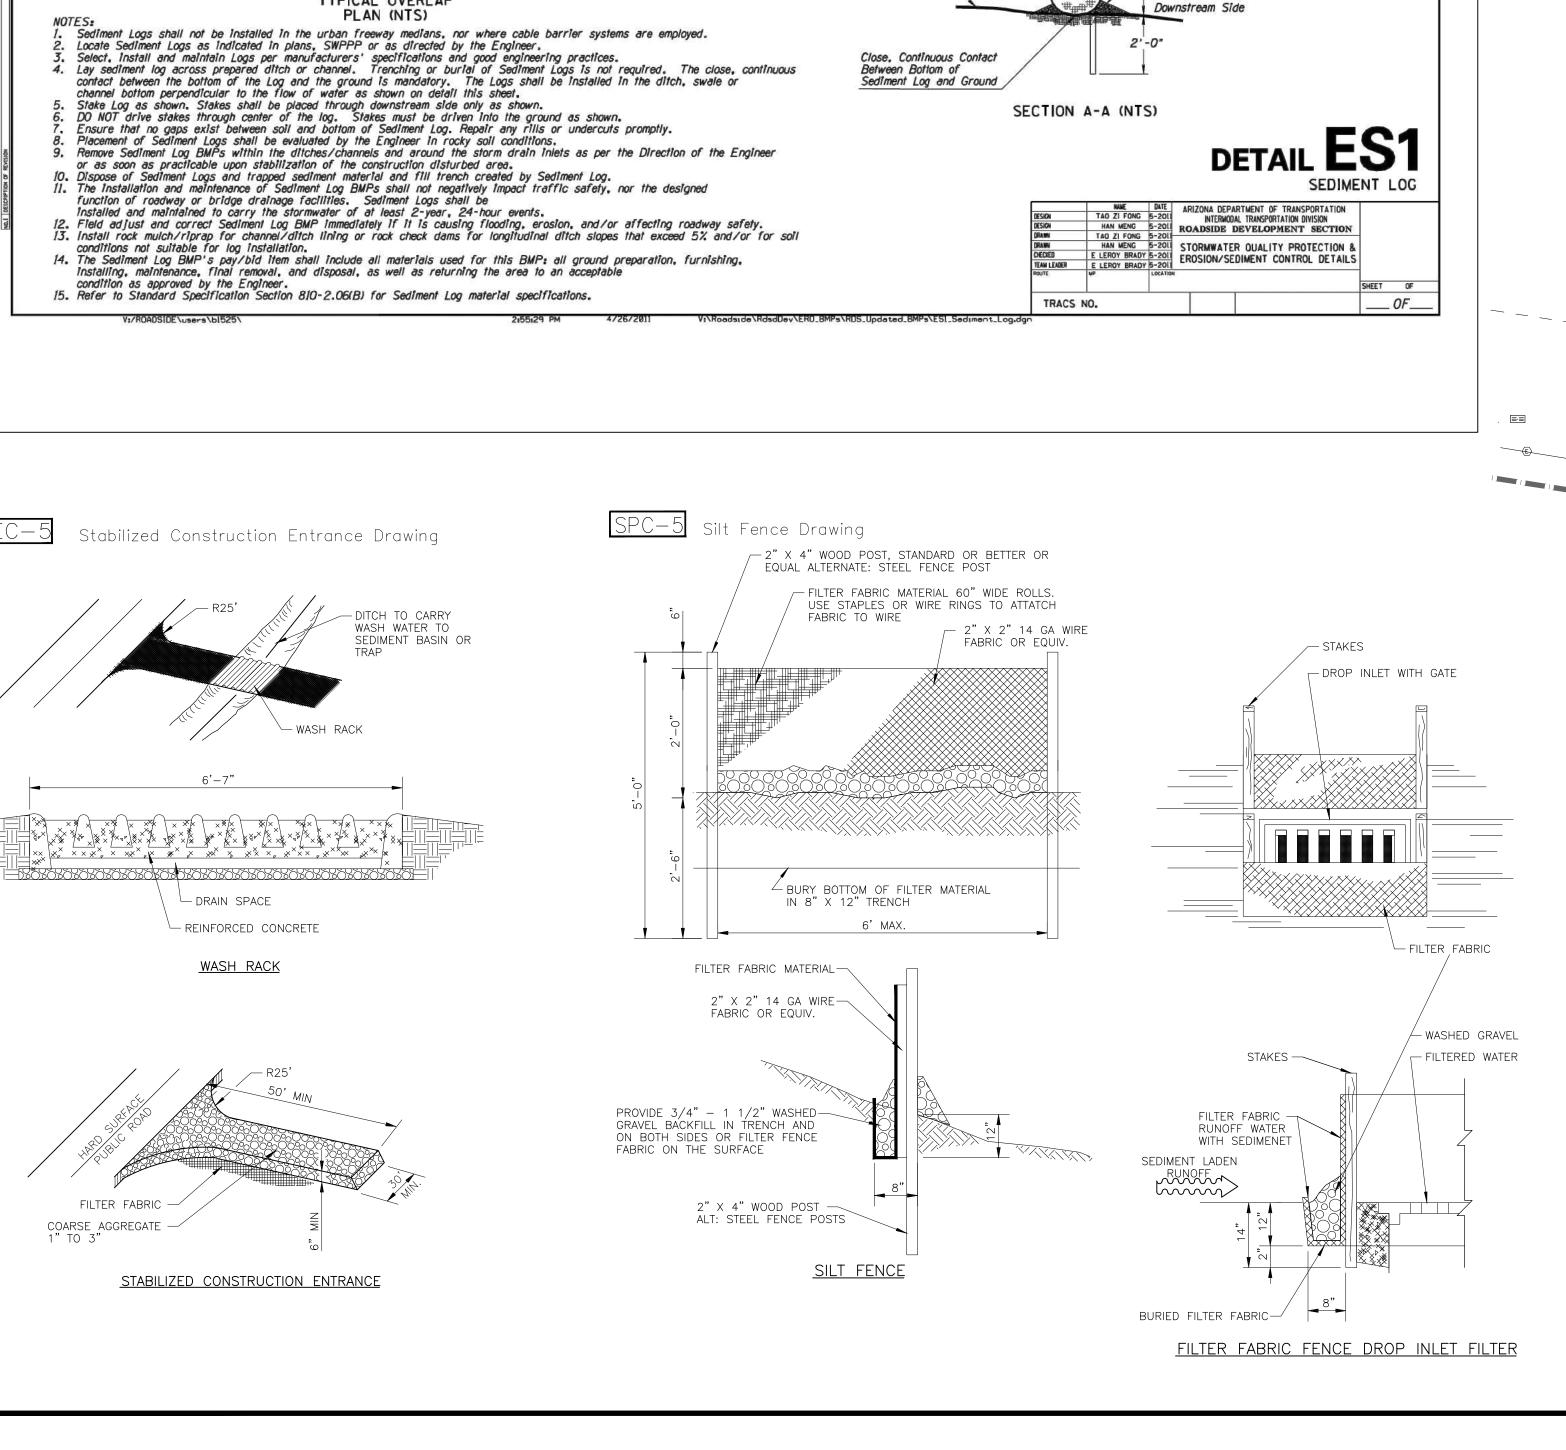

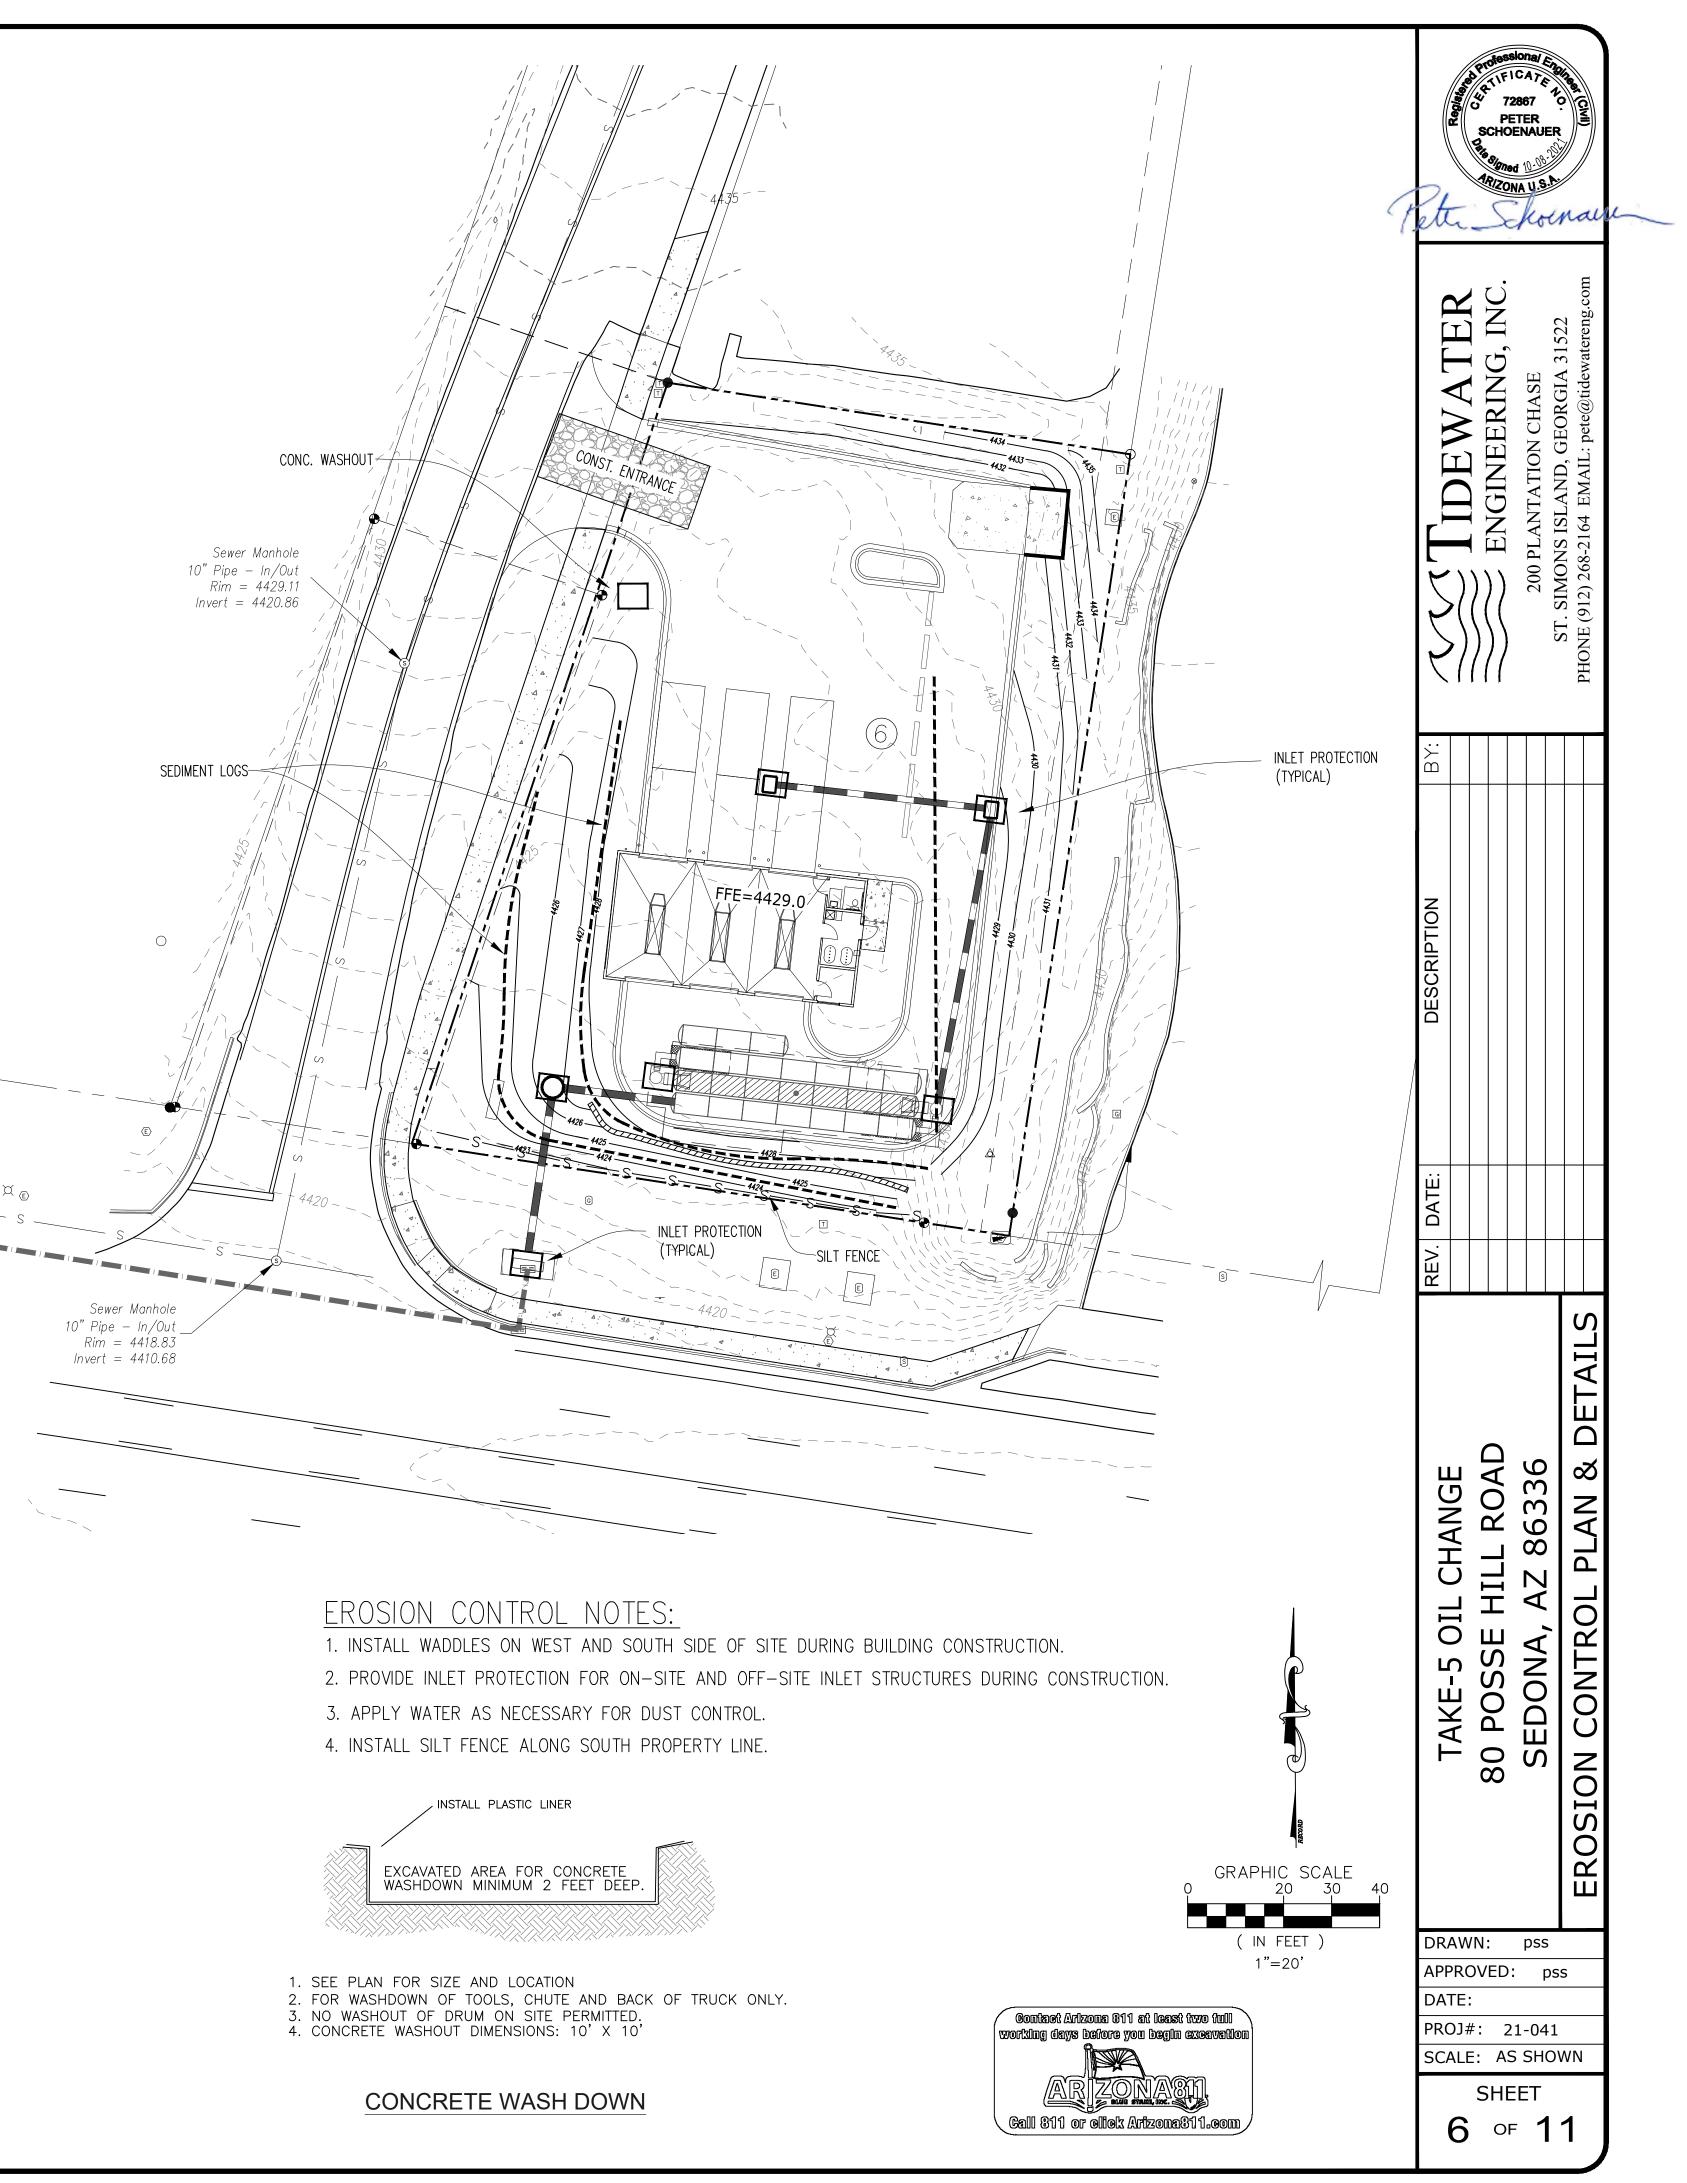

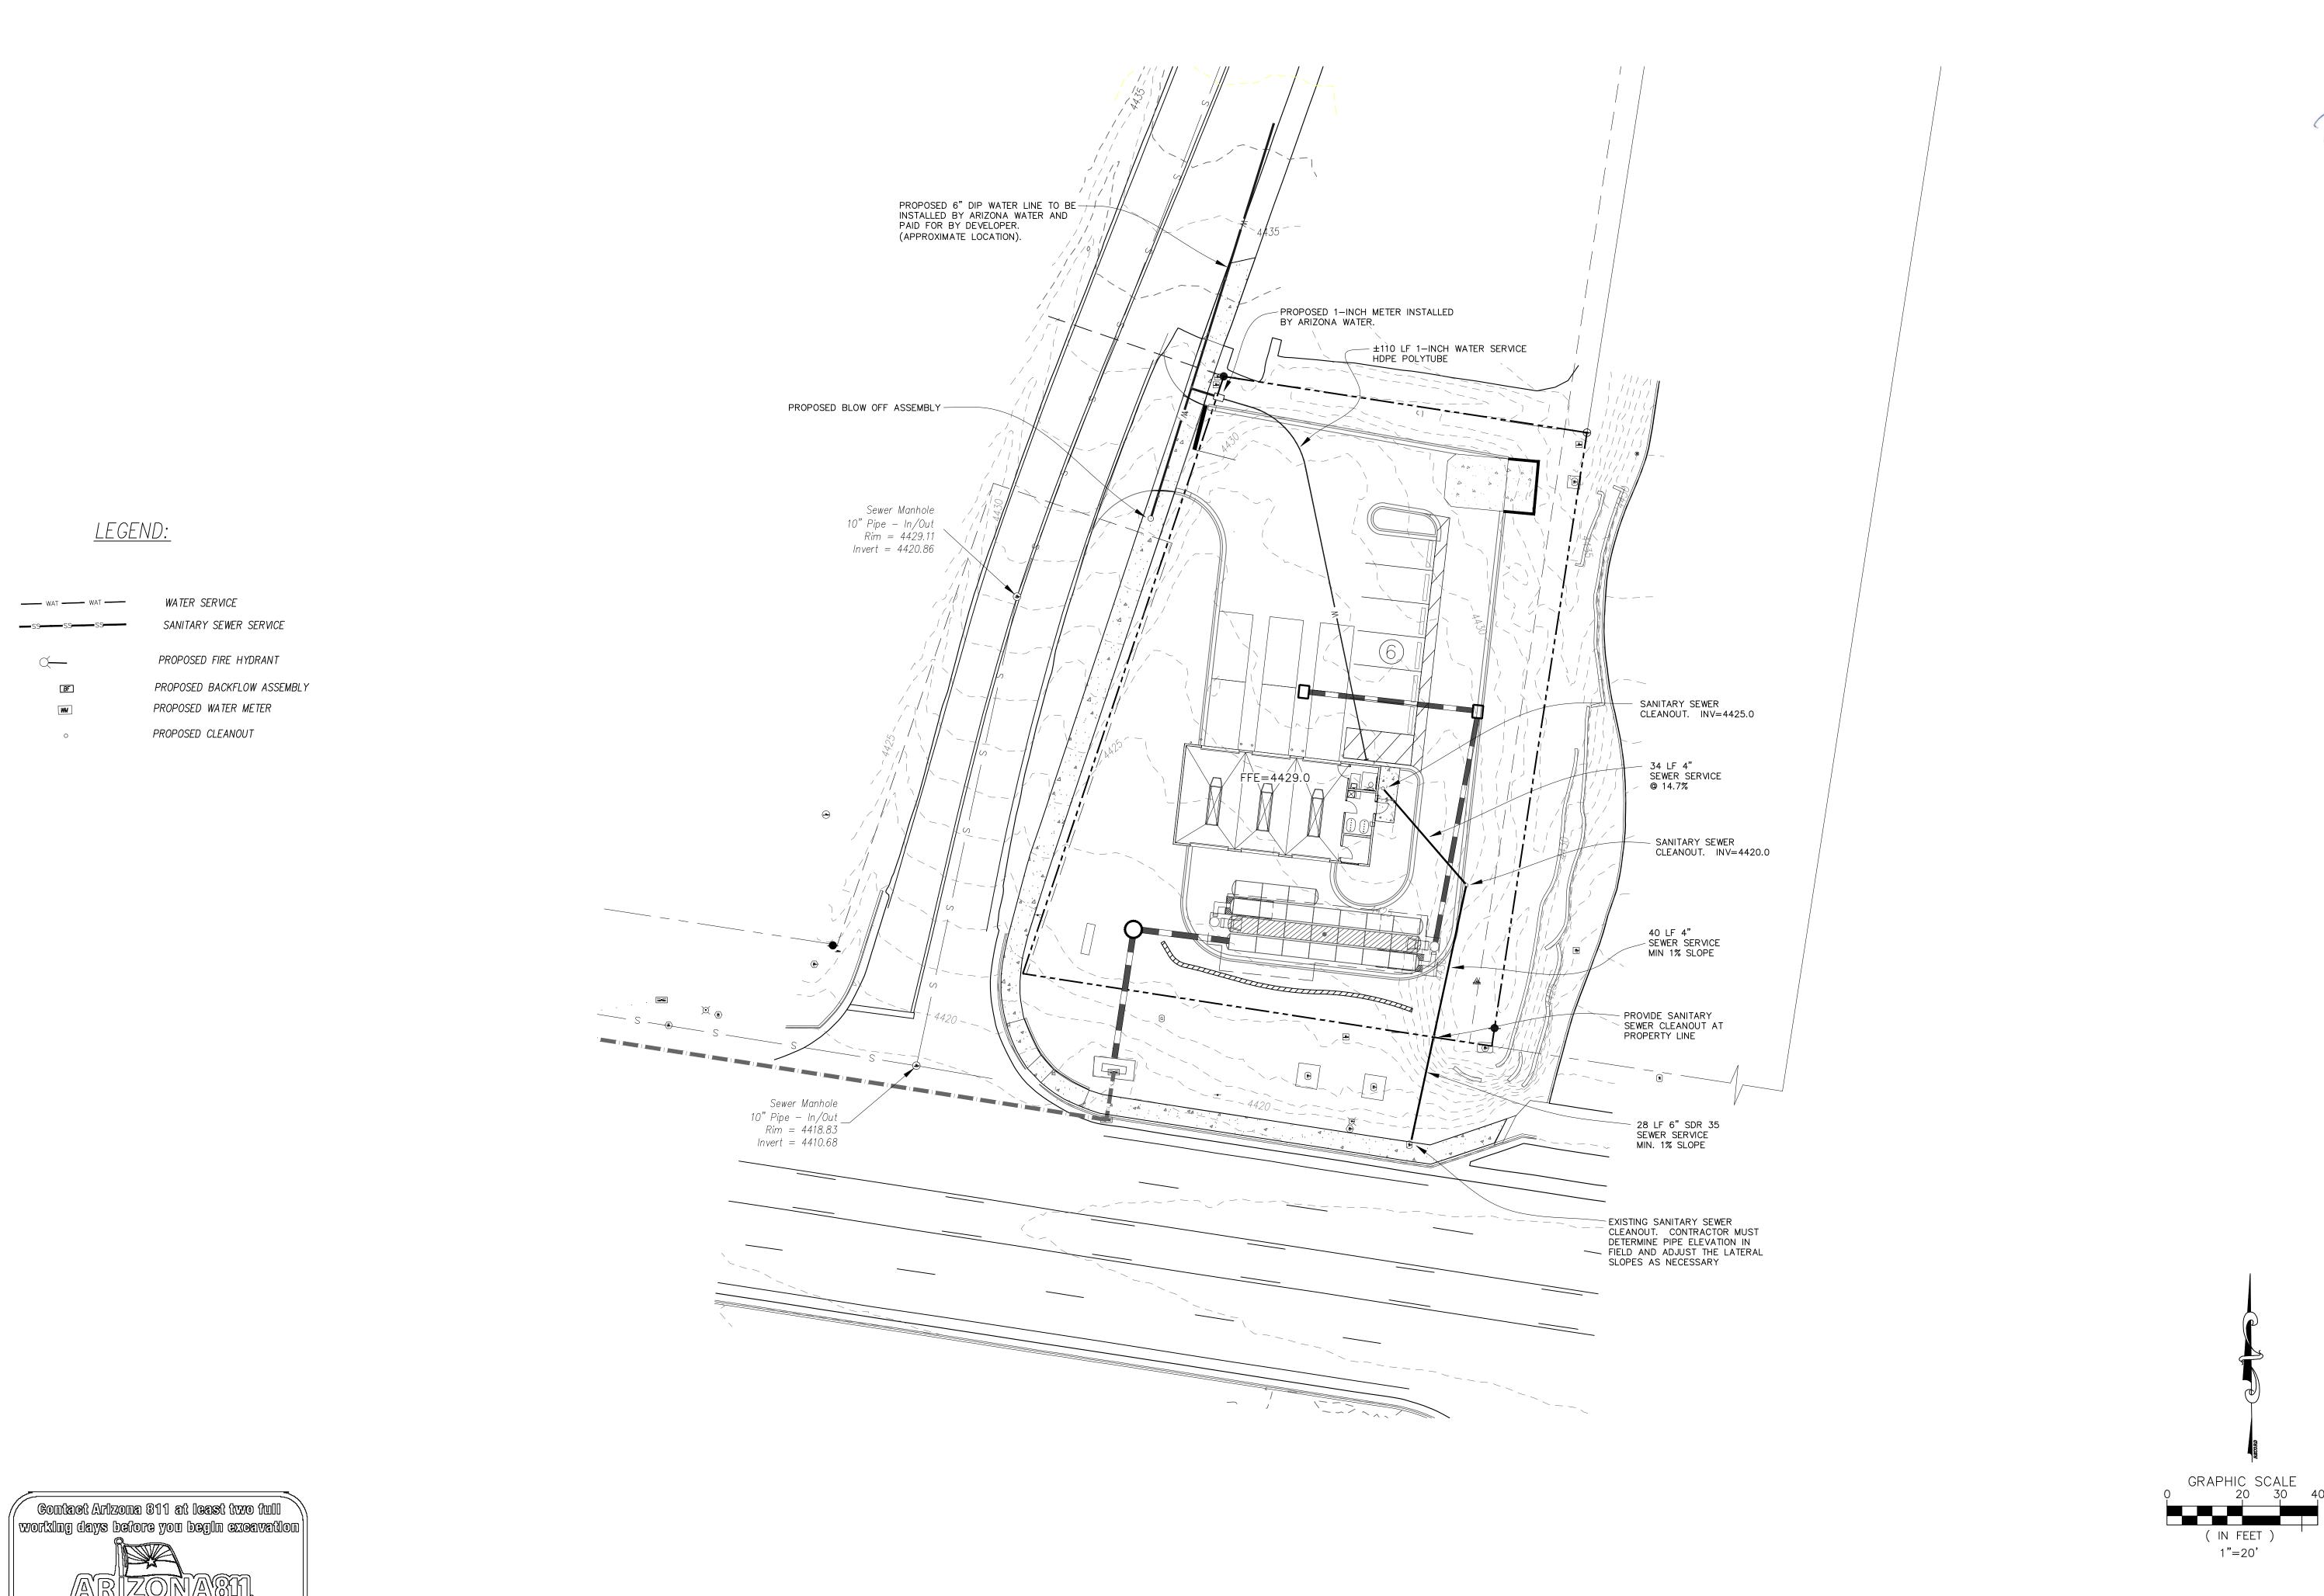

Call 811 or eliek Arizona811.com



TAKE-5 OIL CHANGE 80 POSSE HILL ROAD SEDONA, AZ 86336

DRAWN: pss

APPROVED: pss

DATE:


APPROVED: pss


DATE:


PROJ#: 21-041


SCALE: AS SHOWN


SHEET **7** of **11**

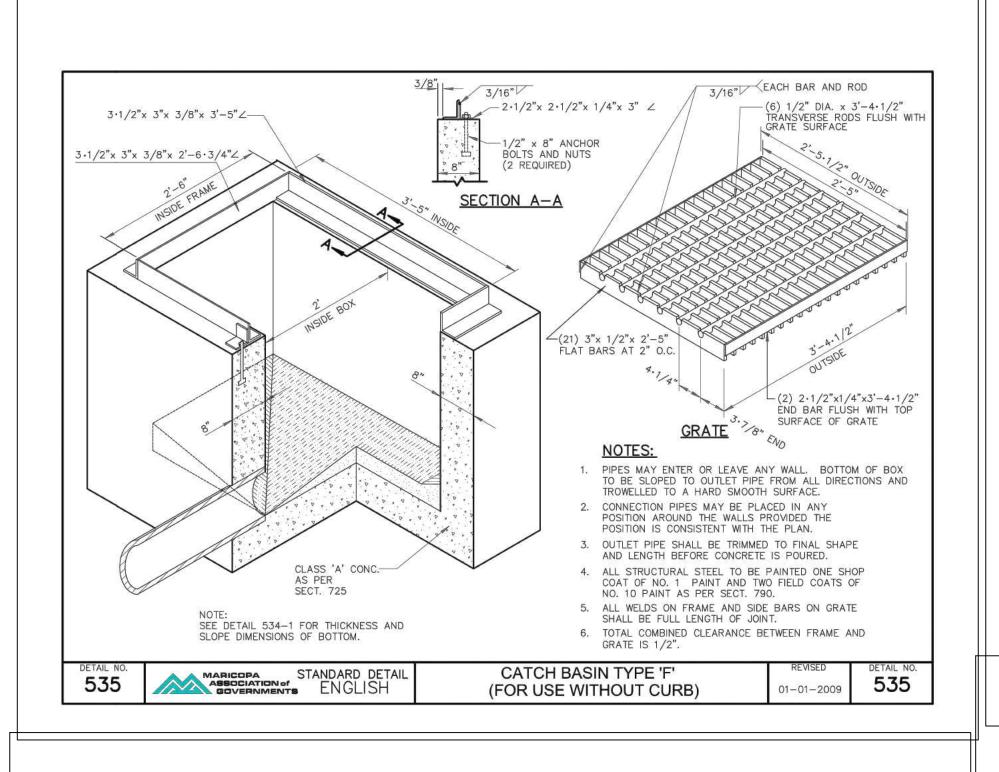


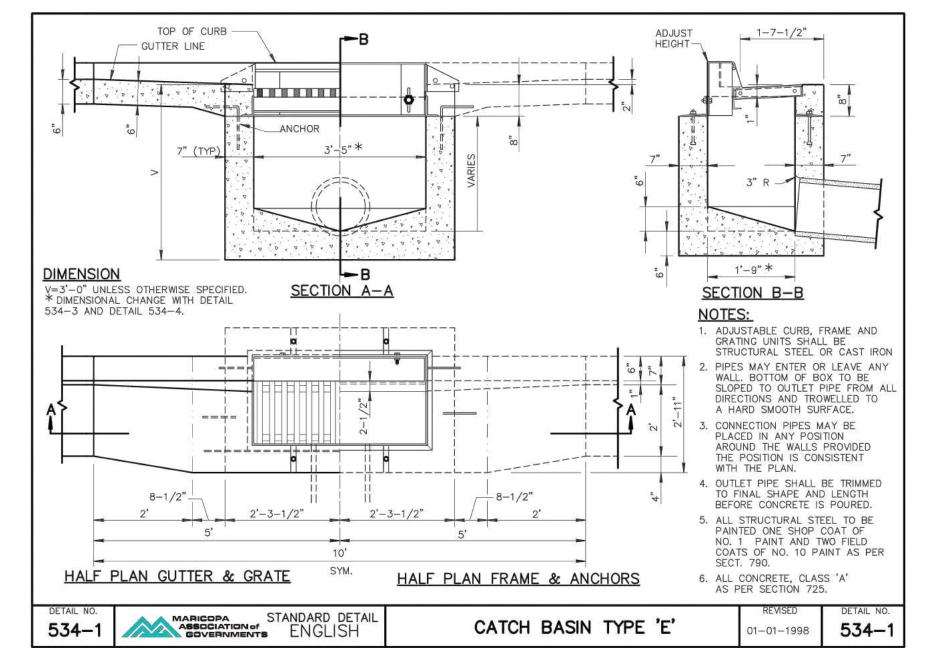


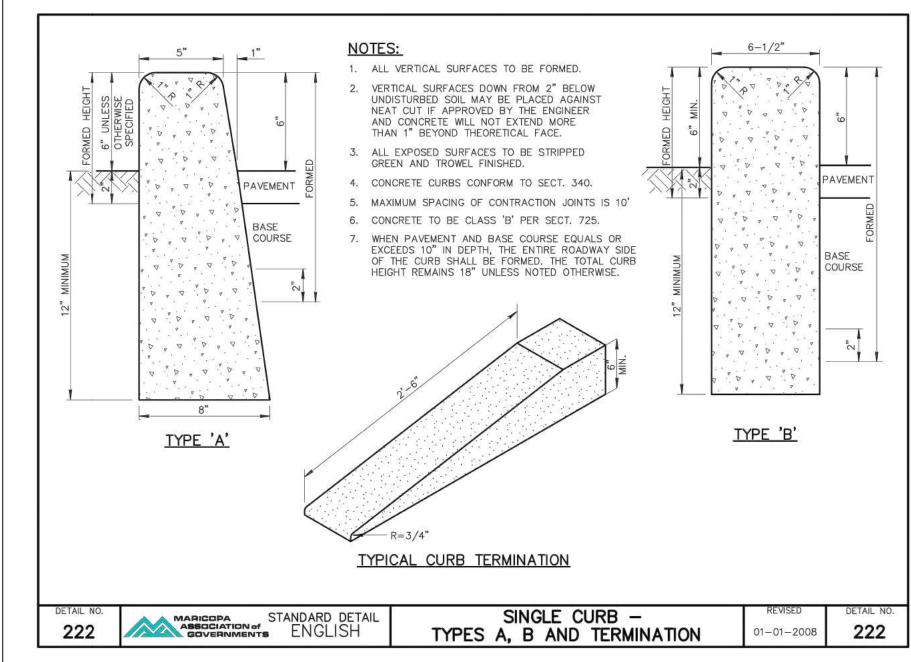


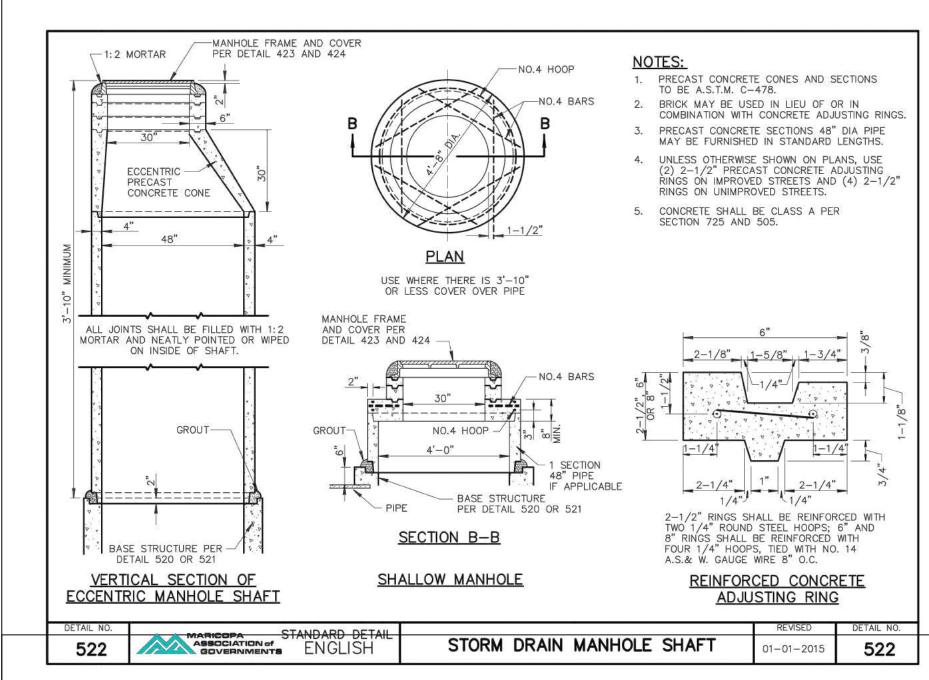


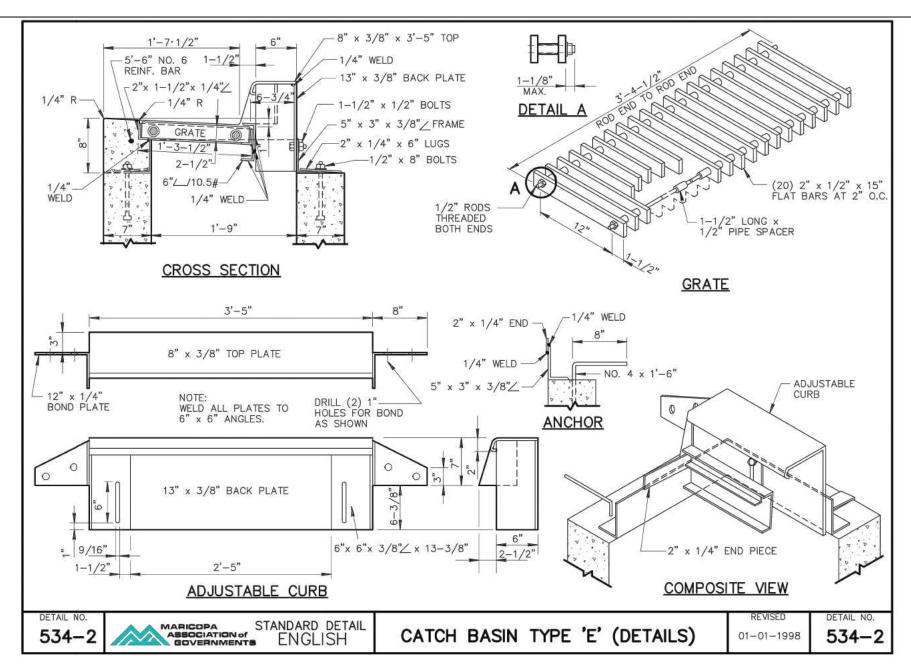


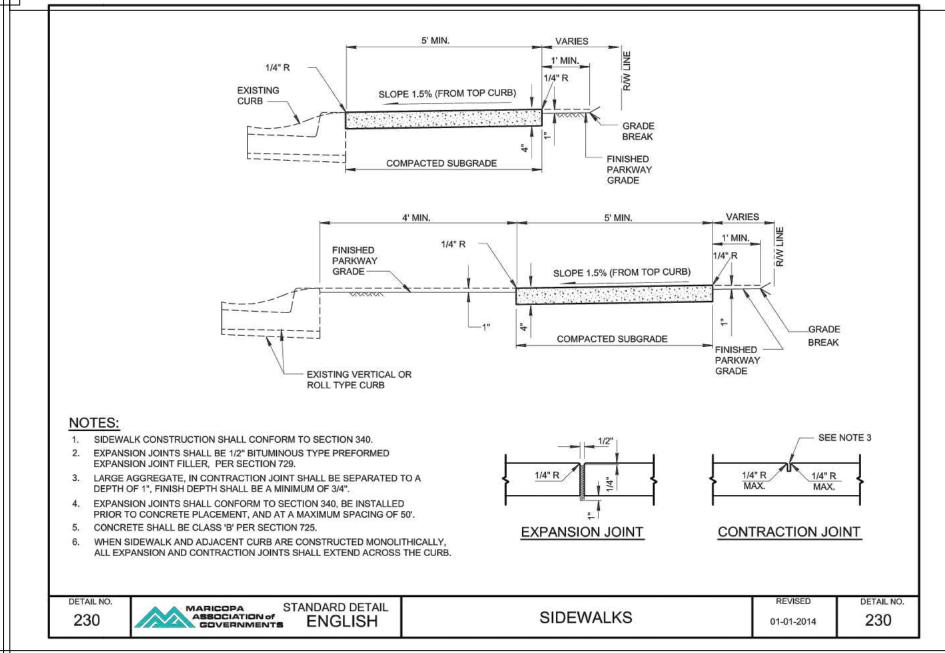

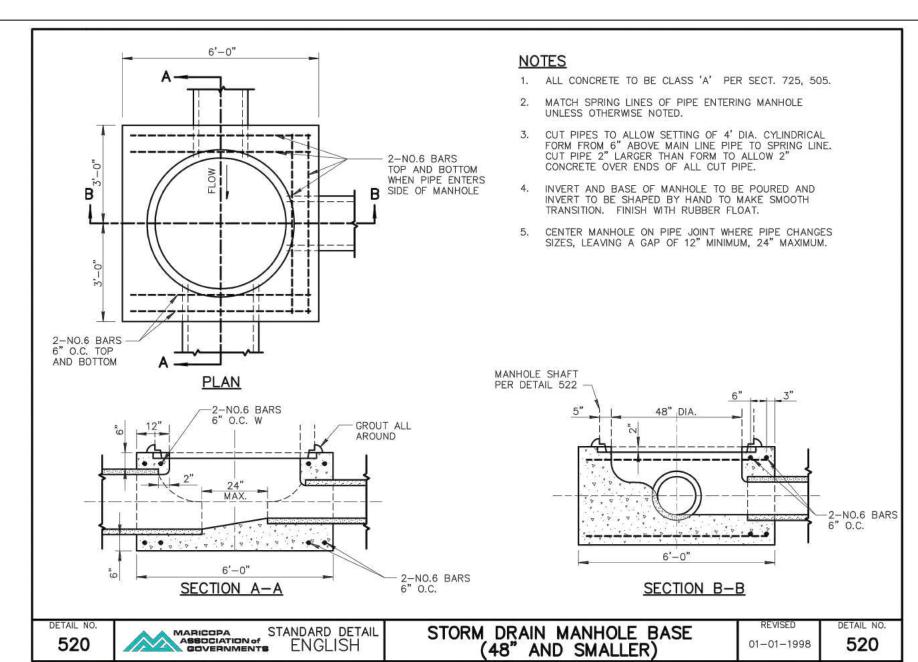

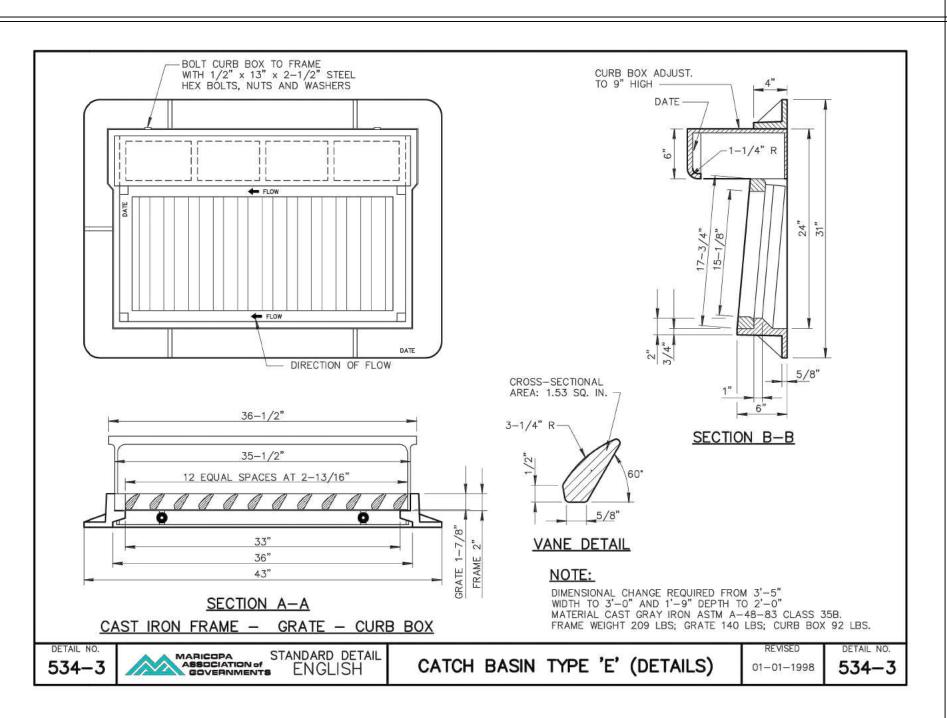

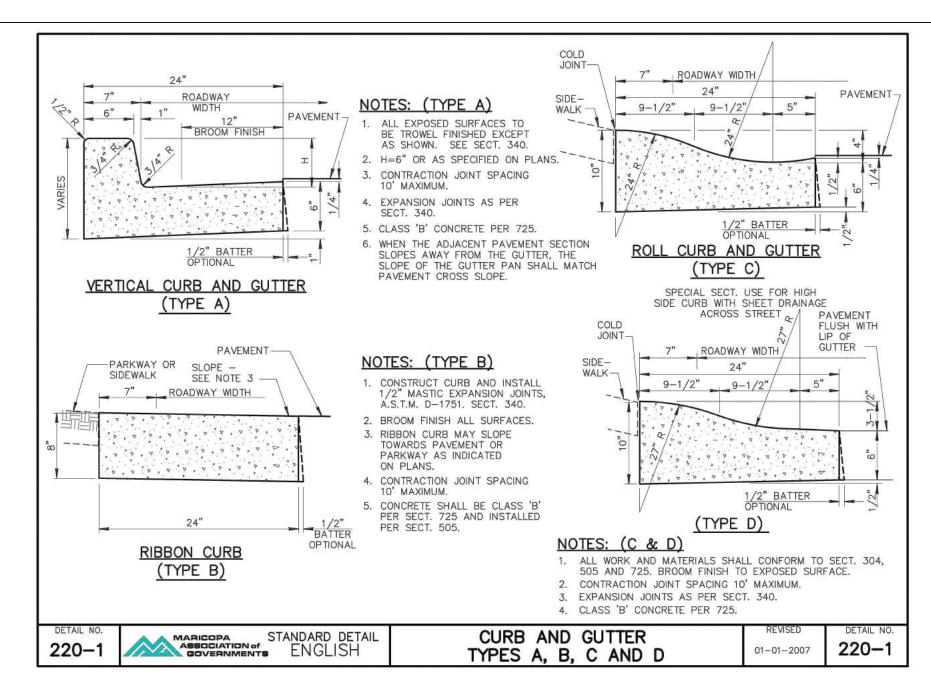

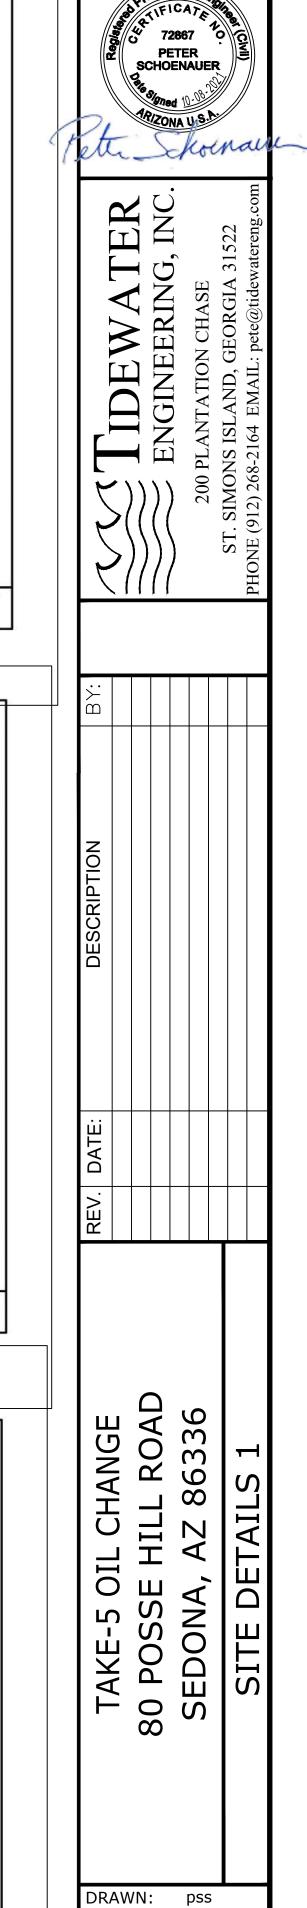

APPROVED: pss


PROJ#: 21-041


SCALE: AS SHOWN


SHEET

8 of 1

DATE:

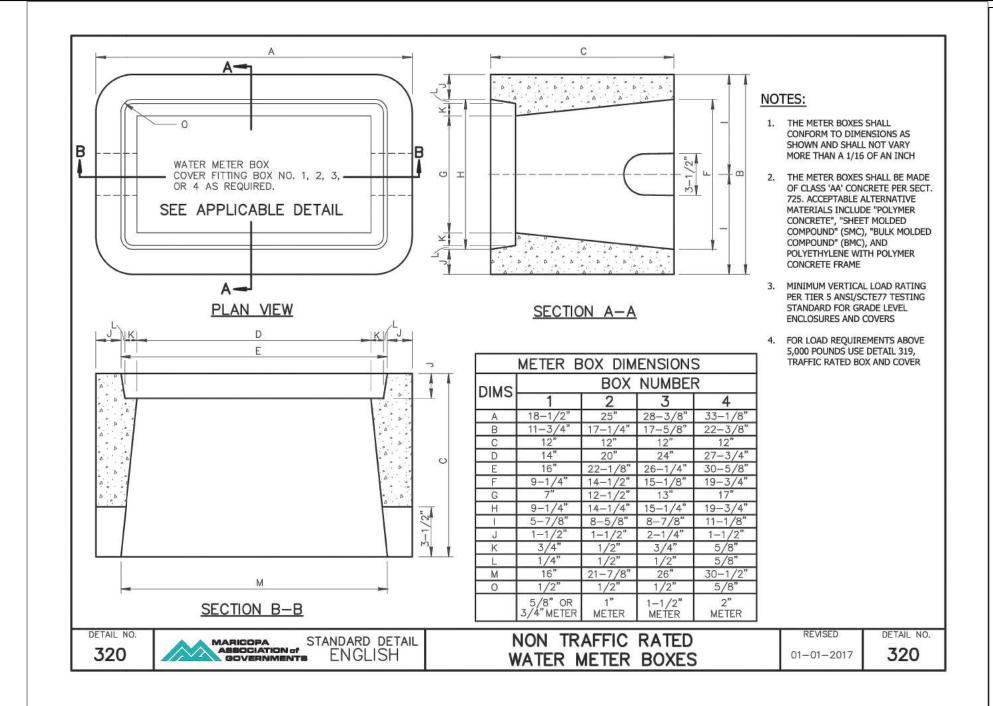

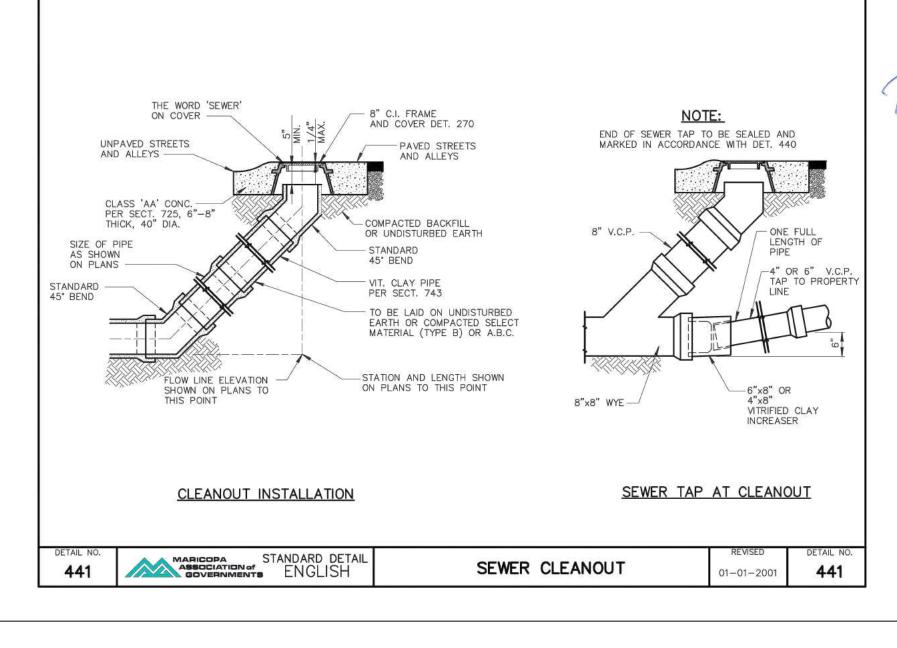

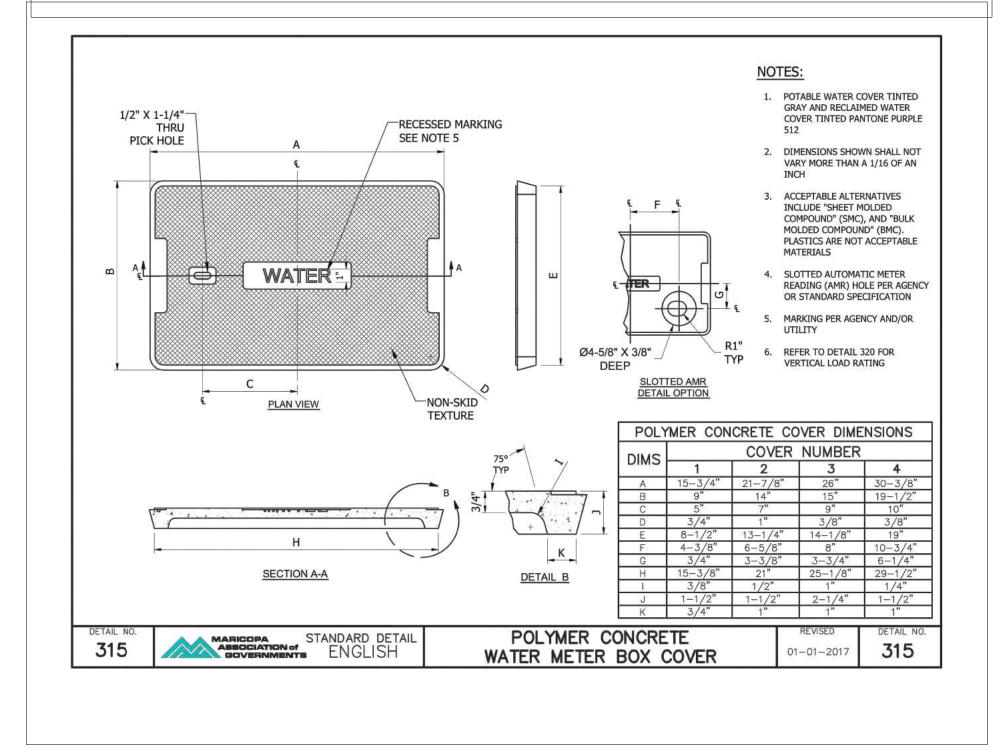

 REV. DATE:
 DESCRIPTION
 BY:

 Image: Control of the property of the

72867

SCHOENAUER

Skocnall

TAKE-5 OIL CHANGE 80 POSSE HILL ROAD SEDONA, AZ 86336

DRAWN: pss
APPROVED: pss
DATE:
PROJ#: 21-041

SCALE: AS SHOWN
SHEET
9 OF 11

PROJECT INFORMATION					
I IVOSEC	71 IINI OINIMATION				
ENGINEERED PRODUCT MANAGER					
ADS SALES REP					





TAKE 5 OIL CHANGE SEDONA

SEDONA, AZ

SC-740 STORMTECH CHAMBER SPECIFICATIONS

- CHAMBERS SHALL BE STORMTECH SC-740.
- CHAMBERS SHALL BE ARCH-SHAPED AND SHALL BE MANUFACTURED FROM VIRGIN, IMPACT-MODIFIED POLYPROPYLENE COPOLYMERS.
- 3. CHAMBERS SHALL MEET THE REQUIREMENTS OF ASTM F2418-16a, "STANDARD SPECIFICATION FOR POLYPROPYLENE (PP) CORRUGATED WALL STORMWATER COLLECTION CHAMBERS".
- 4. CHAMBER ROWS SHALL PROVIDE CONTINUOUS, UNOBSTRUCTED INTERNAL SPACE WITH NO INTERNAL SUPPORTS THAT WOULD IMPEDE FLOW OR LIMIT ACCESS FOR INSPECTION.
- 5. THE STRUCTURAL DESIGN OF THE CHAMBERS, THE STRUCTURAL BACKFILL, AND THE INSTALLATION REQUIREMENTS SHALL ENSURE THAT THE LOAD FACTORS SPECIFIED IN THE AASHTO LRFD BRIDGE DESIGN SPECIFICATIONS, SECTION 12.12, ARE MET FOR: 1) LONG-DURATION DEAD LOADS AND 2) SHORT-DURATION LIVE LOADS, BASED ON THE AASHTO DESIGN TRUCK WITH CONSIDERATION
- CHAMBERS SHALL BE DESIGNED, TESTED AND ALLOWABLE LOAD CONFIGURATIONS DETERMINED IN ACCORDANCE WITH ASTM F2787,
 "STANDARD PRACTICE FOR STRUCTURAL DESIGN OF THERMOPLASTIC CORRUGATED WALL STORMWATER COLLECTION CHAMBERS".
 LOAD CONFIGURATIONS SHALL INCLUDE: 1) INSTANTANEOUS (<1 MIN) AASHTO DESIGN TRUCK LIVE LOAD ON MINIMUM COVER 2)
 MAXIMUM PERMANENT (75-YR) COVER LOAD AND 3) ALLOWABLE COVER WITH PARKED (1-WEEK) AASHTO DESIGN TRUCK.
- REQUIREMENTS FOR HANDLING AND INSTALLATION:
 TO MAINTAIN THE WIDTH OF CHAMBERS DURING SHIPPING AND HANDLING, CHAMBERS SHALL HAVE INTEGRAL, INTERLOCKING
- STACKING LUGS.

 TO ENSURE A SECURE JOINT DURING INSTALLATION AND BACKFILL, THE HEIGHT OF THE CHAMBER JOINT SHALL NOT BE LESS
- TO ENSURE THE INTEGRITY OF THE ARCH SHAPE DURING INSTALLATION, a) THE ARCH STIFFNESS CONSTANT AS DEFINED IN SECTION 6.2.8 OF ASTM F2418 SHALL BE GREATER THAN OR EQUAL TO 550 LBS/IN/IN. AND b) TO RESIST CHAMBER DEFORMATION DURING INSTALLATION AT ELEVATED TEMPERATURES (ABOVE 73° F / 23° C), CHAMBERS SHALL BE PRODUCED FROM REFLECTIVE GOLD OR YELLOW COLORS.
- 8. ONLY CHAMBERS THAT ARE APPROVED BY THE SITE DESIGN ENGINEER WILL BE ALLOWED. UPON REQUEST BY THE SITE DESIGN ENGINEER OR OWNER, THE CHAMBER MANUFACTURER SHALL SUBMIT A STRUCTURAL EVALUATION FOR APPROVAL BEFORE
- DELIVERING CHAMBERS TO THE PROJECT SITE AS FOLLOWS:

 THE STRUCTURAL EVALUATION FOR APPROVAL BEFORE

 THE STRUCTURAL EVALUATION SHALL BE SEALED BY A REGISTERED PROFESSIONAL ENGINEER.
- THE STRUCTURAL EVALUATION SHALL DEMONSTRATE THAT THE SAFETY FACTORS ARE GREATER THAN OR EQUAL TO 1.95 FOR DEAD LOAD AND 1.75 FOR LIVE LOAD, THE MINIMUM REQUIRED BY ASTM F2787 AND BY SECTIONS 3 AND 12.12 OF THE AASHTO LRFD BRIDGE DESIGN SPECIFICATIONS FOR THERMOPLASTIC PIPE.
 THE TEST DERIVED CREEP MODULUS AS SPECIFIED IN ASTM F2418 SHALL BE USED FOR PERMANENT DEAD LOAD DESIGN
- EXCEPT THAT IT SHALL BE THE 75-YEAR MODULUS USED FOR DESIGN.

 9. CHAMBERS AND END CAPS SHALL BE PRODUCED AT AN ISO 9001 CERTIFIED MANUFACTURING FACILITY.

IMPORTANT - NOTES FOR THE BIDDING AND INSTALLATION OF THE SC-740 SYSTEM


- STORMTECH SC-740 CHAMBERS SHALL NOT BE INSTALLED UNTIL THE MANUFACTURER'S REPRESENTATIVE HAS COMPLETED A PRE-CONSTRUCTION MEETING WITH THE INSTALLERS.
- 2. STORMTECH SC-740 CHAMBERS SHALL BE INSTALLED IN ACCORDANCE WITH THE "STORMTECH SC-310/SC-740/DC-780 CONSTRUCTION GUIDE".
- 3. CHAMBERS ARE NOT TO BE BACKFILLED WITH A DOZER OR AN EXCAVATOR SITUATED OVER THE CHAMBERS.
- STORMTECH RECOMMENDS 3 BACKFILL METHODS:


 STONESHOOTER LOCATED OFF THE CHAMBER BED.
- BACKFILL AS ROWS ARE BUILT USING AN EXCAVATOR ON THE FOUNDATION STONE OR SUBGRADE.
 BACKFILL FROM OUTSIDE THE EXCAVATION USING A LONG BOOM HOE OR EXCAVATOR.
- . THE FOUNDATION STONE SHALL BE LEVELED AND COMPACTED PRIOR TO PLACING CHAMBERS.
- 5. JOINTS BETWEEN CHAMBERS SHALL BE PROPERLY SEATED PRIOR TO PLACING STONE.
- MAINTAIN MINIMUM 6" (150 mm) SPACING BETWEEN THE CHAMBER ROWS.
 EMBEDMENT STONE SURROUNDING CHAMBERS MUST BE A CLEAN, CRUSHED, ANGULAR STONE 3/4-2" (20-50 mm).
- THE CONTRACTOR MUST REPORT ANY DISCREPANCIES WITH CHAMBER FOUNDATION MATERIALS BEARING CAPACITIES TO THE SITE DESIGN ENGINEER.
- ADS RECOMMENDS THE USE OF "FLEXSTORM CATCH IT" INSERTS DURING CONSTRUCTION FOR ALL INLETS TO PROTECT THE SUBSURFACE STORMWATER MANAGEMENT SYSTEM FROM CONSTRUCTION SITE RUNOFF.


NOTES FOR CONSTRUCTION EQUIPMENT


- 1. STORMTECH SC-740 CHAMBERS SHALL BE INSTALLED IN ACCORDANCE WITH THE "STORMTECH SC-310/SC-740/DC-780 CONSTRUCTION GUIDE".
- THE USE OF CONSTRUCTION EQUIPMENT OVER SC-740 CHAMBERS IS LIMITED:
 NO EQUIPMENT IS ALLOWED ON BARE CHAMBERS.
 - NO RUBBER TIRED LOADERS, DUMP TRUCKS, OR EXCAVATORS ARE ALLOWED UNTIL PROPER FILL DEPTHS ARE REACHED IN ACCORDANCE
 WITH THE "STORMTECH SC-310/SC-740/DC-780 CONSTRUCTION GUIDE".
- WEIGHT LIMITS FOR CONSTRUCTION EQUIPMENT CAN BE FOUND IN THE "STORMTECH SC-310/SC-740/DC-780 CONSTRUCTION GUIDE".
 FULL 36" (900 mm) OF STABILIZED COVER MATERIALS OVER THE CHAMBERS IS REQUIRED FOR DUMP TRUCK TRAVEL OR DUMPING.
- USE OF A DOZER TO PUSH EMBEDMENT STONE BETWEEN THE ROWS OF CHAMBERS MAY CAUSE DAMAGE TO THE CHAMBERS AND IS NOT AN ACCEPTABLE BACKFILL METHOD. ANY CHAMBERS DAMAGED BY THE "DUMP AND PUSH" METHOD ARE NOT COVERED UNDER THE STORMTECH

CONTACT STORMTECH AT 1-888-892-2694 WITH ANY QUESTIONS ON INSTALLATION REQUIREMENTS OR WEIGHT LIMITS FOR CONSTRUCTION EQUIPMENT.

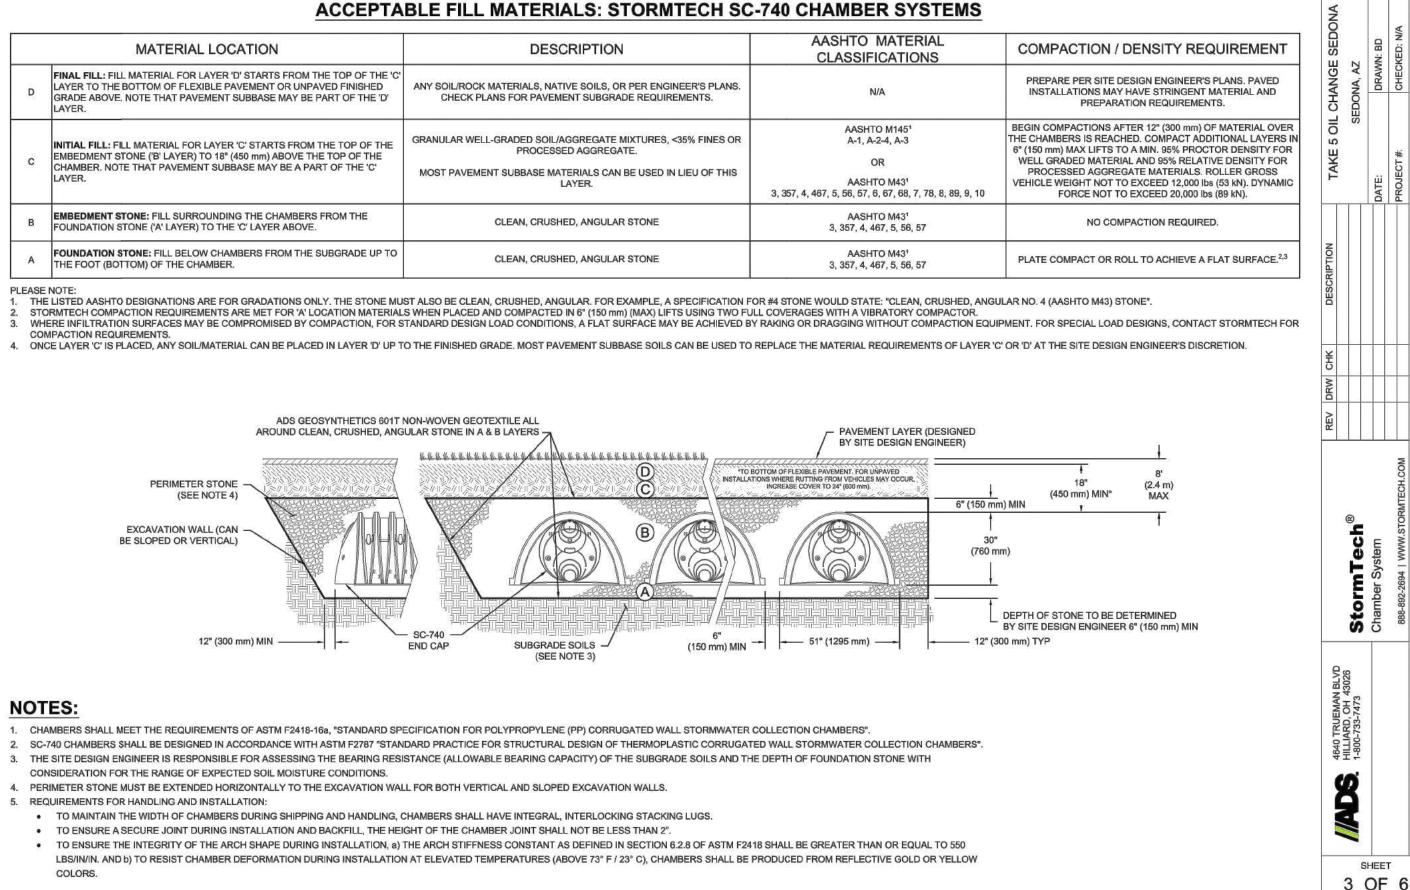

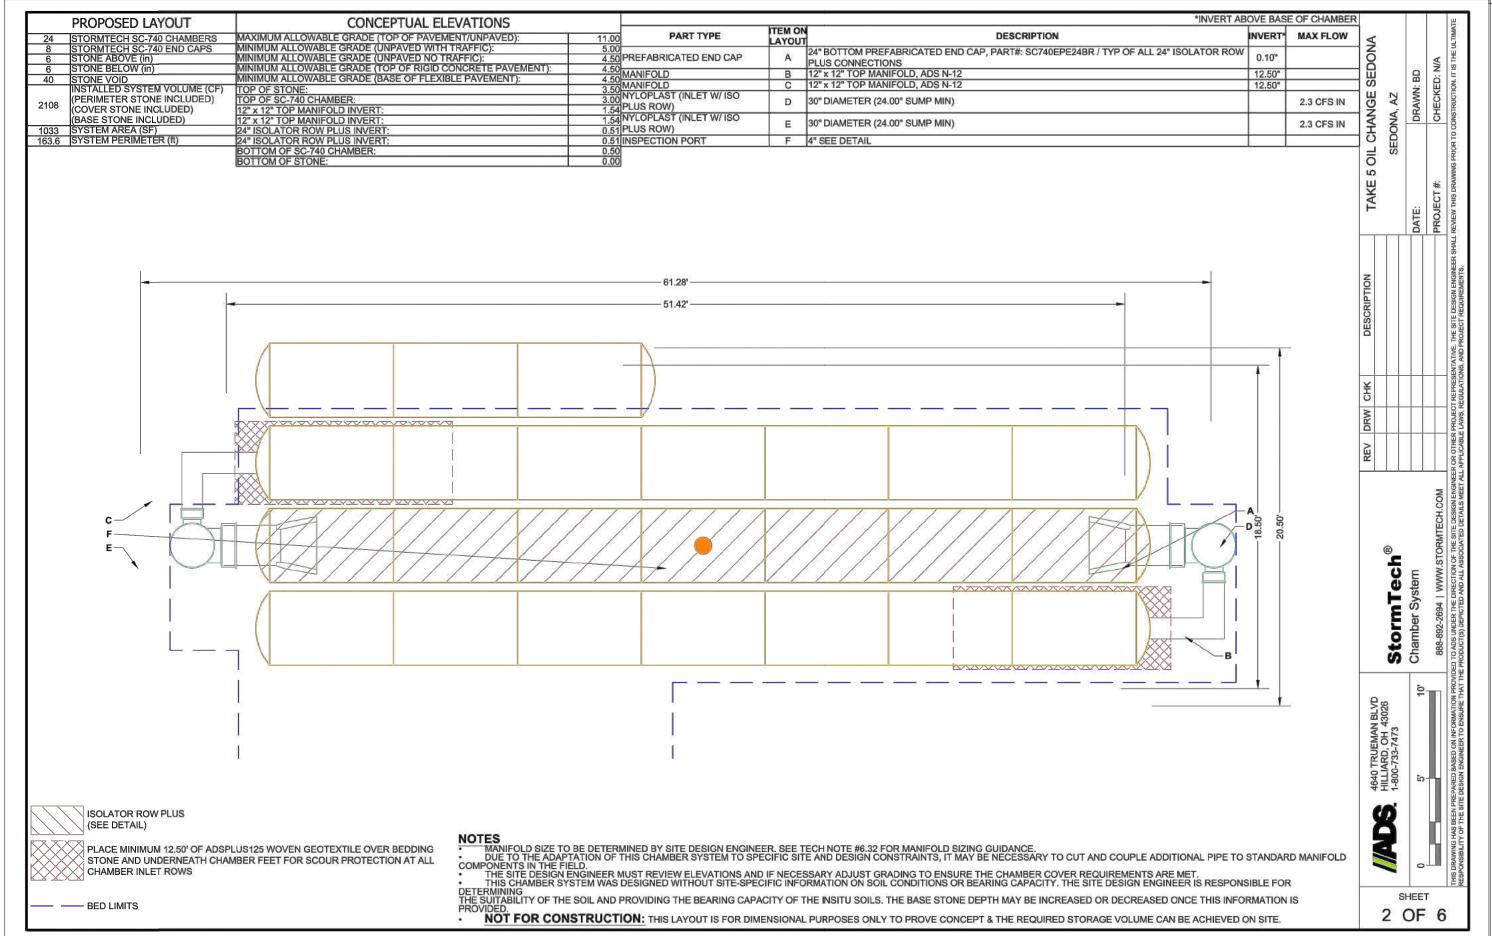

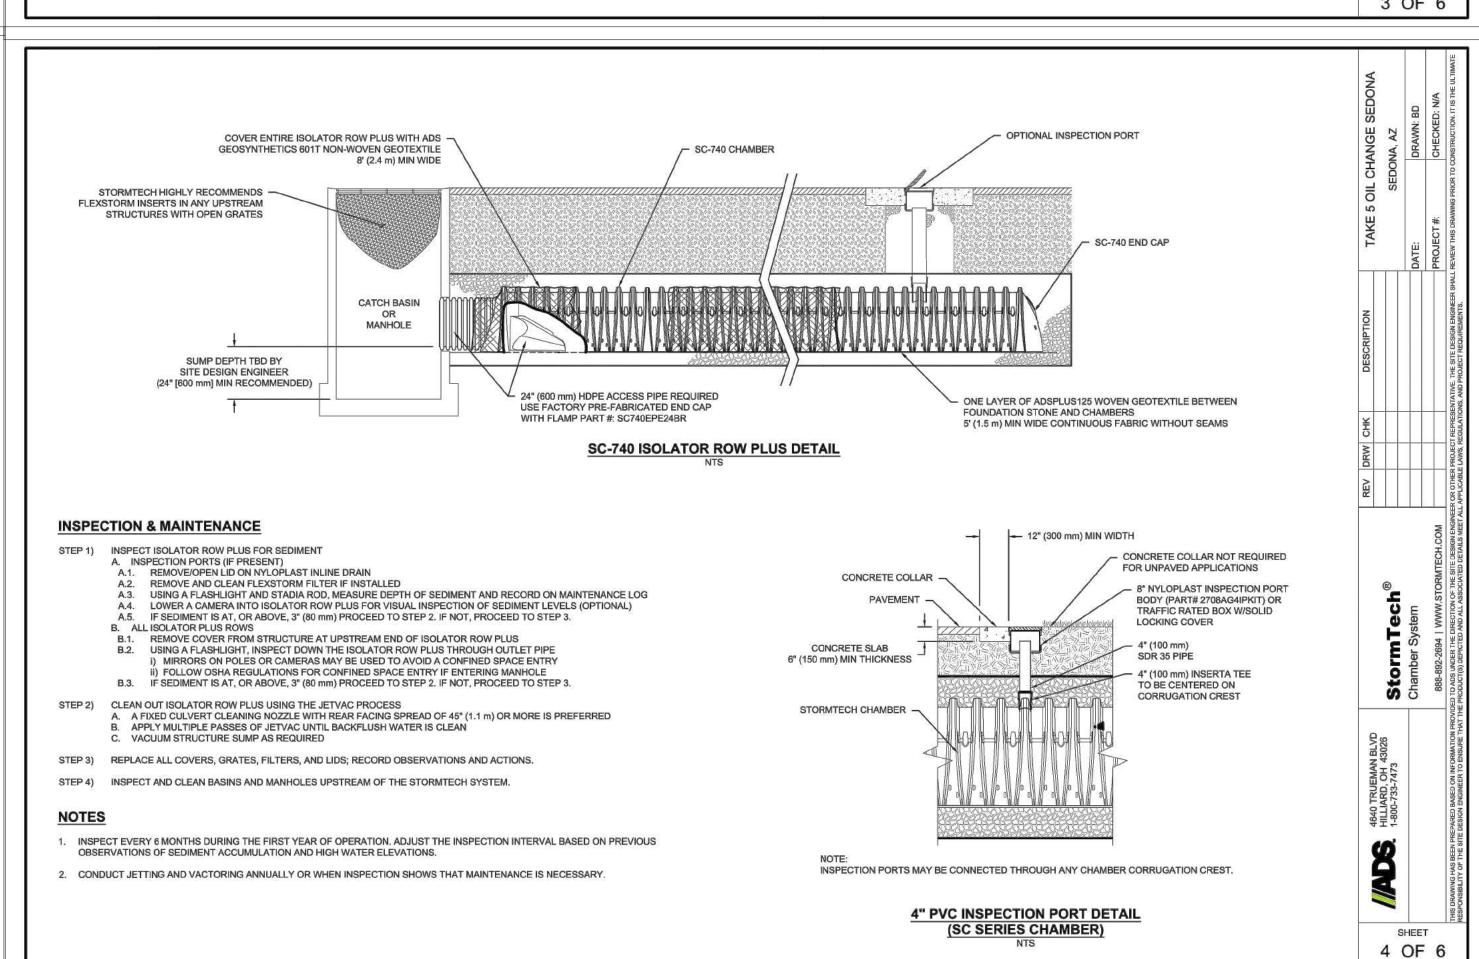

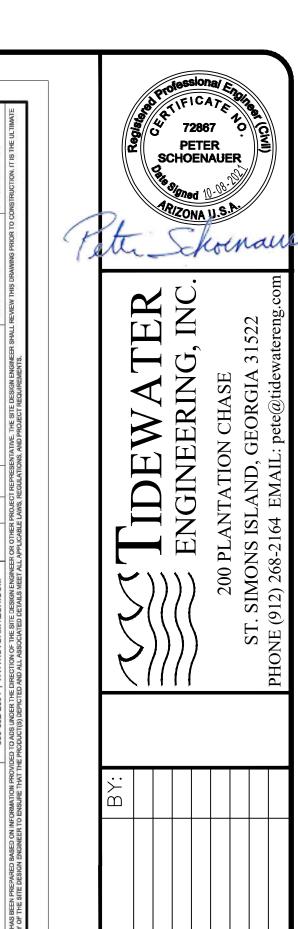



TAKE-5 OIL CHANGE 80 POSSE HILL ROAD SEDONA, AZ 86336

DRAWN: pss
APPROVED: pss
DATE:

PROJ#: 21-041 SCALE: AS SHOWN

SHEET 10 of 11

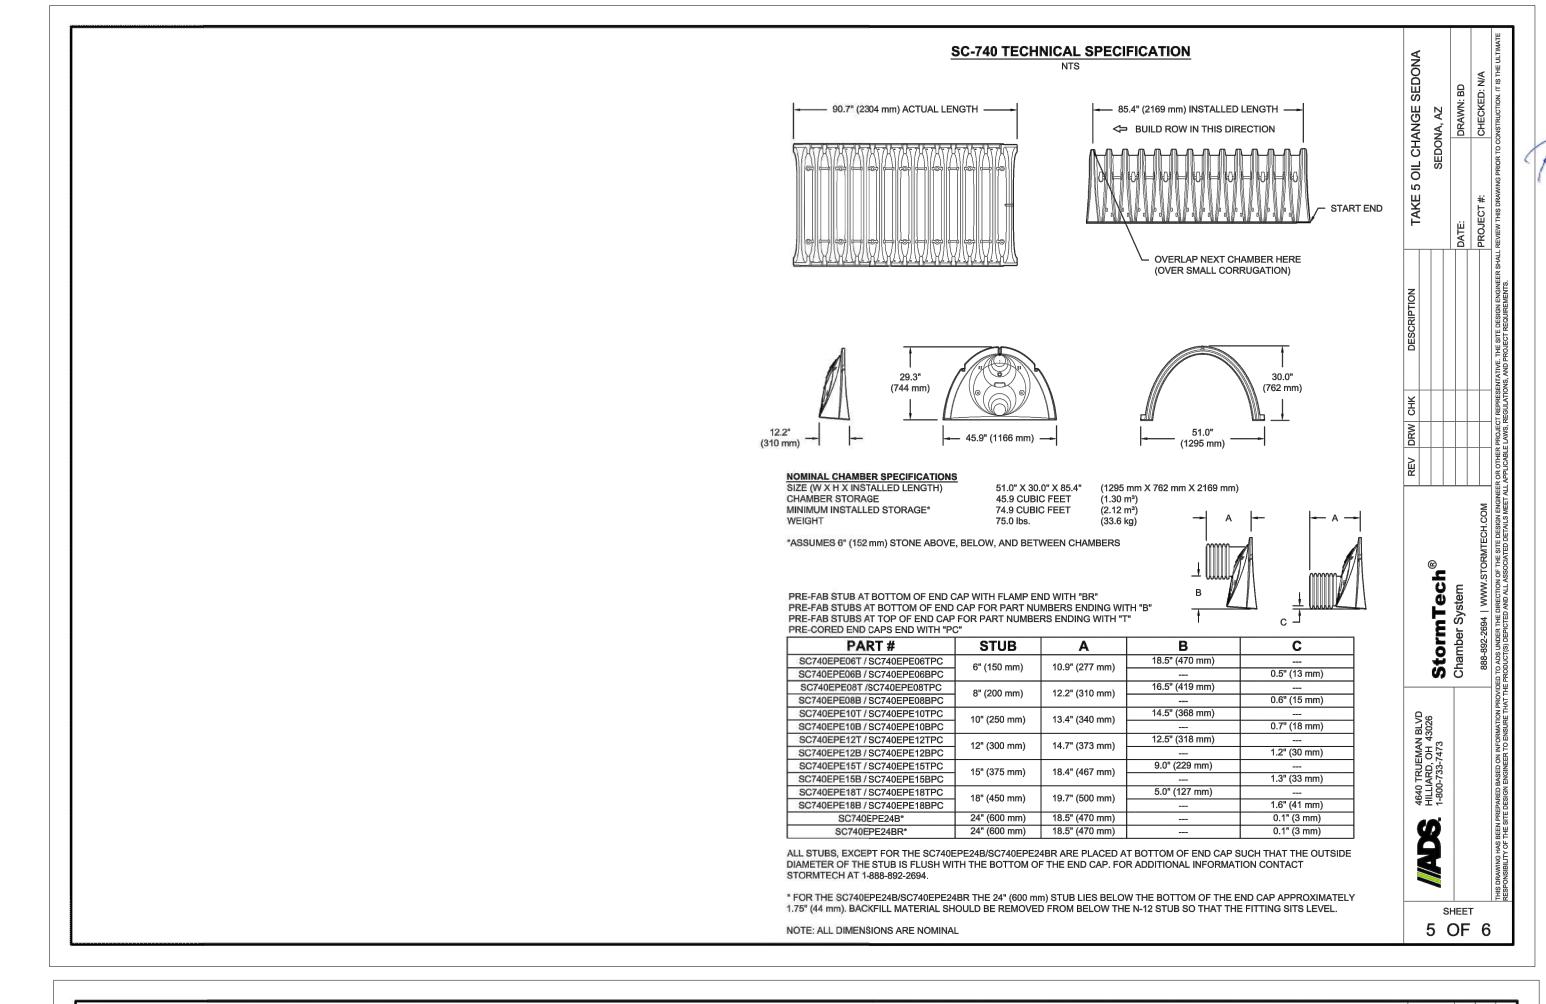

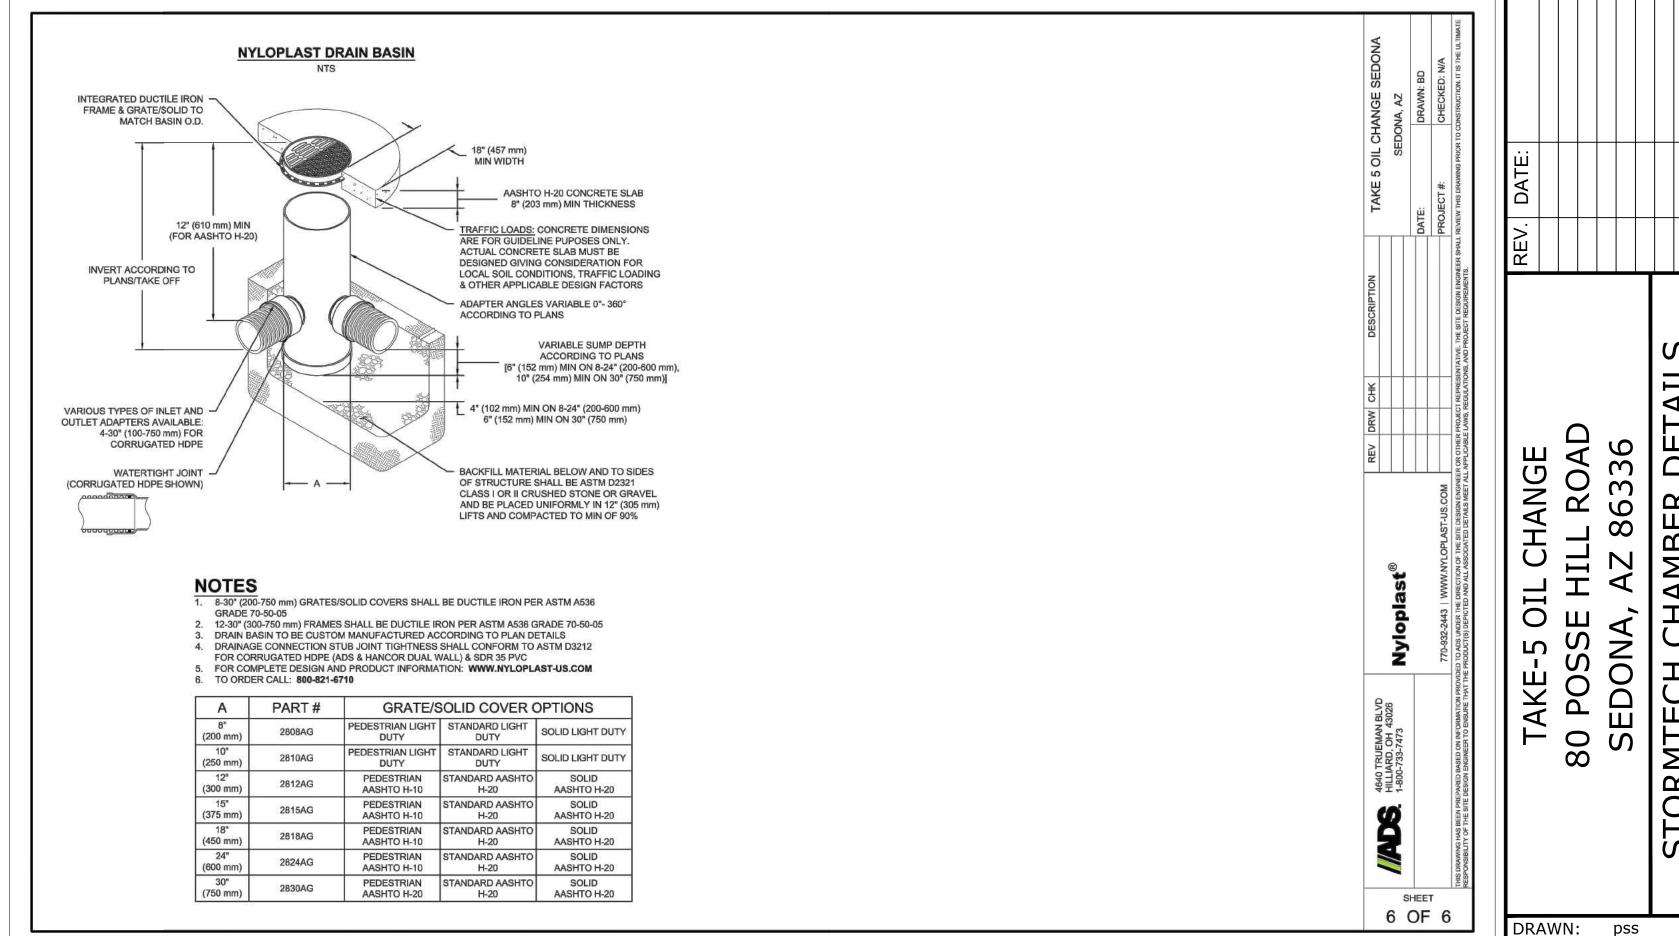



 ANGE
 REV. DATE:
 DESCRIPTION
 BY:

 ROAD
 CCCT
 T


 86336
 ST. SIMONS ISL


 ER DETAILS
 PHONE (912) 268-2164

DRAWN: pss
APPROVED: pss
DATE:
PROJ#: 21-041

SCALE: AS SHOWN
SHEET
11 OF 11

MASTER SIGN PLAN

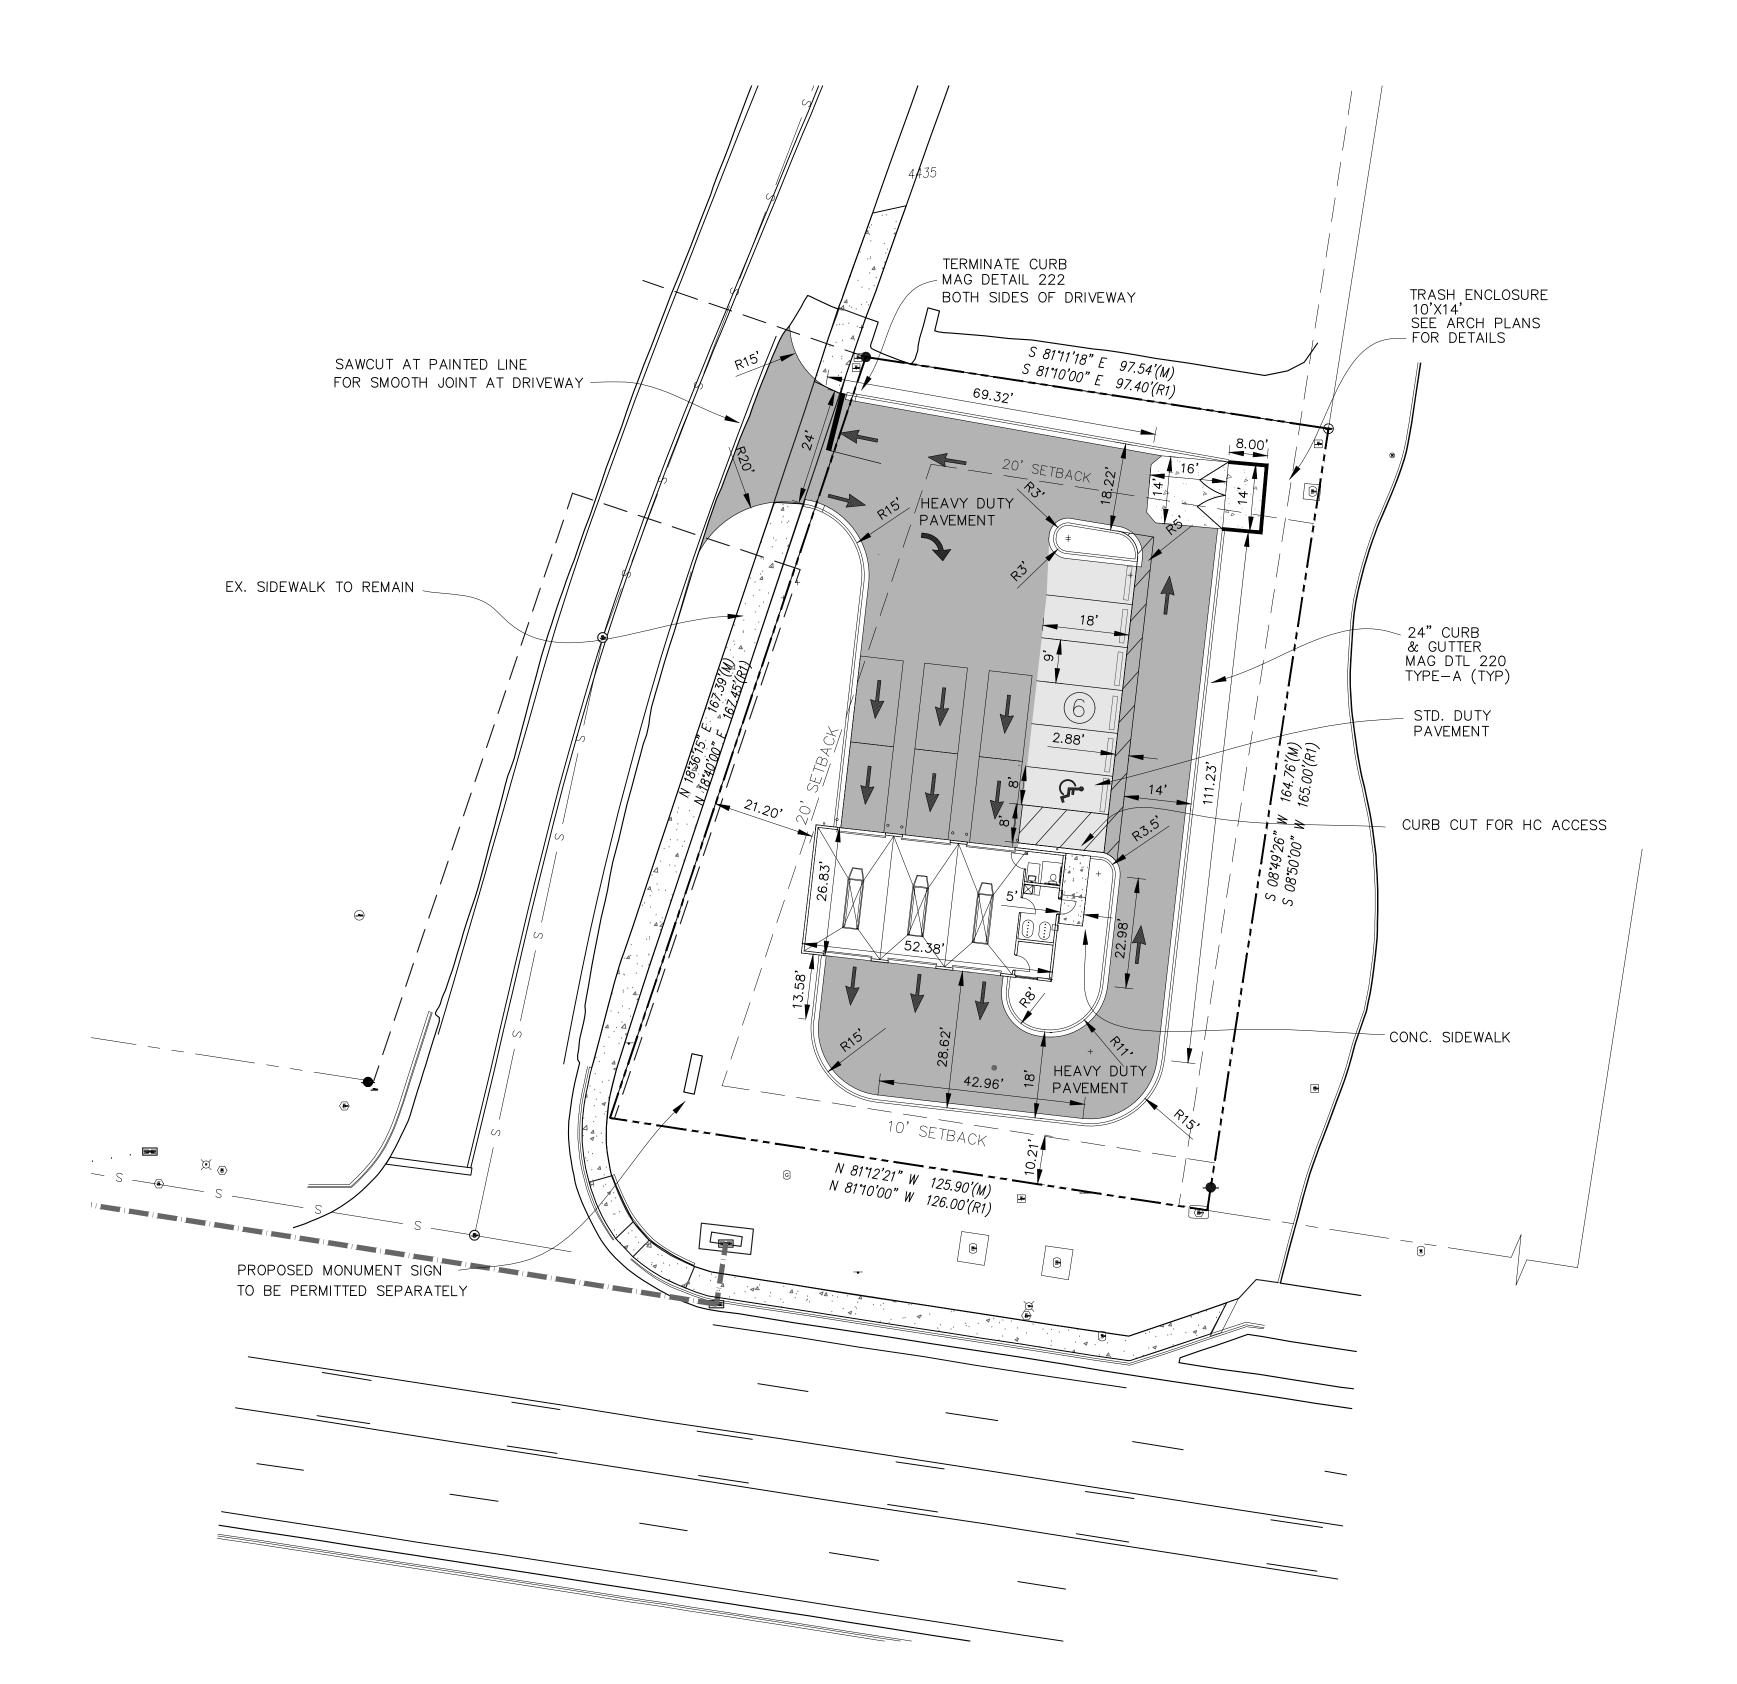

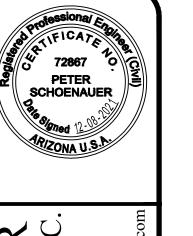

ENGINEERING, INC.

200 PLANTATION CHASE
ST. SIMONS ISLAND, GEORGIA 31522
PHONE (912) 268-2164 EMAIL: pete@tidewatereng.com

BY:				
DESCRIPTION				
REV. DATE:				
REV.				


TAKE-5 OIL CHANGE 80 POSSE HILL ROAD SEDONA, AZ 86336

DRAWN: pss
APPROVED: pss
DATE:

(IN FEET) 1"=20'

PROJ#: 21-041 SCALE: AS SHOWN

SHEET **1** OF **1**

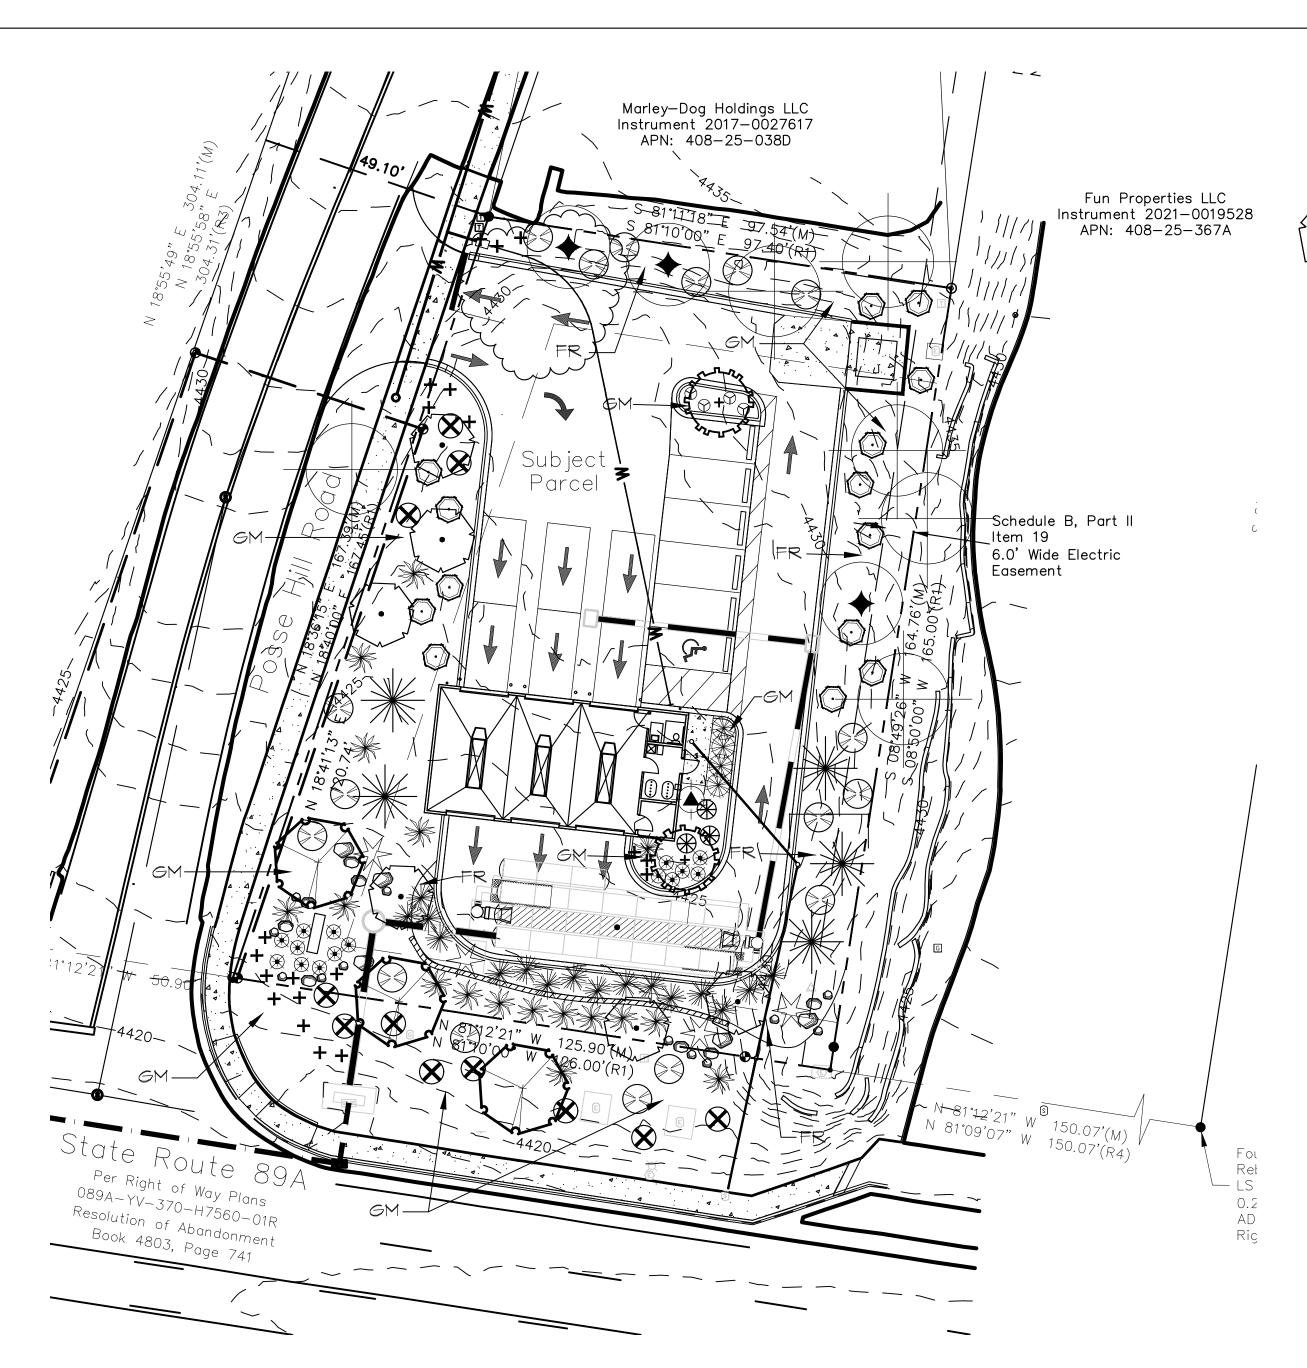

LANDSCAPE NOTES


I. Prior to plant pit excavation all plants shall be located in the field with flagging or stakes and approved by Landscape Architect or Owner's Representative.

2. All plants shall be nursery grown unless otherwise noted. Plants shall be healthy, well formed and well branched, vigorous, symmetrical and free from pests and diseases. They shall conform in quality and size to the American Nursery Stock and the Arizona Nursery Association Growers committee recommended tree specifications. Plant materials shall be protected adequately during transport and delivery. Contractor to assure all plants are adequately watered while on site.

3. Trees shall be staked per detail.

4. All plant pits shall drain at a minimum rate of 6"per2 hours. Plant pits in caliche shall be deepend to a sufficient depth to meet the 6" per 2 hour minimum.

5. Soil conditioner/compost shall consist of composted ground or shredded fir or pine bark shavings. Maximum pH 7.5, 85% shall pass a one-quarter screen. Nitrogen stabilized, minimum of 0.5% nitrogen. Submit Laboratory analysis to Landscape Architect / Owners Representative for review and approval prior to use.

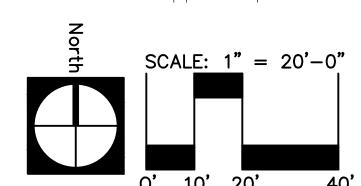

6. Fertilizer - Slow release tablets, Agriform 20-10-5 slow release, 21 gram tablets or approved equal for trees and shrubs. Agricultural gypsum (c) Powdered soil sulfur (85-95% pure soil sulfur). Fertilizers shall be delivered to the site in un-opened containers, each fully labeled and bearing the name or trademark and warranty of the producer. Submit product specifications for review and approval by Owner's Representative.

7. Plant pit backfill mix shall consist of 65% site soil and 35% soil conditioner/compost. Site soil shall be mixed with six (6) pounds of agricultural gypsum and one (1) pound of powdered soil sulfur for each cubic yard of backfill mix. The backfill mix shall be an homogenous blend of the required materials. Place one (1) Agriform tablet for each I-gallon plant, two (2) tablets each for 5 - gallon plants and three (3) tablets for trees. Evenly distribute tablets around the plant rootball in the backfill mix.

8. Backfill mix shall well worked about the rootball and settled by tamping and watering and be at the required finish grade as shown for water-harvesting basins.

9. The Contractor shall at all times keep the area of his work in a neat and orderly condition, insofar as the storage of material and the removal of dirt and debris caused by his work operations, cleaning up of debris, etc. shall be explicitly followed. Upon completion of work the Contractor shall thoroughly clean all paving, walls, curbs boulders, etc. by sweeping area and washing the area with water from a pressurized hose.

PLANT LEGEND

BOTANICAL NAME:

COMMON NAME:

		<u> </u>	
SYMBOL _	TREES:		
•	Cercis occidentalis Western Redbud	Min. 2" Cal.	8
	Pinus edulis Pinyon Pine	8' Tall	8
	Fraxinus velutina Arizona Ash	Min. 2" Cal.	8

'Arizona Cypress Quercus virginiana Live Oak

Cupessus arizonica

Existing Trees -To Remain in Place Prune and remove lower branches, damaged branches and deadwood.

Min. 2" Cal. 8

8' Tall

SIZE:

Irrigate all trees to remain in place with I - 2 GPH Multi-Port Emitter for a total of 12 GPH.

<u>S</u> H	RUBS AND ACCENTS	SIZE:	<u>GPH:</u>
\bigcirc	Leucophyllum frutecens "Compacta" Compact Texas Ranger	2' Tall	2
	Arctostaphylos pungens Pointleaf Manzinita	2' Tall	2
-	Photinia fraseri Red Tip Photinia	2' Tall	2
*	Dasylirion quadrangulatum Toothless Sotol	2' Tall	1
M	Yucca Elata Soaptree Yucca	15 Gal.	.5
*	Hamelia patens "Sierra Red" Firecracker bush	2' Tall	2
*	Hesperaloe Parviflora "Breaklights" Red Aloe	2' Tall	
	Mulhenbergia capilaris Regal Mist	2' Tall	2
	Mulhenbergia lindheimeri Autumn Glow Muhlenbegergia	2' Tall	2
8	Juniperus sabrina "Buffalo" Buffalo Juniper	2' Tall	2
+	Euonymus For. "Sunrise" Sunrise Witercreeper	2' Tall	2
Θ	Rosmarinus officianalis Prostrate Rosemary	I Gal.	2

BOULDERS:

Note: Native Surface Select -Weathered Boulders - Native to the area Sizes Are Approximate -

• |8"x 24"x 2"

• 2'x 3'x 2'

4 x 4 x 3 ¹

GENERAL NOTES

1. Contractor shall visit site and examine existing conditions prior to submitting a bid.

2. Prior to commencing work on site arrange an on-site meeting with the Owner or his Representative.

3. Contractor is required to contact Blue Stake to identify and locate all existing utilities prior to any type of excavation on site. Any damage to underground utilities or structures shall be repaired at the Contractors expense.

4. Submit to Owner's Representative manufacturers or vendors certified analysis for soil amendments and fertilizer materials. Submit other data substantiating that materials comply with the specified soil amendments

LANDSCAPE CALCULATIONS

LANDSCAPE AREA = 7,240 S.F. LANDSCAPE REQUIREMENTS | TREE/ 400 S.F. \$ 4 SHRUBS /400S.F. No. Trees Required = 18 - Trees provided = 18 No. Shrubs required = 73 - Shrubs provided = +72

INERT GROUNDCOVERS:

GM Granite Mulch: I-1/4" Minus - "Sedona Red" - Min. 2" Depth

FR Fractured Rock 4"Minus "Sedona Red" Rock shall be angular, fractured rock material

Pre-Emergent Herbicide: All landscape areas shall be treated with Surflan per-emergent herbicide or approved equal. Herbicide shall meet all applicable local, State and Federal environmental and labeling laws. Under no circumstances shall a soil sterilant be used on the site. Submit specification to Owners Representative for review and approval prior to application. Apply herbicide per manufacturer's recommendations.

All granite mulch and rock rip-rap areas shall be watered settled. Wash off all boulders at completion

LANDSCAPE MAINTENANCE

It shall be the responsibility of the owner, lessee. heirs, agent, homeowners association or other liable entity of the property to permanently maintain all approved landscaping in accordance with the approved landscape plan.

- Required maintenance shall include regular watering, pruning, mowing, fertilizing, clearing of debris and weeds, removal and replacement of dead plants and repair and replacement of irrigation systems and architectural features.
- 2. Any required plant materials not surviving shall be replaced with plants of the same variety and quality as those removed within 30 days of their demise or in the next planting period. This requirement may be waived by the director if the remaining landscaping on site satisfies the minimum landscape requirements.
- 3. Failure to maintain approved landscaping shall constitute a violation of the LDC.
- 4. Maintenance of the landscaping within public right-of-way shall be included in accordance with the terms of encroachment permits authorizing such landscaping.
- 5. All plants shall be allowed to grow in natural patterns. Over-pruning plants into unnatural shapes is prohibited.
- 6. Vegetation shall be selected, placed and maintained, so that at maturity it does not interfere with utility lines, building, traffic sight lines, vehicular parking, pedestrian circulation, and property rights of adjacent owners, and would not significantly damage or create upheaval of sidewalks and pavement.

ADOT NOTES:

I. MATERIALS WITHIN SYT'S SHALL BE PLACED SO AS NOT TO INTERFERE WITH A VISIBILITY PLANE DESCRIBED BY TO HORIZONTAL

PLANES 244 AND 724 ABOVE FINISH GRADE OF THE TRAVEL LANE, ALL SHRUB HEIGHTS IN THE SVT'S SHALL BE MAINTAINED AT

244 AND BELOW AND TREE CANOPY'S SHALL BE MAINTAINED AT A MINIMUM 724

2. ALL REQUIRED MAINTENANCE SHALL BE PROVIDED BY TAKE-5 OIL CHANGE AND ITS SUCCESSORS. MAINTENANCE SHALL INCLUDE

WEEKLY TRASH PICKUP, PRUNING, PLANT REPLACEMENT, IRRIGATION REPAIR,

SEASONAL SCHEDULING ADJUSTMENT

LANDSCAPE PLAN

JOHN HUCKO - LANDSCAPE ARCHITECT 5236 N. STONEHOUSE PL. TUCSON, ARIZONA 85750 P: (520) 400.8529 E: jhucko789@comcast.net PROJECT NO: 21-71 DATE: 10/11/21



NO.	DATE	REVISION


. CHANGE RIZONA XX ⊒ĀŠ **N N** AKE -SEDO

OWNE

SHEET NUMBER

1 of 3

Call at least two full working day ARIZONA 81
Arkona Bine Stake, Inc.

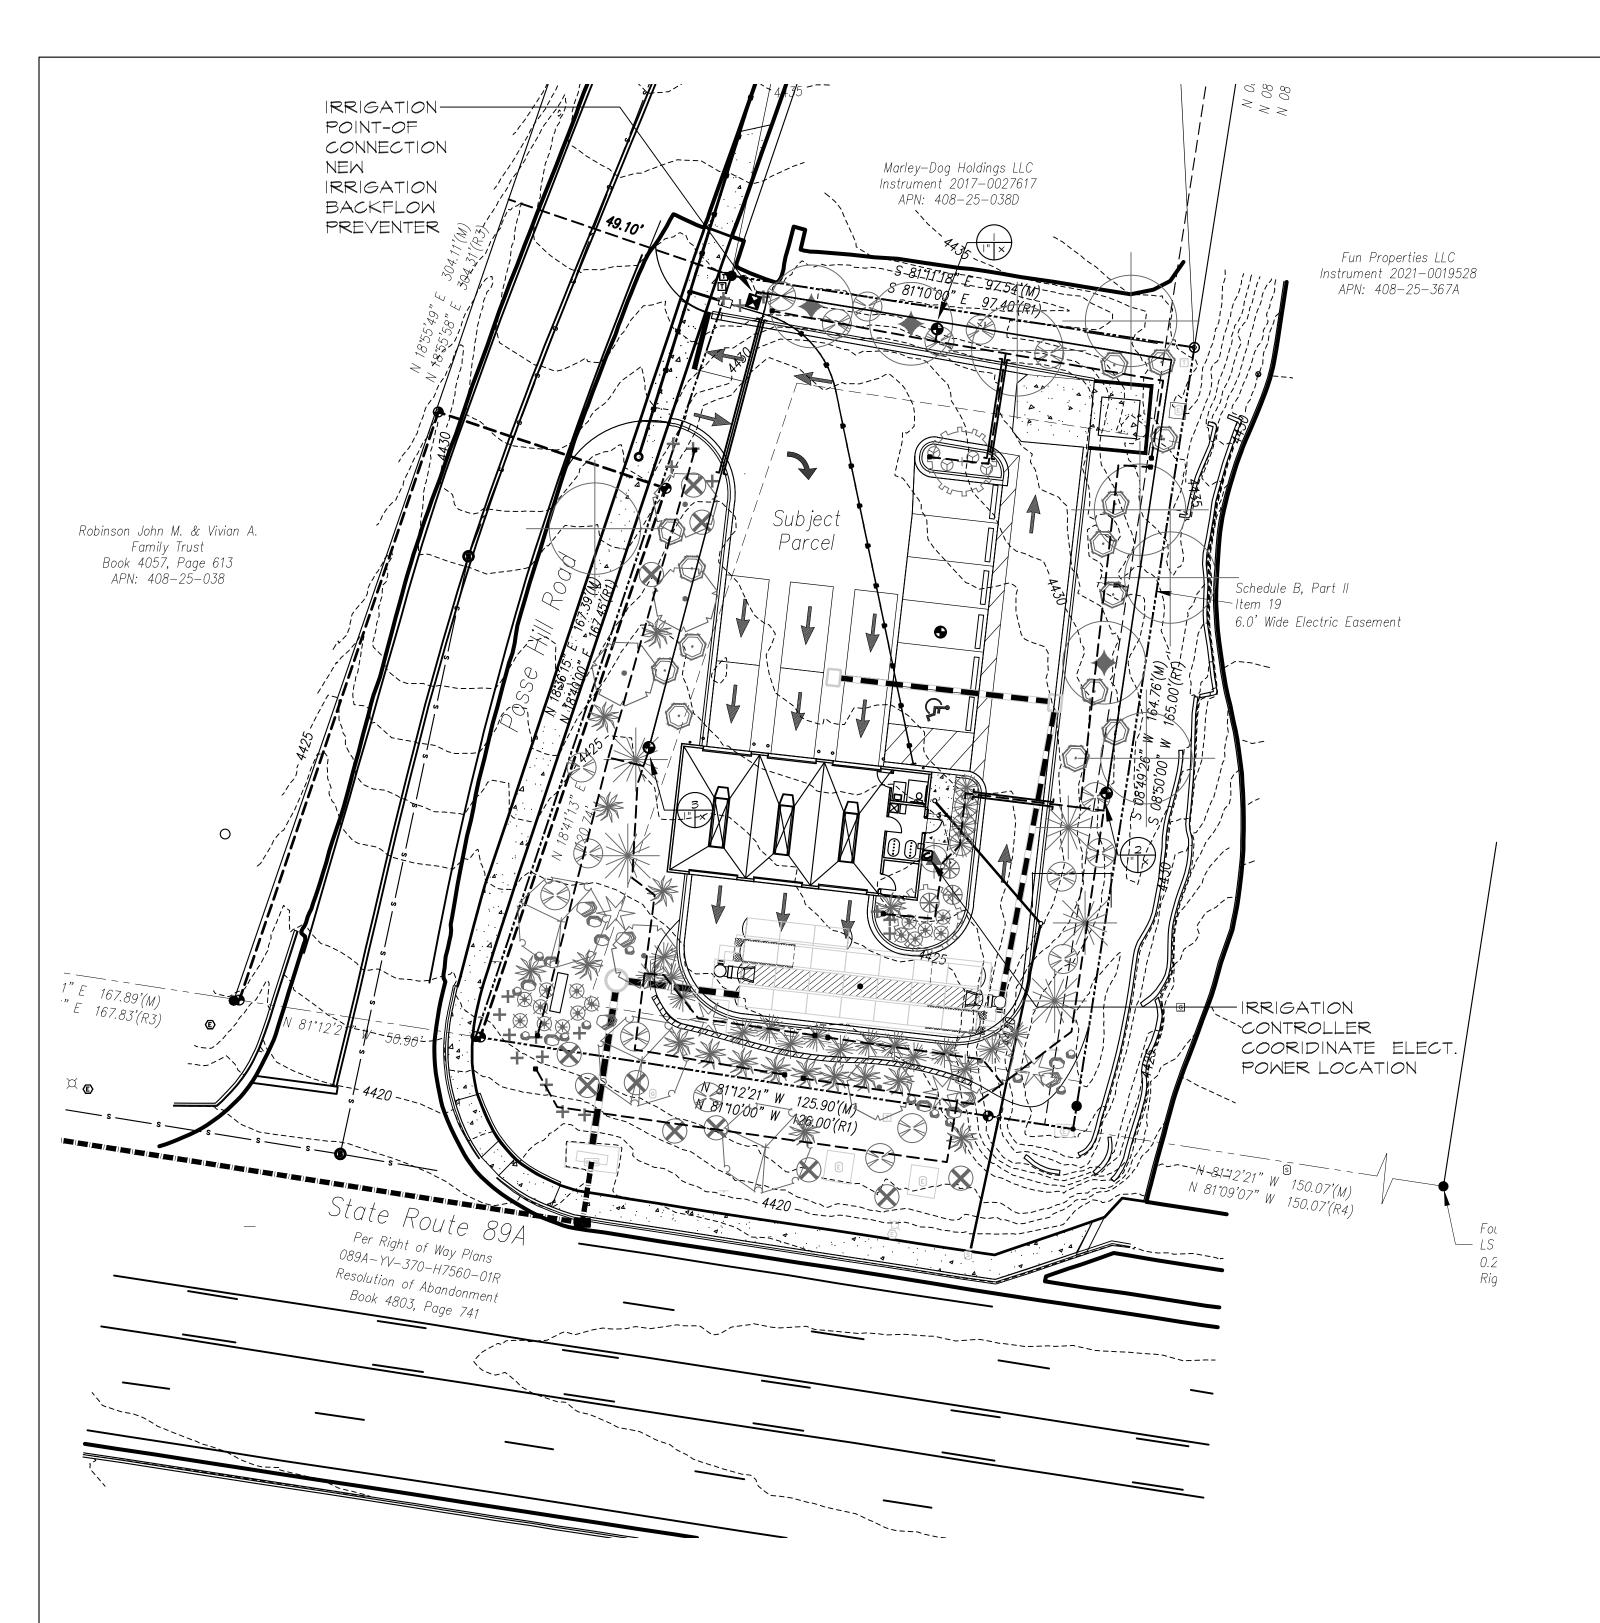

IRRIGATION LEGEND

Symbol ManufactureDescription

Water Meter - Irrigation P.O.C

I-CORE 6 Station #IC-600-PL - Wall-Mount,

Reduced Pressure Backflow Preventer, Febco

825Y - 3/4". w/ Guardshack security cabinet.

XCZ - 100-PRB-COM I"- Control Zone Kit

Sch 40 PVC Mainline - 3/4"


Sch 40 PVC 2" Sleeve.

SCH 40 PVC Lateral line - size as shown.

CL 200 PVC 3/4" CL 200 PVC Drip Irrigation Lateral w/Rain Bug XBT-20-6 Multi-outlet Emitter @ 2 GPH each Outlet XBT-20 Single-outlet


Emitter @ 2 GPH w/ RBT-220V Distribution

AP-075 - 3/4" Hose End Flush Cap.

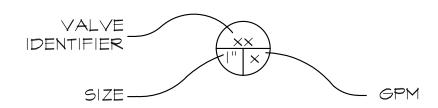

IRRIGATION NOTES

- I. Plan is schematic only. All mainlines, valves, etc. shall be placed within planting areas wherever possible.
- 2. The entire irrigation system shall satisfy all code requirements and be installed as per manufacturers' specifications.
- 3. Contractor shall sleeve all mainlines (2" or less), valve wires and laterals under all paved surfaces and walls, extending sleeves I foot from edge of paved surface or wall. Mainlines greater than 2 inches in diameter shall be direct buried. Contractor shall coordinate sleeve installation through wall/footing to bring irrigation into the planters located in the storage/parking area
- 4. Contractor shall coordinate installation of drip irrigation lines prior to installation of plant material with the Owner's Representative.
- 5. Trees to be irrigated by multi-outlet emitters. Shrubs and groundcover to be irrigated by single-outlet emitters.
- 6. Contractor shall apply for Reduced Pressure Backflow Preventer permit from Dept. of Water Backflow Prevention Department.
- 7. All irrigation equipment shall be as specified, or approved equal per the discretion of the owner.
- 8. The irrigation system has been designed for a minimum static water pressure of 50 PSI. Contractor shall verify water pressure in the field before construction and notify to owner/general contractor of any discrepancy.

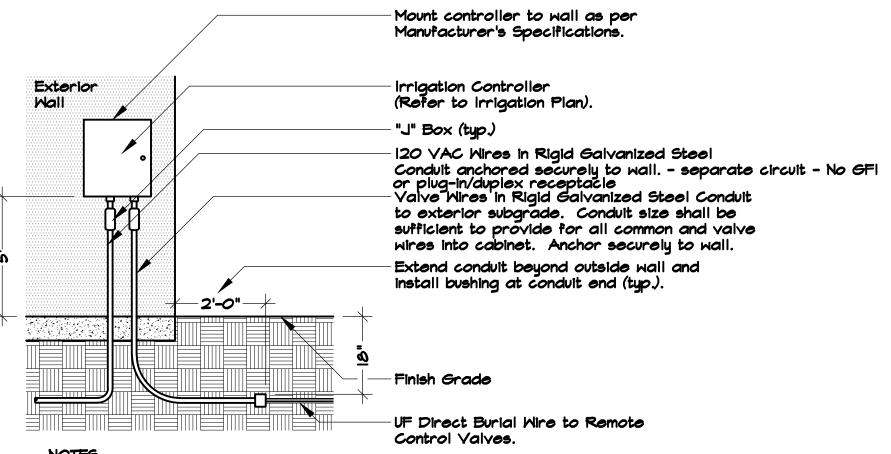

All wiring to be installed as per City Code. Refer to Electrical Plans for location and power source.

WALL-MOUNTED IRRIGATION CONTROLLER



SCALE: 1" = 20'-0"





JOHN HUCKO - LANDSCAPE ARCHITECT 5236 N. STONEHOUSE PL. TUCSON, ARIZONA 85750 P: (520) 400.8529 E: jhucko789@comcast.net PROJECT NO: 21-71 DATE: 10/11/21

SHEET NUMBER

TAKE -SEDOI


2 of 3

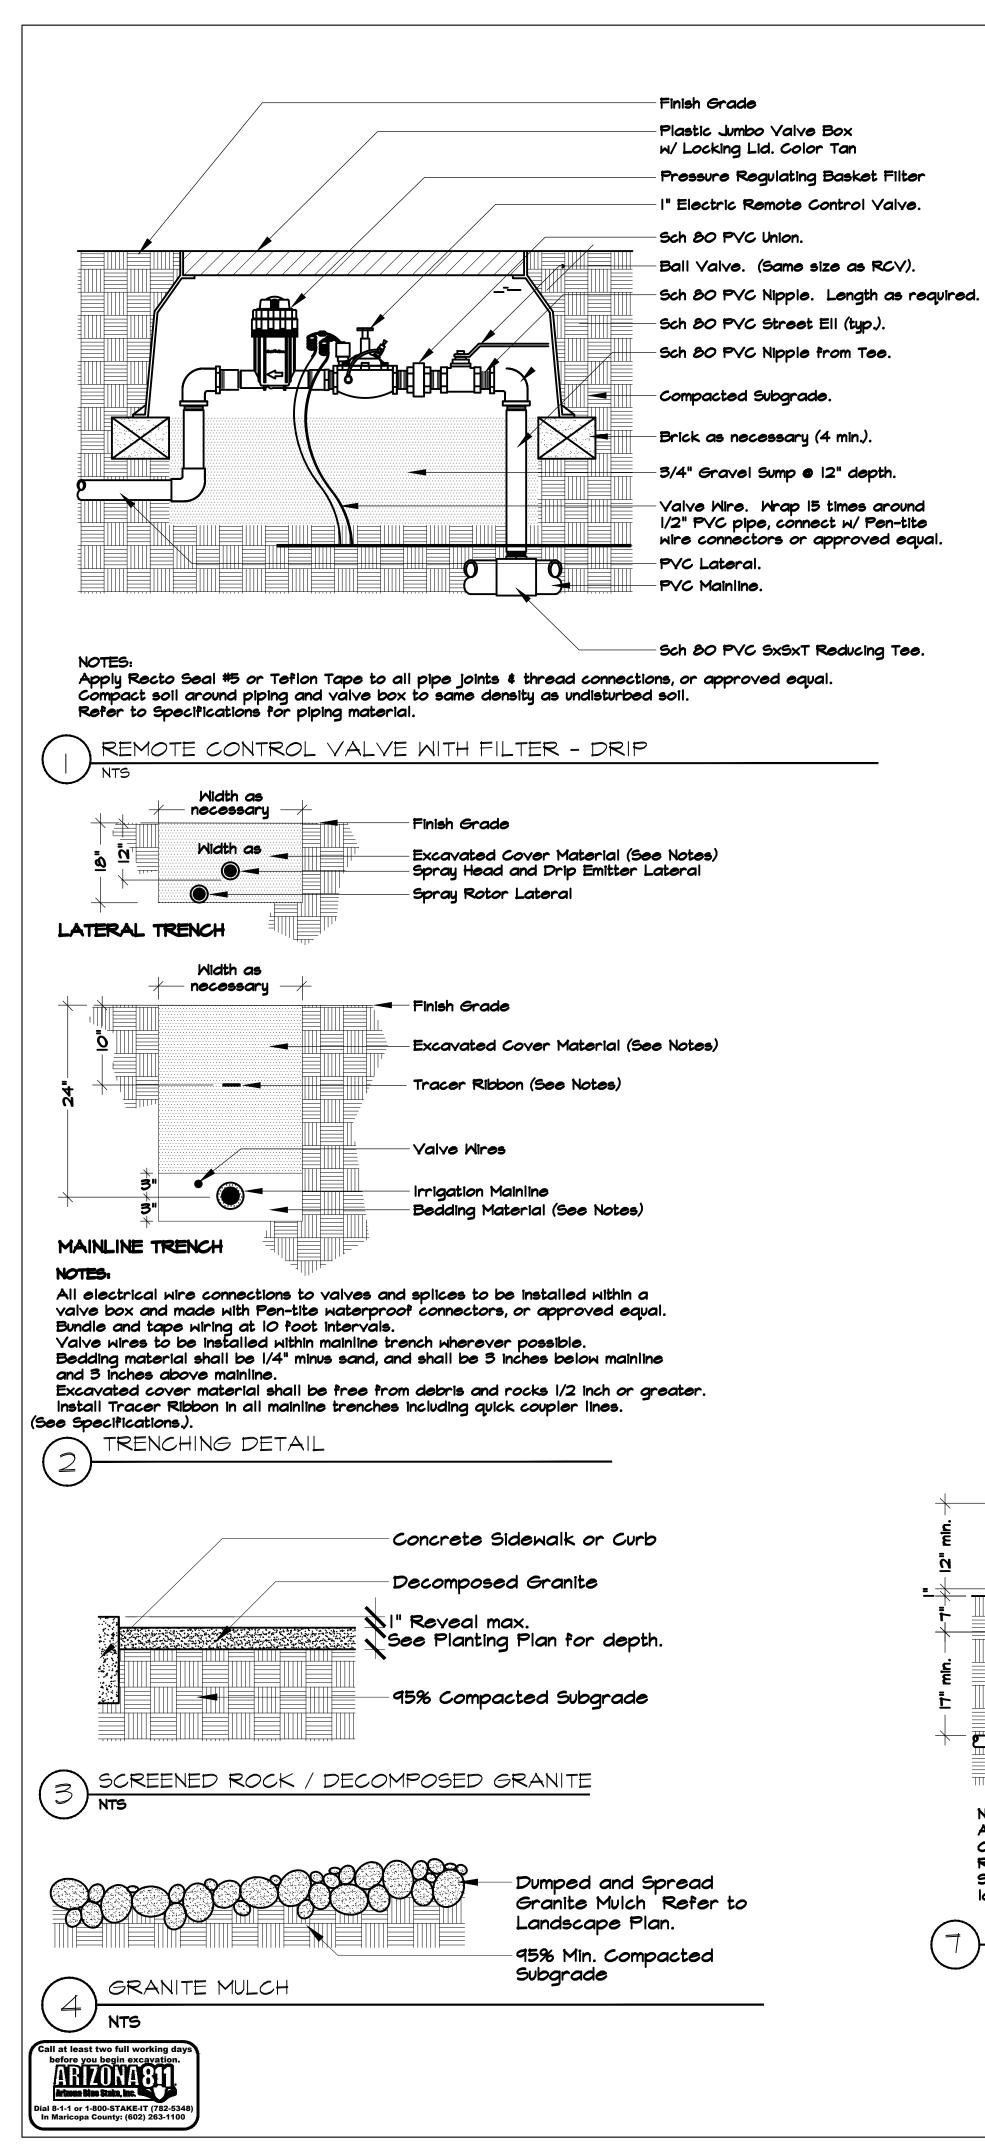

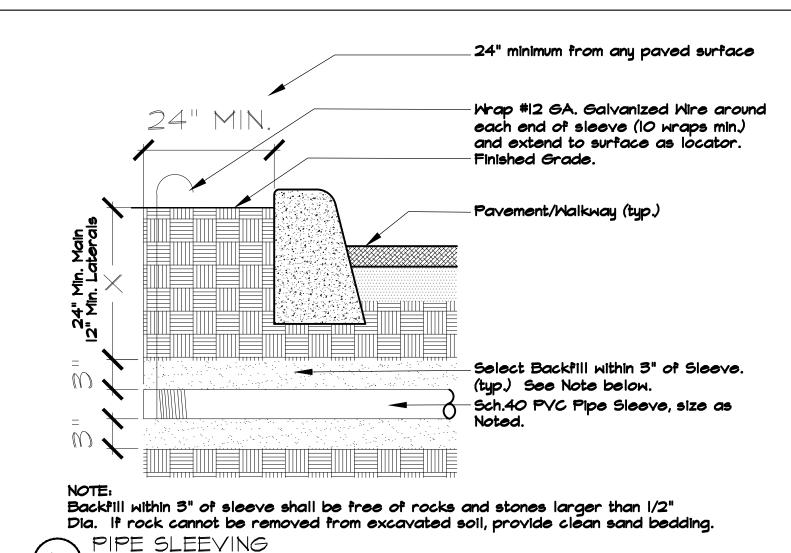


Multi-Outlet Emitter. -3/4" Class 200 PVC -Emitter Distribution Tubing Location (typ.). Tree Trunk. _+- \3' (typ.)/ -Tree Canopy (Plan View). Vinyl Distribution Tubing. Multi-Outlet Emitter 3/4" Class 200 PVC Vinul Distribution Tubing. -Emitter Tubing Location (typ.). Shrub or Groundcover Center. 6" (typ.) -Dist. Tubing to other Plants. (typ.) SHRUB OR GROUNDCOVER

NOTES: Refer to Irrigation Key for Manufacturer. YEMITTER PLACEMENT

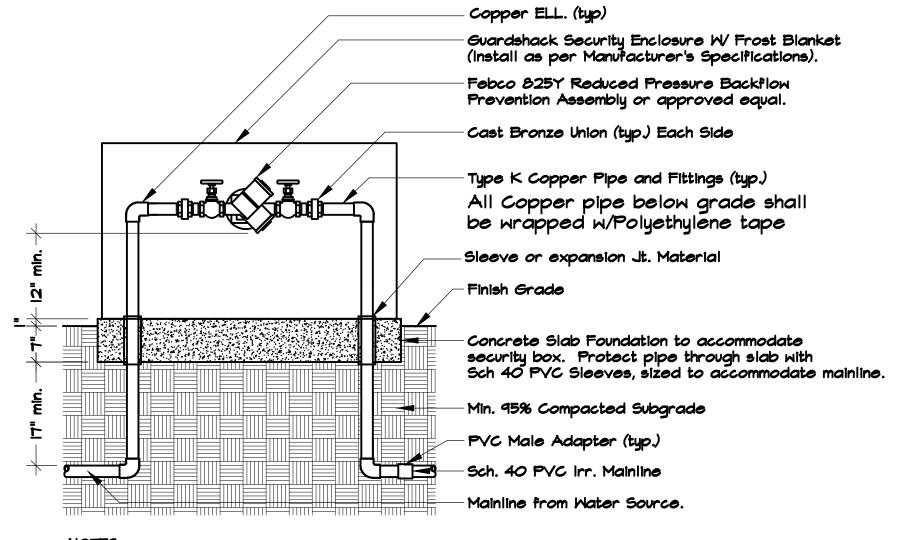

Apply Recto Seal #5 or Teflon Tape to all pipe joints & thread connections, or approved equal. Compact soil around mainline piping to same density as undisturbed soil. Refer to specifications for piping material. Supply keyed padlock, Master Lock Model #957 w/ two keys, or approved equal, for locking security enclosure.

REDUCED PRESSURE TYPE BACKFLOW PREVENTER

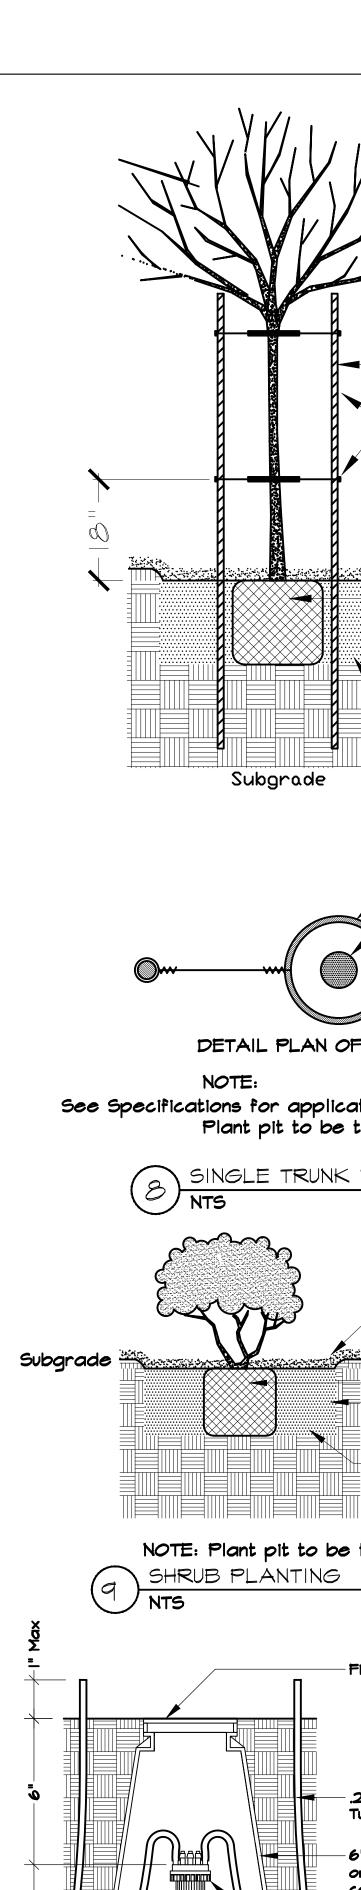

2" Diameter Pressure Treated 10' min. Lodge Pole Pine Tree Stake. 12 ga. Galvanized Wire Inside 3/4" dia. Flexible Rubber Hose ● 6" dia. circle. Staple wire to each stake. (2 wires/tree). 6' X 3" Deep Basin (typical) Finish Grade Decomposed Granite if applicable. Rootball Planting Pit Size: 15 Gal - 36" dia. 24" Box - 48" dia.


Depth of pit to be depth of rootball. Backfill Mix per Landscape Notes

3/4" Rubber Hose @ 6" dia. Tree Trunk -12 ga. Galv. Wire. Staple to Stake. 2" dia. Tree Stake


DETAIL PLAN OF HOSE AND WIRE

See Specifications for application of FERROMEC AC Liquid Iron to all trees. Plant pit to be to the depth of the rootball, typical.

SINGLE TRUNK TREE PLANTING

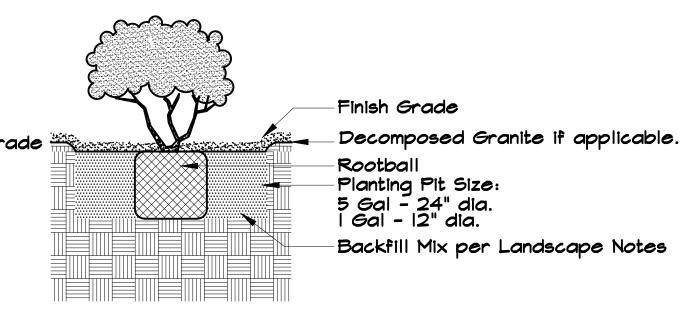

NOTE: Plant pit to be to the depth of the rootball, typical.

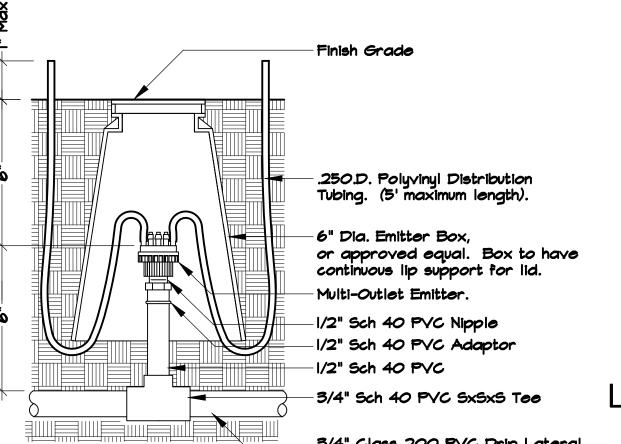

3/4" Class 200 PVC Drip Lateral Compact soil around emitter assembly to same density as undisturbed soil.

EMITTER INSTALLATION

LANDSCAPE - IRRIGATION DETAILS

JOHN HUCKO - LANDSCAPE ARCHITECT 5236 N. STONEHOUSE PL. TUCSON, ARIZONA 85750 P: (520) 400.8529 E: jhucko789@comcast.net PROJECT NO: 21-71 DATE: 10/11/21




NO. DATE REVISION

CHANGE RIZONA XX -AKE -SEDOI

SE SE

SHEET NUMBER

3 of 3

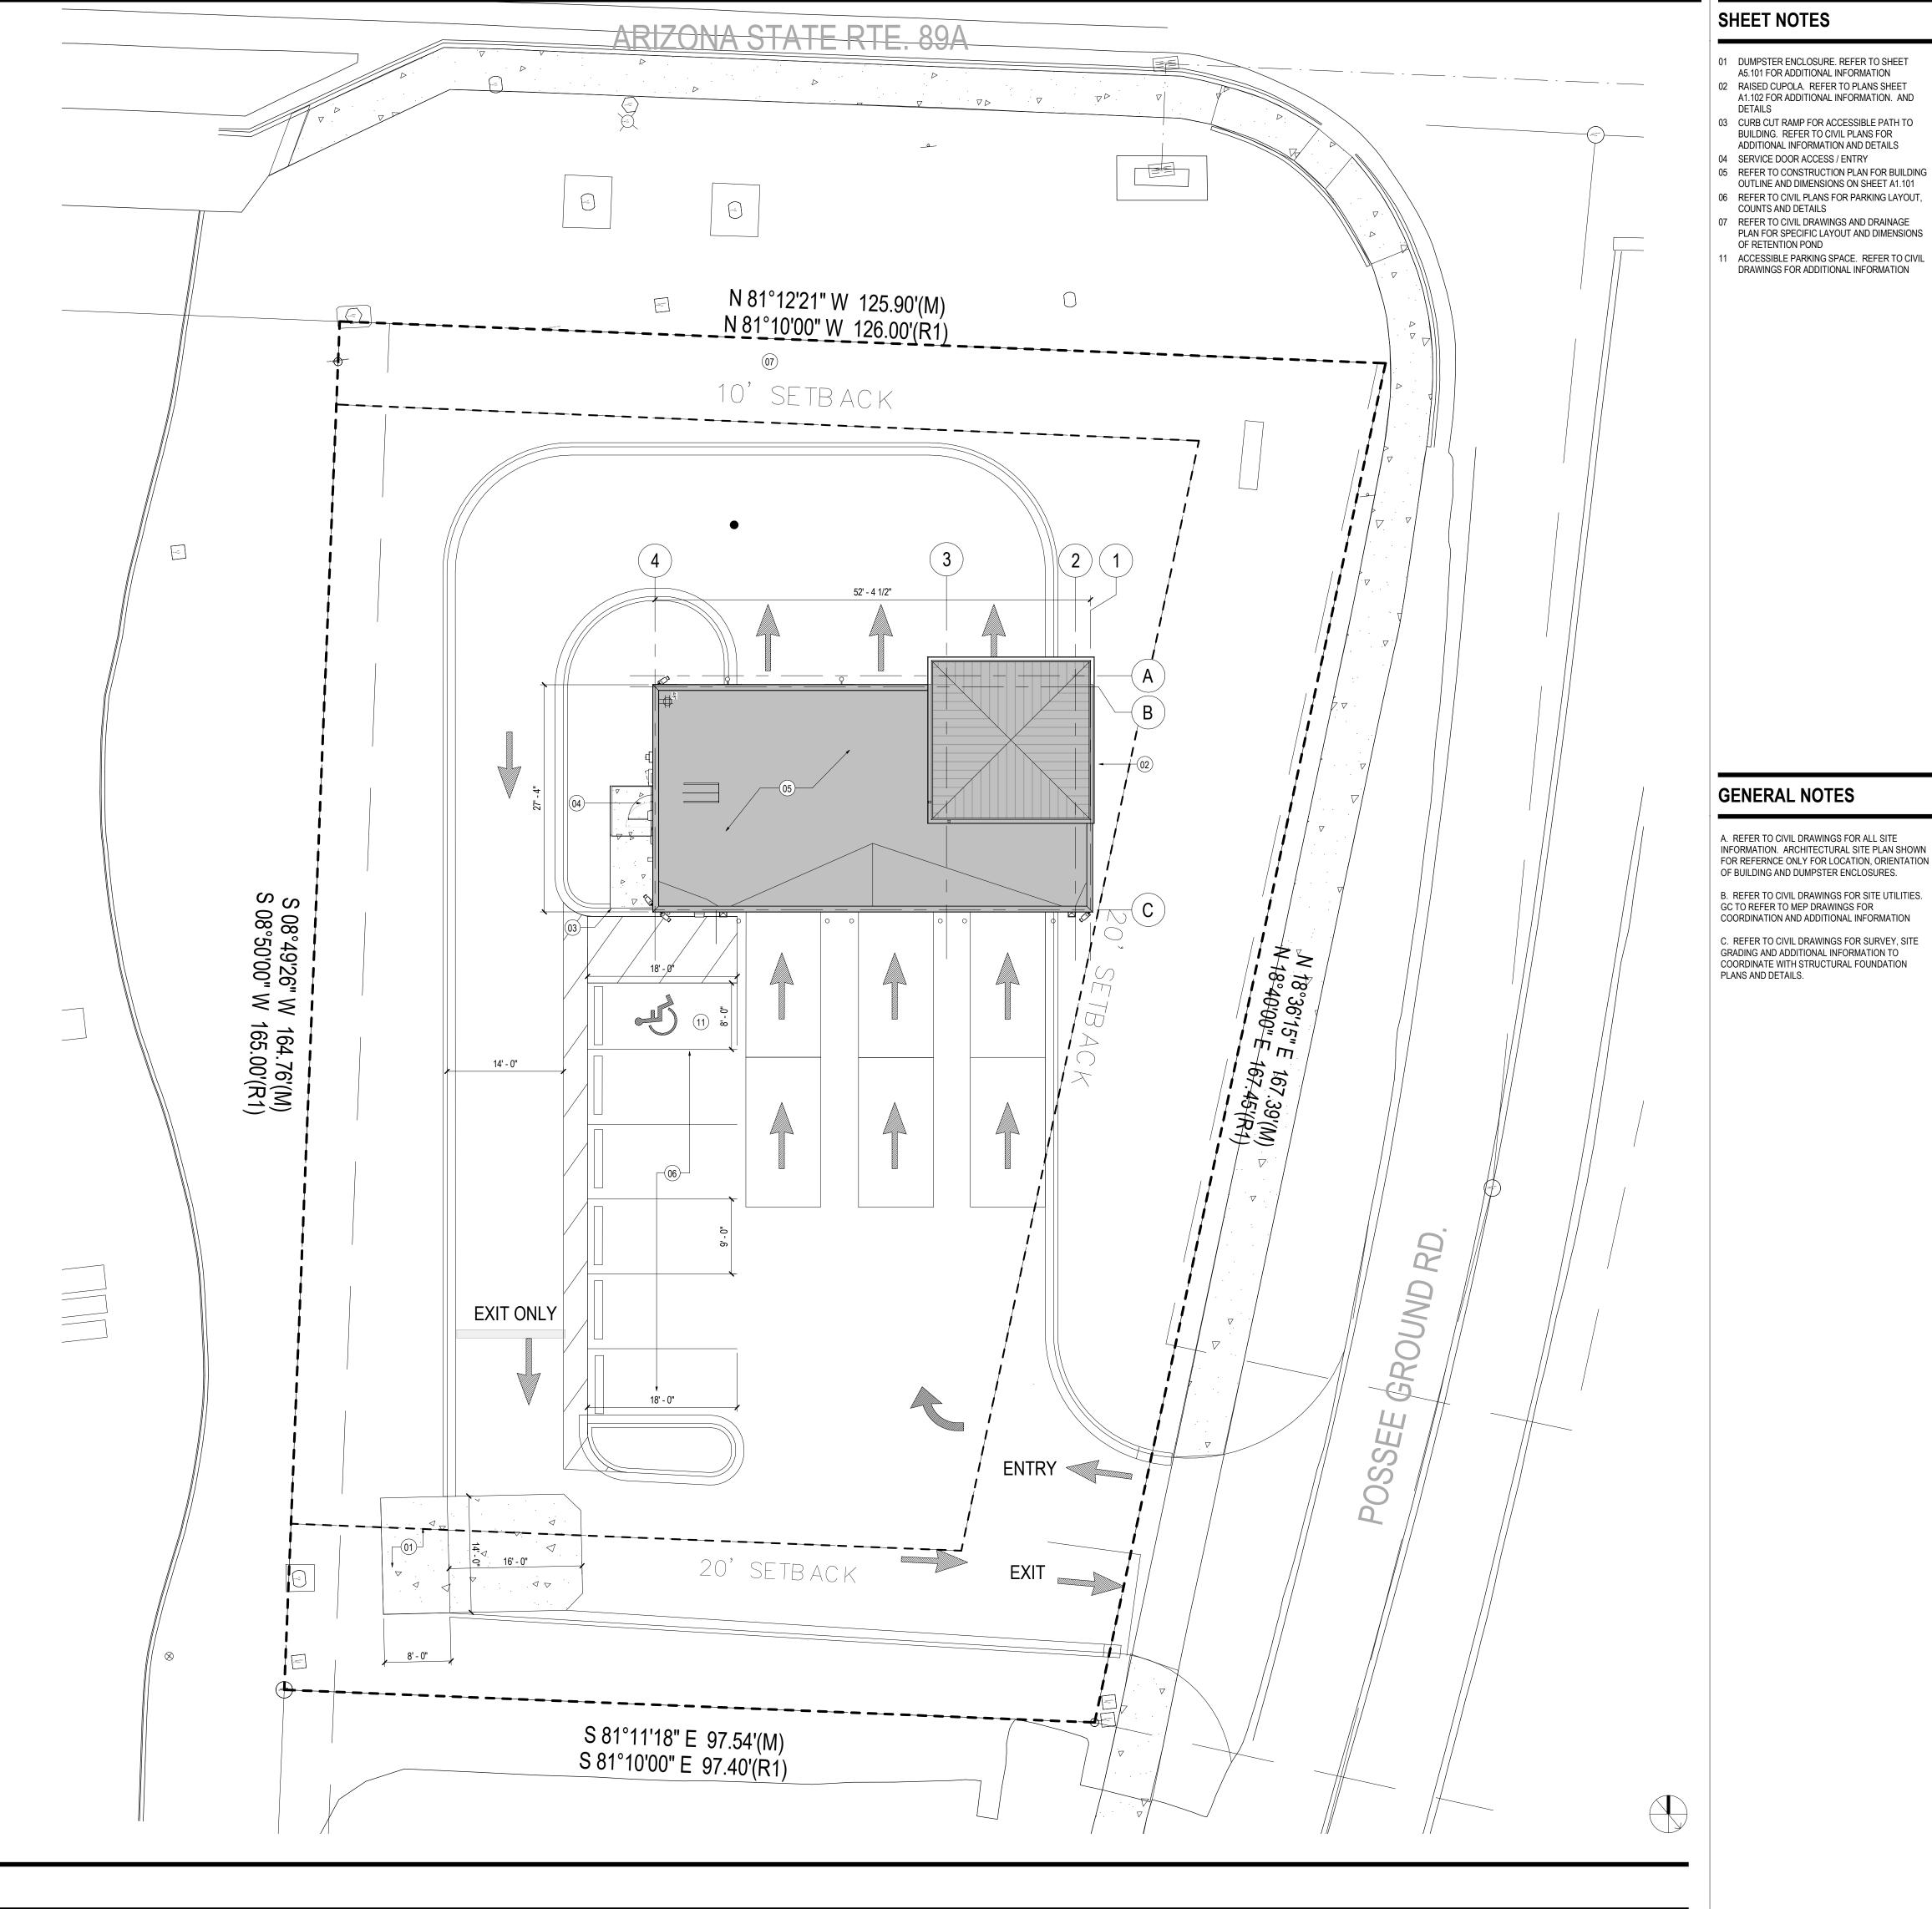

SHEET NOTES Take 5 Oil Change

80 Posse Ground Rd 01 DUMPSTER ENCLOSURE. REFER TO SHEET A5.101 FOR ADDITIONAL INFORMATION Sedona AZ 86<u>336</u> 02 RAISED CUPOLA. REFER TO PLANS SHEET A1.102 FOR ADDITIONAL INFORMATION. AND



Gensler

Tel 602.523.4900 Fax 602.523.4949 2575 E Camelback Rd Suite 175
Phoenix, AZ 85016
United States



Structural Engineer 1307 W. Morehead Street Suite 205 Charlotte, NC 28208 Telephone 980.999.6122



MEP Engineer 709 Catawba Street Belmont, NC 28012 Telephone 704.399.3943

GENERAL NOTES

A. REFER TO CIVIL DRAWINGS FOR ALL SITE INFORMATION. ARCHITECTURAL SITE PLAN SHOWN FOR REFERNCE ONLY FOR LOCATION, ORIENTATION OF BUILDING AND DUMPSTER ENCLOSURES.

B. REFER TO CIVIL DRAWINGS FOR SITE UTILITIES. GC TO REFER TO MEP DRAWINGS FOR COORDINATION AND ADDITIONAL INFORMATION

1 10.08.2021 ISSUE FOR CONSTRUCTION

∑ Date Description

Seal / Signature


Take 5 Oil Change


Project Number 59.6678.008


ARCHITECTURAL SITE PLAN

1/8" = 1'-0"


A0.100

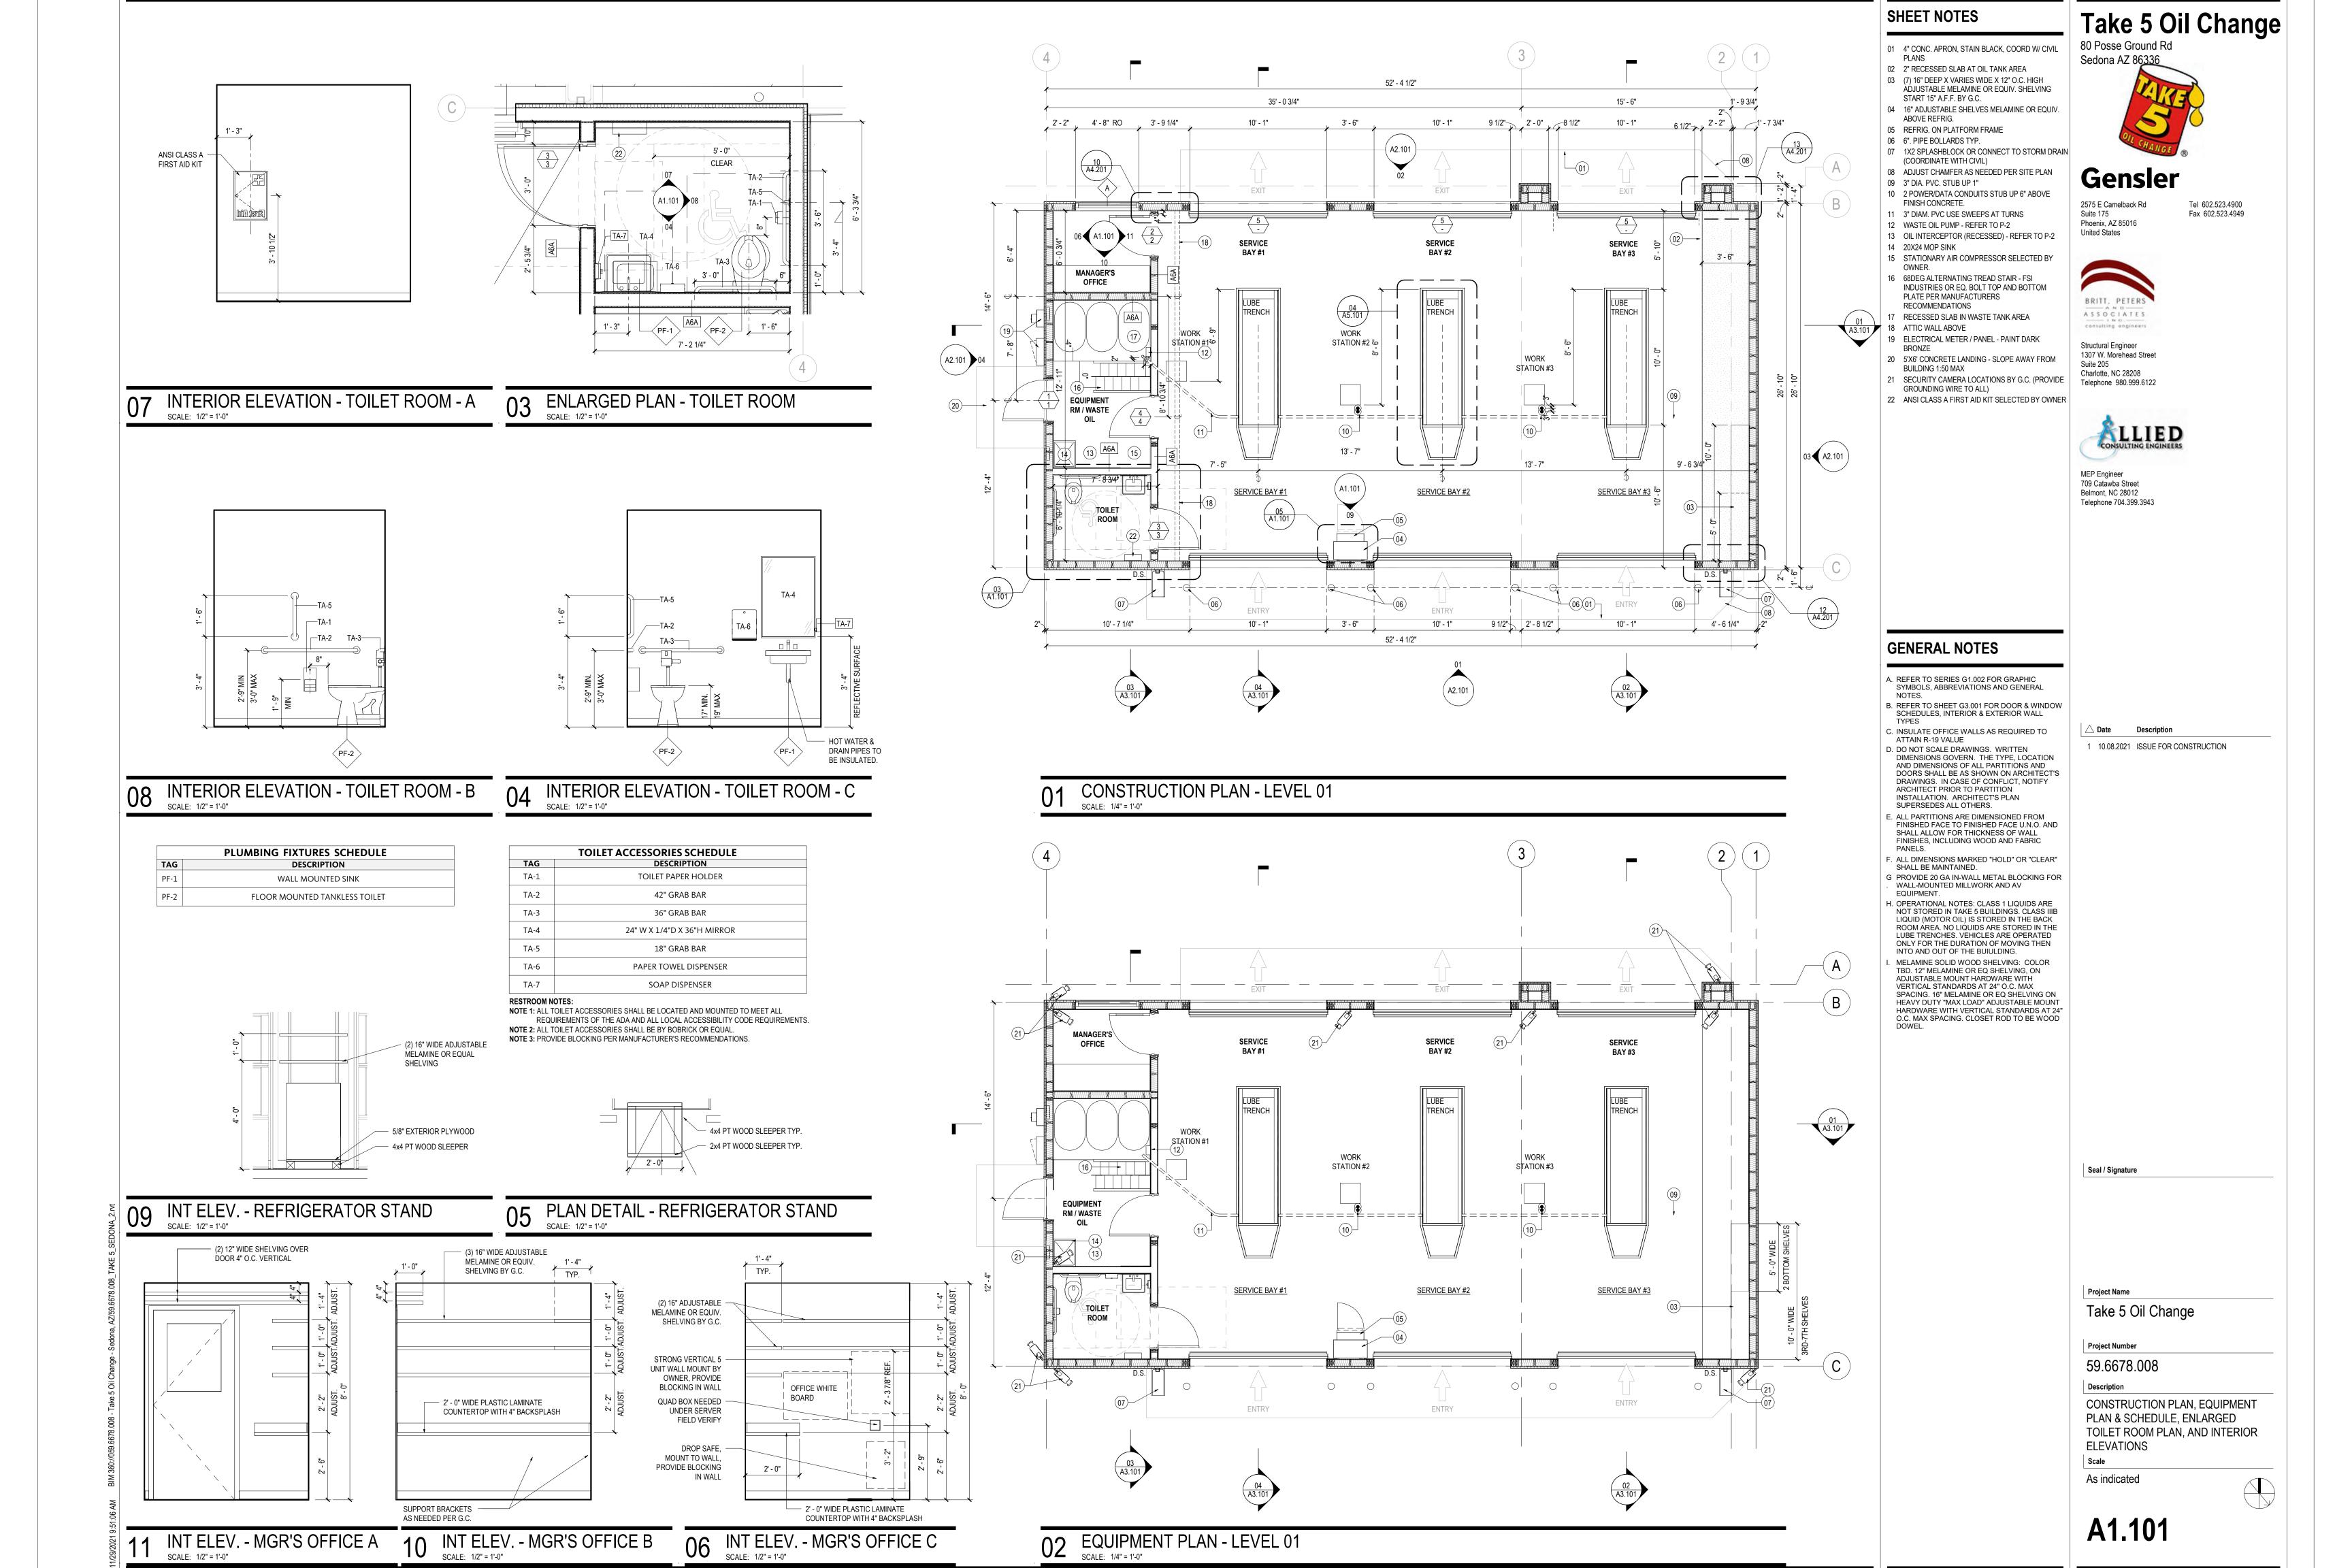


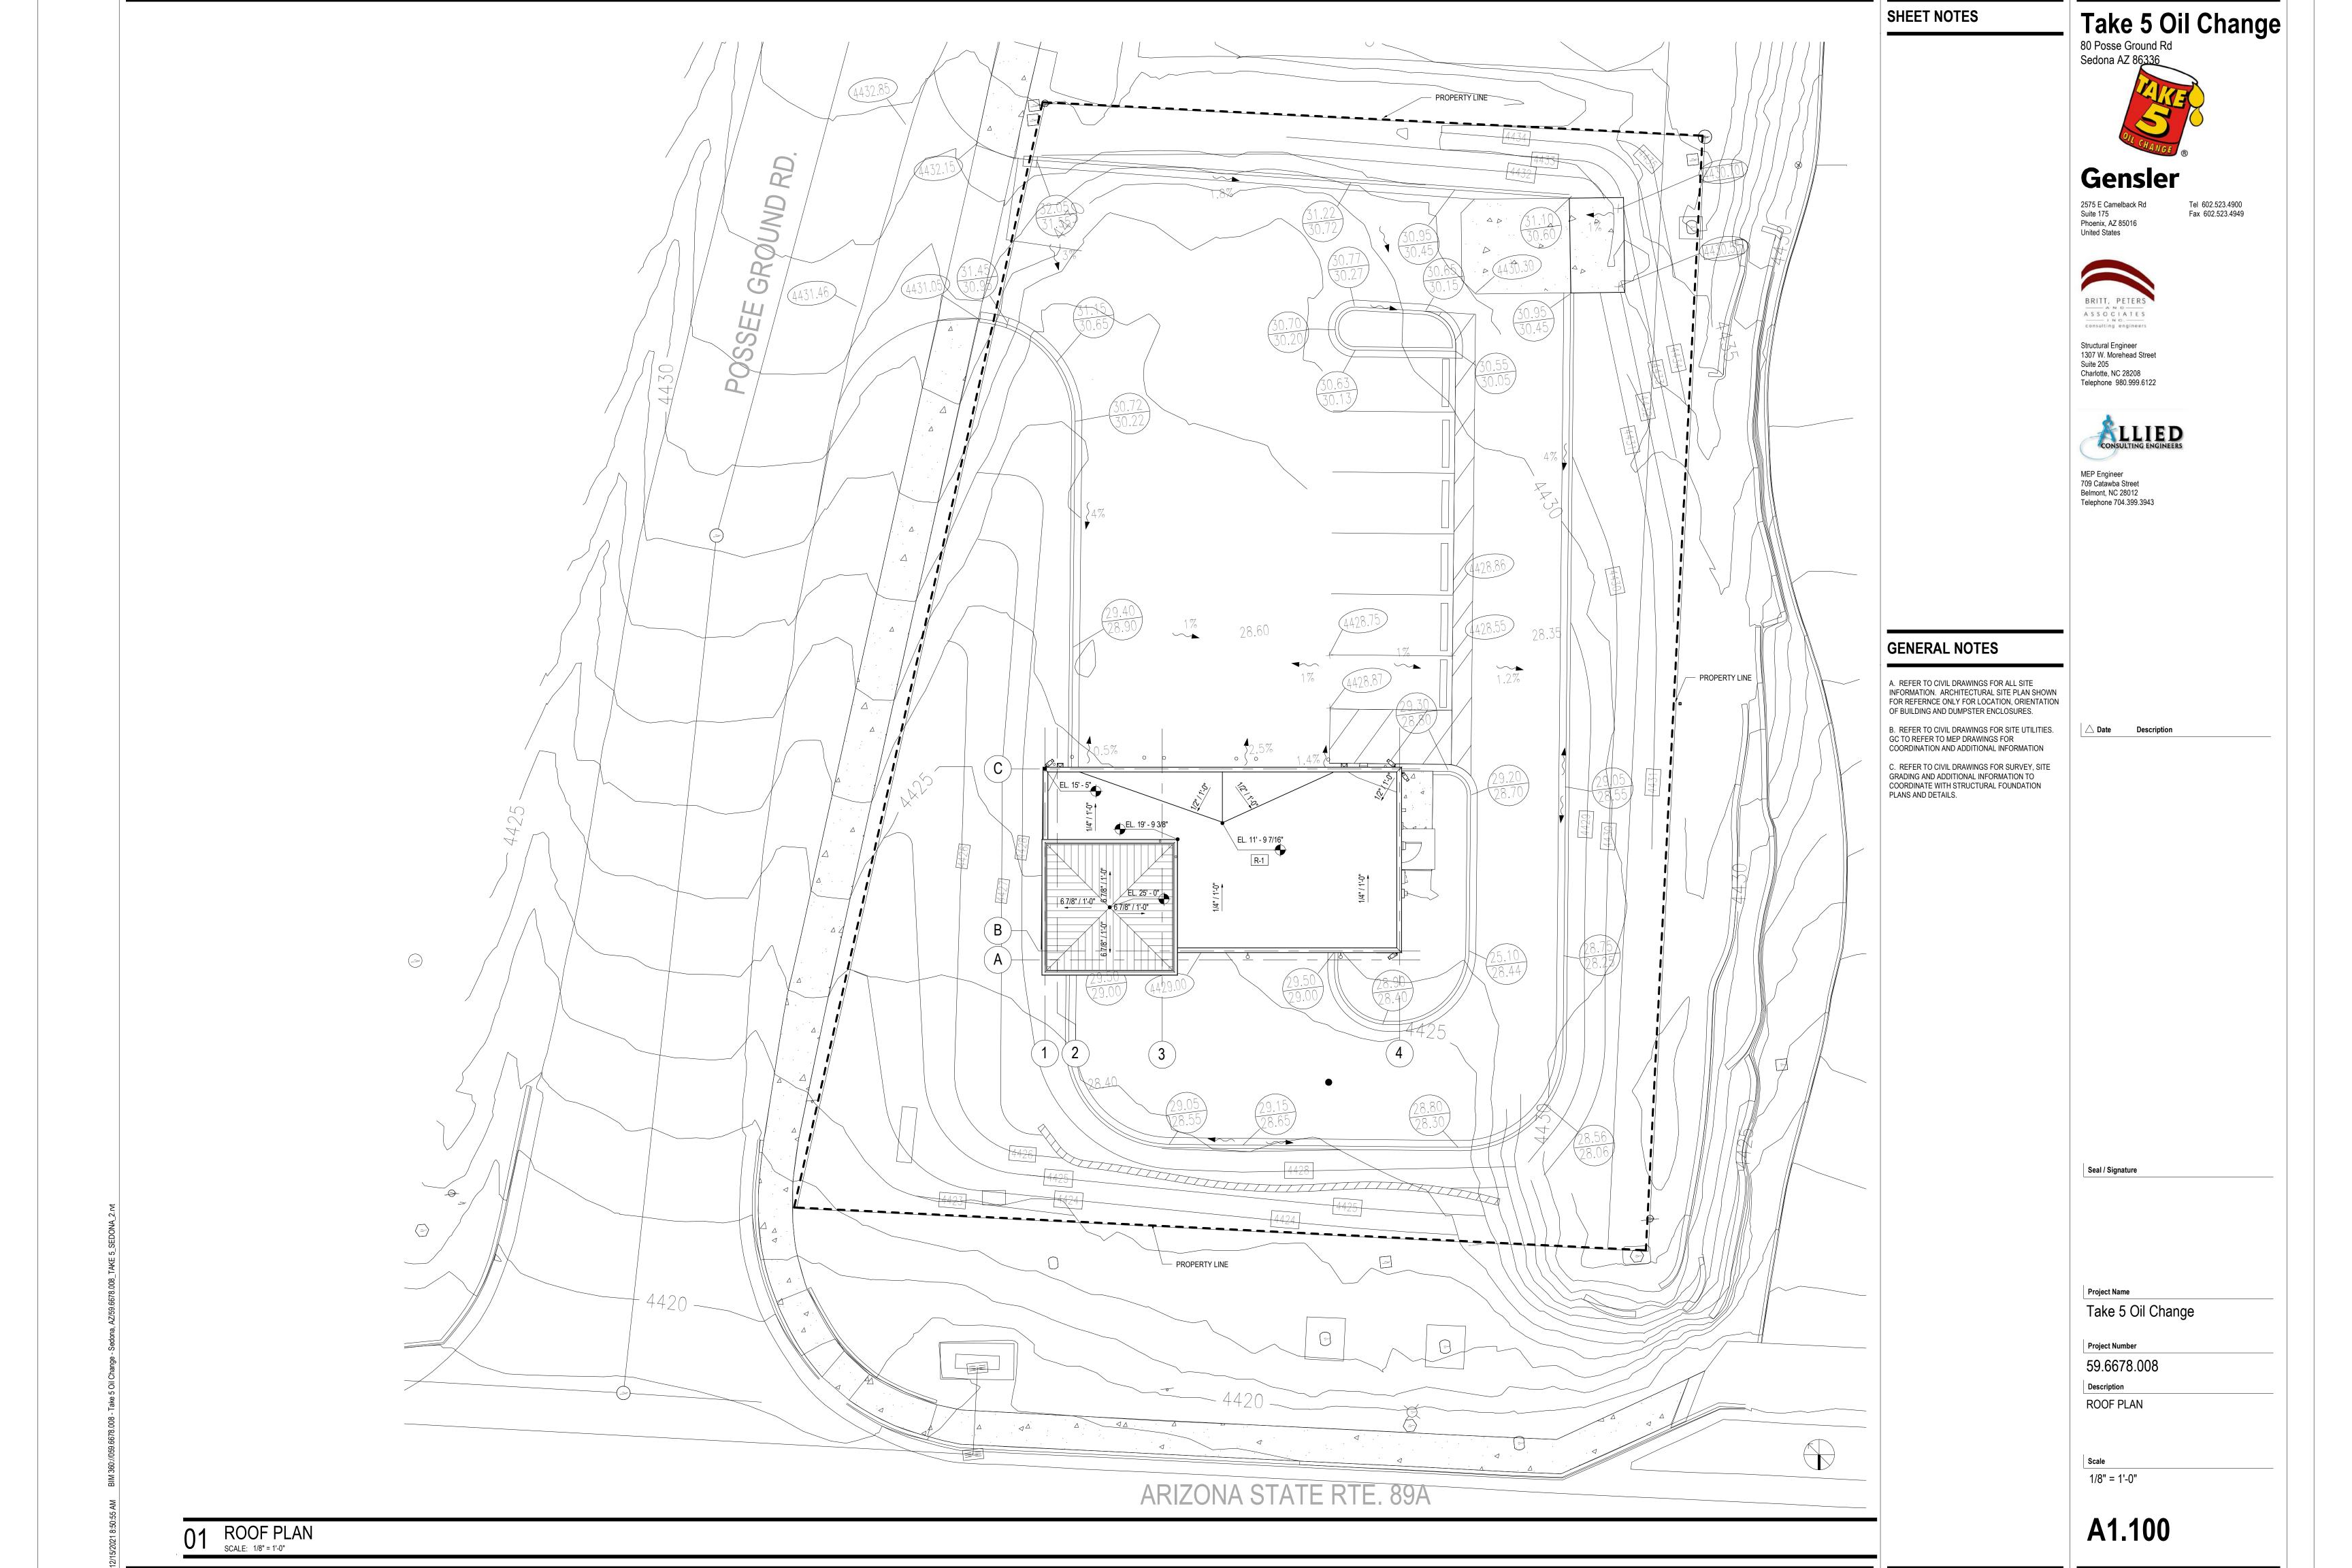

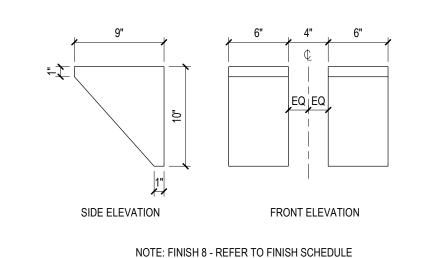

EIFS BRACKET DETAIL SCALE: 1 1/2" = 1'-0"

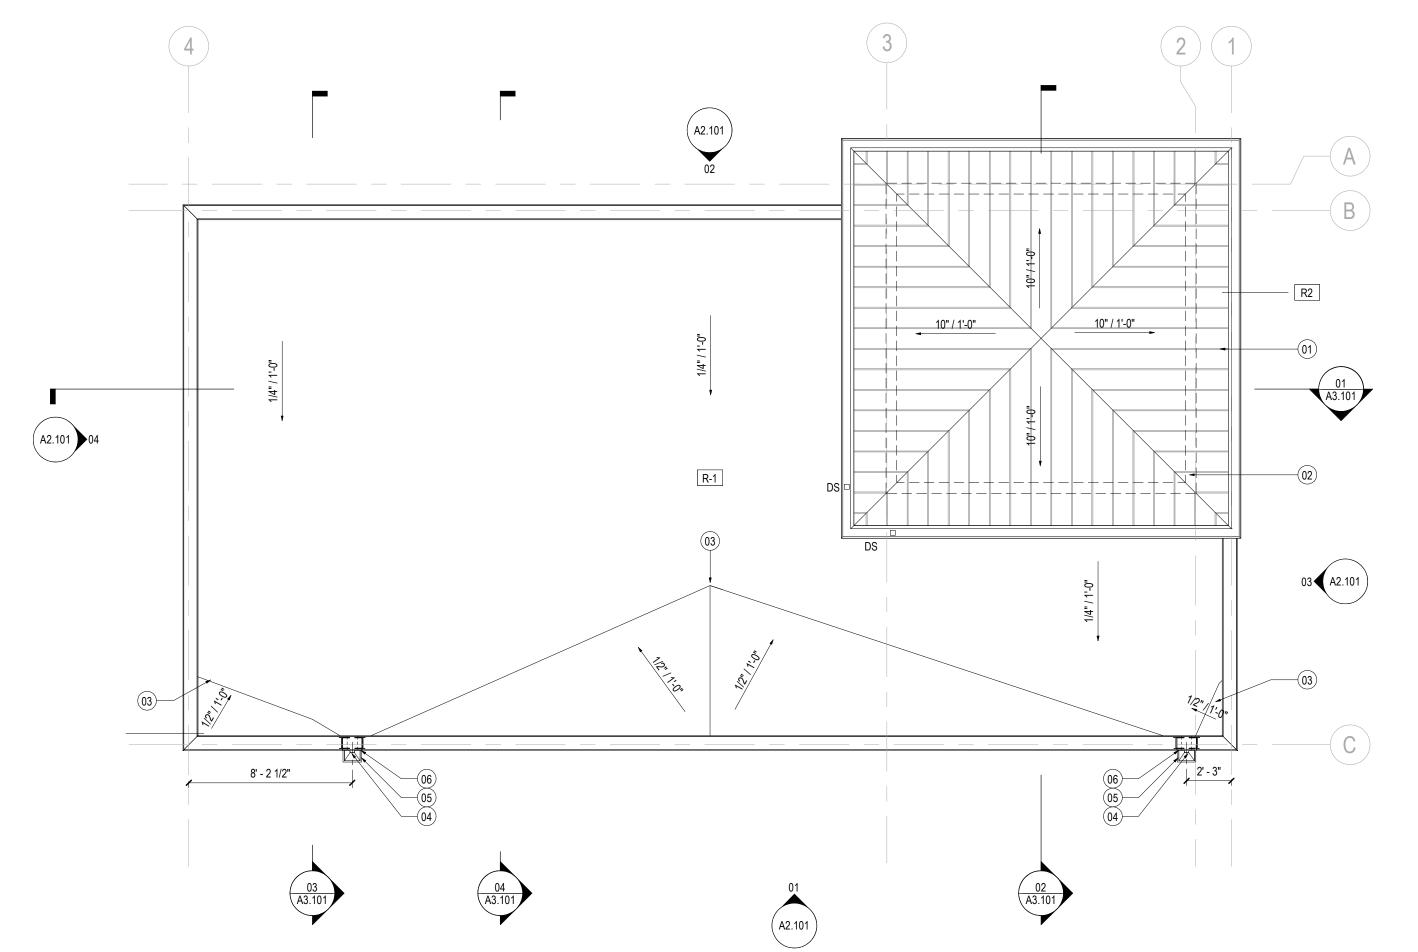

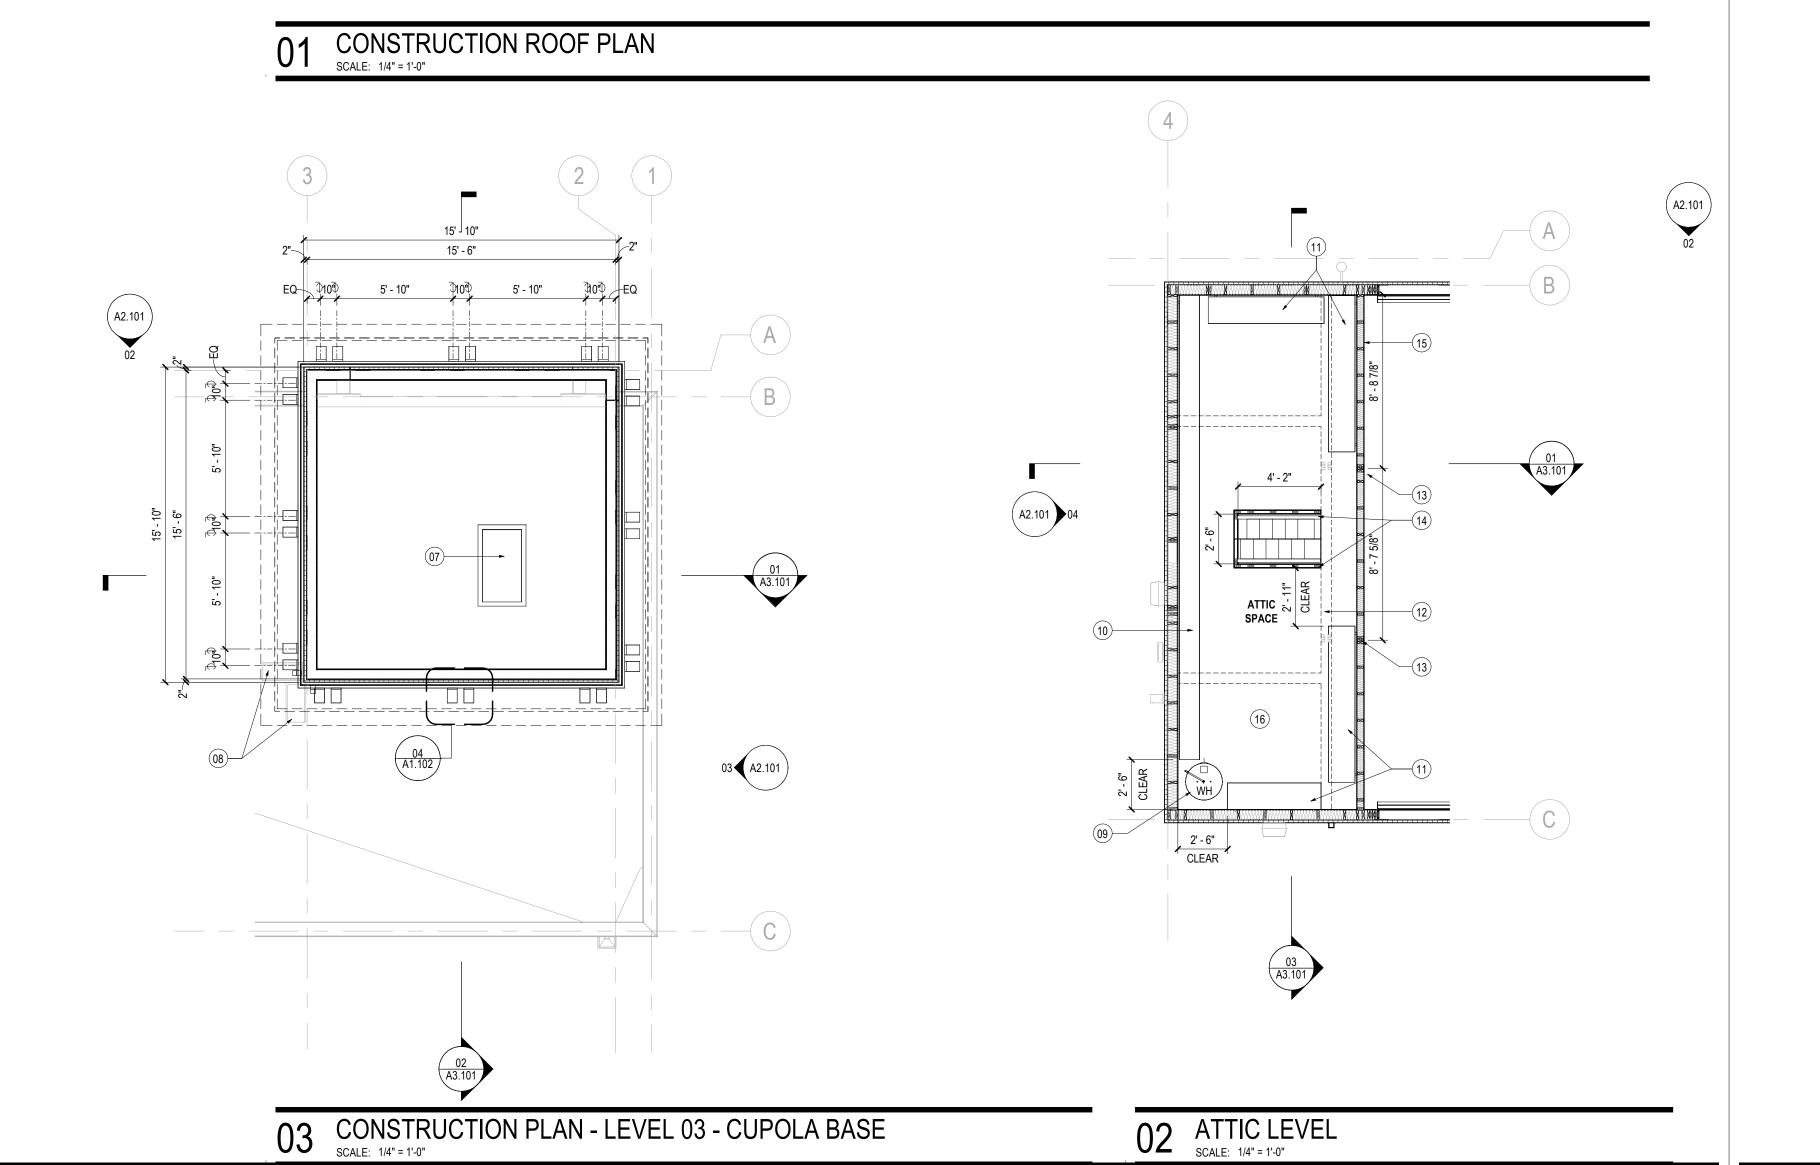

SHEET NOTES

- 01 STANDING SEAM, PREFINISHED METAL ROOF -SEE ELEVATIONS FOR COLOR 02 COUPLA WALLS BEYOND 03 CRICKETS SLOPE TO SCUPPER - TYPICAL
 - 04 LEADER HEAD AND 4X5 DOWNSPOUT 05 6X8 PRIMARY SCUPPER
 - 06 6X12 OVERFLOW SCUPPER 07 22" X 42" OPEN ACCESS HATCH
 - 08 1X2 SPLASHBLOCK ALIGNED WITH DOWNSPOUT ABOVE. 09 WATER HEATER SEATING ON FLOOR IN ATTIC STORAGE - SEE PLUMBING DWGS
 - 10 12" DEEP WOOD SHELVING WITH 1X2 SUPPORTS, (3) SHELVES AT 14" O.C. VERTICALLY (TYP.) 11 16" DEEP WOOD SHELVING WITH 1X2
 - SUPPORTS, (3) SHELVES AT 14" O.C. VERTICALLY (TYP.)
 - 12 2X6 WALL BELOW 13 (3) 2X4 STUDS & DOUBLE JOIST BELOW
 - 14 2X4 SIDEWAYS WALL TO BE 42" ABOVE ATTIC STORAGE FLOOR W/ 1X WOOD CAP
 - 15 EXTEND 2X4 WALL TO UNDERSIDE OF ROOF DECK & INSULATE
 - 16 3X4 PLYWOOD FLOOR (TYP.)



Sedona AZ 86336

Gensler

Tel 602.523.4900 Fax 602.523.4949 2575 E Camelback Rd Suite 175
Phoenix, AZ 85016
United States



Structural Engineer 1307 W. Morehead Street Suite 205 Charlotte, NC 28208 Telephone 980.999.6122



MEP Engineer 709 Catawba Street Belmont, NC 28012 Telephone 704.399.3943

GENERAL NOTES

- A. ROOFING MEMBRANE TO BE MECHANICALLY FASTENED TPO. B. ALL RIGID INSULATION TO BE POLYISOCYANURATE
- C. ROOF INSULATION TO BE MINIMUM R-25
- D. PROVIDE 4" CONTINUOUS CANT STRIP AT PERIMETER TYPICAL E. OVERFLOW DRAIN TO BE 2" HIGHER THAN ROOF DRAIN - TYPICAL

ackslash Date Description

1 10.08.2021 ISSUE FOR CONSTRUCTION

Seal / Signature

Take 5 Oil Change

Project Number 59.6678.008

CONSTRUCTION PLAN - ROOF, ATTIC, & COUPLA

As indicated

A1.102

	EXTERIOR	FINISH	H SCHEDULE
NO.	AREA	COATS	COLOR
1	EIFS MAIN COLOR		MATCH DE6118, SANDPIT
2	EIFS ACCENT BAND	-	MATCH DE6145, ROCKY RIDGE
3	EIFS WAINSCOT		MATCH DEA159, RICH MOCHA
4	COPING / CORNICE		MATCH DEA152, DEEP CRIMSON
5	EIFS SECONDARY COLOR		MATCH DEA152, DEEP CRIMSON
6	TOWER - ROOF AND GUTTER PRE-FINISHED STANDING SEAM		MATCH DEA152, DEEP CRIMSON
7	TOWER - FASCIA PRE-PRIMED LP SMARTSIDE TRIM	2	MATCH DEA152, DEEP CRIMSON
8	TOWER - SOFFIT PRE-PRIMED LP SMARTSIDE VENTED SOFFIT	2	MATCH DE6145, ROCKY RIDGE



01 NORTH ELEVATION SCALE: 1/4" = 1'-0" 03 WEST ELEVATION SCALE: 1/4" = 1'-0" LEVEL 04 - COUPLA PEAK 25' - 0" LEVEL 04 - COUPLA PEAK 25' - 0" TOWER BEYOND LEVEL 03 - CUPOLA BASE 19' - 7" LEVEL 03 - CUPOLA BASE 19' - 7" LEVEL 02 - PARAPET 16' - 3" LEVEL 02 - PARAPET 16' - 3" 5 03 2 -2 — 1 — ATTIC LEVEL 8' - 8 1/2" ATTIC LEVEL 8' - 8 1/2" 05 C 3 3

02 SOUTH ELEVATION SCALE: 1/4" = 1'-0"

04 EAST ELEVATION SCALE: 1/4" = 1'-0"

SHEET NOTES

- 01 LIGHT FIXTURE (TYPICAL) REFER TO ELECTRICAL DWGS.
 02 "V" JOINT IN EIFS REFER TO DETAIL 10 / A4.201
- FOR MORE INFORMATION
- 03 OIL CHANGE SIGN (37 S.F.) SHOWN FOR REFERENCE ONLY
- 04 PREFINISHED GALV. METAL COPING TO MATCH
- 05 A.C. UNIT LOUVER COLOR DARK BRONZE
- 06 PREFINISHED METAL OVERFLOW SCUPPER (COLOR DARK BRONZE) 07 PREFINISHED METAL DOWNSPOUT &
- LEADERHEAD (COLOR DARK BRONZE) 08 1X2 SPLASHBLOCK OR CONNECT TO STORM DRAIN (COORDINATE WITH CIVIL)

09 6" ROUND PIPE BOLLARD TYPICAL - COLOR TO

- MATCH FINISH 5 10 EF-2 W/ THERMOSTAT & GRAVITY LOUVER
- 11 BATH FAN WALL CAP
- 12 12X12 INTAKE LOUVER COLOR TO MATCH FINISH
- 13 ELECTRICAL METER / PANEL PAINT DARK BRONZE 14 PAINT DOOR & FRAME TO BE SW #6076 TURKISH COFFEE



Gensler Tel 602.523.4900 Fax 602.523.4949



Suite 175

Phoenix, AZ 85016 United States

Structural Engineer 1307 W. Morehead Street Suite 205 Charlotte, NC 28208 Telephone 980.999.6122



MEP Engineer 709 Catawba Street Belmont, NC 28012 Telephone 704.399.3943

GENERAL NOTES

riangle Date Description

1 10.08.2021 ISSUE FOR CONSTRUCTION

Seal / Signature

Project Name Take 5 Oil Change


Project Number


59.6678.008 Description

BUILDING ELEVATIONS

1/4" = 1'-0"

A2.101

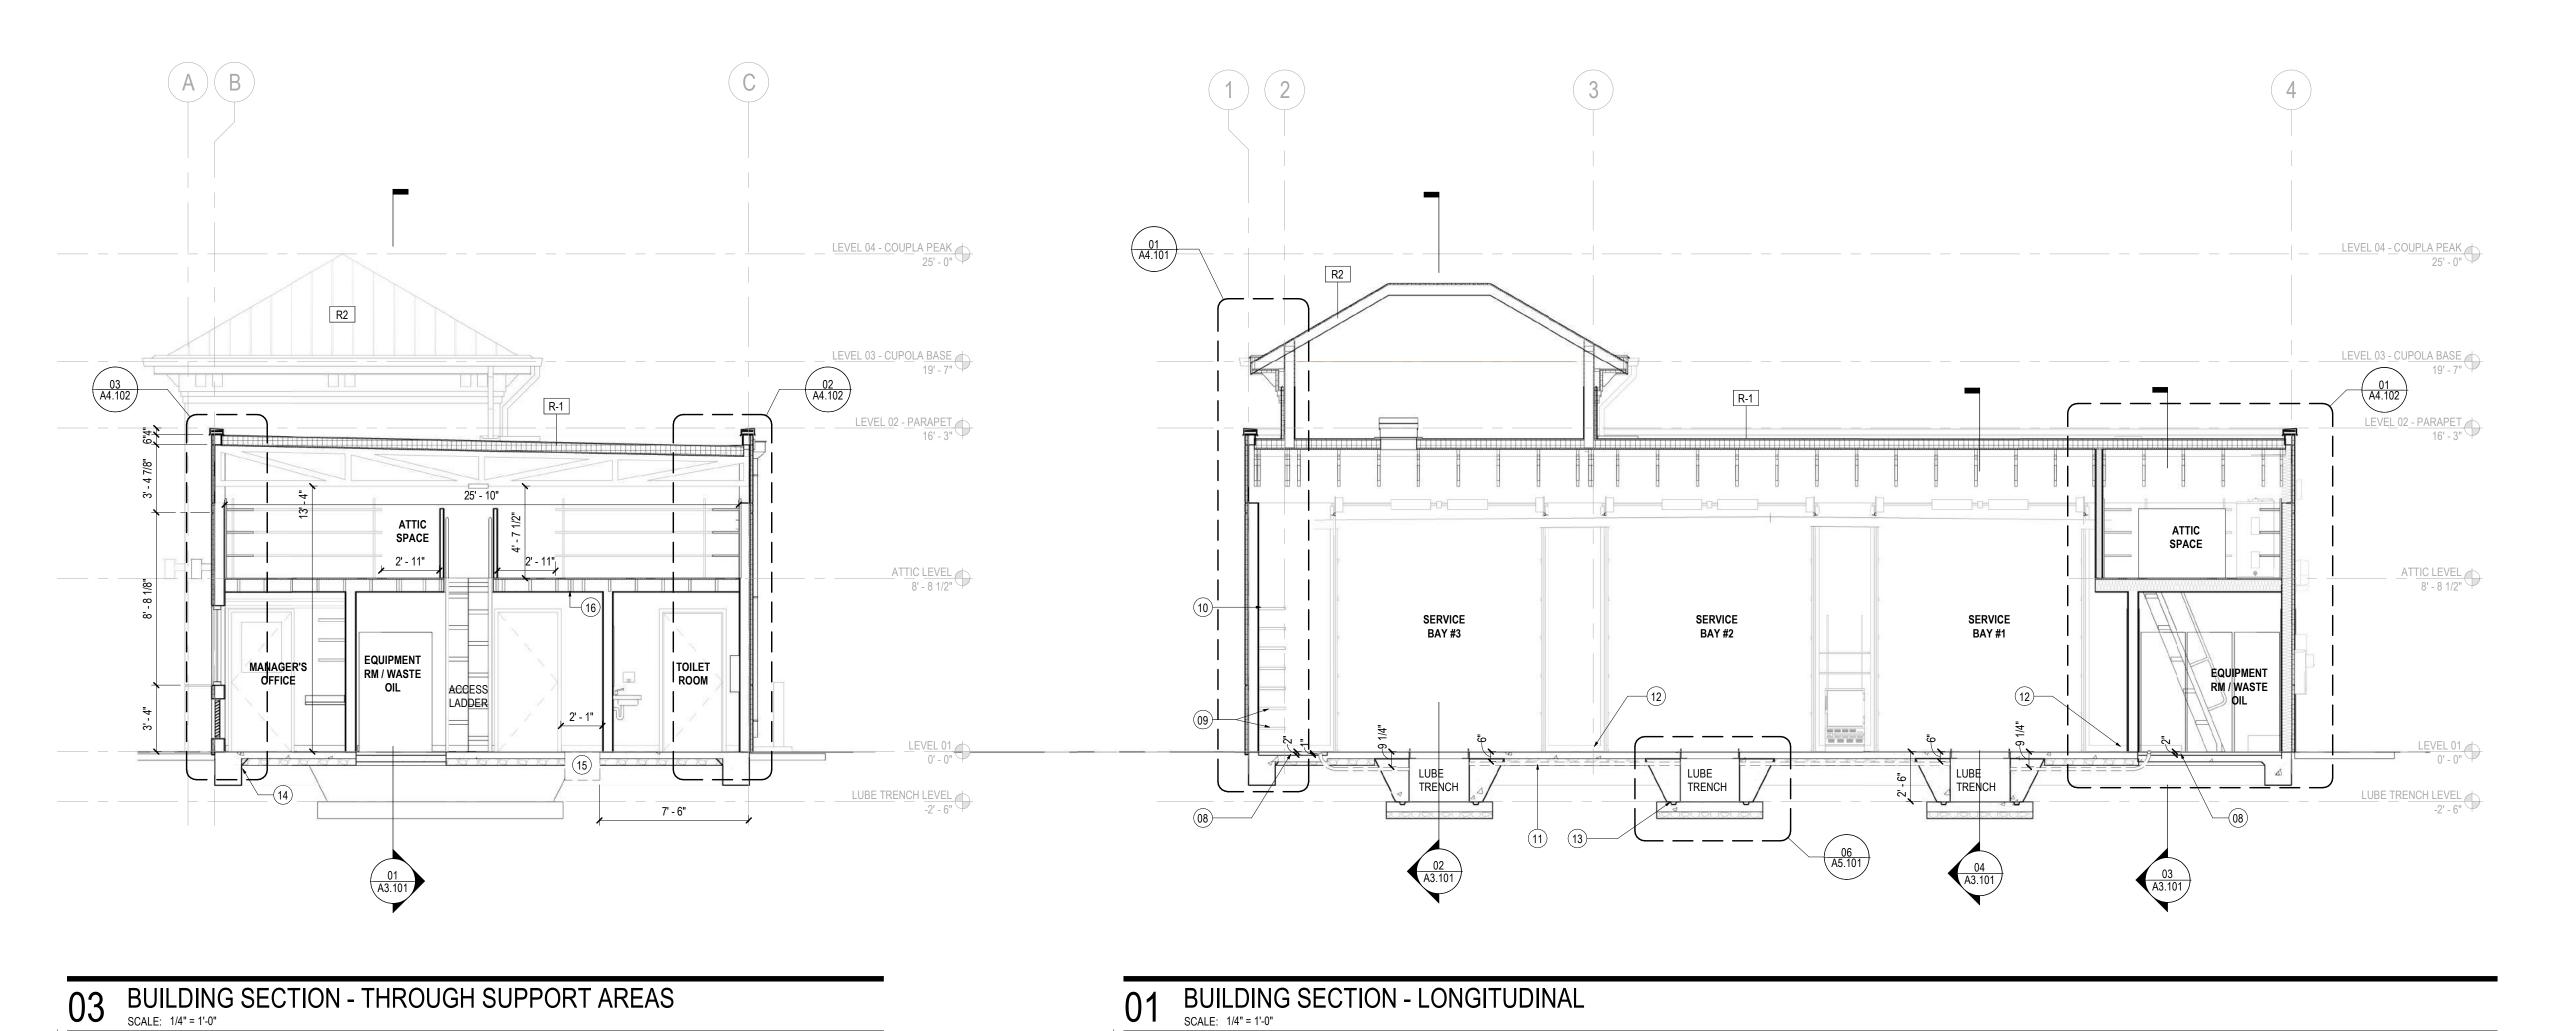

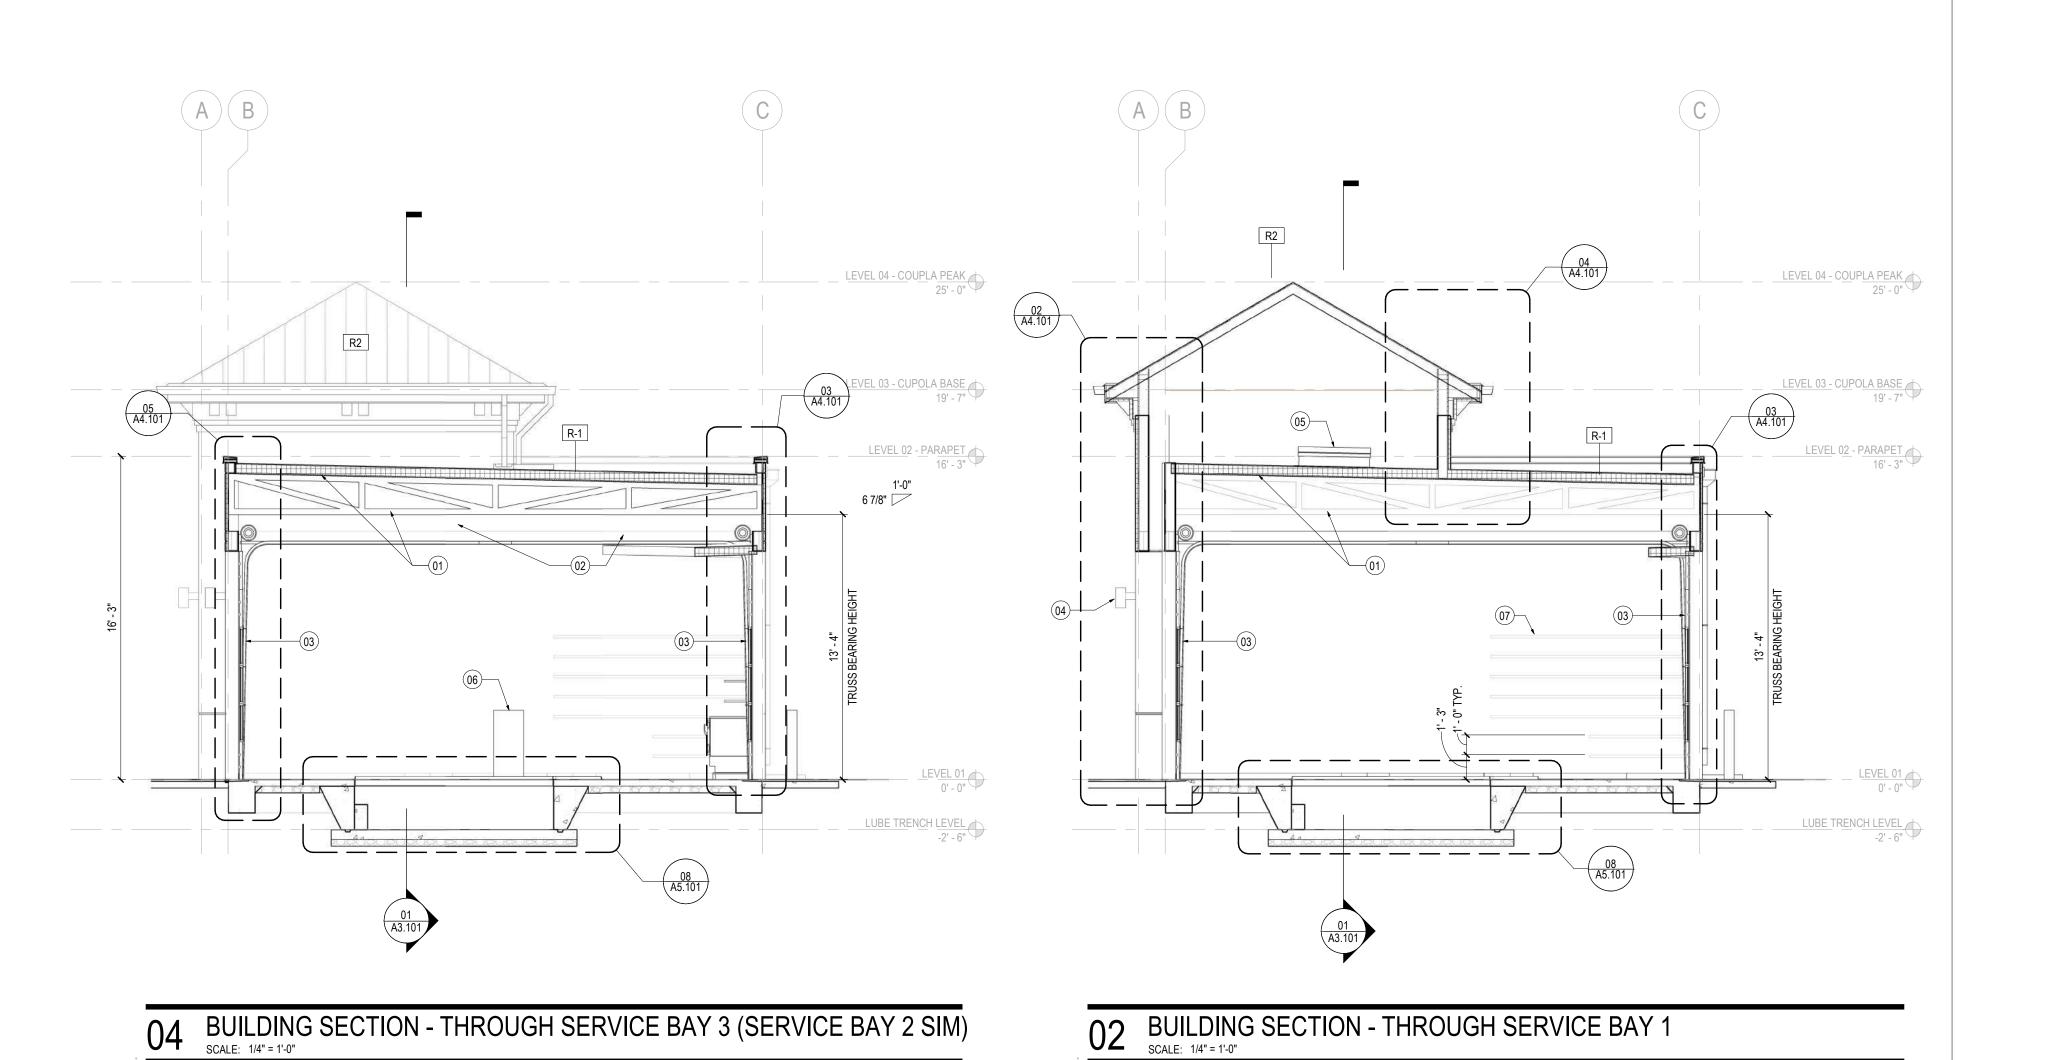

SHEET NOTES

- 01 PAINT ALL EXPOSED STRUCTURAL MEMBERS 02 OVERHEAD DOOR SUPPORTS
- 03 OVERHEAD DOOR
- 04 EXTERIOR LIGHT REFER TO ELECTRICAL
- DRAWINGS. 05 ROOF HATCH
- 06 WORK STATION SEE PLAN FOR LOCATIONS 07 (7) 16" DEEP ADJUSTABLE MELAMINE OR EQUIVILENT SHELVING.
- 08 2" DEPRESSED SLAB AT OIL AREAS 09 1ST 2 SHELVES ARE 5' WIDE & THE REST ARE 10'
- 10 (7) 16" DEEP X VARIES WIDE X 12" O.C. HIGH ADJUSTABLE MELAMINE OR EQ. SHELVING START
- 15" A.F.F. BY G.C. 11 3" DIA. PVC (TYP.) USE SWEEPS AT TURNS
- 12 VINYL BASE
- 13 CONTINUOUS WATERSTOP AROUND TRENCH, TYPICAL AT ALL LUBE TRENCHES. REFER TO STRUCTURAL DWGS.
- 14 PERIMETER INSULATION 2'-0" @ OFFICE ONLY
 15 OIL INTERCEPTOR RECESSED
 16 DOUBLE FLOOR JOIST REFER TO STRUCTURAL DWGS



Take 5 Oil Change

Gensler



Tel 602.523.4900



2575 E Camelback Rd

Structural Engineer 1307 W. Morehead Street Suite 205 Charlotte, NC 28208 Telephone 980.999.6122



MEP Engineer 709 Catawba Street Belmont, NC 28012 Telephone 704.399.3943

GENERAL NOTES

riangle Date Description

1 10.08.2021 ISSUE FOR CONSTRUCTION

Seal / Signature

Project Name Take 5 Oil Change

Project Number

59.6678.008

Description **BUILDING SECTIONS**

Scale 1/4" = 1'-0"

A3.101

PL	UMBING LEGEND
	COLD WATER PIPING (CW)
	HOT WATER PIPING (HW)
	SANITARY PIPING (SAN)
	VENT PIPING (V)
——— A ———	COMPRESSED AIR PIPING (A)
—150R×	BALL VALVE
	CAP
	CHECK VALVE
> +	FREEZELESS WALL HYDRANT (FWH)
-> 	HOSE BIBB (HB)
—⇒ NO -	PIPE DOWN
——○ OR —○—	PIPE UP
── OR ─	FLOOR CLEANOUT (FCO)
O	FLOOR DRAIN (FD)
ABV A/C AD AFF AHAP BFF BLDG BLW B/S CLG CO CONN CONT DN DS DSB DSN E.C.	ABOVE ABOVE CEILING AREA DRAIN ABOVE FINISHED FLOOR AS HIGH AS POSSIBLE BELOW FINISHED FLOOR BUILDING BELOW BELOW SLAB CEILING CLEANOUT CONNECT OR CONNECTION CONTINUATION DOWN DOWNSPOUT DOWNSPOUT BOOT DOWNSPOUT NOZZLE ELECTRICAL CONTRACTOR
E.U. ETR EX, EXIST, (E) FFE FLR G.C. HD	EXISTING TO REMAIN EXISTING FINISHED FLOOR ELEVATION FLOOR GENERAL CONTRACTOR HUB DRAIN
IE, INV ELEV M.C. MTD OH ORD P.C.	INVERT ELEVATION MECHANICAL CONTRACTOR MOUNTED OVERHEAD OVERFLOW ROOF DRAIN PLUMBING CONTRACTOR
RPZ RWC SF, SQ FT T&P TP	REDUCED PRESSURE ZONE BACKFLOW PREVENTER RAINWATER CONDUCTOR SQUARE FOOT TEMPERATURE AND PRESSURE TRAP PRIMER
TYP UNO VTR W	TYPICAL UNLESS NOTED OTHERWISE VENT THROUGH ROOF WASTE

PDI SIZE	FIXTURE UNITS	MODEL				
А	1 - 11	SIOUX CHIEF 652-AS				
В	12 - 32	SIOUX CHIEF 653-BS				
С	33 - 60	SIOUX CHIEF 654-CS				
D	61 - 113	SIOUX CHIEF 655-DS				
E	114 - 154	SIOUX CHIEF 656-ES				
F	155 - 330	SIOUX CHIEF 657-FS				

SAME SIZE AS CONNECTED PIPING. AIR CHAMBERS WILL NOT BE PERMITTED.

								PLUMBING FIXTURE SPECIFICATIONS AND CONNECTION SCHEDULE
MARK	FIXTURE	TYPE	MATERIAL	PIPE SIZE		SIZES		SPECIFICATION
				SAN	VENT	CW	HW	
<u>WC-1</u>	WATER CLOSET	FLOOR MOUNTED FLUSH TANK ADA HEIGHT	VITREOUS CHINA	3"	1-1/2"	1/2"	_	FIXTURE: AMERICAN STANDARD CADET PRO RIGHT HEIGHT NO. 215AA.104, 1.28 GALLONS PER FLUSH, ELONGATED RIM, SIPHON JET FLUSH ACTION, 3" FLUSH VALVE, EVERCLEAN SURFACE. SUPPLY: McGUIRE 1/2" X 3/8" CHROME-PLATED CAST BRASS FLEXIBLE CLOSET SUPPLY KIT, WITH WHEEL HANDLE ANGLE STOP. SEAT: BEMIS MODEL 3155SSCT EXTRA HEAVY WEIGHT, SOLID PLASTIC, OPEN FRONT, LESS COVER, STAINLESS STEEL SELF-SUSTAINING CHECK HINGES, STA-TITE FASTENING SYSTEM, ANTIMICROBIAL.
<u>L-1</u>	LAVATORY	WALL HUNG ADA HEIGHT	VITREOUS CHINA	1-1/2"	1-1/2"	1/2"	1/2"	FIXTURE: AMERICAN STANDARD LUCERNE NO. 0355.012, 20" X 18", FRONT OVERFLOW, SELF-DRAINING DECK WITH SPLASH SHIELDS, FAUCET LEDGE WITH FAUCET HOLES ON 4" CENTERS. FAUCET: AMERICAN STANDARD SEVA NO. 1480.150.002, POLISHED CHROME-PLATED CAST BRASS, SINGLE CONTROL CENTERSET, WITH 0.5 GPM VANDAL-RESISTANT AERATOR. MIXING VALVE: LEONARD LF-170 ASSE 1070 MIXING VALVE SET AT 105 DEG. F. TRAP: McGUIRE 155WC STRAINER WITH 1-1/4" OFFSET TAILPIECE, McGUIRE 1-1/4" X 1-1/2" 17 GAUGE CHROME-PLATED CAST BRASS P-TRAP WITH CLEANOUT PLUG. SUPPLIES: McGUIRE 1/2" X 3/8" CHROME-PLATED CAST BRASS FLEXIBLE LAVATORY SUPPLY KITS, WITH WHEEL HANDLE ANGLE STOPS. CARRIER: ZURN Z1231 SERIES CONCEALED ARM SYSTEM FOR WALL LAVATORIES. INCLUDE TRUEBRO LAV GUARD 2 MODEL #103 E-Z UNDERSINK PIPING COVERS, WITH P-TRAP COVER, TWO ANGLE VALVE AND SUPPLY COVERS, AND OFFSET TAILPIECE COVER.
<u>SS-1</u>	SERVICE SINK	FLOOR MOUNTED SINGLE BOWL	MOLDED STONE	1-1/2"	1-1/2"	1/2"	1/2"	FIXTURE: FIAT MODEL FL-1 FLOOR MOUNTED SERV-A-SINK, 23" X 21-1/2" X 13" DEEP, WITH DRAIN AND STOPPER, WHITE BAKED ENAMEL ANGLE LEGS WITH LEVELING DEVICES. FAUCET: AMERICAN STANDARD LAUNDRY FAUCET NO. 7573.140.002, POLISHED CHROME-PLATED CAST BRASS, 4" CENTERSET, HOSE END SWIVEL SPOUT, LEVER HANDLES. PROVIDE VACUUM BREAKERS ON SUPPLIES. TRAP: CHROME-PLATED BRASS TAILPIECE, McGUIRE 1-1/2" 17 GAUGE CHROME-PLATED CAST BRASS P-TRAP WITH CLEANOUT PLUG. SUPPLIES: McGUIRE 1/2" X 3/8" CHROME-PLATED CAST BRASS FLEXIBLE SUPPLY KITS, WITH WHEEL HANDLE ANGLE STOPS. SPRAYER: T&S BRASS B-7212-01-ESB WALL HUNG SPRAYER WITH HOSE MOP BRACKET: PROVIDE MOP BRACKET

	PLUMBING EQUIPMENT SCHEDULE								
MARK	EQUIPMENT	MANUFACTURER & MODEL NO.	SPECIFICATION						
<u>FD-1</u>	FLOOR DRAIN	ZURN ZN415B-P	CAST IRON BODY, MEMBRANE CLAMP, ADJUSTABLE COLLAR, 6" DIAMETER "TYPE B" POLISHED NICKEL BRONZE STRAINER, 1/2" TRAP PRIMER CONNECTION.						
<u>FCO</u>	FLOOR CLEAN OUT	ZURN ZN1400-BP	ADJUSTABLE, COATED CAST IRON BODY, ROUND SCORIATED NICKEL BRONZE TOP, BRONZE PLUG.						
<u>WCO</u>	WALL CLEAN OUT	ZURN Z1446-BP-VP	CAST IRON NO-HUB CLEANOUT TEE, WITH ROUND STAINLESS STEEL WALL ACCESS COVER, BRONZE PLUG, VANDAL-PROOF SECURING SCREW.						
<u>GCO</u>	GRADE CLEAN OUT	ZURN Z1400-BP-VP	ADJUSTABLE, COATED CAST IRON BODY, ROUND CAST IRON TOP, BRONZE PLUG, VANDAL-PROOF SCREWS, SET IN 18" X 18" X 6" DEEP CONCRETE SLAB.						
FWH-1	FREEZELESS WALL HYDRANT	WOODFORD MODEL B67C	ENCLOSED, ANTI-SIPHON, AUTOMATIC DRAINING, CAST BRASS WALL HYDRANT, CHROME PLATED FINISH, 3/4" INLET, 3/4" MALE HOSE THREAD NOZZLE, LOOSE TEE KEY OPERATION, WITH A DOUBLE CHECK BACKFLOW PREVENTION DEVICE. INCLUDES WOODFORD 67BX BRASS BOX IN CHROME FINISH, WITH HINGED COVER AND TEE KEY OPERABLE LOCK						
<u>HB-1</u>	HOSE BIBB	WOODFORD MODEL 26P1/2-PC	INTERIOR, EXPOSED, ANTI-SIPHON, AUTOMATIC DRAINING, POLISHED CHROME FINISH, 1/2" FLANGED FEMALE PIPE THREAD INLET, 3/4" MALE HOSE THREAD NOZZLE, WITH POLYCARBONATE WHEEL HANDLE AND LOOSE TEE KEY, WITH A DOUBLE CHECK BACKFLOW PREVENTION DEVICE.						
<u>WH-1</u>	ELECTRIC WATER HEATER	AO SMITH MODEL DEL-10	COMMERCIAL ELECTRIC, LOWBOY, 10 GALLON CAPACITY, 1.5 KW INPUT, 115V-1 PHASE, 7.5 GPH AT 80°F TEMPERATURE RISE, GLASS-LINEI STEEL TANK, WITH FACTORY INSTALLED T&P RELIEF VALVE AND DRAIN VALVE.						
<u>0I-1</u>	OIL INTERCEPTOR, RECESSED IN FLOOR	JR SMITH 8599-10-5	FABRICATED STEEL WITH DIAMOND PLATE COVER, SEDIMENT BASKET, DUCO COATED INSIDE AND COAL TAR EPOXY OUTSIDE, COMPLETE WIT FLOW CONTROL FITTING, 10 GPM FLOW RATE, 5 GPM STORAGE, PROVIDE CLEANOUT ACCESS, EXTENSIONS IF REQUIRED						

PLUMBING GENERAL NOTES

GENERAL REQUIREMENTS:

- COMPLETION AND OPERATION OF ALL SYSTEMS IN THIS SECTION OF WORK.
- ALL AUTHORITIES HAVING JURISDICTION, BUILDING DEPARTMENTS, AND DOCUMENTS AND SPECIFICATIONS. THE CONTRACTOR IS TO NOTIFY THE THE ABOVE CODES, LAWS, OR REGULATIONS. ANY WORK DONE BY THE CONTRACTOR CAUSING SUCH A VIOLATION SHALL BE CORRECTED AT THE CONTRACTOR'S EXPENSE AND AT NO EXPENSE TO THE OWNER.
- AND EQUIPMENT LOCATIONS WITH WORK UNDER OTHER DIVISIONS OF THE
- SCALE: DO NOT SCALE PLANS. SEE ARCHITECTURAL PLANS FOR EXACT LOCATION OF DOORS, WINDOWS, FIXTURES, WALLS, WALL DIMENSIONS, ETC.
- PROJECT AND BEFORE STARTING CONSTRUCTION AND NOTIFY THE ARCHITECT/ENGINEER OF RECORD OF ANY DISCREPANCIES BETWEEN THE CONSTRUCTION DOCUMENTS AND EXISTING CONDITIONS, AND/OR ANY POTENTIAL PROBLEMS OBSERVED, BEFORE CONTINUING WORK IN THE AFFECTED AREAS.
- 8. PLUMBING SYSTEMS INCLUDE, BUT ARE NOT LIMITED TO:

- PROVIDE COMPLETE FIXTURES AND INCLUDE SUPPLIES, STOPS, VALVES, FAUCETS, DRAINS, TRAPS, TAILPIECES, ESCUTCHEONS, ETC. EXPOSED COPPER
- FIXTURES/FAUCETS TO WHICH HOSES MAY BE CONNECTED.

- FURNISH AND INSTALL A COMPLETE SYSTEM OF DOMESTIC HOT AND COLD
- 3" AND SMALLER.
- ASTM D 2846 MAY BE USED.

FITTINGS, AND SOLDERED OR PRESSURE-SEALED JOINTS.

- WORKS ASSOCIATION'S SPECIFICATIONS AND LOCAL HEALTH DEPARTMENT
- PROVIDE AN ASSE 1070 TEMPERATURE LIMITING DEVICE SET AT 110 DEGREES FAHRENHEIT FOR ALL PUBLIC HAND WASHING LAVATORIES, PUBLIC GROUP WASH FIXTURES, AND HAND SINKS.
- PROVIDE A PRESSURE REDUCING VALVE WITH STRAINER AT THE SERVICE
- ENTRANCE TO THE BUILDING IF THE INCOMING WATER PRESSURE EXCEEDS 80
- SERVICE SINKS, ETC.), AND TO ALL SPRAY FAUCETS (PRE-RINSE, BED PAN CLEANERS, ETC.), UNLESS FAUCET HAS INTEGRAL CHECK VALVES.
- COPPER-PLATED. WHERE COPPER PIPING IS CARRIED ON IRON TRAPEZE HANGERS WITH OTHER PIPING, PROVIDE A PERMANENT ELECTROLYTIC ISOLATION MATERIAL TO PREVENT CONTACT WITH OTHER METALS.
- O. PROTECT COPPER PIPING AGAINST CONTACT WITH ALL MASONRY. WHERE COPPER PIPING IS SLEEVED THROUGH MASONRY. PROVIDE COPPER OR RED BRASS SLEEVES. WHERE COPPER PIPING IS CONCEALED IN OR AGAINST MASONRY PARTITIONS, PROVIDE A HEAVY COATING OF ASPHALTIC ENAMEL ON THE COPPER PIPING AND 15# ASPHALT-SATURATED FELT BETWEEN THE PIPING AND THE MASONRY PARTITION.
- SIDE OF THE WALL INSULATION.

SANITARY WASTE AND VENT PIPING:

- SCOPE: PROVIDE ALL LABOR, MATERIALS, AND EQUIPMENT REQUIRED FOR THE
- DEPARTMENT OF HEALTH. APPLICABLE NATIONAL, STATE, AND LOCAL CODES, LAWS, AND REGULATIONS GOVERNING OR RELATING TO ANY PORTION OF THIS WORK SHALL BE INCORPORATED INTO AND MADE A PART OF THESE CONTRACT ARCHITECT/ENGINEER OF ANY WORK OR MATERIALS WHICH VIOLATE ANY OF
- PERMITS: APPLY FOR AND PAY FOR ALL NECESSARY PERMITS, FEES, AND
- WARRANTY: PROVIDE ALL LABOR, MATERIALS, AND EQUIPMENT UNDER THIS SECTION OF THE SPECIFICATIONS WITH A ONE YEAR WARRANTY FROM THE DATE OF ACCEPTANCE OF WORK BY THE OWNER.
- SPECIFICATIONS TO AVOID CONFLICTS. CONTRACTOR MUST COORDINATE WITH OTHER TRADES FOR ALL STRUCTURES, PIPING, CONDUIT, DUCTWORK, LIGHTING, ETC TO PROPERLY BE INSTALLED. ANY CONFLICTS SHALL BE RESOLVED AT NO EXPENSE TO THE OWNER. COORDINATE INSTALLATION OF ALL PLUMBING PIPING AT CMU WALLS SO THAT THE PIPING IS PLACED IN WALL DURING CMU WALL CONSTRUCTION. CUTTING AND PATCHING OF CMU WALLS IN PLACE WILL NOT

- -SANITARY WASTE AND VENT SYSTEM
- -COMPRESSED AIR SYSTEM -INSULATION

- COUNTERTOPS USING SANITARY-TYPE, ONE-PART, MILDEW RESISTANT SILICONE
- PROVIDE PERMANENTLY ATTACHED VACUUM BREAKERS FOR ALL
- REFER TO ARCHITECTURAL DRAWINGS FOR MOUNTING HEIGHTS OF PLUMBING

- WATER FROM SITE SUPPLIES TO ALL FIXTURES AND/OR EQUIPMENT REQUIRING
- 2. DOMESTIC WATER PIPING BELOW GROUND: 2.1. AWWA C151 CEMENT-LINED DUCTILE IRON PIPE AND FITTINGS FOR PIPING 4" AND LARGER; ASTM B 88 TYPE 'K' SOFT COPPER TUBE WITH WROT TINGS, AND BRAZED OR PRESSURE—SEALED JOINTS FOR PIPING
- 2.2. IF PERMITTED BY LOCAL CODES, CPVC PIPE AND FITTINGS CONFORMING TO
- STERILIZE DOMESTIC WATER PIPING IN ACCORDANCE WITH THE AMERICAN WATER
- SHUT-OFF VALVES SHALL BE NIBCO TWO-PIECE, BRONZE, FULL PORT, BALL TYPE. PROVIDE SHUT-OFF VALVES ON ALL BRANCH PIPING SERVING TWO OR MORE FIXTURES. AND WHERE INDICATED ON THE DRAWINGS. INSTALL VALVES IN A LOCATION THAT PERMITS ACCESS FOR SERVICE AND OPERATION WITHOUT DAMAGE TO THE BUILDING OR FINISHED MATERIALS. PROVIDE ACCESS DOORS

- PROVIDE CHECK VALVES IN THE HOT AND COLD WATER SUPPLY PIPING TO ALL FAUCETS TO WHICH HOSES MAY BE CONNECTED (MOP BASINS, CAN WASHES,
- PROTECT COPPER PIPING AGAINST CONTACT WITH DISSIMILAR METALS. ALL HANGERS, SUPPORTS, ANCHORS, AND CLIPS SHALL BE COPPER OR

- CODE COMPLIANCE: ALL WORK SHALL COMPLY WITH THE REQUIREMENTS OF AND FITTINGS; AND GASKETED JOINTS. ALL PIPE AND FITTINGS SHALL BE
- INSPECTIONS REQUIRED BY ANY PUBLIC AUTHORITY HAVING JURISDICTION.
- COORDINATION: VERIFY ALL ROUGH-IN LOCATIONS AND COORDINATE PIPING

- FIELD VERIFICATION: FIELD VERIFY EXISTING CONDITIONS BEFORE BIDDING
- -PLUMBING FIXTURES AND EQUIPMENT
- -DOMESTIC WATER SYSTEM

-HEAT TRACE

- OR BRASS MATERIALS SHALL BE CHROME PLATED.
- SEAL ALL EDGES OF PLUMBING FIXTURES IN CONTACT WITH FLOORS, WALLS, OR SEALANT. MATCH SEALANT COLOR TO FIXTURE COLOR.

DOMESTIC WATER PIPING:

- DOMESTIC WATER SUPPLIES. VERIFY LOCATION OF BEGINNING POINTS.

- DOMESTIC WATER PIPING ABOVE GROUND: 3.1. ASTM B 88 TYPE 'L' HARD COPPER TUBE WITH WROUGHT COPPER
- 3.2. IF PERMITTED BY LOCAL CODES, FLOWGUARD GOLD CPVC COPPER TUBE SIZE SDR 11 PIPE AND FITTINGS CONFORMING TO ASTM D 2846 MAY BE
- 3.3. IF PERMITTED BY LOCAL CODES, ASTM F876 CROSSLINKED POLYETHYLENE PEX-A TUBING, AND ASTM F1960 PEX-A COLD EXPANSION FITTINGS MAY BE USED. DO NOT INSTALL PEX TUBING IN RETURN AIR PLENUMS.

- . INSTALL DOMESTIC WATER PIPING IN EXTERIOR WALLS ON THE CONDITIONED

1. FURNISH AND INSTALL COMPLETE SYSTEMS OF SANITARY WASTE AND VENT PIPING FROM ALL PLUMBING FIXTURES AND OR FOUIPMENT REQUIRING WASTE

AND VENT CONNECTIONS. ALL WASTE AND VENT PIPING SHALL BE CONCEALED IN THE BUILDING CONSTRUCTION WHERE POSSIBLE. 2. SANITARY WASTE AND VENT PIPING BELOW GROUND: 2.1. ASTM A 74, SERVICE WEIGHT, HUB AND SPIGOT, CAST IRON SOIL PIPE

BE USED. FOAM CORE PVC PIPE IS NOT APPROVED.

INTERNATIONAL.

MARKED WITH THE COLLECTIVE TRADEMARK OF THE CAST IRON SOIL PIPE INSTITUTE, AND LISTED BY NSF INTERNATIONAL. 2.2. IF PERMITTED BY LOCAL CODES, ASTM D 2665 SCHEDULE 40 SOLID WALL

PVC PIPE WITH ASTM D 2665 SCHEDULE 40 SOCKET-TYPE FITTINGS MAY

- 3. SANITARY WASTE AND VENT PIPING ABOVE GROUND: 3.1. ASTM A 888 AND CISPI 301, HUBLESS, CAST IRON SOIL PIPE AND FITTINGS; AND HEAVY DUTY SHIELDED, STAINLESS STEEL COUPLINGS. ALL PIPE AND FITTINGS SHALL BE MARKED WITH THE COLLECTIVE TRADEMARK OF THE CAST IRON SOIL PIPE INSTITUTE, AND LISTED BY NSF
- 3.2. IF PERMITTED BY LOCAL CODES, ASTM D 2665 SCHEDULE 40 SOLID WALL PVC PIPE WITH ASTM D 2665 SCHEDULE 40 SOCKET-TYPE FITTINGS MAY BE USED. FOAM CORE PVC PIPE IS NOT APPROVED.
- INVERT ELEVATIONS SHALL BE ESTABLISHED AND VERIFIED BEFORE SANITARY PIPING IS INSTALLED IN ORDER THAT PROPER SLOPES WILL BE MAINTAINED. SLOPE SANITARY PIPING 2-1/2" AND SMALLER AT 1/4" PER FOOT MINIMUM, AND SLOPE SANITARY PIPING 3" AND LARGER AT 1/8" PER FOOT MINIMUM.
- WHERE SANITARY PIPING IS EXPOSED IN TOILET ROOMS. PROVIDE CHROME-PLATED BRASS PIPING WITH MATCHING ESCUTCHEONS. PROVIDE REMOVABLE TRAPS WITH INTEGRAL CLEANOUT PLUG FOR ALL LAVATORIES AND
- INSTALL CLEANOUTS IN A LOCATION THAT PERMITS ACCESS FOR SERVICE WITHOUT DAMAGE TO THE BUILDING OR FINISHED MATERIALS. CLEANOUT PLUGS SHALL BE INSTALLED IN ACCORDANCE WITH PLUMBING CODE REQUIREMENTS. PROVIDE CLEANOUTS IN HORIZONTAL PIPING NOT MORE THAN 100 FEET APART, AT THE BASE OF ALL SOIL AND WASTE STACKS, AND FOR EVERY FOUR 45° CHANGES LOCATED IN SERIES (A LONG SWEEP IS EQUIVALENT TO TWO 45°
- 7. ALL INDIRECT WASTE PIPING SHALL DISCHARGE THROUGH AN AIR GAP INTO AN APPROVED WASTE RECEPTOR. THE AIR GAP BETWEEN THE INDIRECT WASTE PIPE AND THE FLOOD LEVEL RIM OF THE WASTE RECEPTOR SHALL BE A
- 8. PROVIDE AUTOMATIC TRAP PRIMER ON ALL TRAPS WITH TRAP SEAL SUBJECT TO LOSS BY EVAPORATION. IF ALLOWED BY LOCAL AUTHORITY HAVING JURISDICTION, A TRAP SEAL MAINTENANCE DEVICE MAY BE USED IN LIEU OF A

MINIMUM OF TWICE THE EFFECTIVE OPENING OF THE INDIRECT WASTE PIPE.

- TRAP PRIMER WHERE TRAP SEAL IS SUBJECT TO LOSS BY EVAPORATION. 9. ON SLOPED ROOFS, PAINT SANITARY VENT PIPING ABOVE ROOF TO MATCH
- 10. MODIFY PIPING AS REQUIRED SO THAT SANITARY VENT TERMINALS ARE A MINIMUM OF 10' FROM ANY BUILDING FRESH AIR INLET OR AS OTHERWISE

REQUIRED BY LOCAL AUTHORITIES. COMPRESSED AIR PIPING:

- WORK TO INCLUDE PIPING FROM EXISTING PIPING TO ALL NEW EQUIPMENT REQUIRING COMPRESSED AIR SUPPLY, INCLUDING FINAL CONNECTIONS TO
- 2. COMPRESSED AIR PIPING: ASTM B 88 TYPE 'L' HARD COPPER TUBE WITH WROT COPPER FITTINGS, AND BRAZED JOINTS.
- 3. SHUT-OFF VALVES SHALL BE FULL PORT, BALL TYPE APPROVED FOR USE IN COMPRESSED AIR PIPING SYSTEMS. PROVIDE SHUT-OFF VALVES AT
- CONNECTIONS TO EXISTING PIPING, AND AT EACH CONNECTION TO EQUIPMENT.
- 5. INSTALL BRANCH CONNECTIONS TO EQUIPMENT FROM TOP OF COMPRESSED AIR
- 6. PROVIDE DRAIN LEG AT END OF EACH COMPRESSED AIR MAIN AND BRANCH. 7. PROVIDE PRESSURE REGULATOR AND FILTER AT EACH CONNECTION TO EQUIPMENT AS REQUIRED. VERIFY ALL CONNECTION REQUIREMENTS WITH
- PROTECT COPPER PIPING AGAINST CONTACT WITH DISSIMILAR METALS. ALL HANGERS, SUPPORTS, ANCHORS, AND CLIPS SHALL BE COPPER OR

COPPER-PLATED. INSULATION:

- INSULATION, JACKETS, COVERINGS, SEALERS, MASTICS, AND ADHESIVES SHALL NOT EXCEED A FLAME SPREAD RATING OF 25 AND A SMOKE DEVELOPED RATING OF 50 WHEN TESTED IN ACCORDANCE WITH ASTM E 84.
- 2. ALL PIPE INSULATION SHALL RUN CONTINUOUSLY THROUGH FLOORS, WALLS,
- DOMESTIC WATER PIPING: 3.1. INSULATE METALLIC WATER SYSTEM WATER PIPING ABOVE GRADE (EXCEPT EXPOSED CONNECTIONS TO PLUMBING FIXTURES) WITH 1" ELASTOMERIC FOAM INSULATION, OR 1" FIBERGLASS PIPE INSULATION WITH
- USED FOR METALLIC PIPING 1" AND LESS. 3.2. INSULATE NON-METALLIC PIPING INSTALLED IN RETURN AIR PLENUMS WITH FIRE BARRIER PLENUM WRAP LISTED FOR THE PIPE MATERIALS AND PIPE SIZE, IF THE PIPE AND FITTINGS ARE NOT LISTED FOR INSTALLATION IN

FACTORY-APPLIED ALL SERVICE JACKETING. 1/2" INSULATION MAY BE

RETURN AIR PLENUMS.

HEAT TRACE:

 DOMESTIC WATER PIPING: 1.1. IN AREAS SUBJECT TO FREEZING TEMPERATURES, WRAP WITH HEAT TRACE AND INSULATION INSTALLED PER MANUFACTURER'S RECOMMENDATIONS TO

MAINTAIN TEMPERATURE AT 40°F OR ABOVE.

ARRESTER SCHEDULE.

WATER HAMMER ARRESTER REQUIREMENTS: PROVIDE WATER HAMMER ARRESTERS CONFORMING TO PDI-WH201 OR ASSE 1010, INSTALLED PER MANUFACTURER'S SPECIFICATIONS, WHERE QUICK CLOSING VALVES ARE UTILIZED. A QUICK CLOSING VALVE IS A VALVE OR FAUCET THAT CLOSES AUTOMATICALLY WHEN RELEASED, OR THAT IS CONTROLLED BY MECHANICAL MEANS FOR FAST-ACTION CLOSING. REFER TO WATER HAMMER

LENGTH, A SECOND WATER HAMMER ARRESTER IS REQUIRED.

2. AS A MINIMUM, PROVIDE ONE WATER HAMMER ARRESTER FOR EACH BRANCH LINE TO EACH TOILET ROOM LESS THAN 20' IN LENGTH, LOCATED BETWEEN THE LAST TWO FIXTURES SERVED. FOR BRANCH LINES GREATER THAN 20' IN

Seal / Signature



Take 5 Oil Change

Fax 704.377.2807

80 Posse Ground Rd. Sedona, AZ 86336

Gensler

ASSOCIATES consulting engineers

Structural Engineer

Charlotte, NC 28208

MEP Engineer

Description

7/29/2021 ISSUE FOR CONSTRUCTION

2905-D Queen City Dr.

Telephone 704.399.3943

Charlotte, NC 28208

Suite 205

1307 W. Morehead Street

Telephone 980.999.6122

101 South Tryon Street

Charlotte, NC 28280

Suite 2100

United States

Project Name Take 5 Oil Change

Project Number


59.6678.001 Description

PLUMBING NOTES, LEGEND AND SCHEDULES

As indicated

P0.01

Scale

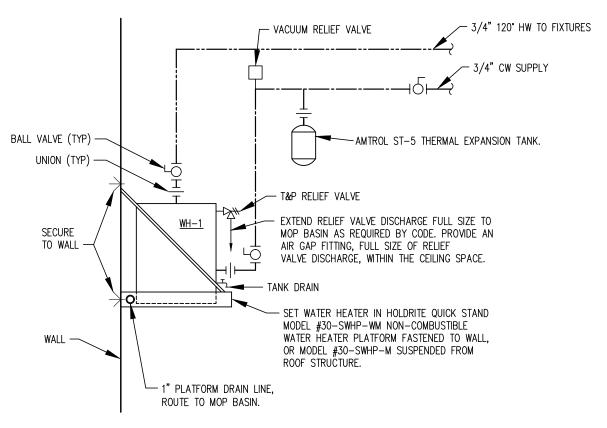


NOTES:


1. WATER HEATER PLATFORM SHALL BE MOUNTED ABOVE CEILING OR AS HIGH AS POSSIBLE ON WALL. 2. PROVIDE HEAT TRAPS AS REQUIRED PER LOCAL CODE, UNLESS WATER HEATER HAS INTEGRAL HEAT TRAPS. 3. WATER HEATER AND RELATED COMPONENTS SHALL BE INSTALLED PER CODE AND MANUFACTURER'S INSTRUCTIONS.


GENERAL NOTES


- PROVIDE HEAT TRACE ON ALL PIPING RUN EXPOSED IN SERVICE BAY AND STORAGE ROOM
- VERIFY/CONFIRM ALL HOSE BIBB LOCATIONS WITH OWNER PRIOR TO STARTING WORK
- COMPRESSED AIR SYSTEM BY OTHERS. SEE OWNER AND EQUIPMENT PROVIDED FOR ADDITIONAL INFORMATION.
- SEAL ALL PIT PENETRATIONS

DOMESTIC WATER HEATER DETAIL P1.01 NOT TO SCALE

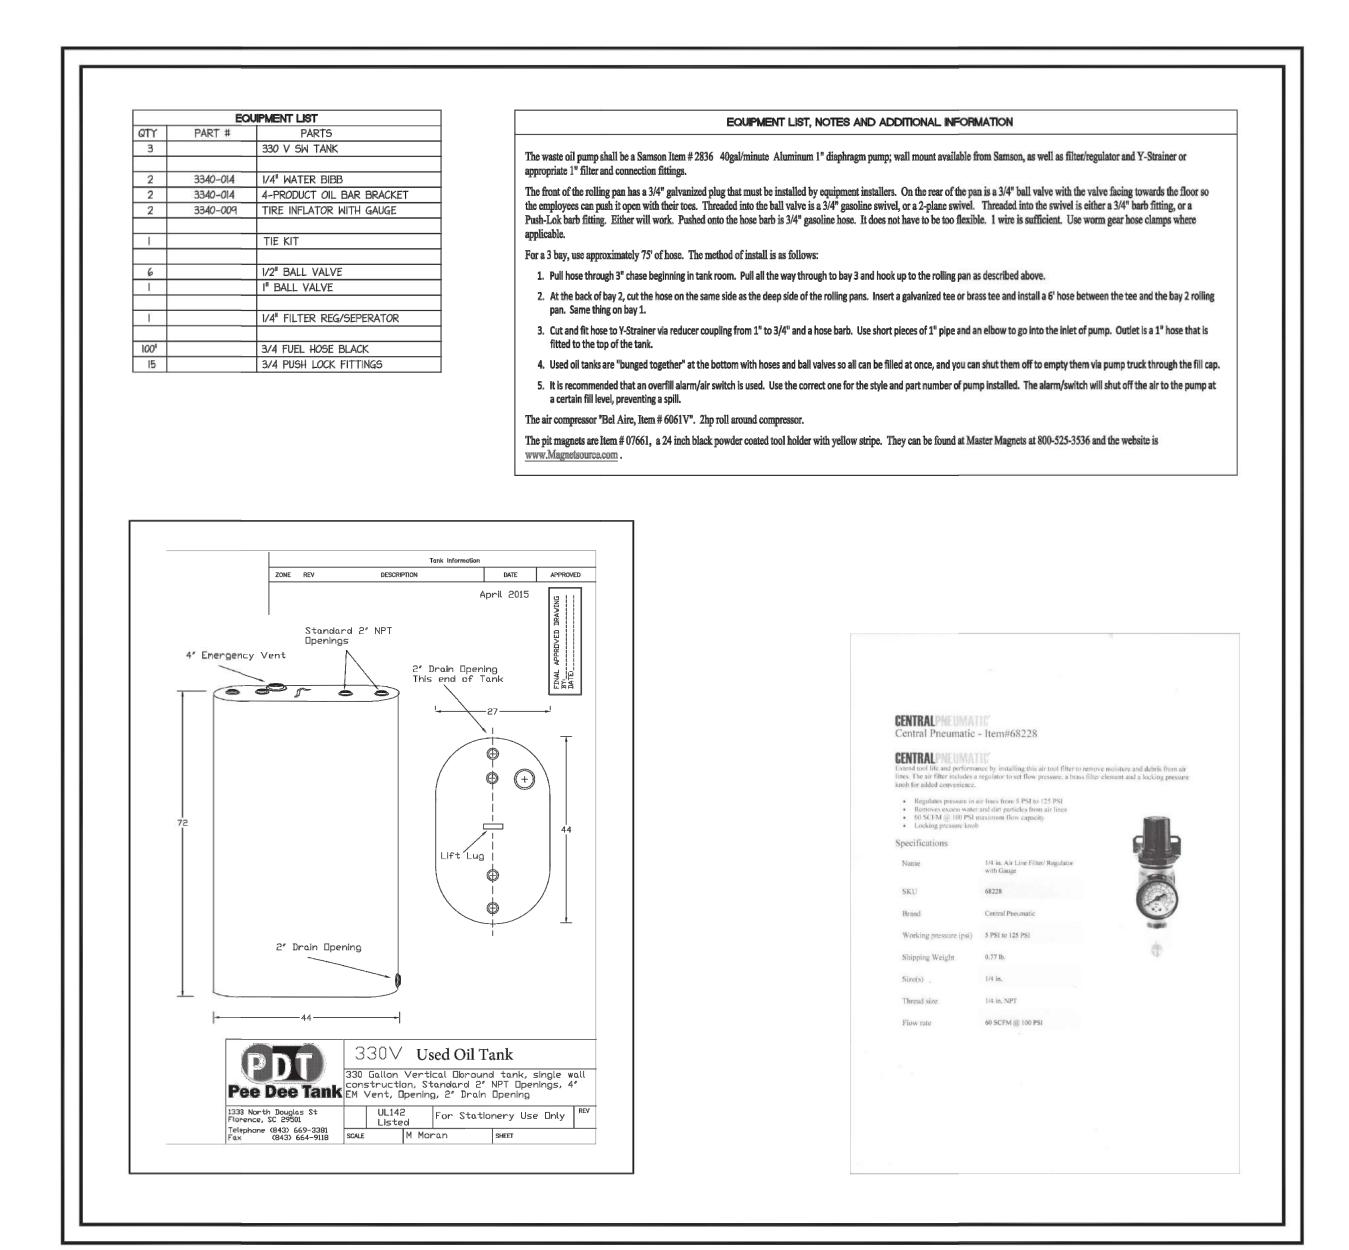

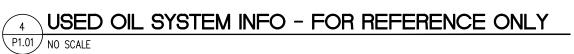

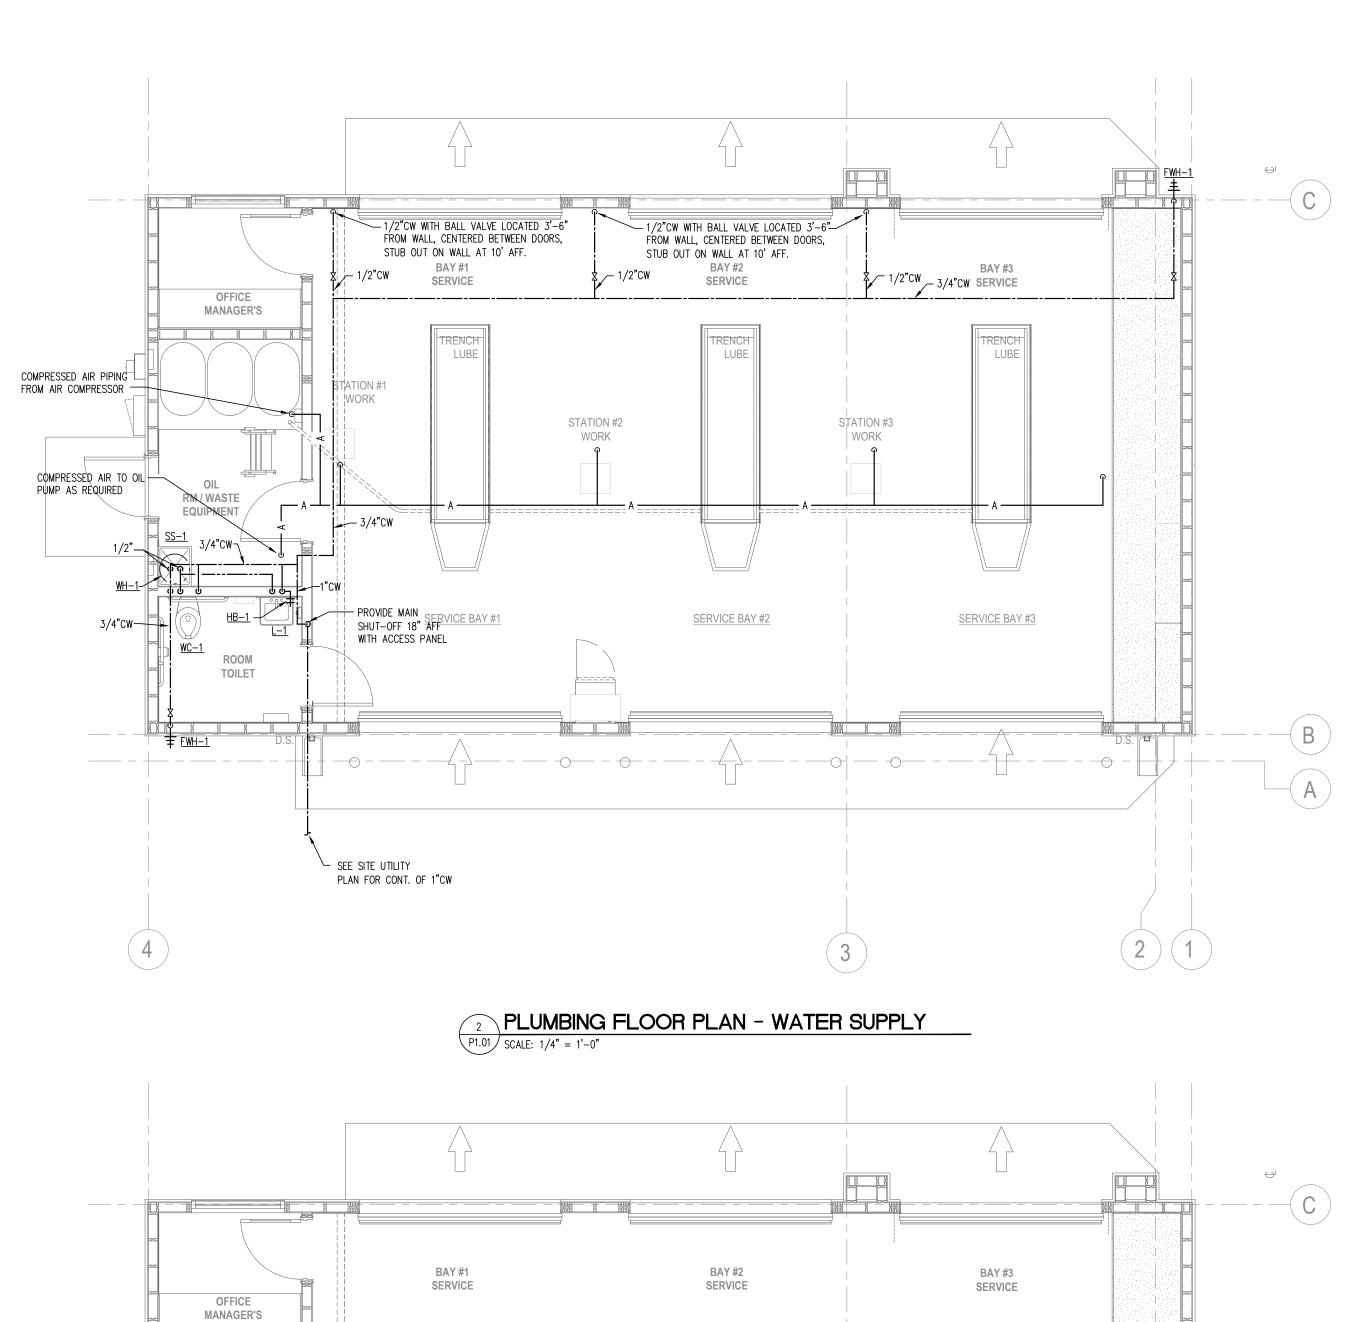

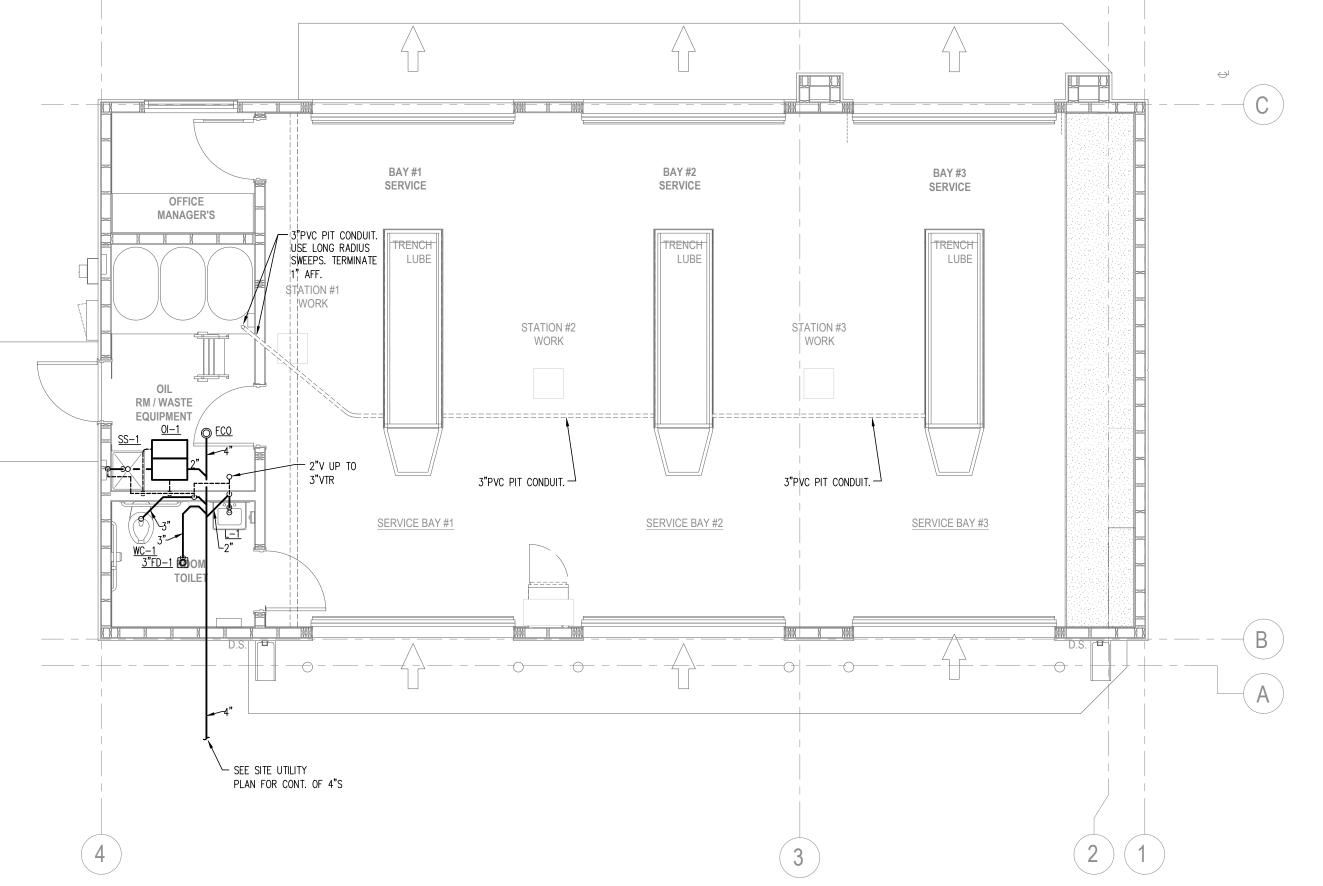

PLUMBING FLOOR PLAN - WASTE AND VENT P1.01 SCALE: 1/4" = 1'-0"

Take 5 Oil Change 80 Posse Ground Rd. Sedona, AZ 86336



Fax 704.377.2807

Gensler

101 South Tryon Street Suite 2100 Charlotte, NC 28280 United States



Structural Engineer 1307 W. Morehead Street Suite 205 Charlotte, NC 28208 Telephone 980.999.6122



MEP Engineer 2905-D Queen City Dr. Charlotte, NC 28208 Telephone 704.399.3943

△ Date Description 7/29/2021 ISSUE FOR CONSTRUCTION

Seal / Signature



Project Name

Take 5 Oil Change

Project Number 59.6678.001

Description PLUMBING FLOOR

Scale As indicated

PLANS

P1.01

					FAN SO	CHED	ULE				
<u>SYMBOL</u>	<u>TYPE</u>	<u>CFM</u>	APPROX.	<u>DRIVE</u>	<u>RPM</u>	M ELECTRICAL DATA WATTS H.P. VOLTAGE			<u>MANUFACTURER</u>	CONTROL	ACCESSORIES
STWIDOL	1156	CLIM	<u>S.P.</u>	DRIVE	<u>IXFIWI</u>	<u>WATTS</u>	<u>H.P.</u>	<u>VOLTAGE</u>	<u>GREENHECK</u>	CONTROL	ACCESSONIES
<u>EF-1</u>	EXHAUST	100	0.25	DIRECT	708	128	_	120V/1ø	SP-B150	D	1 2 4 5 6 8 12 13
<u>EF-2</u>	EXHAUST	200	0.25	DIRECT	1400	113	_	120V/1ø	SEI-10428-P	С	1 2 4 5 8 11 12
<u>EF-1</u>	EXHAUST	150	0.25	DIRECT	1080	128	_	120V/1ø	SP-B150	С	1 2 4 5 6 8 12 13

ACCESSORIES : DISCONNECT BY E.C.

4: BIRDSCREEN

5: SPEED CONTROLLER

6: HANGING BRACKETS

7: DISCHARGE HOOD 2: BACKDRAFT DAMPER 3: PREFAB. ROOF CURB

8: WL, WALL LOUVER DISCHARGE 9: MFG ROOF CAP 10: WALL MOUNTING COLLAR 11: MOTOR SIDE FAN GUARD 12: COLOR BY ARCHITECT WITH VIBRATION ISOLATION

13: EXHAUST GRILLE

14: UL 762

BAY #2

SERVICE

SERVICE BAY #2

ENTRY

MECHANICAL FLOOR PLAN

M1.01 SCALE: 1/4" = 1'-0"

CLASS I LIQUIDS ARE NOT USED OR STORED IN THIS BUILDING.

2. VEHICLES ARE ONLY OPERATED

FOR THE DURATION OF MOVING THEM IN AND OUT OF THE GARAGE.

A: WALL MOUNTED SWITCH B: WALL MOUNTED PUSH BUTTON SWITCH C: WALL MOUNTED THERMOSTAT

D: INTERLOCK WITH ROOM LIGHT SWITCH

E: CONTINUOUS OPERATION F: INTERLOCK WITH KITCHEN HOOD CONTROLS

CONTROL:

TOTAL OUTDOOR AIR REQUIRED = 5

NOTES:

ALL FANS SHALL BE U.L. LISTED AND LABELED AND SHALL BE AMCA CERTIFIED.

ALL FANS SHALL BE SUPPLIED BY ONE MANUFACTURER UNLESS NOTED OTHERWISE. MECHANICAL CONTRACTOR SHALL PROVIDE MAGNETIC STARTER WITH AUXILLARY CONTACTS AS REQUIRED.

BACKDRAFT DAMPER ON ROOF SUPPLY FANS SHALL BE MOTORIZED.

WHEN A SPEED CONTROLLER IS REQUIRED AND MOUNTED TO EXHAUST FAN, SPEED SHALL BE ADJUSTED TO PROVIDE LISTED AIRFLOW PRIOR TO CEILING BEING INSTALLED.

BAY #1

SERVICE

SERVICE BAY #1

ENTRY

STATION #1

	CTRIC	UNI	Τŀ	IEA	ΓER	SCH	IEDULE	
SYMBOL	LOCATION	MDU	IZW		ELEC DA	ГА	MANUFACTURER	
SIMBUL	<u>LOCATION</u>	<u>MBH</u>	<u> KW</u>	VOLTS	PHASE	AMPS	QMARK	REMARKS
EH-1	TOILET	2.56	0.75	120	1	6.3	QCH1151F	1,2,4
EH-2	STORAGE	5.12	1.5	208	1	7.2	QCH1202F	1,2,4
IRH-1,2	SERVICE BAYS	20.5	6.0	208	1	-	BRM6083B	1,3,5

NOTES & ACCESSORIES:

1. HEATING CAPACITY BASED ON 65° F. E.A.T., 180° F. E.W.T.

2. DISCONNECT SWITCH 3. WALL MOUNTED THERMOSTAT

4. INTERNAL THERMOSTAT

5. CHAIN MOUNT 12'-0" AFF (FIELD COORD. FINAL MOUNTING HEIGHT WITH OWNER)

T	AC	UN	ITS

UNIT TAG	AMANA MODEL	FAN CFM	OSA CFM	ESP (WG)	EER	COOLING (MBH)	ELECT. HEAT (KW)	VOLTAGE (V)	MCA (A)	MOCP (A)	WEIGHTS (LBS)	
PTAC-1	PTC073G	310	10	0.4	11.7	7.7	3.5	208V/1ø	19.5	20	108	

1) G.C. SHALL PROVIDE INSULAATED SUB-BASE KIT WITH DISCONNECT SWITCH FOR ALL PTAC'S. CONCEAL ALL ELECTRICAL CONNECTIONS WITH-IN KIT.

2) 2 SPEED FAN 3) PROVIDE EXTENDED SLEEVE IF REQUIRED. VERIFY PRIOR TO ORDERING.

-3/4" COND.

OFFICE MANAGER'S

RM / WASTE EQUIPMENT EH-2

VENTILATION CALCULATIONS

BASED ON TABLE 403.3 OF THE 2018 IMC

BASED ON EQUATION 4-1 FROM SECTION 403.3.1.1: Vbz = RpPz + RaAz WHERE:

Az = ZONE FLOOR AREA Pz = ZONE POPULATION Rp = PEOPLE OUTDOOR AIR RATE Ra = AREA OUTDOOR AIR RATE

<u>PTAC-1</u> OFFICE:

 $Vbz = (50 \times 0.06) + \underline{50 \times 5 \times 5}$ = 4 CFM OA REQUIRED

Ev = 0.8 Voz = Vbz/Ev = 4/0.8 = 5 CFM

TOTAL OUTDOOR AIR PROVIDED = 10

TOTAL SF FREE AREA = 600 SF*

NATURAL VENTILATION CALCULATION

SERVICE BAYS:

1150 (SF) \times 0.04 = 46 (SF) (FREE AREA REQUIRED)

OVERHEAD DOOR AREA = 60'x10'

*NATURAL VENTILATION REQUIREMENT IS MET FOR THIS UNIT.

GENERAL COORDINATION NOTES

- THE CONTRACTOR SHALL REVIEW THE ENTIRE SET OF DOCUMENTS INCLUDING BUT NOT LIMITED TO ALL ARCHITECTURAL, STRUCTURAL, MECHANICAL, ELECTRICAL, PLUMBING AND THE ENTIRE PROJECT MANUAL. THE CONTRACTOR SHALL ACKNOWLEDGE AND INCLUDE IN THE SCOPE OF WORK (CONTRACT) ALL CONDITIONS PERTINENT TO THE COMPLETIONS OF HIS WORK. THE CONTRACTOR SHALL FULLY COORDINATE HIS WORK WITH THE INSTALLATION OF WORK BY ALL OTHER TRADES AND MAKE NECESSARY FIELD ADJUSTMENTS AS REQUIRED TO ACCOMMODATE THE INSTALLATION. ALL OF THE ABOVE SHALL BE INCLUDED IN THE SCOPE OF WORK AT NO ADDITIONAL COST TO THE OWNER.
- THE CONTRACTOR SHALL CAREFULLY EXAMINE THE DRAWINGS AND SPECIFICATIONS, VISIT THE SITE OF THE WORK AND FULLY INFORM HIMSELF AS TO ALL CONDITIONS AND MATTERS THAT CAN, IN ANY WAY AFFECT THE WORK OR THE COST THEREOF. SHOULD THE CONTRACTOR FIND DISCREPANCIES IN, OR OMISSIONS FROM THE DRAWINGS, SPECIFICATIONS OR OTHER DOCUMENTS OR BE IN DOUBT AS TO THEIR INTENT, HE SHALL NOTIFY THE ARCHITECT/ENGINEER AT ONCE IN WRITING OF ANY DISCREPANCIES BETWEEN EXISTING CONDITIONS AND NEW WORK, OR BETWEEN HIS WORK AND THE WORK OF OTHER TRADES PRIOR AND OBTAIN CLARIFICATION PRIOR TO SUBMITTING BID. LACK OF SUCH NOTIFICATION SHALL BE CONSTRUED TO INDICATE NO DISCREPANCIES OR CONFLICTS. ADDITIONAL COMPENSATION WILL NOT BE GRANTED AFTER AWARD OF CONTRACT FOR ANY WORK REQUIRED TO COMPLY WITH THESE REQUIREMENTS.

BAY #3

SERVICE

SERVICE BAY #3

(06)____


TATION #3

WORK

HVAC GENERAL NOTES


- 1. THE CONTRACTOR SHALL FURNISH AND INSTALL ALL MATERIAL AND EQUIPMENT IN STRICT ACCORDANCE WITH APPLICABLE STATE AND LOCAL CODES AND STANDARDS, AND PER MANUFACTURER'S DIRECTIONS.
- 2. THE CONTRACTOR SHALL SECURE AND PAY FOR ALL NECESSARY PERMITS, LICENSE, INSPECTIONS, APPROVALS, AND FEES.
- 3. THE CONTRACTOR SHALL COORDINATE HIS WORK WITH ALL OTHER TRADES BEFORE INSTALLATION OF ANY MATERIALS OR EQUIPMENT.
- 4. THESE DRAWINGS ARE DIAGRAMMATIC AND SHOW GENERAL LOCATION AND ARRANGEMENT OF ALL MATERIALS AND EQUIPMENT. THE DRAWINGS SHALL BE FOLLOWED AS CLOSELY AS BUILDING CONSTRUCTION AND ALL OTHER WORK WILL PERMIT.
- 5. DO NOT SCALE DRAWINGS FOR MEASUREMENTS.
- 6. ALL DUCT DIMENSIONS SHOWN ARE INTERIOR OPEN AREA DIMENSIONS. CONTRACTOR SHALL ADJUST DUCT SIZE WHEN USING INTERNAL INSULATION IN LIEU OF EXTERNAL WRAP.
- 7. ALL PENETRATIONS THROUGH EXTERIOR WALLS & ROOF SHALL BE FLASHED & COUNTERFLASHED IN A WATERPROOF MANNER. (COLOR TO MATCH EXTERIOR).
- 8. ALL SUSPENDED MATERIALS AND EQUIPMENT SHALL BE INDIVIDUALLY SUPPORTED FROM THE BUILDING STRUCTURE. DO NOT SUSPEND ITEMS FROM THE CEILING OR ITS SUPPORT SYSTEM.
- 9. INSTALL ALL CONTROL DEVICES, INCLUDING THERMOSTATS AND SWITCHES, 4'-0" ABOVE FINISHED FLOOR. PROVIDE THE REQUIRED DEVICE(S) FOR ALL SYSTEMS WHETHER LOCATED ON THE PLANS OR NOT. ANY THERMOSTAT LOCATED ON AN EXTERIOR WALL SHALL BE PROVIDED WITH AN
- 10. LOCATE CEILING GRILLES IN ACCORDANCE WITH ARCHITECTURAL REFLECTED CEILING PLANS (IF
- 11. PROVIDE MANUFACTURER'S RECOMMENDED CLEARANCES AROUND MECHANICAL UNITS FOR MAINTENANCE AND FILTER REMOVAL.
- 12. ALL PIPING AND DUCTWORK LOCATIONS SHALL BE COORDINATED W/ WORK UNDER OTHER DIVISIONS OF THE SPECIFICATIONS, TO AVOID INTERFERENCE.
- 13. THE EXTERNAL STATIC PRESSURE FOR ALL FANS, HVAC UNITS, ETC IS BASED ON DUCT ROUTING AS INDICATED ON PLANS. THE MECHANICAL CONTRACTOR SHALL NOTIFY THE ENGINEER OF ANY DEVIATIONS IN THE FIELD AS AIR QUANTITIES MAY BE AFFECTED.
- 14. CERTIFIED TEST AND BALANCE CONTRACTOR SHALL BALANCE SYSTEM TO AIR QUANTITIES INDICATED ON PLANS AND PROVIDE OWNER'S REPRESENTATIVE WITH COMPLETE BALANCE REPORT. BALANCE REPORT SHALL INCLUDE: SUPPLY & RETURN AIR FLOWS, ALL STATIC PRESSURES, SUPPLY & RETURN AIR TEMPERATURES AS WELL AS OUTDOOR AIR TEMPS AT TIME OF TEST. CONTRACTOR SHALL BALANCE SUPPLY SIDE TO AIR QUANTITIES INDICATED ON PLANS AND SHALL BALANCE OUTSIDE AIR AND RETURN AIR FLOWS AT THE AIR HANDLER TO AIR QUANTITIES INDICATED IN THE SCHEDULE. PROVIDE NEW AIR FILTERS FOR EACH UNIT.

- 15. PROVIDE 1 YEAR WARRANTY ON ALL EQUIPMENT AND 5 YEAR WARRANTY ON ALL COMPRESSORS.
- 16. ALL INTAKE OPENINGS SHALL BE LOCATED A MINIMUM OF 10'-0" FROM ALL EXHAUST LOCATIONS.
- 17. CONDENSATE DRAIN PIPING SHALL BE SCHEDULE 40 PVC PIPE AND FITTINGS. DRAINS FROM AIR HANDLING UNITS SHALL BE TRAPPED.
- 18. A COMPLETE SYSTEM OF SEISMIC RESTRAINTS SHALL BE DESIGNED BY MASON INDUSTRIES & SEALED BY THEIR REGISTERED ENGR & INSTALLED BY THIS CONTR. AS REQ'D BY APPLICABLE CODES FOR THE LOCALE OF THIS PROJECT.
- 19. ALL MAIN DUCTWORK SHALL BE GALVANIZED SHEET METAL. CONSTRUCT METAL DUCTWORK IN ACCORDANCE WITH SMACNA DUCT CONTRUCTION MANUAL INCLUDING REQUIRED THICKNESS, BRACING, JOINTS AND FITTINGS AS APPLICABLE. ALL METAL DUCT SHALL BE EITHER ASTM A653 GALVANIZED STEEL OR ASTM B209 ALUMINUM. ALL EXHAUST DUCTS SHALL COMPLY WITH SMACNA DUCT CONSTRUCTION STANDARDS FOR PRESSURE CLASS 1"W.G. AND LEAKAGE CLASS 6 CFM/100 S.F.
- 20. THE MECHANICAL CONTRACTOR SHALL PROVIDE LOW VOLTAGE CONTROL LINES. COORDINATE ROUTING AND INSTALLATION WITH THE GENERAL CONTRACTOR.
- 21. ELECTRICAL CONTRACTOR TO PROVIDE ALL HIGH VOLTAGE ELECTRICAL WIRING, CONDUIT, DISCONNECT SWITCHES, FUSES, ECT. ALL FINAL ELECTRICAL CONNECTIONS ARE BY ELECTRICAL
- 22. MECHANICAL CONTRACTOR SHALL VERIFY LOCATION OF ALL PENETRATIONS FOR LOUVERS, AND WALL CAPS WITH ARCHITECT & OWNER PRIOR TO INSTALLATION.
- 23. MECHANICAL CONTRACTOR SHALL PAINT ALL LOUVERS, AND VENT CAPS. CONFIRM COLOR WITH ARCHITECT & OWNER PRIOR TO INSTALLATION.
- 24. ALL CUTTING AND PATCHING OF WALLS FOR MECHANICAL EQUIPMENT SHALL BE THE RESPONSIBILITY OF THE MECHANICAL CONTRACTOR.
- 25. IT SHALL BE RESPONSIBILITY OF THE CONTRACTOR TO ENSURE SHOP DRAWINGS ARE PROVIDED TO THE ARCHITECT AND ENGINEER FOR APPROVAL PRIOR TO PURCHASE OF ANY PIECE OF EQUIPMENT, DUCTWORK OR DEVICE.
- 26. CONTRACTOR SHALL NOTIFY ENGINEER OF RECORD A MINIMUM OF TEN BUSINESS DAYS IN ADVANCE FOR COMPLETION OF FIELD INSPECTION FOR APPENDIX 5 OF THE 2018 INTERNATIONAL ENERGY CODE, IF ENFORCED.

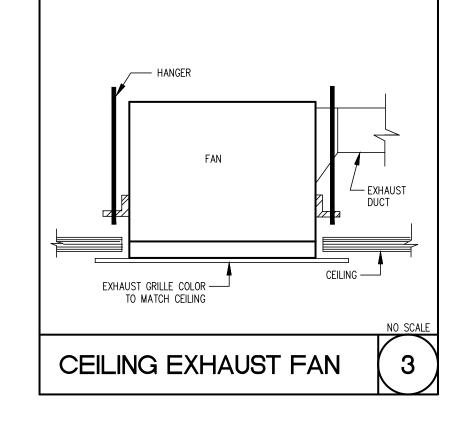

MECHANICAL KEYED NOTES

- (1) FAN MFR. WALL CAP.
- 2 HEATER SHALL BE MOUNTED MINIMUM 10' AFF. COORDINATE LOCATION OF HEATER WITH TAKE 5 REPRESENTATIVE.
- 3 12"x12" RUSKIN ELB375 OUTSIDE AIR INTAKE LOUVER WITH BACKDRAFT DAMPER AND EXTERIOR WALL TRIM.
- 4 FIELD COORDINATE EXACT LOCATION OF FAN WITH ARCHITECTURAL ELEVATIONS.
- (5) LITTLE GIANT CONDENSATE PUMP MODEL VCMA-20, 120V-1ø, ¹/₆ HP, 14 GPM@ 15'. MTD. HIGH ON WALL.
- 6 ROUTE CONDENSATE DOWN IN WALL AND SPILL OUT TO MOP

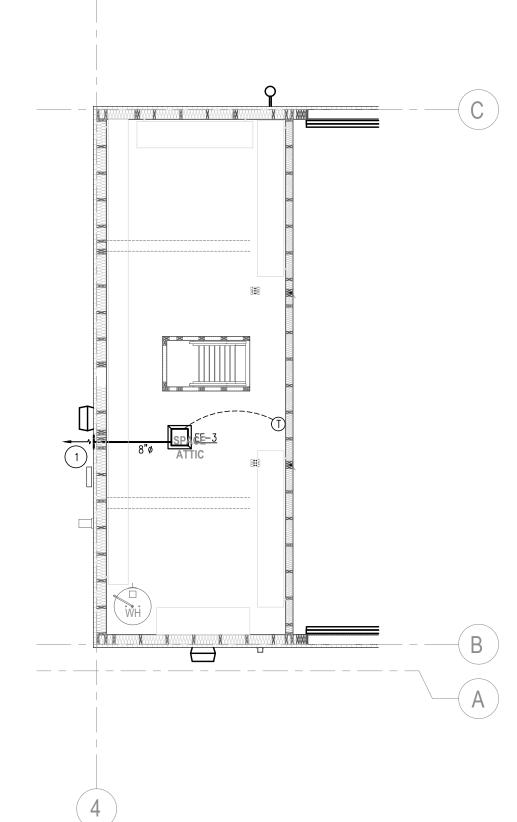

MECHANICAL ATTIC PLAN M1.01 SCALE: 1/4" = 1'-0"

80 Posse Ground Rd Sedona, AZ 86336

Suite 2100

United States

Charlotte, NC 28280

ASSOCIATES

consulting engineers

1307 W. Morehead Street

Telephone 980.999.6122

Structural Engineer

Charlotte, NC 28208

MEP Engineer 2905-D Queen City Dr.

Charlotte, NC 28208

Telephone 704.399.3943


△ Date Description

7/29/2021 ISSUE FOR CONSTRUCTION

Suite 205

Tel 704.377.2725

Fax 704.377.2807

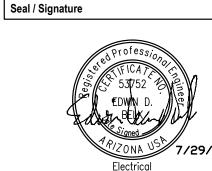

Project Name

Take 5 Oil Change

Project Number

59.6678.001

Description MECHANICAL NOTES, DETAILS,

SCHEDULES AND FLOOR PLANS

Scale


As indicated





M1.01


	LIGHT FIXTURE SCHEDULE											
TYPE	MANUFACTURER	CATALOG NUMBER	DESCRIPTION	B.U.G RATING	BALLAST / DRIVER	LAMPS / LUMENS	VOLTS	WATTS				
SA	COOPER LIGHTING	PRV-PA1B-730-U-T3-BK-HSS	POLE MOUNTED LED FIXTURE. BLACK FINISH. WET LOCATION LISTED. TYPE III WIDE DISTRIBUTION. 25'-0" STEEL POLE. HOUSE SIDE SHIELD.	B2-UO-G3	ELECTRONIC	LED 3000K	120	74				
С	KICHLER	11310BKTLED	UP/DOWN LIGHTING WALL SCONCE, WET LOCATION RATED. PROVIDE WITH 1 #9536AZ LENS EACH FIXTURE	ELECTRONIC	LED 3000K 925 LUMENS	120/277	120	20.1				
OA	LUMARK	LDWP-FC-3B-ED-7030	LED WALL PACK, DIE CAST ALLUMINUM HOUSING, BLACK FINISH, BOROSILICATE PRISMATIC GLASS, WET LOCATION LABEL.	B1-U0-G1	ELECTRONIC	LED 3000K 3,137LUMENS	120	47				

Calculation Summary							
Label	CalcType	Units	Avg	Max	Min	Avg/Min	Max/Min
PARKING	Illuminance	Fc	1.34	2.0	0.4	3.35	5.00
PROPERTY LINE	Illuminance	Fc	0.18	0.6	0.0	N.A.	N.A.

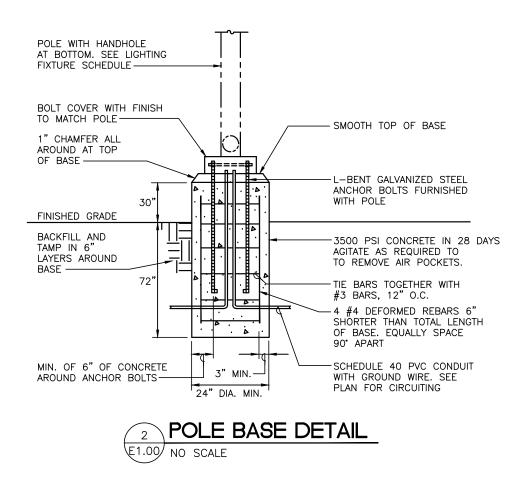

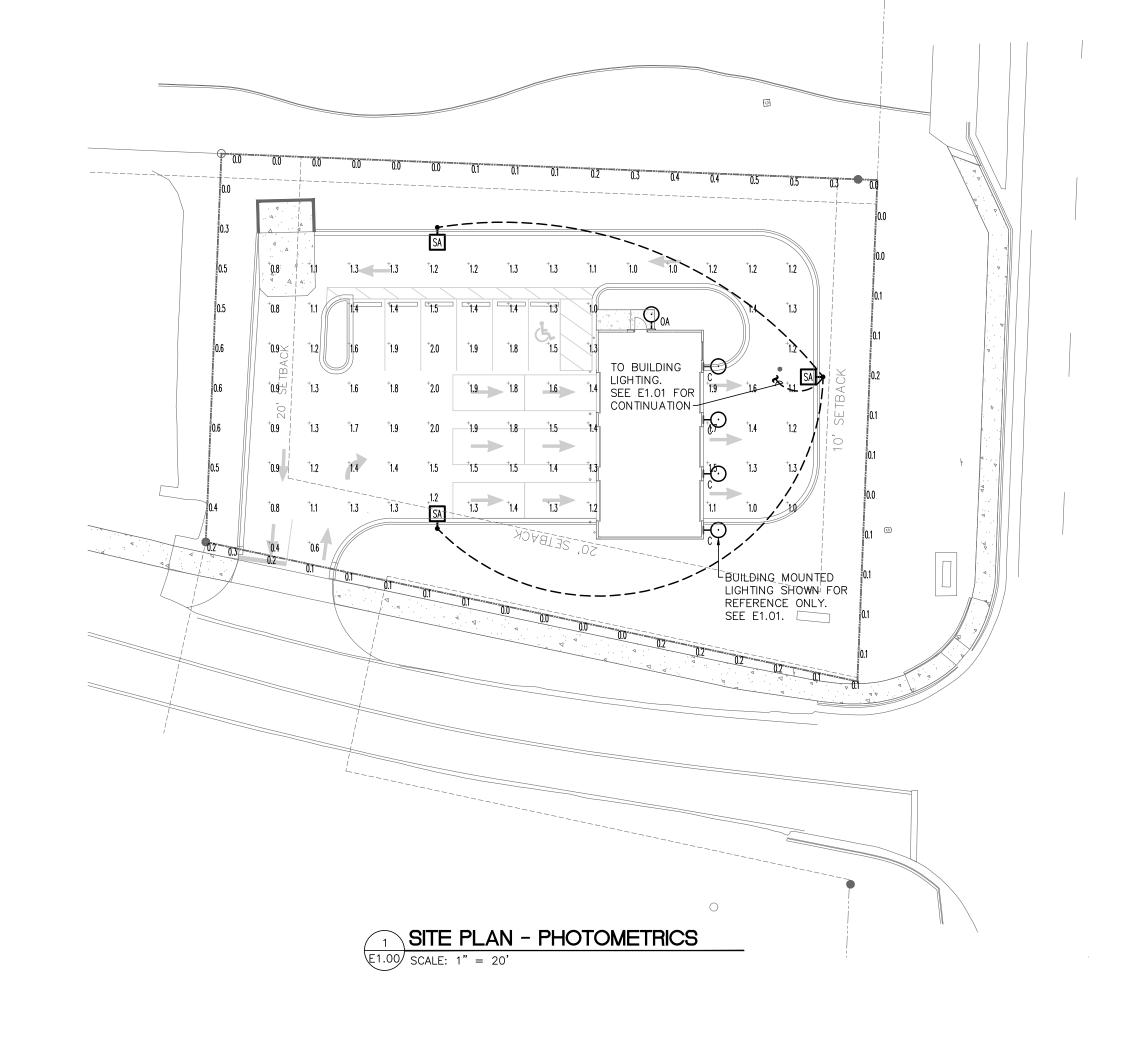

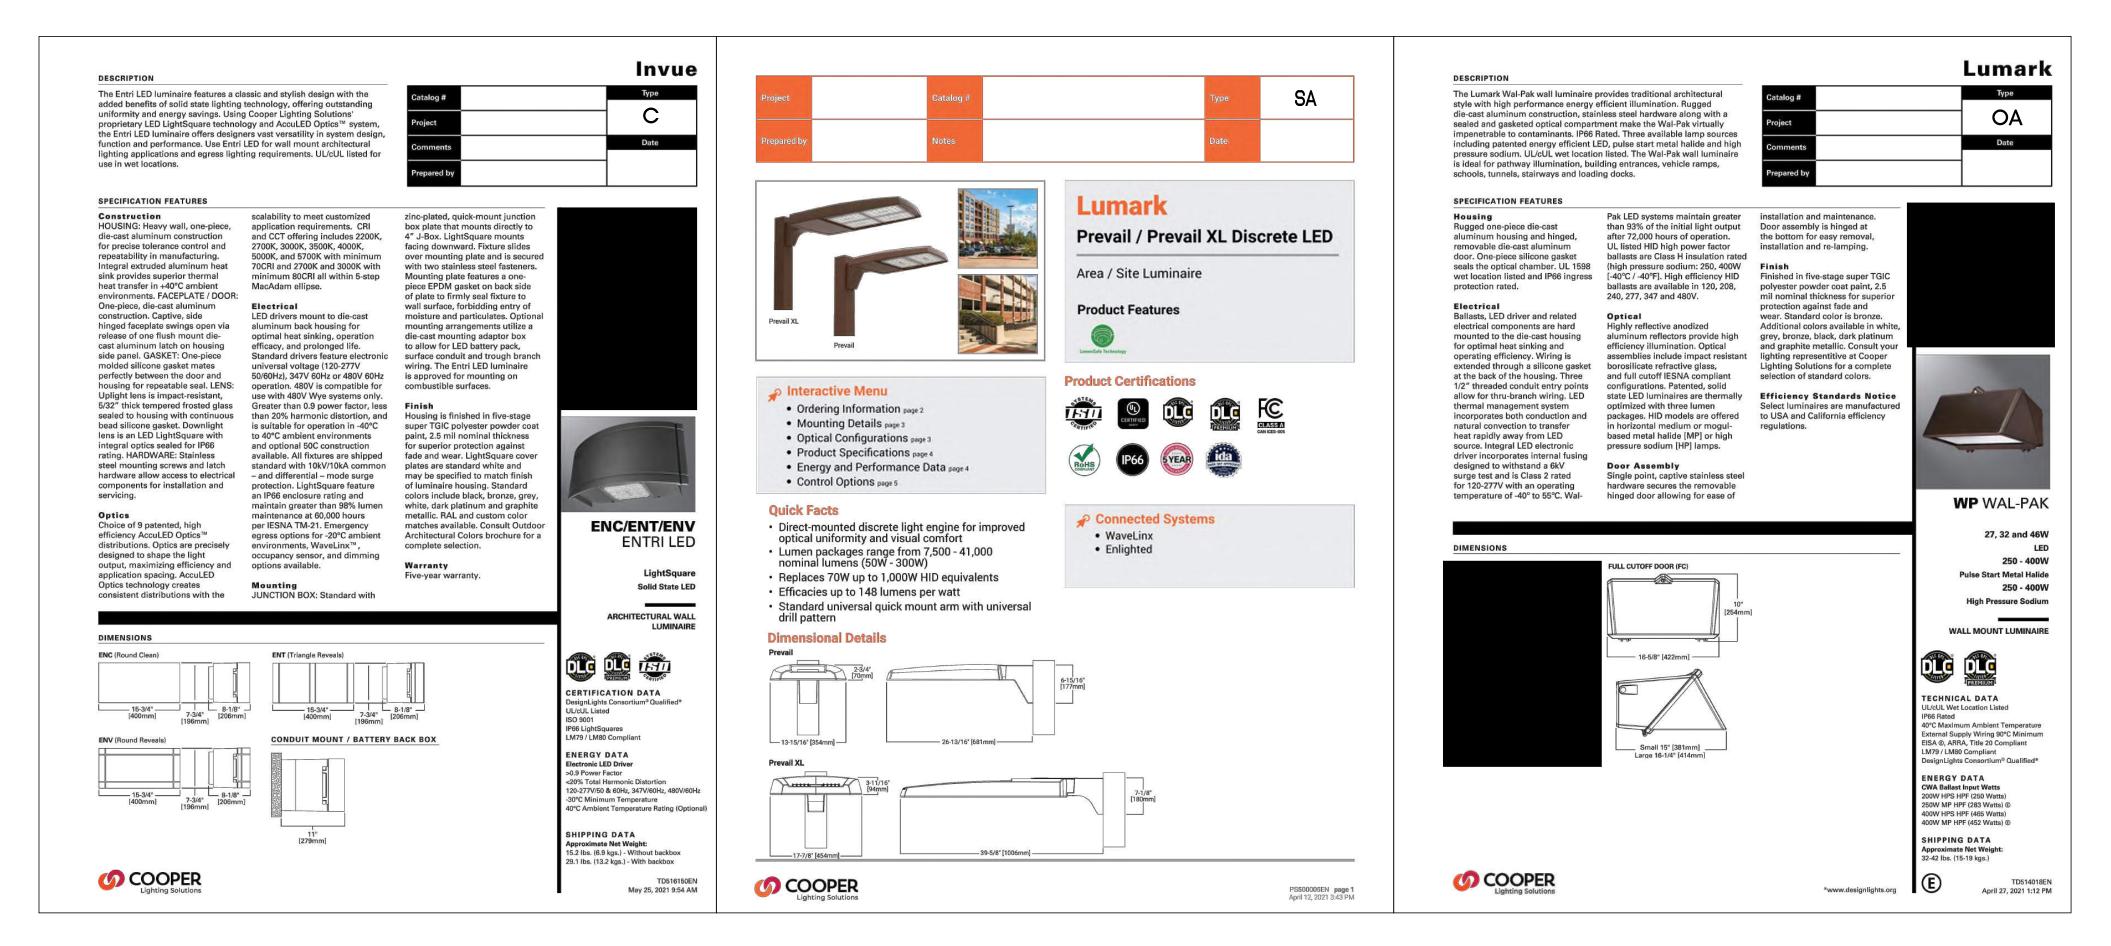


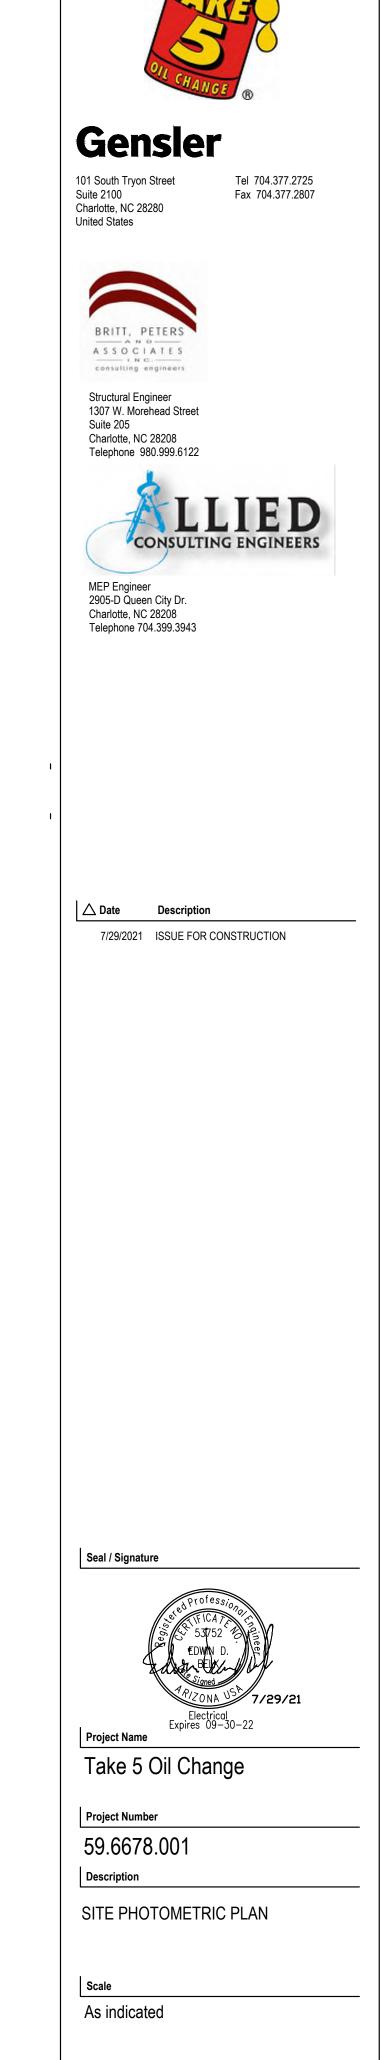



80 Posse Ground Rd. Sedona, AZ 86336

Take 5 Oil Change

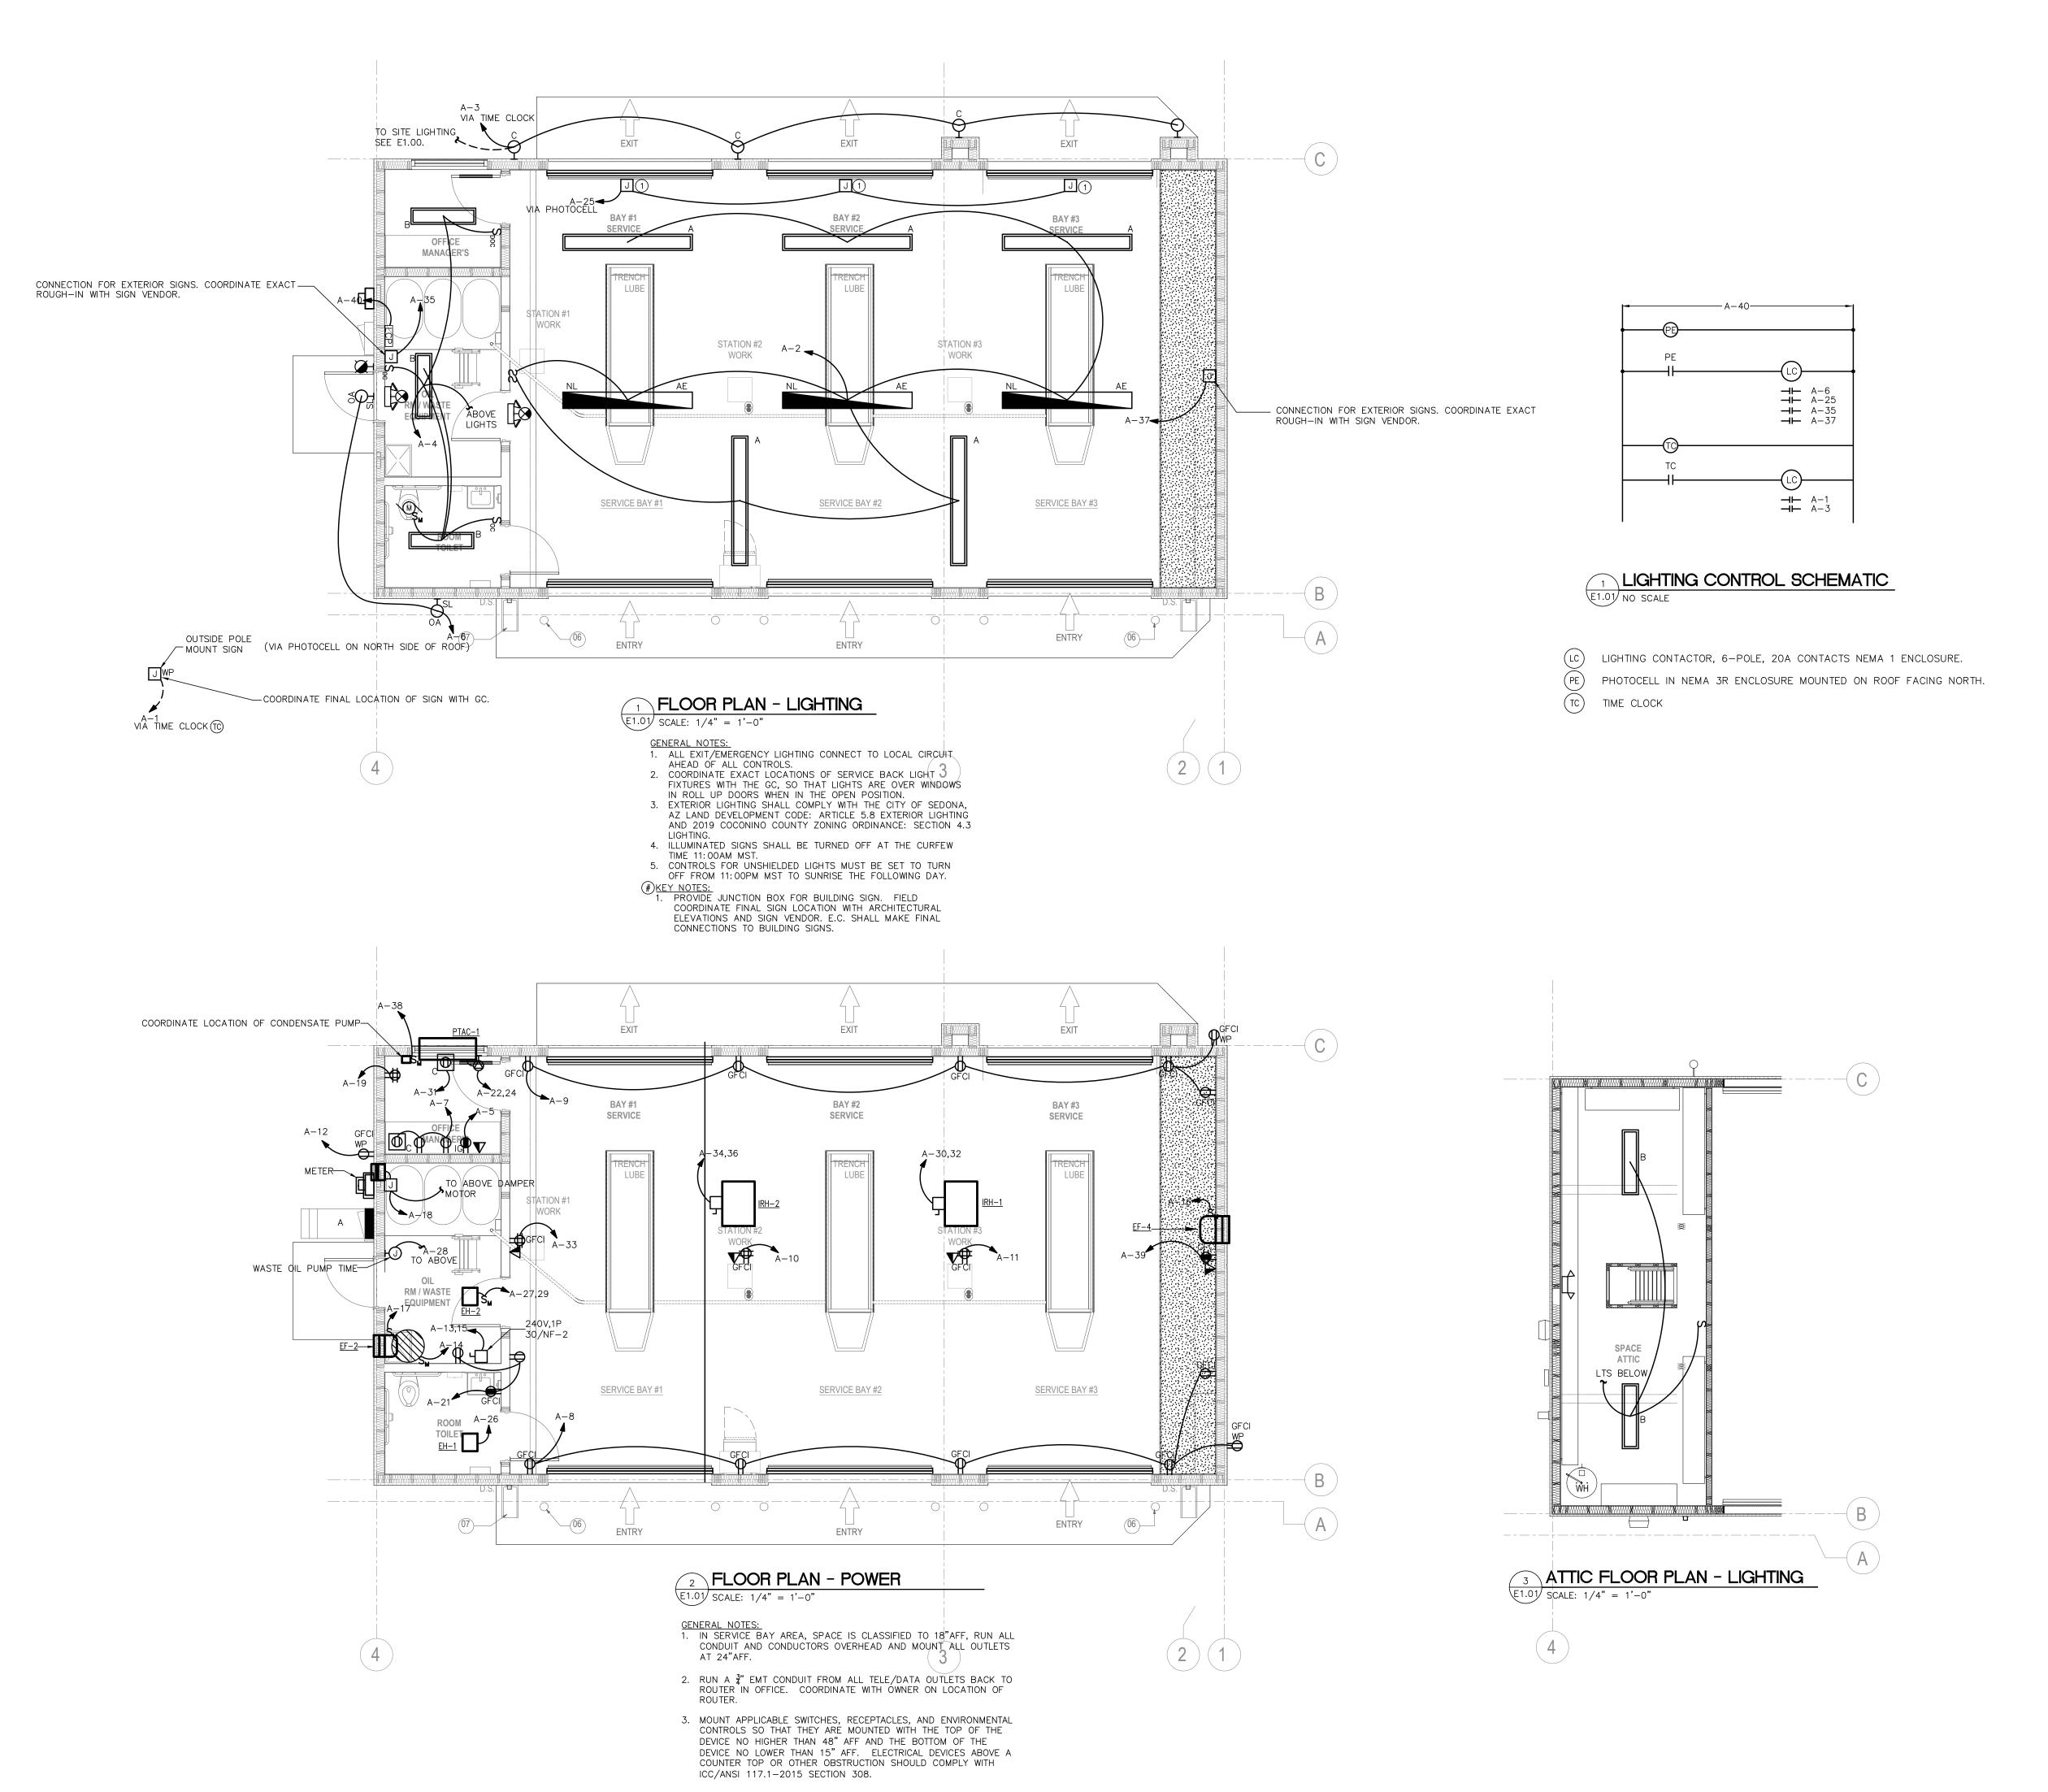


Take 5 Oil Change 80 Posse Ground Rd. Sedona, AZ 86336



Gensler

Suite 2100 Charlotte, NC 28280 United States

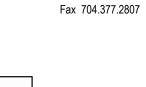

Tel 704.377.2725



Structural Engineer 1307 W. Morehead Street Suite 205 Charlotte, NC 28208 Telephone 980.999.6122



MEP Engineer 2905-D Queen City Dr. Charlotte, NC 28208 Telephone 704.399.3943

△ Date Description

7/29/2021 ISSUE FOR CONSTRUCTION

Seal / Signature



Project Name Take 5 Oil Change

Project Number

59.6678.001 Description


FLOOR PLAN - ELECTRICAL


Scale As indicated

E1.01

						PANE	1:	Α									BY:	AKN		S	HEET:	1	
	120/240	Ô	VOLTS, 1	Ø	3	WIRE		,	TYP€	LQAI	CENTE	₹	AIC: 10,0	00			JOB#	21155			QF:	1	
	ŞUF	RFACE	MOUNTED,			200) AMF	MAIN	ÇIRÇ	JUIT B	REAKE	7	١	EUTRA L	AMP\$	200	CHECH	KED BY:	EDB		DATE	10/28	3/2021
	K	/A				REVIA	RKS C	R EQUIPN	MENTS	SERV E	Ð			K	/A				k	VΑ.			
_								WRE SIZ				,			· · ·	_		ω	Ø		z		
LOAD								TRIPAME	-							LOAD	LIGHTS	RECEPTS	MOTORS	4	KITCHEN	OTHER	SPARE
7	Α	В					·	RAMES						Α	В	7	₫		5	HEAT	2	Ė	Ϋ́
							'	CIRCUIT N	O. "]									oc	≥		×	Ŭ	0,
0	1.2		POLE SIGN	12	20	1	1		2	1	20	12	SERVICE BAY LIGHTS	0.5		L	0.5					1.2	
L		0.6	EXTERIOR LIGHTS	12	20	1	3		4	1	20	12	OFFICE LIGHTS		0.1	L	0.7	,	M			y	*
R	10		COMPUTER RECEPT	12	20	1	5		6	1	20	12	OUTSIDE LIGHTS	0.2		L	0.2	10					
R		0.5	OFFICE RECEPTS	12	20	1	7		8	1	20	12	SERVICE BAY RECEPTS		1.1	R	7	16		•	•	7	7
R	11		SERVICE BAY RECEPTS	12	20	1	9		10	1	20	12	WORK STATION	0.4		R	1	15					
R		0.4	WORK STATION	12	20	1	11		12	1	20	12	SERVICE RECEPT		0.2	R	7	0.6		•	•	7	7
M	1.4		- AIR COMPRESSOR	10	30	2	13		14	1	20	12	WH-1	1.5	<u> </u>	Н	ļ		1.4	1.5			
M		1.4	- AIR COMPRESSOR	10	30	2	15		16	1	20		SPARE				Y	,	1.4	,		,	•
M	0.2		EF -2	12	20	1	17		18	1	20		SPARE						0.2				
R	I	0.4	DATA RACK	12	20	1	19		20	. 2	20	45	PTAC		1.8	Н		0.4	,	1.8			
R	0.6		BATHROOM RECEPT	12	20	1	21		22		20	12	PIAC	1.8		Н		0.6		1.8			
			SPARE	12	20	1	23		24	1	20		SPARE				7	7 1	_	•	•	•	7
L	10		BUILDING SIGNAGE	12	20	1	25		26	1	20	12	E+1	0.8		Н	1.0			8.0			
Н		0.8	EH-2	12	20	2	27		28	1	20	12	WASTE OIL PUMPTIMER		0.5	Ö		,		0.8		0.5	-
Н	0.8		U FZ	12	20	_	29		30	2	30	10	IRH-1	2.3		Н				3.0			
R		0.8	OFFICE SIGN	12	20	1	31		32		30	10	INFI		2.3	н		0.8		2.3		7	
L	04		WORK STATION	12	20	1	33		34	2	30	10	IRH-2	2.3		Н	0.4			2.3			
L		1.0	BUILDING SIGNAGE	12	20	1	35		36				11172		2.3	Н	1.0	7		2.3	7	7	7
L	1.0		BUILDNG SIGNAGE	12	20	1	37		38	1	20	12	CONDENSATE PUMP	0.5		M	1.0		0.5				
R		0.4	WORK STATION	12	20	1	39		40	1	20	12	LCP		1.0	0		0.4				1.0	
			SPACE ONLY			1	41		42	1			SPACE ONLY										
	8.7	6.3					5	SUBTOTA	LS					10.1	9.2								
												TOTAL	.\$	18 7	15.5		4.8	69	3.5	16.3		2.7	
OAD			KVA CONNEC		D.F		KVA	NET	_														
GHT			. 48		1.25			60	1	CALC	ZULATIO	INS:	35 4		- /	0 240	147	7.5 A	125%		184	A	
	PTACLE		69		1.00			69	1														
	PTACLE	3 5	0.0		0.50			00	4	NOTE													
ОТС			3.5		1.00	,		3.5	1	PANE	1 IS SE	RATE	D										
	EST MC	OTOR	0.0		1.75			0.0															
EAT			16.3		1.00			16.3															
ITCH			0.0		0.65			0.0	1														
THE			2.7		1.00			2.7	4														
PAR			00		1.00			00	1														
OTA	L		34.2					35.4	1														


TYPE	MANUFACTURER	CATALOG NUMBER	DESCRIPTION	B.U.G RATING	BALLAST / DRIVER	LAMPS / LUMENS	VOLTS	WATTS
Α	METALUX	8VT2-LD5-9-DR-UNV-L840-CD1-U	8' INDUSTRIAL LED LAMP VAPORTITE INDUSTRIAL REFRIGERATED CASE FIXTURE. CHAIN HUNG OPTION	NA	ELECTRONIC	LED 4000K 9054 LUMENS	120/277	66
AE	METALUX	8VT2-LD5-9-DR-UNV-VT-REM-EL-L840- CD1-U	8' INDUSTRIAL LED LAMP VAPORTITE INDUSTRIAL REFRIGERATED CASE FIXTURE. CHAIN HUNG OPTION. REMOTE EMERGENCY ENCLOSURE	NA	ELECTRONIC	LED 4000K 9054 LUMENS	120/277	66
В	LITHONIA	RTLA-30L-GZ10-LP840	1'X4' LED VOLUMETRIC SURFACE MOUNT FIXTURE	NA	ELECTRONIC	LED 4000K 3224LUMENS	120/277	26.6
BE	LITHONIA	RTLA-30L-GZ10-EL14L-LP840	1'X4' LED VOLUMETRIC SURFACE MOUNT FIXTURE WITH BATTERY BACKUP	NA	ELECTRONIC	LED 4000K 3224LUMENS	120/277	26.6
С	IN∀UE	ENV-SA1A-740-1-T3-BK-HSS	DOWN LIGHTING WALL SCONCE, WET LOCATION RATED.	B0-U0-G0	ELECTRONIC	LED 4000K 1544 LUMENS	120/277	20.1
OA	LUMARK	LDWP-FC-6B-ED-7040	LED WALL PACK, DIE CAST ALLUMINUM HOUSING, BLACK FINISH, BOROSILICATE PRISMATIC GLASS, WET LOCATION LABEL.	B1-U0-G1	ELECTRONIC	LED 4000K 3,137LUMENS	120/277	47
EX	LIGHT ALARMS	QLXN500-RN	WALL MOUNTED LED EXIT LIGHT WITH POLYCARBONATE HOUSING WITH SELF CONTAINED POWERPACK FOR 90 MIN. OPERATION. LEAD CALCIUM BATTERY.			LED	120/277	2.5
EM	LIGHT ALARMS	LCA-2LEDR	WALL MOUNTED EMERG LED LIGHT WITH POLYCARBONATE HOUSING WITH SELF CONTAINED POWERPACK FOR 90 MIN. OPERATION, LEAD CALCIUM			DOUBLE LED	120/277	4.9
EM EXT	LIGHT ALARMS	UQLXN500-R-2LED-R	WALL MOUNTED COMBO EMERG/EXIT LED LIGHT WITH POLYCARBONATE HOUSING WITH SELF CONTAINED POWERPACK FOR 90 MIN. OPERATION.			LED FOR FACE,	120/277	4.9
EXT	LIGHT ALARMS	ELF652D/LED-WP	REMOTE HEAD FEED FROM COMBO			DOUBLE LED	120/277	4.9

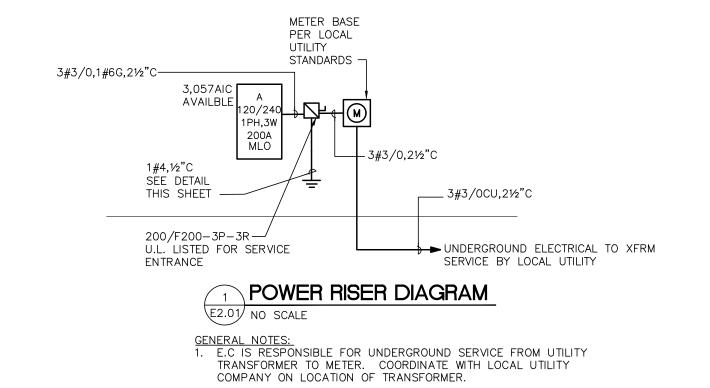

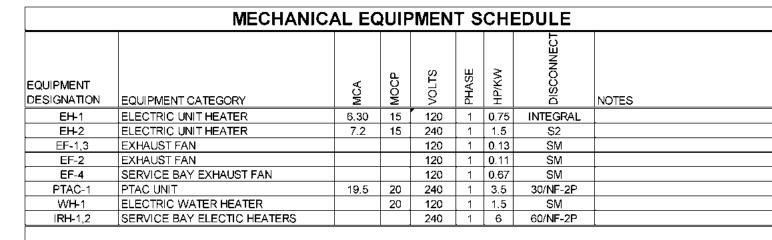

1. THE ELECTRICAL CONTRACTOR SHALL PROVIDE AND INSTALL AS REQUIRED ALL DISCONNECT SWITCHES, RECEPTACLES, ETC. TO MECHANICAL/PLUMBING EQUIPMENT. THE ELECTRICAL CONTRACTOR SHALL ALSO PROVIDE ALL CORDS, PLUGS, CABLES, ETC., ON EQUIPMENT REQUIRING SUCH ITEMS.

2. THE ELECTRICAL CONTRACTOR SHALL PROVIDE FINAL CONNECTIONS TO ALL MECHANICAL/PLUMBING EQUIPMENT AS REQUIRED.

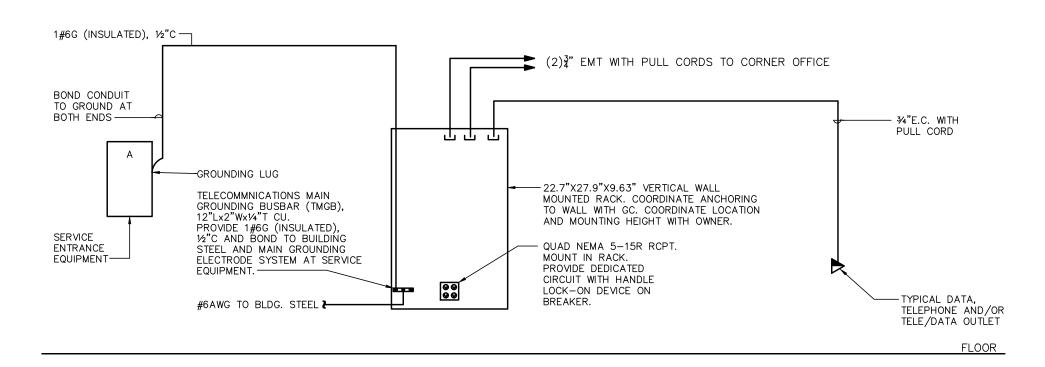


TELE/DATA RISER DIAGRAM NOTES:

1. FLOOR PLANS INDICATE THE EXACT QUANTITY AND LOCATION OF ALL TELEPHONE AND/OR DATA OUTLETS.

2. ALL TELEPHONE AND/OR DATA WIRING AND EQUIPMENT SHALL BE PROVIDED BY THE OWNER'S TELE/DATA SUPPLIER.

TELEPHONE RISER DIAGRAM

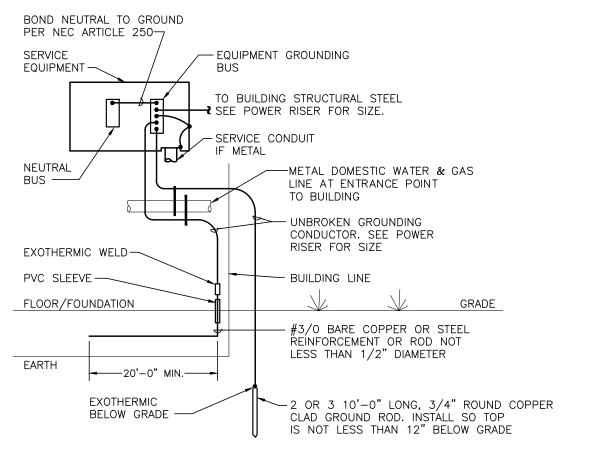

RESISTANCE TO GROUND SHALL BE LESS THAN 25 OHMS

SERVICE GROUNDING DETAIL E2.01 NO SCALE

Take 5 Oil Change

80 Posse Ground Rd. Sedona, AZ 86336



Tel 704.377.2725

Fax 704.377.2807

Gensler

Suite 2100 Charlotte, NC 28280 United States



Structural Engineer 1307 W. Morehead Street Suite 205 Charlotte, NC 28208 Telephone 980.999.6122



MEP Engineer 2905-D Queen City Dr. Charlotte, NC 28208 Telephone 704.399.3943

△ Date Description 7/29/2021 ISSUE FOR CONSTRUCTION

Seal / Signature



Project Name Take 5 Oil Change

Project Number

59.6678.001

Description

PANEL SCHEDULES AND RISER DIAGRAM

Scale

As indicated

E2.01