

CONTEXT PLAN

Designed by:

Drawn by:

Checked by:

27 December 2021

GLA PROJECT NO. 20109

Project Code:

scale: 1" = 80'

north





PROJECT INFORMATION:

PARCELS: 401-16-100 & 401-16-071

ADDRESS: 430 & 460 FOREST ROAD, SEDONA, ARIZONA 86336

NAVAHOPI RD

ZONING: M-3 MIXED USE


NOTICE OF EXTENDED PAYMENT PROVISION (PER ARS 32-1129.01) THIS CONTRACT ALLOWS THE OWNER TO MAKE PAYMENT WITHIN 15 DAYS AFTER CERTIFICATION AND APPROVALS OF BILLINGS AND ESTIMATES FOR PROGRESS PAYMENTS, WITHIN 15 DAYS AFTER CERTIFICATION AND APPROVALS OF BILLINGS AND ESTIMATES FOR RELEASE OF RETENTION AND WITHIN 15 DAYS AFTER CERTIFICATION AND APPROVAL OF BILLINGS AND ESTIMATES FOR FINAL PAYMENT.

Revisions



gabor lorant architects

3326 n. 3rd avenue suite 200 phoenix, arizona 85013 tel: 602.667.9090 gaborlorant.com

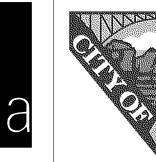



928-204-7111

Uptown Sedona Parking Facility Design Development Context Plan | Vicinity Map


IF NOT ONE INCH ON THIS SHEET, ADJUST SCALES ACCORDINGLY SHEET ID a000

VERIFY SCALES
BAR IS ONE INCH ON
ORIGINAL DRAWING

SHEET NO. OF



SYMBOL LEGEND

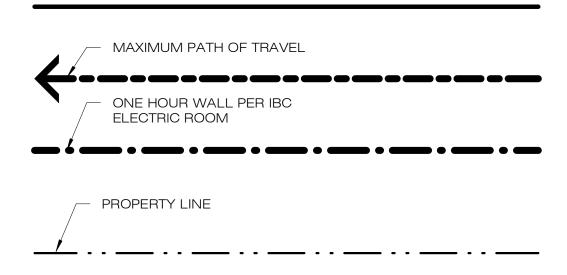

PARKING COUNTS

BASEMENT LEVEL 97 SPACES

GROUND LEVEL 74 SPACES 7 ACC. SPACES


UPPER LEVEL 97 SPACES


TOTAL SPACES: 275


PARKING NOTES:


EACH ACCESSIBLE PARKING SPACE SHALL COMPRISE RECTANGULAR AREAS NOT LESS THAN 11 FEET WIDE BY 18 FEET LONG WITH A 5-FOOT MINIMUM WIDTH ACCESS AISLE ON ITS RIGHT SIDE (EXCEPT IN LAYOUTS WHEREIN 2 ACCESSIBLE PARKING SPACES SHARE A SINGLE 5-FOOT-WIDE ACCESS AISLE.

EACH ACCESS AISLE SHALL LEAD DIRECTLY TO AN ACCESSIBLE ROUTE OF TRAVEL.

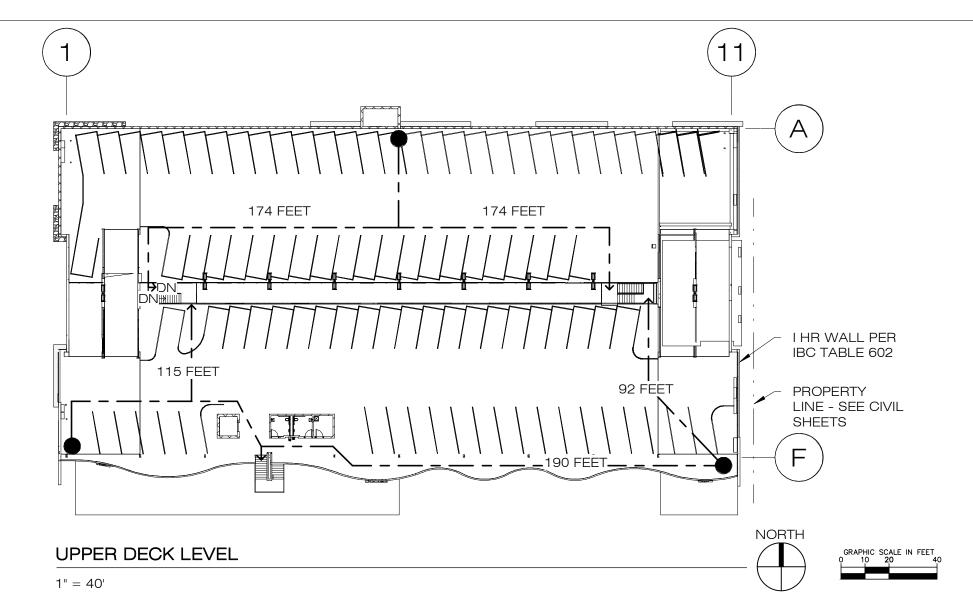

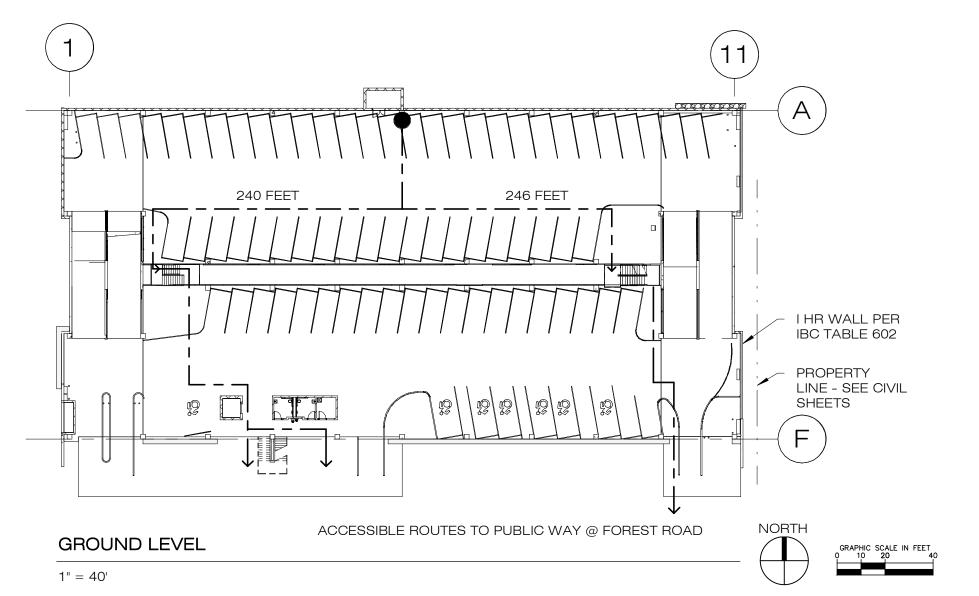

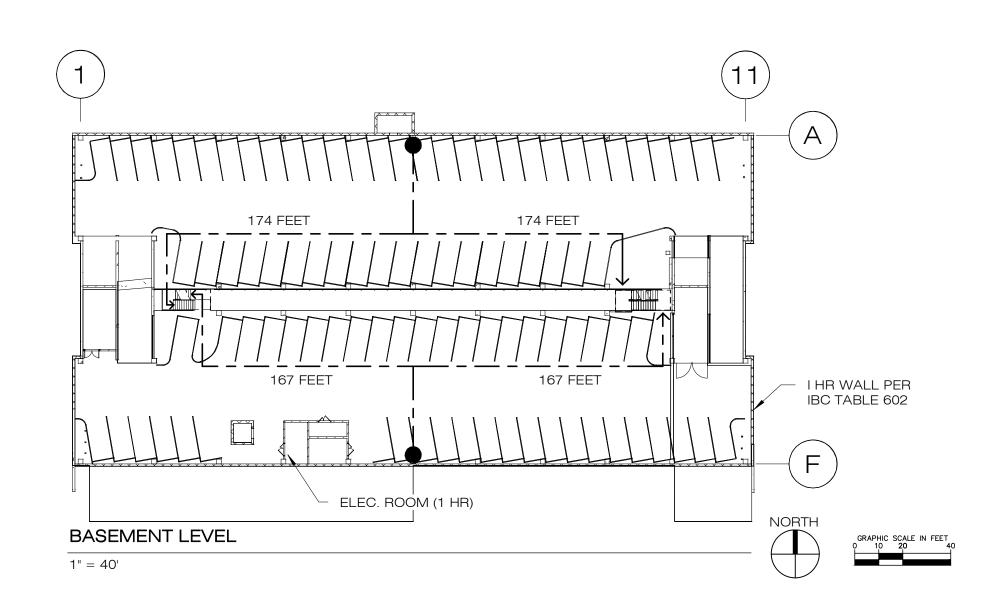

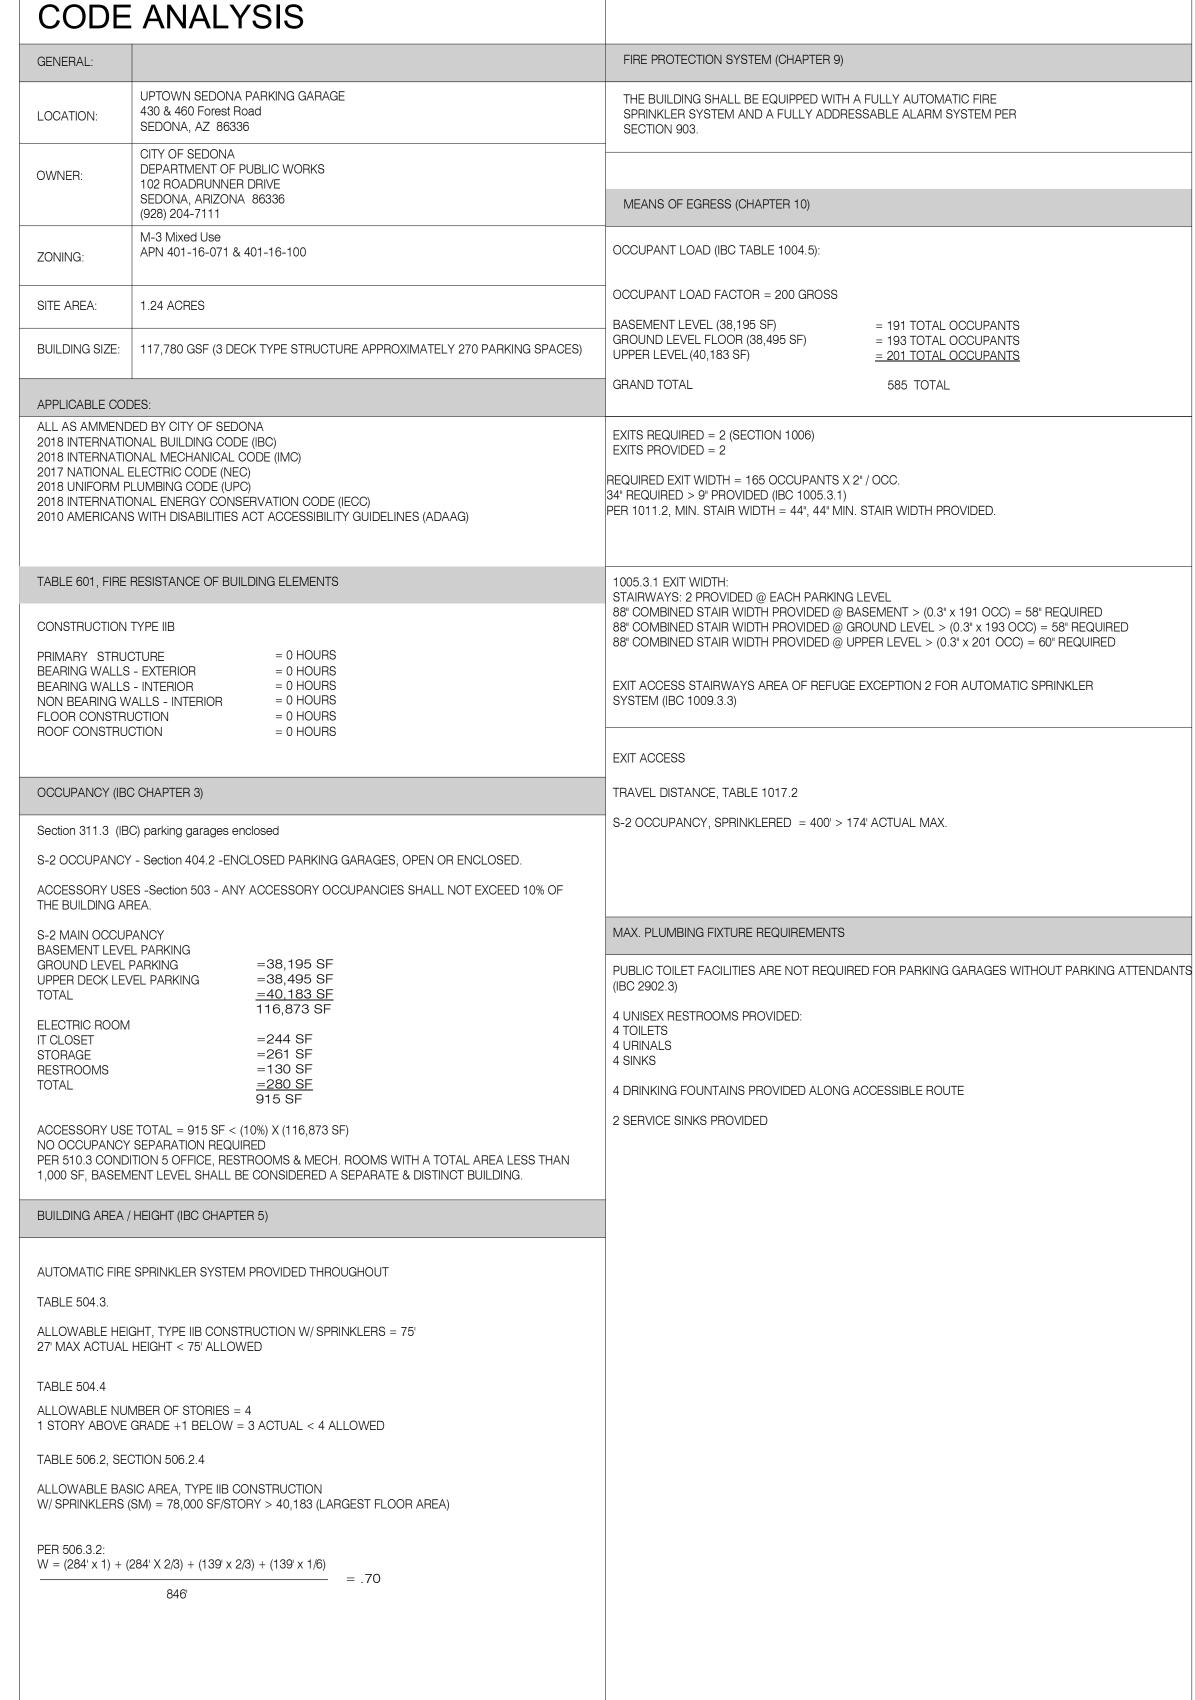

NOTICE OF EXTENDED PAYMENT PROVISION

(PER ARS 32-1129.01) THIS CONTRACT ALLOWS THE OWNER TO MAKE PAYMENT WITHIN 15 DAYS AFTER CERTIFICATION AND APPROVALS OF BILLINGS AND ESTIMATES FOR PROGRESS PAYMENTS, WITHIN 15 DAYS AFTER CERTIFICATION AND APPROVALS OF BILLINGS AND ESTIMATES FOR RELEASE OF RETENTION AND WITHIN 15 DAYS AFTER CERTIFICATION AND APPROVAL OF BILLINGS AND ESTIMATES FOR FINAL PAYMENT.

Revisions

Symbol



Appr.

Designed by:

Drawn by:

Checked by:

RGH

27 December 2021 Project Code:

GLA PROJECT NO. 20109

gabor lorant architects

tel: 602.667.9090 fax: 602.667.9133 gaborlorant.com





928-204-7111

CITY OF SEDONA
PUBLIC WORKS DEPARTMENT **102 ROADRUNNER DRIVE**

Uptown Sedona Parking Facility Design Development

SHEET ID a001

VERIFY SCALES 0

BAR IS ONE INCH ON

ORIGINAL DRAWING

SHEET NO. OF

IF NOT ONE INCH ON


THIS SHEET, ADJUST


SCALES ACCORDINGLY

3326 n. 3rd avenue suite 200 phoenix, arizona 85013

SEDONA, ARIZONA 86336

Occupancy & Code Analysis

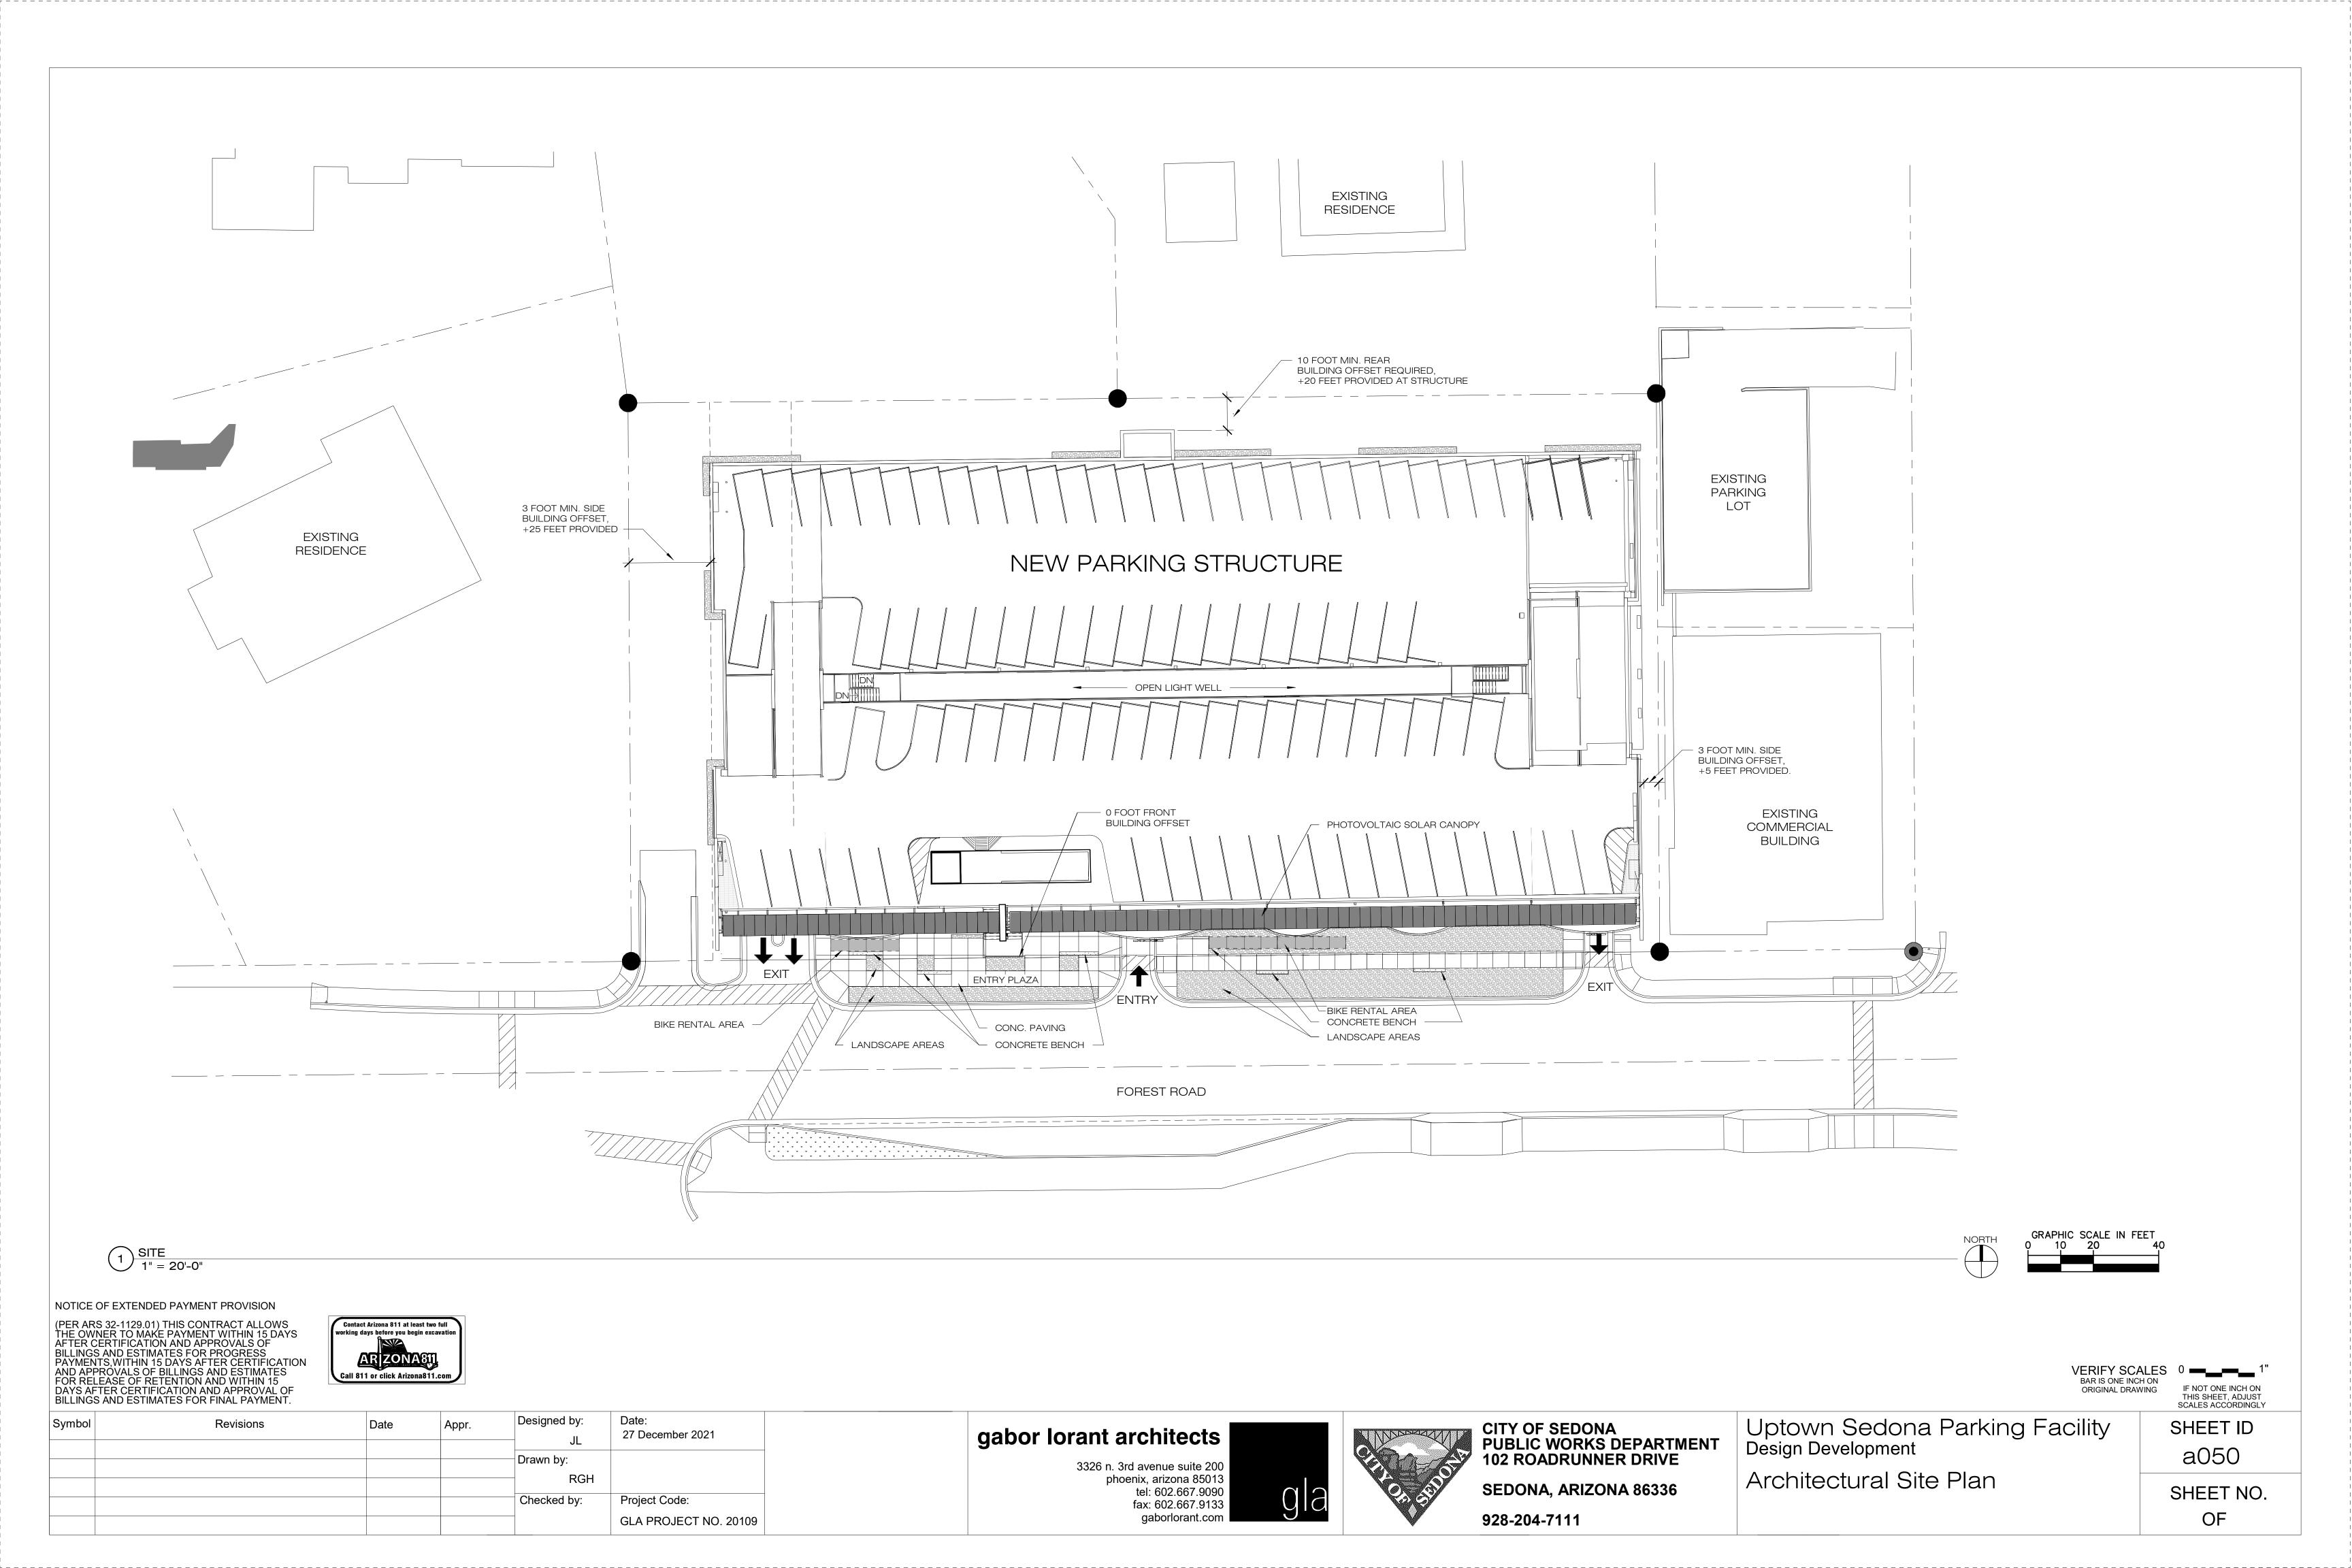

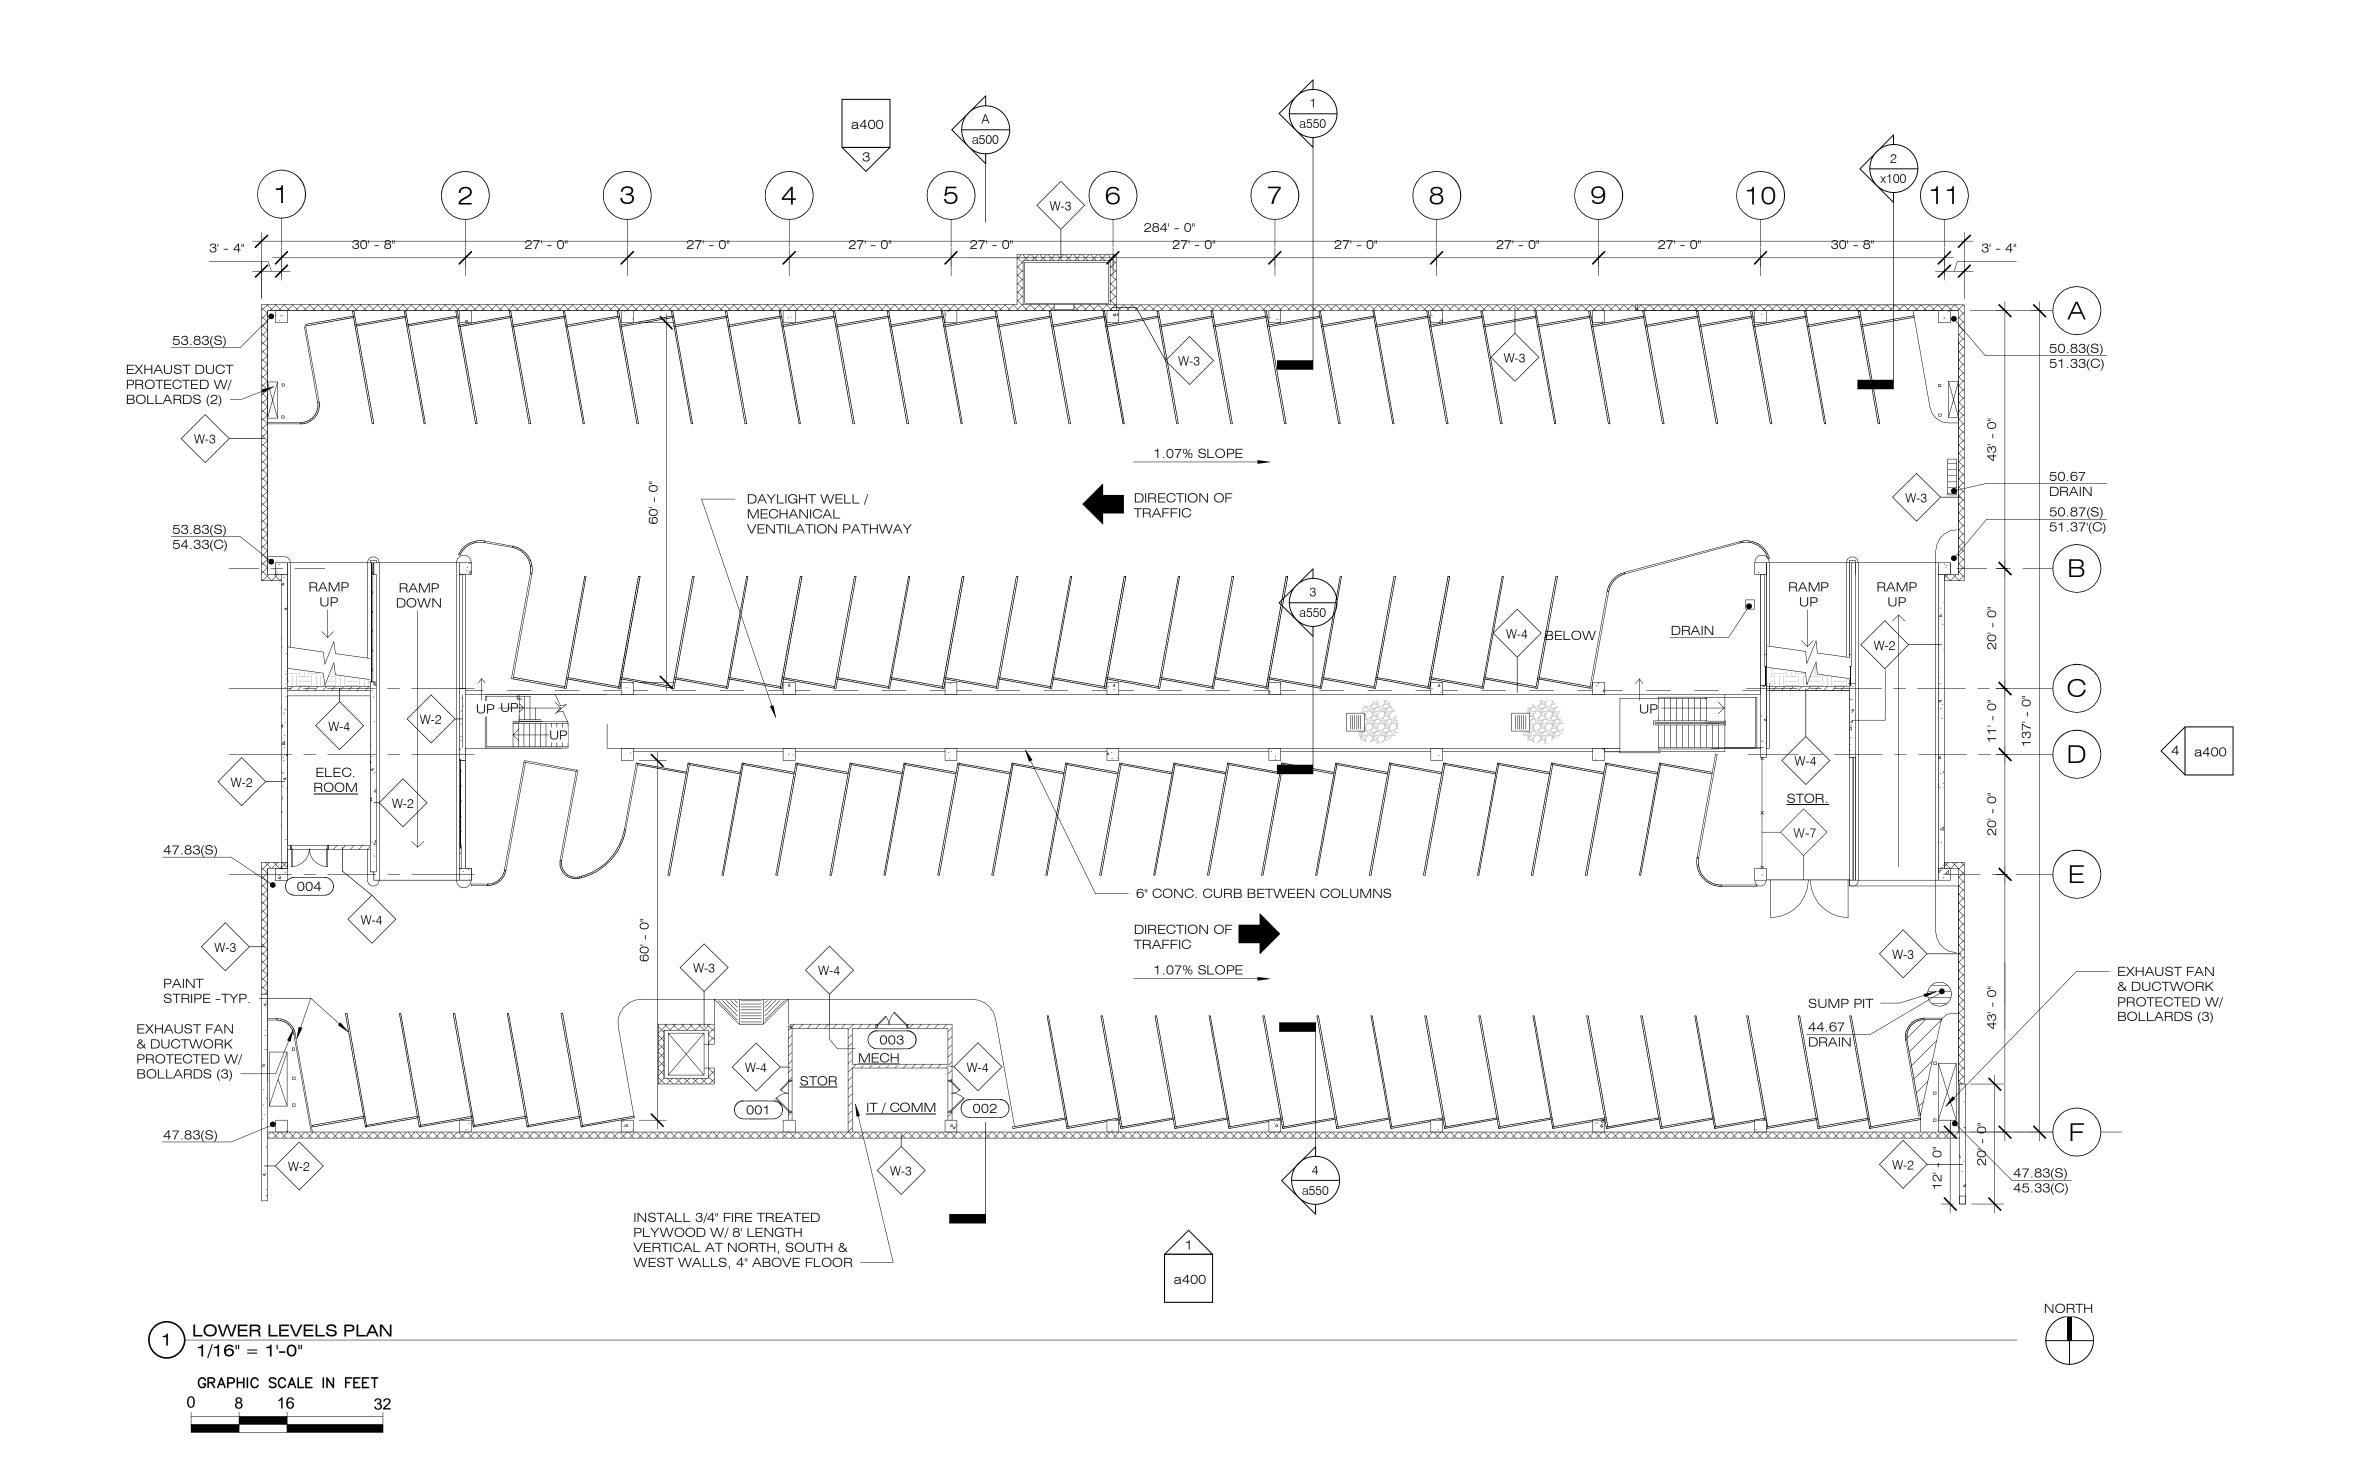

PARKING COUNTS BASEMENT LEVEL 94 SPACES **GROUND LEVEL** 72 SPACES 7 ACC. SPACES UPPER LEVEL 95 SPACES TOTAL SPACES: 268

WALL DESCRIPTION TYPE 8" CONCRETE WALL, REINFORCE PER STRUCTURAL DOCUMENTS (W-1) 12" CONCRETE WALL, REINFORCE PER STRUCTURAL DOCUMENTS $\langle W-2 \rangle$ 12x8x16 CONCRETE MASONRY UNITS, GROUT CELLS W/ REINFORCING PER | W-3 | STRUCTURAL DOCUMENTS. 8x8x16 CONCRETE MASONRY UNITS, GROUT CELLS W/ REINFORCING PER W-4 STRUCTURAL DOCUMENTS. PLUMBING WALL, 5/8" CEMENT BOARD ON 3-5/8" METAL STUDS AT 16" O.C. W-5 PROVIDE WALL TILE FINISH. CORRUGATED CORTEN PANELS OVER STEEL TUBE FRAME. (W-6) W-7 WIRE MESH FENCING & GATES OVER STEEL TUBE FRAMING.

VERIFY SCALES 0 - 1" BAR IS ONE INCH ON ORIGINAL DRAWING

IF NOT ONE INCH ON THIS SHEET, ADJUST SCALES ACCORDINGLY SHEET ID

NOTICE OF EXTENDED PAYMENT PROVISION (PER ARS 32-1129.01) THIS CONTRACT ALLOWS
THE OWNER TO MAKE PAYMENT WITHIN 15 DAYS
AFTER CERTIFICATION AND APPROVALS OF Contact Arizona 811 at least two full working days before you begin excavati BILLINGS AND ESTIMATES FOR PROGRESS
PAYMENTS, WITHIN 15 DAYS AFTER CERTIFICATION
AND APPROVALS OF BILLINGS AND ESTIMATES
FOR RELEASE OF RETENTION AND WITHIN 15
DAYS AFTER CERTIFICATION AND APPROVAL OF
BILLINGS AND ESTIMATES FOR FINAL PAYMENT. AR ZONA811

Revisions

Symbol



Appr.

Designed by:

Drawn by:

Checked by:

RGH

27 December 2021

Project Code:

GLA PROJECT NO. 20109

| gabor lorant architects |
|--|
| 3326 n. 3rd avenue suite 200 phoenix, arizona 85013 |
| , |

tel: 602.667.9090 fax: 602.667.9133 gaborlorant.com




| CITY OF SEDONA PUBLIC WORKS DEPARTMENT 102 ROADRUNNER DRIVE |
|---|
| SEDONA, ARIZONA 86336 |

928-204-7111

| Uptown Sedona Parking Facility |
|--------------------------------|
| Design Development |

Lower Levels Plan

| a100 |
|-----------|
| SHEET NO. |
| OF |

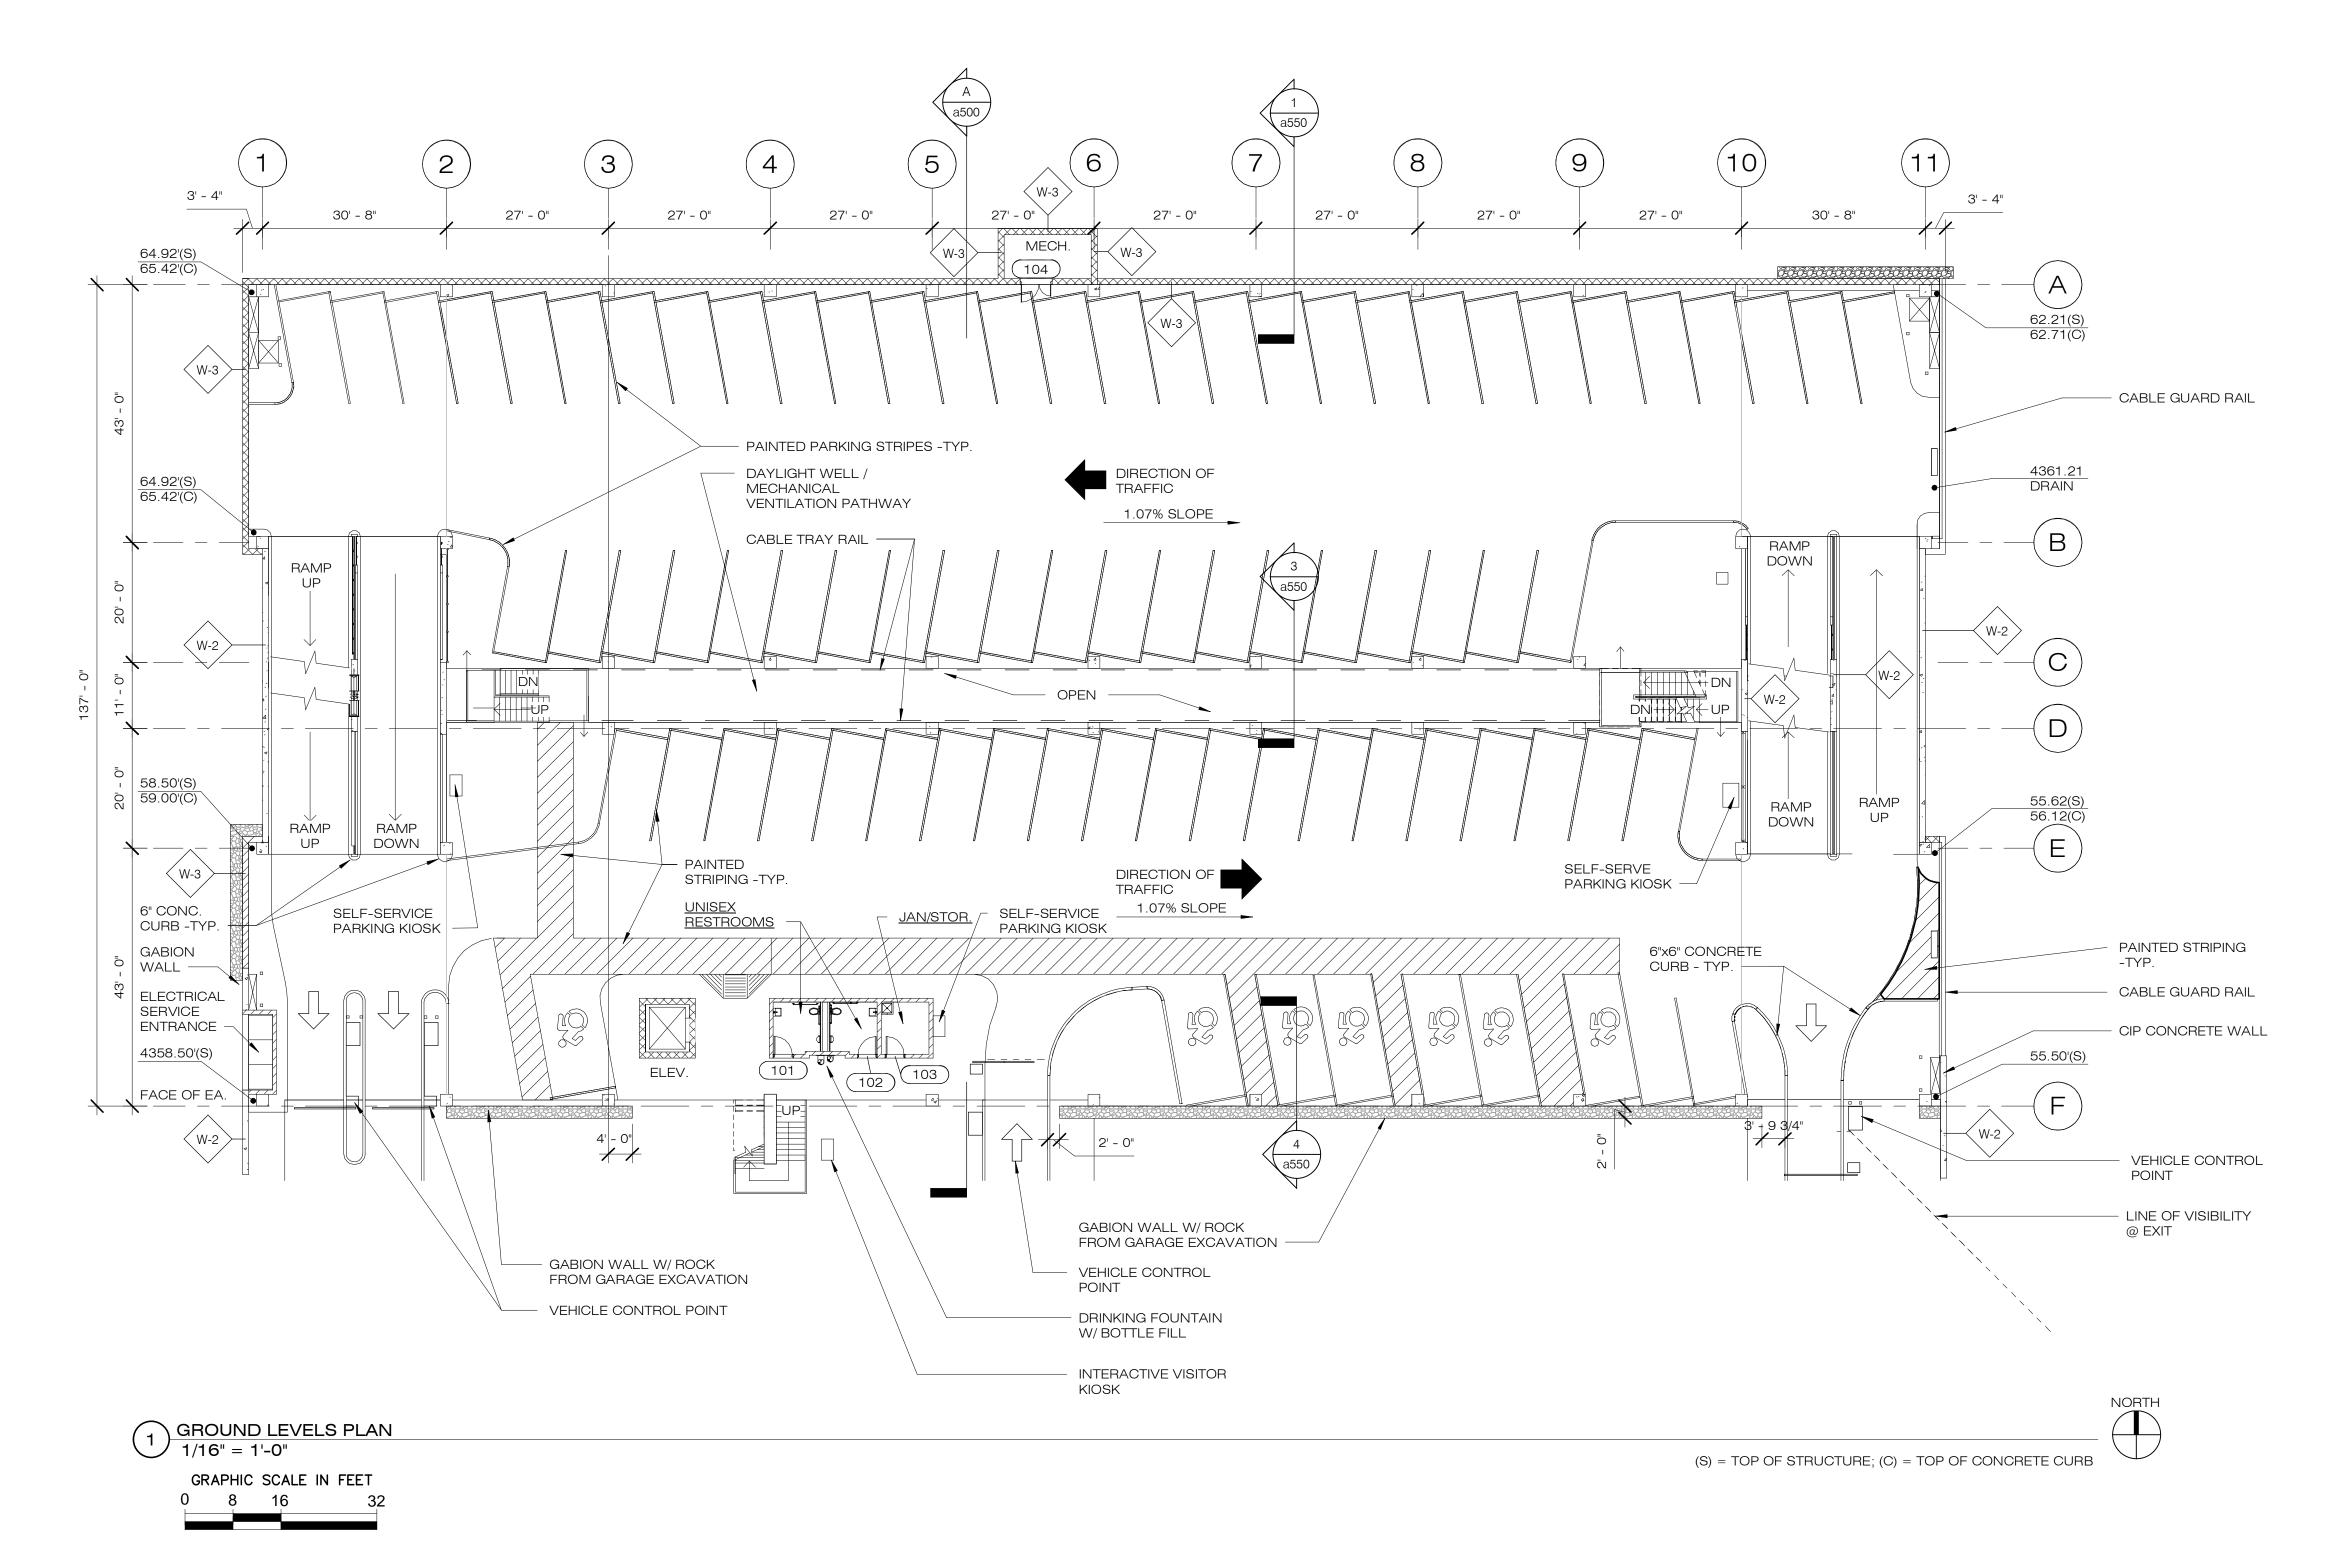

| WALL TYPE | DESCRIPTION |
|--------------|--|
| W-1> | 8" CONCRETE WALL, REINFORCE PER STRUCTURAL DOCUMENTS |
| W-2 | 12" CONCRETE WALL, REINFORCE PER STRUCTURAL DOCUMENTS |
| W-3 | 12x8x16 CONCRETE MASONRY UNITS, GROUT CELLS W/ REINFORCING PER STRUCTURAL DOCUMENTS. |
| W-4> | 8x8x16 CONCRETE MASONRY UNITS, GROUT CELLS W/ REINFORCING PER STRUCTURAL DOCUMENTS. |
| W-5 | PLUMBING WALL, 5/8" CEMENT BOARD ON 3-5/8" METAL STUDS AT 16" O.C. PROVIDE WALL TILE FINISH. |
| W-6> | CORRUGATED CORTEN PANELS OVER STEEL TUBE FRAME. |
| W-7 | WIRE MESH FENCING & GATES OVER STEEL TUBE FRAMING. VERIFY SCALE BAR IS ONE INCH ON |

NOTICE OF EXTENDED PAYMENT PROVISION

(PER ARS 32-1129.01) THIS CONTRACT ALLOWS
THE OWNER TO MAKE PAYMENT WITHIN 15 DAYS
AFTER CERTIFICATION AND APPROVALS OF
BILLINGS AND ESTIMATES FOR PROGRESS
PAYMENTS, WITHIN 15 DAYS AFTER CERTIFICATION
AND APPROVALS OF BILLINGS AND ESTIMATES
FOR RELEASE OF RETENTION AND WITHIN 15
DAYS AFTER CERTIFICATION AND APPROVAL OF
BILLINGS AND ESTIMATES FOR FINAL PAYMENT.




| Symbol | Revisions | Date | Appr. | Designed by: JL | Date: 27 December 2021 |
|--------|-----------|------|-------|------------------|--|
| | | | | Drawn by: | |
| | | | | RGH | |
| | | | | Checked by: | Project Code: GLA PROJECT NO. 20109 |

gabor lorant architects

3326 n. 3rd avenue suite 200 phoenix, arizona 85013 tel: 602.667.9090 fax: 602.667.9133 gaborlorant.com



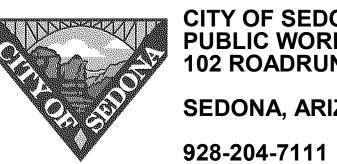

CITY OF SEDONA
PUBLIC WORKS DEPARTMENT
102 ROADRUNNER DRIVE
SEDONA, ARIZONA 86336

Ground Le

IF NOT ONE INCH ON THIS SHEET, ADJUST SCALES ACCORDINGLY


SHEET ID

Ground Levels Floor Plan

Uptown Sedona Parking Facility Design Development

a101 SHEET NO.

OF

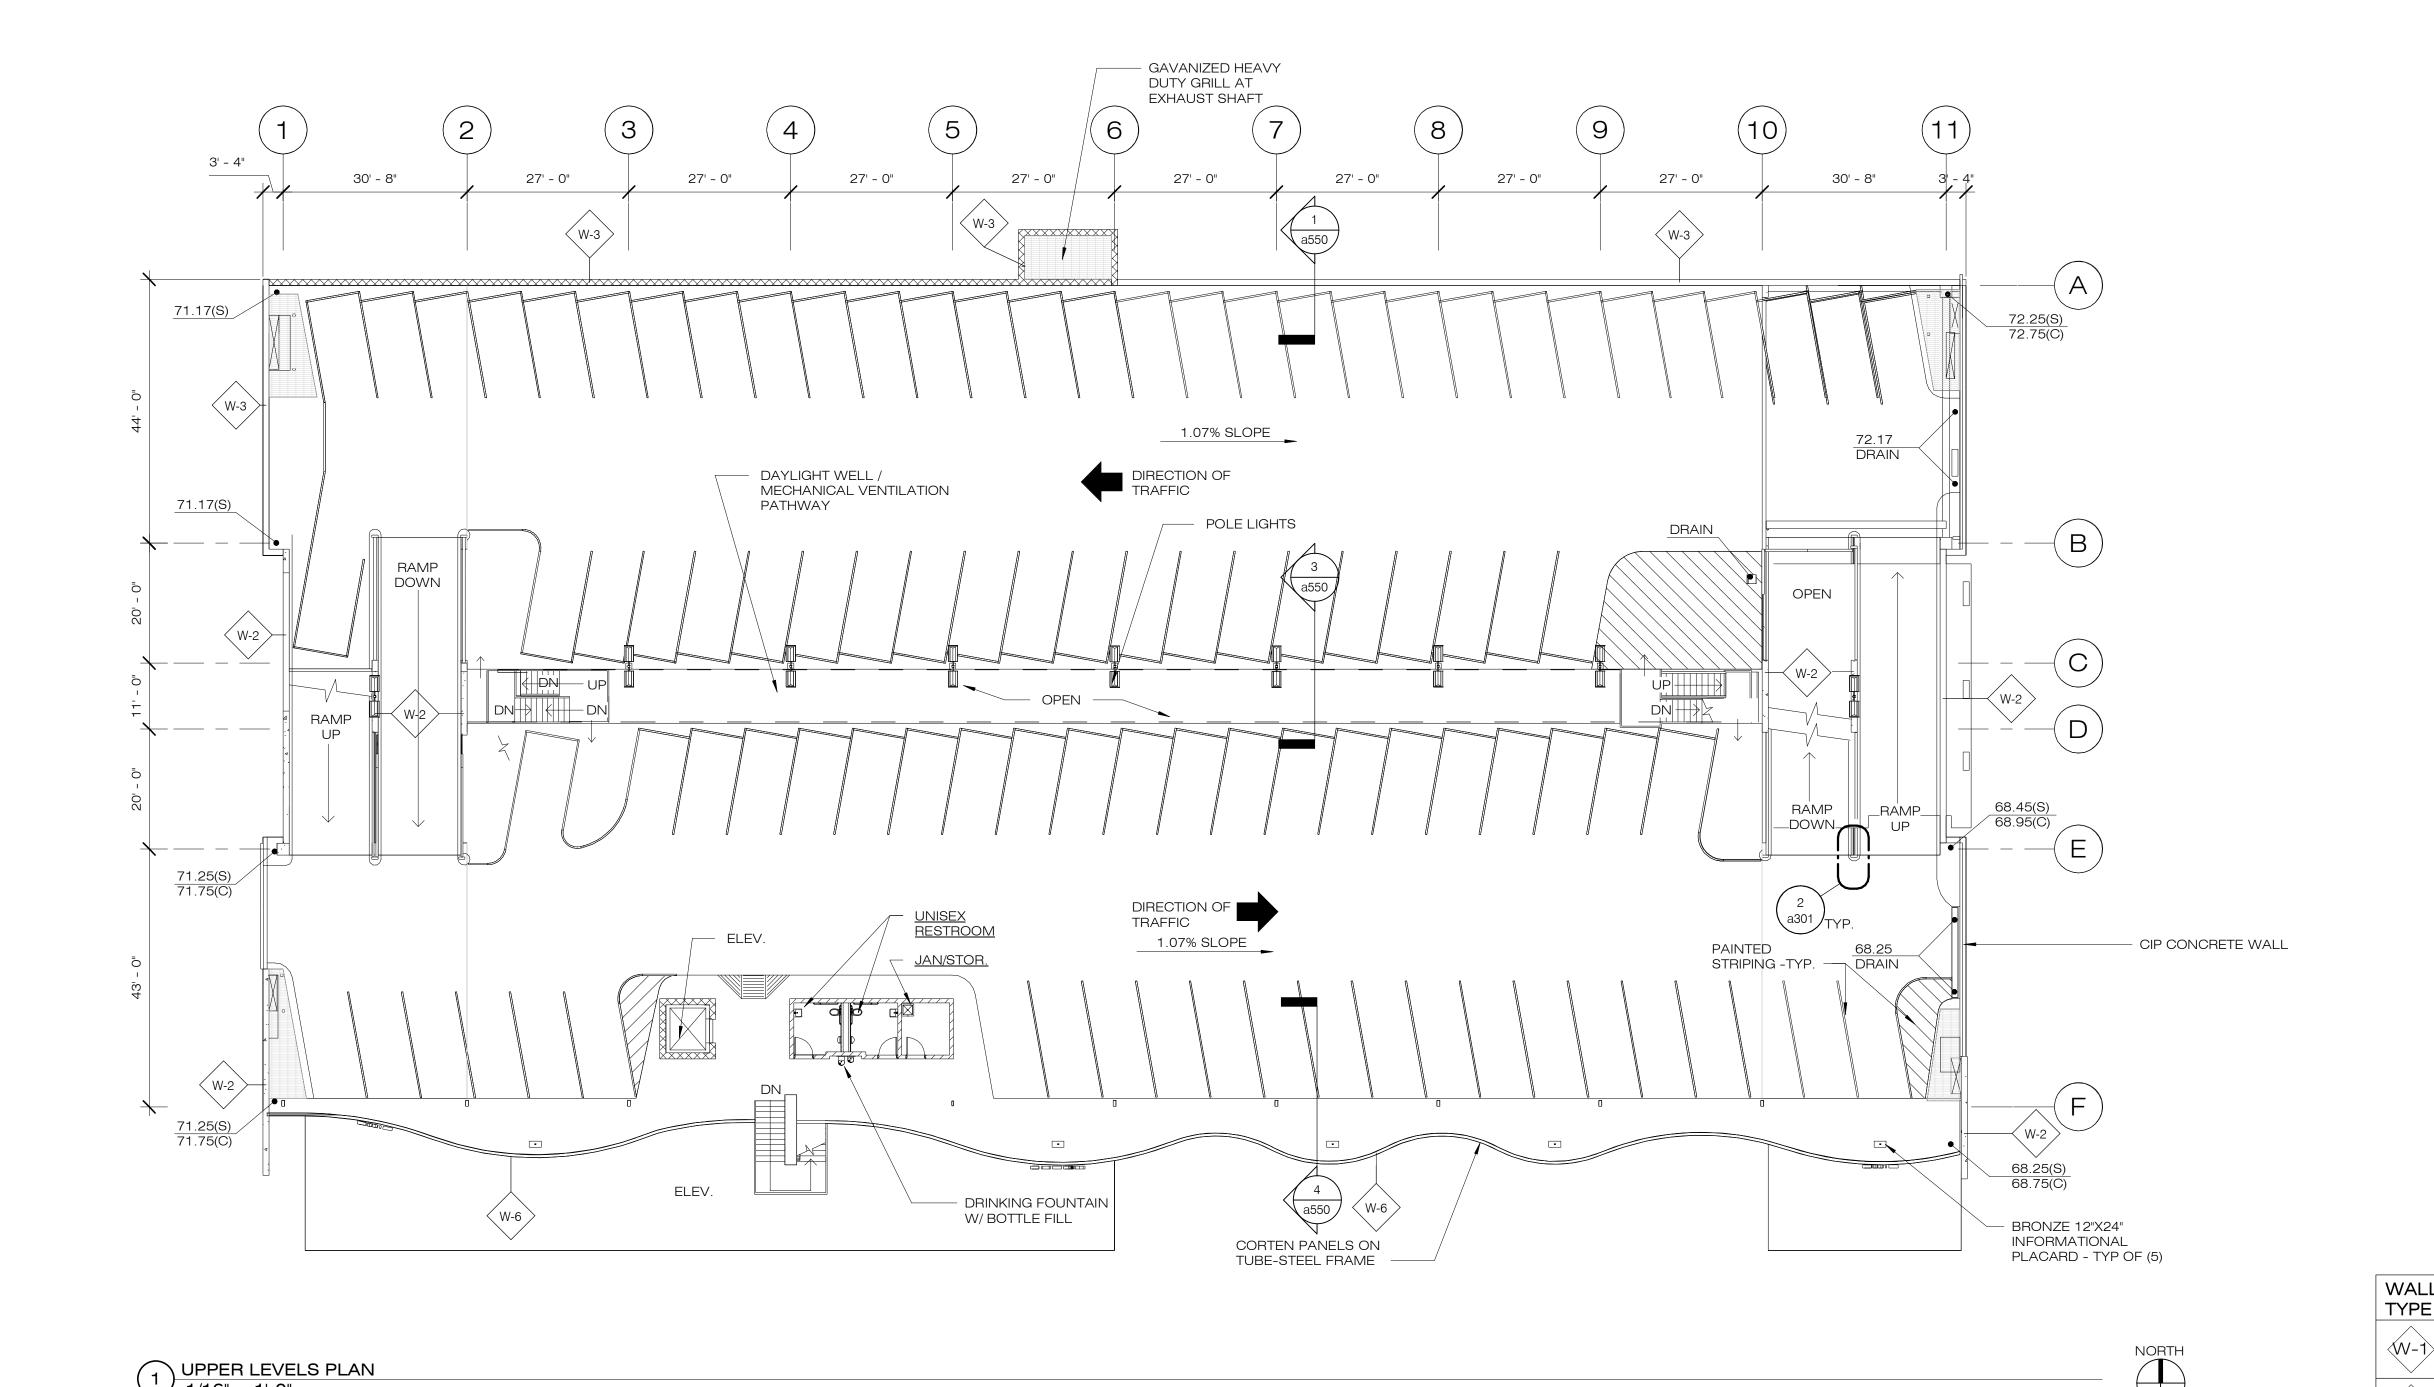

Revisions

1/16" = 1'-0"

GRAPHIC SCALE IN FEET

NOTICE OF EXTENDED PAYMENT PROVISION

Symbol

(PER ARS 32-1129.01) THIS CONTRACT ALLOWS
THE OWNER TO MAKE PAYMENT WITHIN 15 DAYS
AFTER CERTIFICATION AND APPROVALS OF
BILLINGS AND ESTIMATES FOR PROGRESS
PAYMENTS, WITHIN 15 DAYS AFTER CERTIFICATION
AND APPROVALS OF BILLINGS AND ESTIMATES
FOR RELEASE OF RETENTION AND WITHIN 15
DAYS AFTER CERTIFICATION AND APPROVAL OF
BILLINGS AND ESTIMATES FOR FINAL PAYMENT.



Appr.

Designed by:

Drawn by:

Checked by:


27 December 2021

Project Code:

GLA PROJECT NO. 20109

| gabor lorant architects |
|------------------------------|
| 3326 n. 3rd avenue suite 200 |
| phoenix, arizona 85013 |
| tel: 602.667.9090 |
| fav: 602 667 0133 |



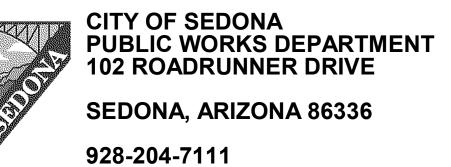

Uptown Sedona Parking Facility Design Development

8" CONCRETE WALL, REINFORCE PER STRUCTURAL DOCUMENTS

12" CONCRETE WALL, REINFORCE PER STRUCTURAL DOCUMENTS

12x8x16 CONCRETE MASONRY UNITS, GROUT CELLS W/ REINFORCING PER

8x8x16 CONCRETE MASONRY UNITS, GROUT CELLS W/ REINFORCING PER

PLUMBING WALL, 5/8" CEMENT BOARD ON 3-5/8" METAL STUDS AT 16" O.C.

CORRUGATED CORTEN PANELS OVER STEEL TUBE FRAME.

WIRE MESH FENCING & GATES OVER STEEL TUBE FRAMING.

DESCRIPTION

STRUCTURAL DOCUMENTS.

W-4 STRUCTURAL DOCUMENTS.

W-5 PROVIDE WALL TILE FINISH.

(W-2)

W-7

Upper Levels Floor Plan

SHEET ID a102

VERIFY SCALES 0 1"

BAR IS ONE INCH ON ORIGINAL DRAWING IF NOT ONE INCH ON THIS SHEET AD JUST


SHEET NO. OF

IF NOT ONE INCH ON THIS SHEET, ADJUST SCALES ACCORDINGLY

| gabor | lorant | architects |
|-------|--------|----------------------|
| | 2226 5 | and evenue quite 200 |

fax: 602.667.9133 gaborlorant.com l

| | pro- September 1 | | |
|---|---------------------|----------|--|
| | ΛA |) | |
| | . N. | | |
| | | | |
| A | | | |
| A | | | |
| | | | |
| | All I | M. | |

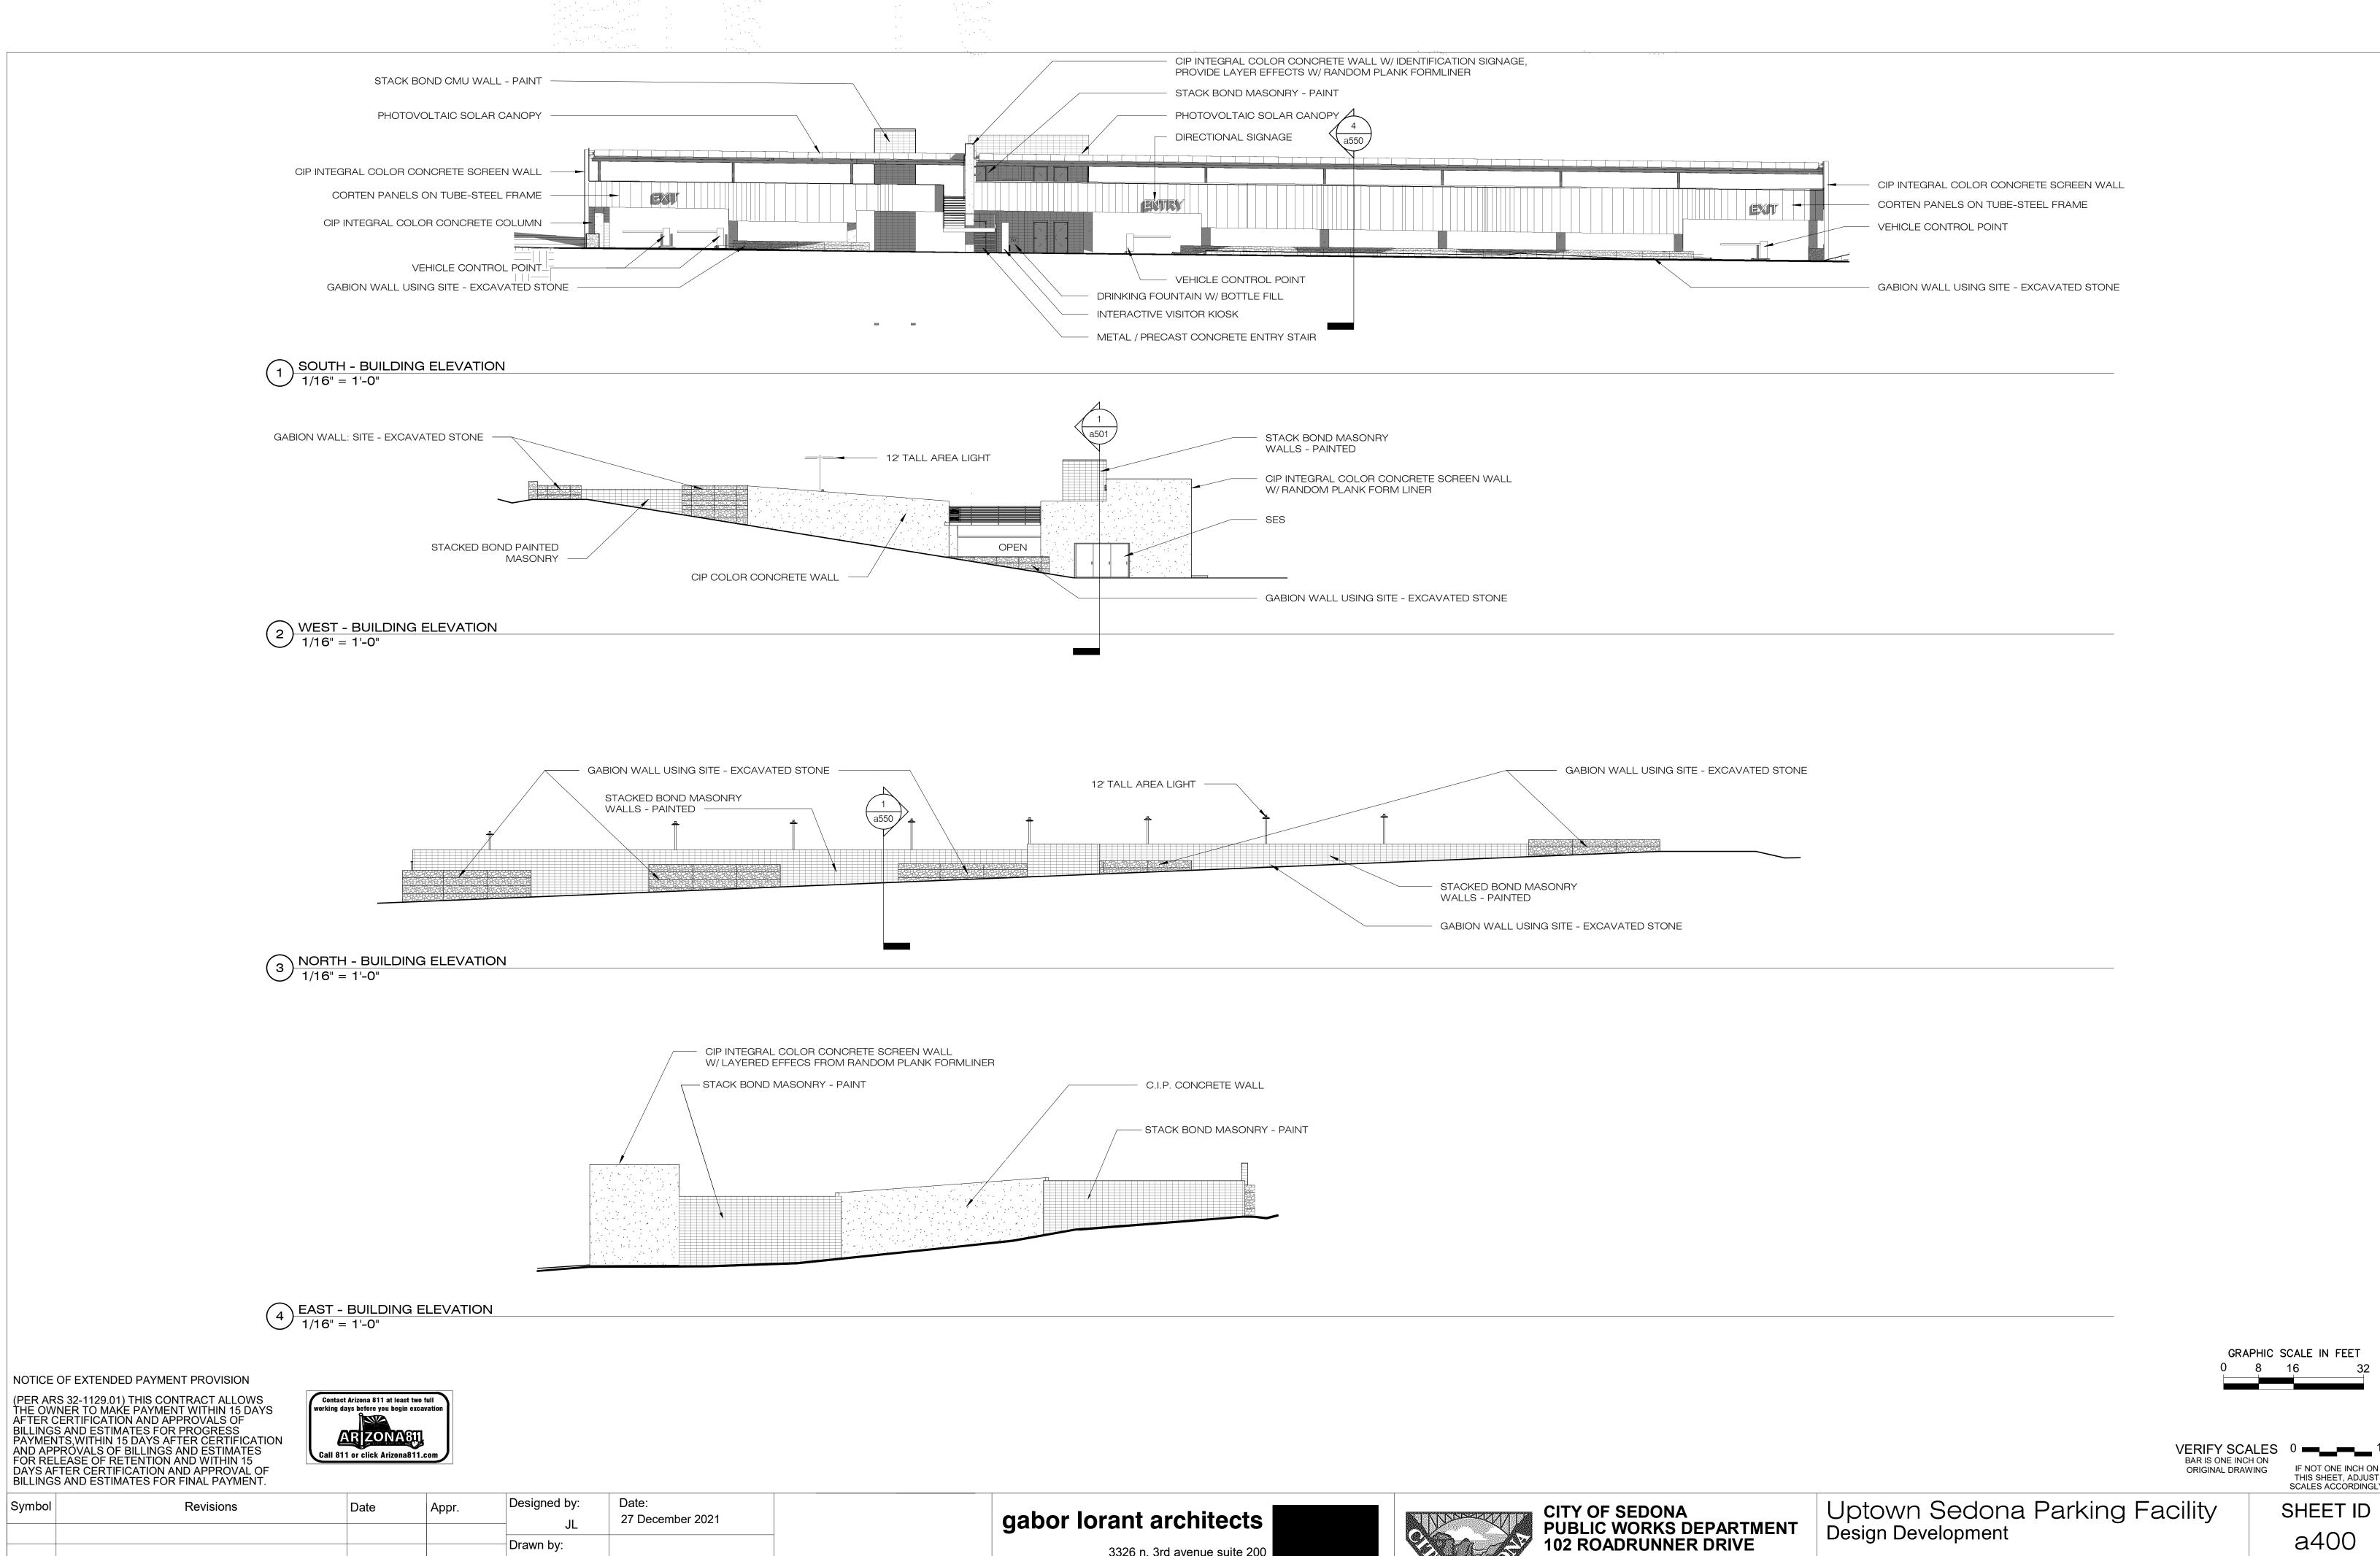

3326 n. 3rd avenue suite 200

phoenix, arizona 85013

tel: 602.667.9090

gaborlorant.com

fax: 602.667.9133

Symbol

Drawn by:

Checked by:

RGH


Project Code:


GLA PROJECT NO. 20109

a400 Exterior Elevations **SEDONA, ARIZONA 86336** SHEET NO. OF 928-204-7111


IF NOT ONE INCH ON THIS SHEET, ADJUST SCALES ACCORDINGLY

SHEET ID

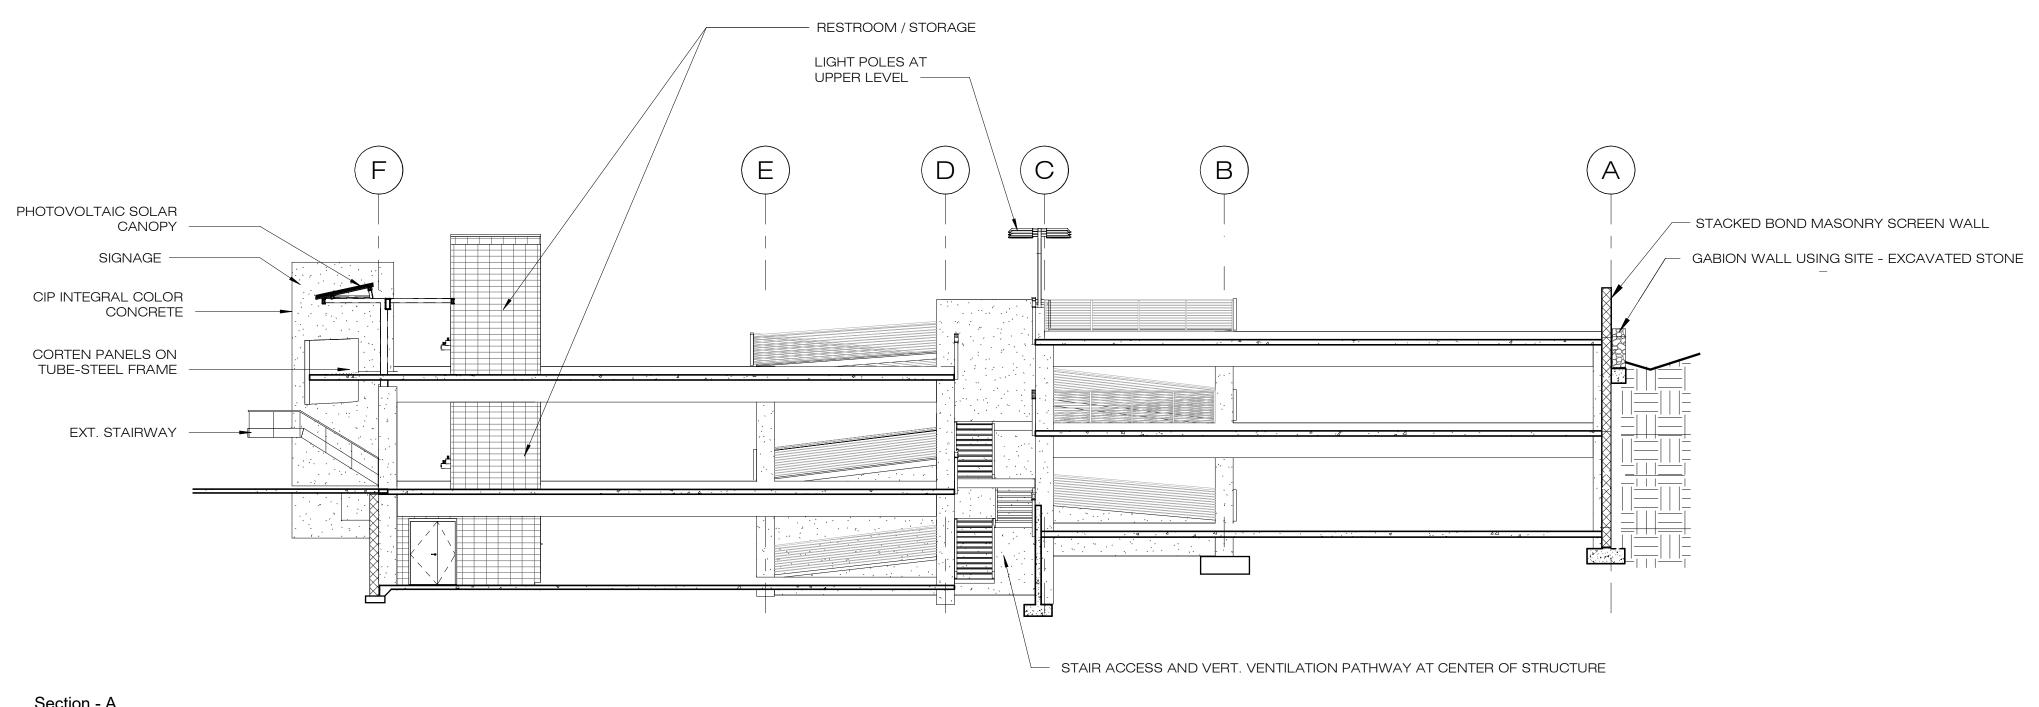

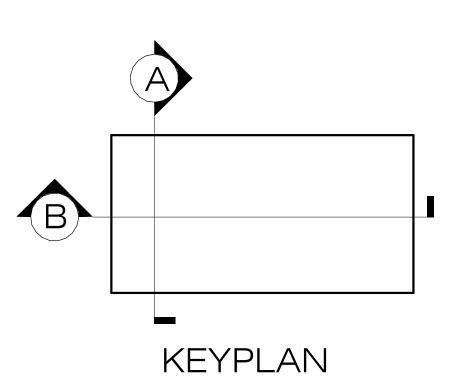

Section - A 3/32" = 1'-0"

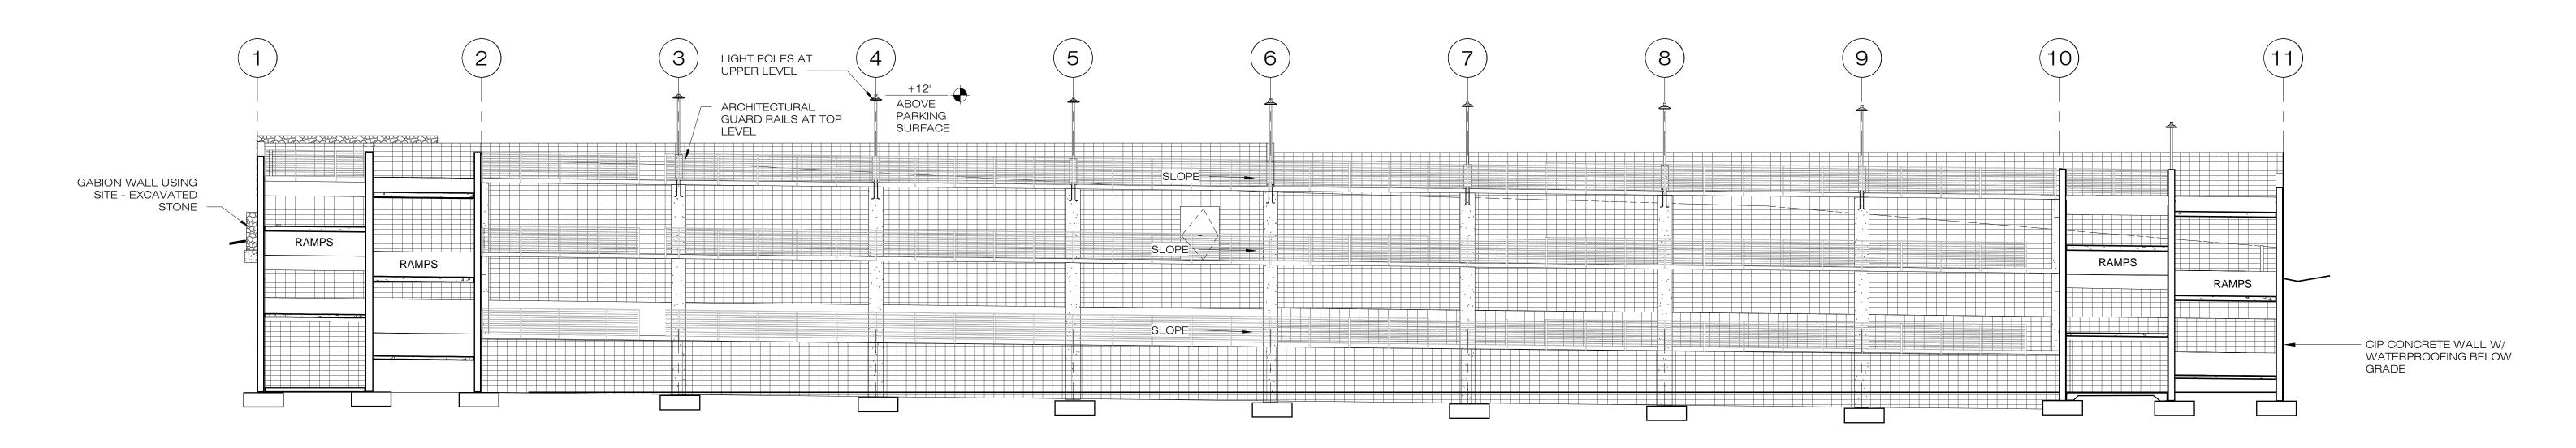

Section - B 3/32" = 1'-0"

NOTICE OF EXTENDED PAYMENT PROVISION

(PER ARS 32-1129.01) THIS CONTRACT ALLOWS
THE OWNER TO MAKE PAYMENT WITHIN 15 DAYS
AFTER CERTIFICATION AND APPROVALS OF
BILLINGS AND ESTIMATES FOR PROGRESS
PAYMENTS, WITHIN 15 DAYS AFTER CERTIFICATION
AND APPROVALS OF BILLINGS AND ESTIMATES
FOR RELEASE OF RETENTION AND WITHIN 15
DAYS AFTER CERTIFICATION AND APPROVAL OF
BILLINGS AND ESTIMATES FOR FINAL PAYMENT.



| | act Arizona 811 at least two full g days before you begin excavation |
|------|---|
| | AR ZONA811 |
| Call | 811 or click Arizona811.com 🦼 |

| Symbol | Revisions | Date | Appr. | Designed by: | Date: 27 December 2021 |
|--------|-----------|------|-------|--------------|---------------------------|
| | | | | JL | |
| | | | | Drawn by: | |
| | | | | RGH | |
| | | | | Checked by: | Project Code: |
| | | | | | GLA PROJECT NO. 20109 |

gabor lorant architects

3326 n. 3rd avenue suite 200 phoenix, arizona 85013 tel: 602.667.9090 fax: 602.667.9133 gaborlorant.com



| CITY OF SEDONA PUBLIC WORKS DEPARTMENT 102 ROADRUNNER DRIVE |
|---|
| SEDONA, ARIZONA 86336 |
| 928-204-7111 |

Uptown Sedona Parking Facility Design Development

Sections


IF NOT ONE INCH ON THIS SHEET, ADJUST SCALES ACCORDINGLY SHEET ID a500

GRAPHIC SCALE IN FEET

VERIFY SCALES 0 1"

BAR IS ONE INCH ON ORIGINAL DRAWING IF NOT ONE INCH ON THIS SHEET AD JUST

SHEET NO. OF

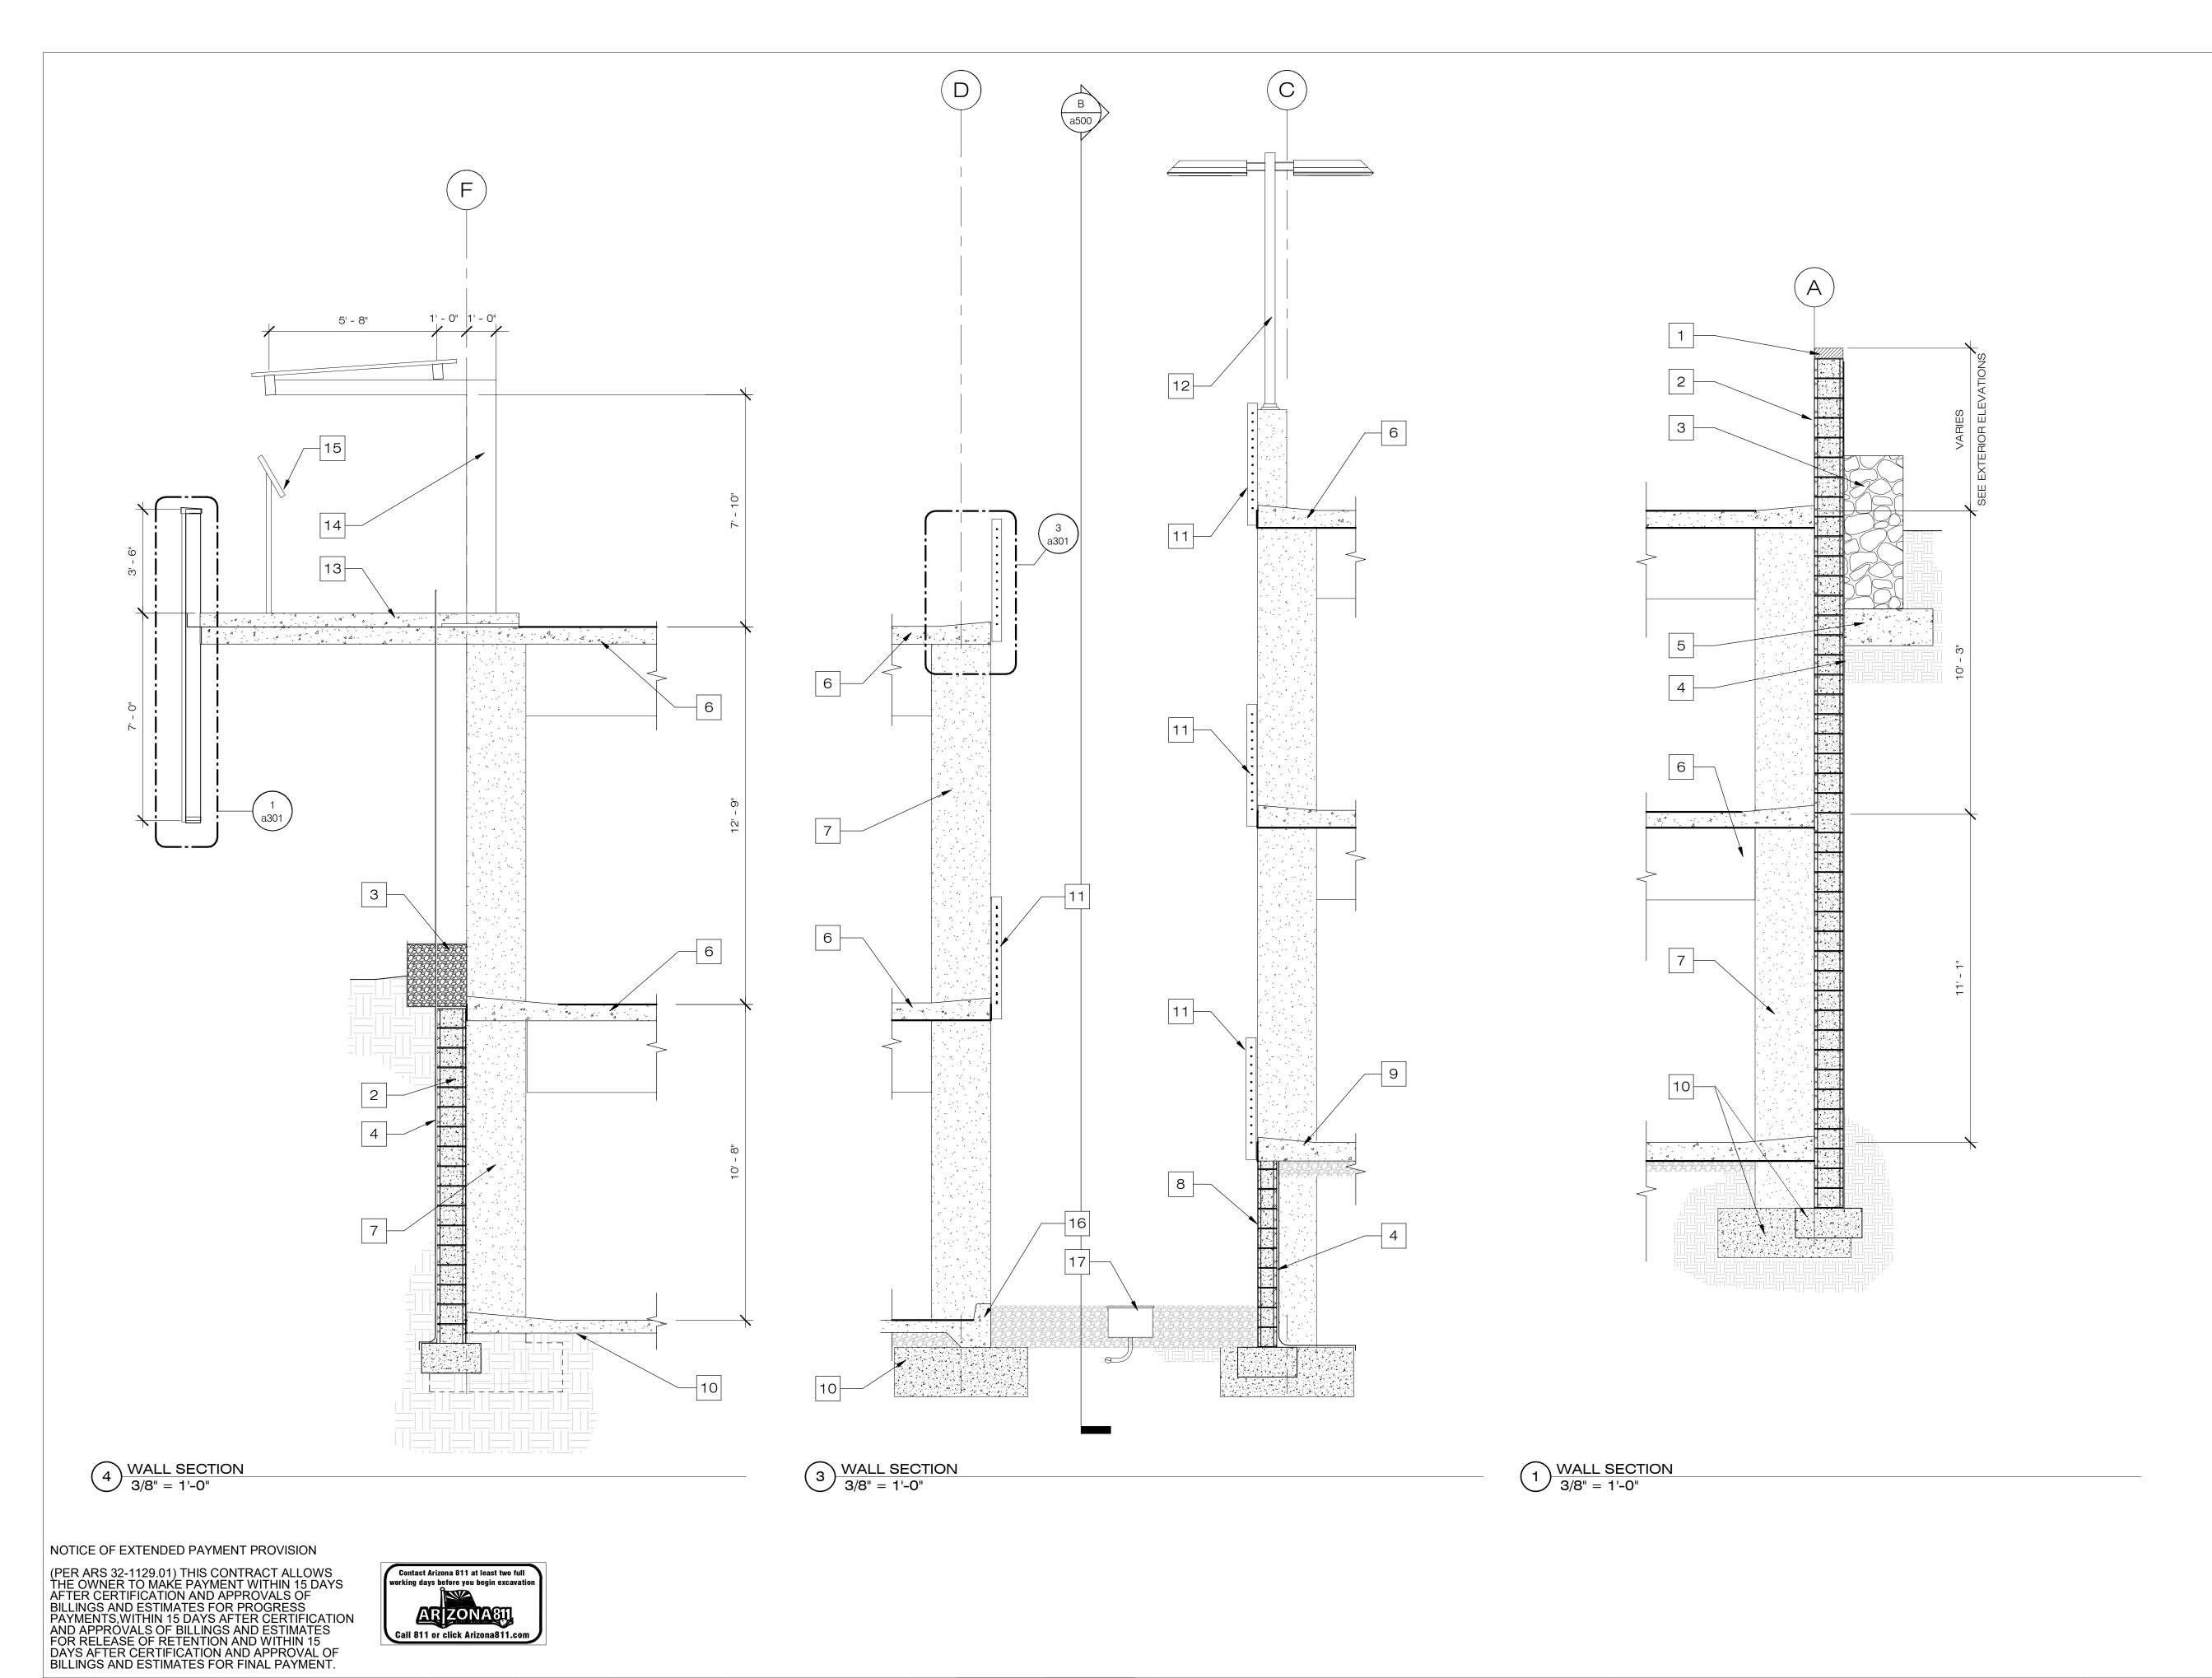

KEYNOTES

| 1 | 4" SOLID CMU WALL CAP |
|---|--|
| | 12" CMU WALL, SOLID GROUTED, SEE STRUCTURAL SHEETS |

24" WIDE GABION WALL

WATERPROOFING & PROTECTION BOARD

12" THICK X 3' WIDE CONCRETE FOOTING

ELEVATED CONCRETE SLAB & BEAMS - SEE STRUCTURAL SHEETS

CONCRETE COLUMN - SEE STRUCTURAL SHEETS

8" CMU WALL, SOLID GROUTED, SEE STRUCTURAL

CONCRETE SLAB ON GRADE - SEE STRUCTURAL SHEETS 10 CONCRETE FOOTING - SEE STRUCTURAL SHEETS

11 CABLE GUARD RAIL

12 LIGHT FIXTURE - SEEL ELECTRICAL SHEETS

13 CONCRETE TOPPING SLAB, MIN 3-1/2" THICK, SLOPE TO

14 SOLAR CANOPY & SUPPORT

15 BRONZE INFORMATIONAL PLACARD

16 5" TALL CONCRETE CURB

17 AREA DRAIN IN ROCK BED

VERIFY SCALES

BAR IS ONE INCH ON
ORIGINAL DRAWING

IF NOT ONE INCH ON
THIS SHEET AD USE IF NOT ONE INCH ON THIS SHEET, ADJUST

| SHEET | ID |
|-------|----|
| a550 |) |


SCALES ACCORDINGLY

Designed by: Symbol Revisions Appr. 27 December 2021 Drawn by: Project Code: Checked by: GLA PROJECT NO. 20109

gabor lorant architects

3326 n. 3rd avenue suite 200 phoenix, arizona 85013 tel: 602.667.9090 fax: 602.667.9133 gaborlorant.com



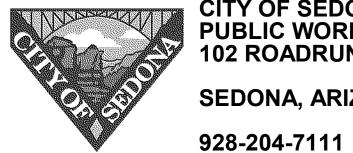

CITY OF SEDONA
PUBLIC WORKS DEPARTMENT
102 ROADRUNNER DRIVE **SEDONA, ARIZONA 86336**

Uptown Sedona Parking Facility Design Development Wall Sections

SHEET NO. OF



Uptown Sedona Parking Garage





NOTICE OF EXTENDED PAYMENT PROVISION

(PER ARS 32-1129.01) THIS CONTRACT ALLOWS
THE OWNER TO MAKE PAYMENT WITHIN 15 DAYS
AFTER CERTIFICATION AND APPROVALS OF
BILLINGS AND ESTIMATES FOR PROGRESS
PAYMENTS, WITHIN 15 DAYS AFTER CERTIFICATION
AND APPROVALS OF BILLINGS AND ESTIMATES
FOR RELEASE OF RETENTION AND WITHIN 15
DAYS AFTER CERTIFICATION AND APPROVAL OF
BILLINGS AND ESTIMATES FOR FINAL PAYMENT.

Revisions



Drawn by:

Checked by:

21 December 2021

GLA PROJECT NO. 20109

Project Code:

3326 n. 3rd avenue suite 200 phoenix, arizona 85013 tel: 602.667.9090 gaborlorant.com





CITY OF SEDONA
PUBLIC WORKS DEPARTMENT
102 ROADRUNNER DRIVE

SEDONA, ARIZONA 86336 928-204-7111

Uptown Sedona Parking Facility Design Development

Rendering

SHEET ID a001

IF NOT ONE INCH ON THIS SHEET, ADJUST SCALES ACCORDINGLY

VERIFY SCALES

BAR IS ONE INCH ON
ORIGINAL DRAWING

IF NOT ONE INCH ON
THIS SHEET ADJUST

SHEET NO. OF

gabor lorant architects

- 2. SITE GRADING NECESSITATED BY THE WORK AS IT PROGRESSES AND NOT SPECIFICALLY CALLED OUT ON THE PLANS SHALL BE CONSIDERED INCIDENTAL WORK.
- 3. CONTRACTOR SHALL COORDINATE AND BE IN COMPLIANCE WITH ALL STATE AND LOCAL MUNICIPALITIES AS WARRANTED.
- 4. CONTRACTOR IS TO REVIEW PLANS, VERIFY SITE CONDITIONS AND PLANT QUANTITIES PRIOR TO INSTALLATION. ANY DISCREPANCIES FOUND BETWEEN THE DRAWINGS AND SPECIFICATIONS AND EXISTING SITE CONDITIONS OR ANY INCONSISTENCIES OR AMBIGUITIES IN DRAWINGS OR SPECIFICATIONS SHALL BE IMMEDIATELY REPORTED TO THE LANDSCAPE ARCHITECT, IN WRITING, WHO SHALL PROMPTLY ADDRESS SUCH INCONSISTENCIES OR AMBIGUITIES. WORK DONE BY THE CONTRACTOR AFTER HIS DISCOVERY OF SUCH DISCREPANCIES, INCONSISTENCIES, OR AMBIGUITIES SHALL BE DONE AT THE CONTRACTOR'S RISK.
- 5. DEVIATION FROM THESE PLANS AND NOTES WITHOUT THE PRIOR CONSENT OF THE OWNER, OR THE LANDSCAPE ARCHITECT, MAY BE CAUSE FOR THE WORK TO BE DESIGNATED UNACCEPTABLE.
- 6. THE CONTRACTOR ACKNOWLEDGES & AGREES THAT THE WORK IS ENTIRELY AT HIS RISK UNTIL SITE IS ACCEPTED, AND HE WILL BE HELD RESPONSIBLE FOR ITS SAFETY BY THE OWNER.
- 7. THE CONTRACTOR WILL BE HELD RESPONSIBLE FOR THE DAMAGE OR LOSS OF ANY REFERENCE POINTS AND HUBS DURING THE CONSTRUCTION OF HIS WORK, AND SHALL BEAR THE COST OF REPLACING SAME.
- 8. THE CONTRACTOR IS RESPONSIBLE FOR HORIZONTALLY AND VERTICALLY LOCATING AND PROTECTING ALL PUBLIC AND PRIVATE UTILITIES WHICH LIE IN OR ADJACENT TO THE CONSTRUCTION SITE AT LEAST 48 HOURS PRIOR TO ANY DEMOLITION, GRADING, OR CONSTRUCTION ACTIVITY.
- 9. THE CONTRACTOR SHALL SALVAGE AND PROTECT ALL EXISTING POWER POLES, SIGNS, MANHOLES, TELEPHONE RISERS, WATER VALVES, ETC., DURING ALL CONSTRUCTION PHASES UNLESS NOTED OTHERWISE. THE CONTRACTOR SHALL REPAIR, AT HIS OWN EXPENSE, ANY EXISTING UTILITIES DAMAGED DURING CONSTRUCTION.
- 10. ANY FOREIGN ITEM FOUND DURING CONSTRUCTION IS THE PROPERTY OF THE OWNER. THIS INCLUDES, BUT IS NOT LIMITED TO, PRECIOUS METALS, COINS, PAPER CURRENCY, ARTIFACTS AND ANTIQUITIES.
- 11. ALL SURPLUS EXCAVATION SHALL BE TAKEN TO A SITE DESIGNATED BY OWNER, AT NO ADDITIONAL COST TO THE OWNER. IF OWNER CHOOSES, THE CONTRACTOR MAY TAKE POSSESSION OF SURPLUS EXCAVATION MATERIAL.
- 12. CONTRACTOR IS RESPONSIBLE FOR VERIFYING AND/OR OBTAINING ALL REQUIRED PERMITS AND APPROVALS PRIOR TO COMMENCING CONSTRUCTION.
- 13. CONTRACTOR IS TO MAINTAIN CONTROLLED PEDESTRIAN AND ADA ACCESS THROUGH ALL AREAS OF THE SITE THROUGHOUT CONSTRUCTION PERIOD.
- 14. MAINTAIN THE SITE IN A NEAT AND ORDERLY CONDITION AT ALL TIMES. DAILY, AND MORE OFTEN IF NECESSARY, INSPECT & AND PICK UP ALL SCRAP, DEBRIS, & WASTE MATERIAL.
- 15. IT IS THE RESPONSIBILITY OF THE CONTRACTOR TO REMOVE ALL MUD. DIRT, ROCK MULCH AND OTHER MATERIALS TRACKED ONTO ANY PRIVATE OR PUBLIC STREETS OR SIDEWALKS. THE CONTRACTOR MUST CLEAN THESE DAILY, IF NECESSARY. THE CONTRACTOR MUST USE WATER OR OTHER ACCEPTABLE METHODS TO KEEP AIRBORNE DUST TO A REQUIRED MINIMUM.
- 16. PROVIDE PROTECTION TO ALL FINISHED WORK. MAINTAIN SURFACES CLEAN, UNMARRED, AND SUITABLY PROTECTED UNTIL ACCEPTANCE BY OWNER.
- 17. THE CONTRACTOR SHALL BE RESPONSIBLE FOR REPAIRING ANY DAMAGE RESULTING FROM CONSTRUCTION ACTIVITY TO EXISTING ELEMENTS THAT ARE TO REMAIN.
- 18. EROSION CONTROL MEASURES (IE: SILT FENCING AND SEDIMENT CONTROL) SHALL BE MAINTAINED BY THE CONTRACTOR PER CIVIL SPECIFICATIONS. ANY EROSION CONTROL MEASURES DAMAGED BY THE CONTRACTOR SHALL BE REPLACED PER CIVIL SPECIFICATIONS.
- 19. PLANT QUANTITIES LISTED IN THE PLANT LEGEND ARE FOR THE CONVENIENCE OF THE CONTRACTOR. THE CONTRACTOR SHALL DO THEIR OWN TAKE-OFFS AND BASE BID ACCORDINGLY.
- 20. ALL PLANT MATERIAL SHALL BE HEALTHY, VIGOROUS, WELL BRANCHED, AND DENSELY FOLIATED (WHEN IN-LEAF) AS IS TYPICAL FOR THE SPECIES. THEY SHALL HAVE HEALTHY, WELL DEVELOPED STANDARDS, AND FREE OF ANY BRUISES, CUTS OR OTHER ABNORMALITIES. PLANT MATERIAL SHALL BE SIZED IN ACCORDANCE WITH THE AMERICAN STANDARD FOR NURSERY STOCK, LATEST EDITION, PUBLISHED BY THE AMERICAN ASSOCIATION OF NURSERYMAN.
- 21. OWNERS REPRESENTATIVE RESERVES THE RIGHT TO REJECT ANY PLANT MATERIAL DEEMED UNACCEPTABLE.
- 22. LANDSCAPE CONTRACTOR TO TAG AND HOLD ALL PLANT MATERIAL A MINIMUM OF 30 DAYS PRIOR TO DATE OF INSTALLATION. ALL PLANT MATERIAL SUBSTITUTIONS MADE WITHIN THE 30 DAYS PRIOR TO INSTALLATION TO BE THE NEXT SIZE LARGER AT NO ADDITIONAL COST TO THE CLIENT.
- 23. INSTALL ALL CANOPY TREES WITH A MINIMUM OF 5 FT. SEPARATION FROM ALL UTILITIES. UNLESS A ROOT BARRIER IS UTILIZED.
- 24. THE LANDSCAPE CONTRACTOR SHALL MAINTAIN PLANTED AREAS BY MEANS OF CONTINUOUS WATERING, PRUNING, RAISING TREE ROOT BALLS WHICH SETTLE BELOW GRADE, APPLICATION OF SPRAYS WHICH ARE NECESSARY TO KEEP THE PLANTING FREE OF INSECTS AND DISEASES, FERTILIZING, WEEDING, MOVING, EDGING AND/OR OTHER OPERATIONS NECESSARY FOR PROPER CARE AND UPKEEP. MAINTENANCE PERIOD SHALL BE TWO (2) YEARS BEGINNING FROM DATE OF ACCEPTED FINAL COMPLETION.
- 25. ROCK MULCH: ALL AREAS LABELED ROCK MULCH ON THE PLANS ARE TO BE APPROVED BY OWNER. 2" MINIMUM DEPTH THROUGHOUT ENTIRE PROJECT. FINISH GRADE IN ALL AREAS TO BE SMOOTH AND EVEN AND 1" BELOW TOP OF CURB OR SIDEWALK.

MAINTENANCE REQUIREMENTS

- 1. THE LANDSCAPE MAINTENANCE AND WARRANTY PERIOD SHALL BE SEVEN HUNDRED AND THIRTY (730) CONSECUTIVE CALENDAR DAYS. THE TIME PERIOD SHALL BEGIN AFTER WRITTEN NOTICE FROM THE PROJECT ENGINEER OF SUBSTANTIAL COMPLETION OF THE LANDSCAPE PORTION OF THE PROJECT AND WHEN THE ENGINEER IS ASSURED THAT THE WORK CAN BE PERFORMED IN A CONTINUOUS AND CONSISTENT MANNER WITHOUT RESTRICTING THE USE OF ANY FACILITIES BY THE TRAVELING PUBLIC.
- 2. THE CONTRACTOR SHALL SUBMIT A WORK SCHEDULE OF OPERATIONS FOR APPROVAL BY THE ENGINEER AND CITY OF SEDONA STAFF. THE WORK SCHEDULE SHALL INCLUDE CONTACT INFORMATION FOR THOSE RESPONSIBLE FOR MAINTENANCE.
- 3. PLANT MATERIALS NOT SURVIVING SHALL BE REPLACED WITHIN 30 DAYS OF ITS DEMISE.

PLANT LEGEND

| DECIDUOUS TREES | | | |
|--|---|--------------|---------|
| SYMBOL | BOTANICAL NAME COMMON NAME | QUANTITY | SIZE |
| | CHILOPSIS LINEARIS DESERT WILLOW | 5 | 15 GAL. |
| EVERGREEN TREES | | | |
| SYMBOL | BOTANICAL NAME COMMON NAME | QUANTITY | SIZE |
| The state of the s | JUNIPERUS ARIZONICA REDBERRY JUNIPER | 15 | 15 GAL. |
| • | JUNIPERUS SCOPULORUM ROCKY MOUNTAIN JUNIPER | 13 | 15 GAL. |
| SHRUBS/GROUNDCOV | /ERS | | |
| SYMBOL | BOTANICAL NAME COMMON NAME | QUANTITY | SIZE |
| \odot | ASCLEPIAS TUBEROSA BUTTERFLY MILKWEED | 55 | 1 GAL. |
| 0 | BOUTELOUA GRACILIS 'BLONDE AMBITION' 'BLONDE AMBITION' BLUE GRAMA | 81 | 1 GAL. |
| 6 | CHAMAEBATIARIA MILLEFOLIUM 'FERNBUSH' FERNBBUSH | 17 | 5 GAL. |
| 0 | ERICAMERICA LARICIFOLIA TURPENTINE BUSH | 31 | 1 GAL. |
| o | MELAMPODIUM LEUCANTHUM BLACKFOOT DAISY | 62 | 1 GAL. |
| \odot | NOLIA MICROCARPA BEAR GRASS | 24 | 5 GAL. |
| SITE | | | |
| SYMBOL | NAME | QUANTITY | |
| Responsible to the second seco | 1"-3" ROCK MULCH, | 15,998 SQ FT | |

IRRIGATION NOTES


- 1. CONTRACTOR SHALL REVIEW AND FIELD VERIFY LAYOUT OF ALL IRRIGATION SYSTEM COMPONENTS AND HAVE THE LAYOUT AND COMPONENTS APPROVED BY CITY OF SEDONA STAFF PRIOR TO STARTING INSTALLATION.
- 2. ALL PIPING AND WIRING PLACED UNDER PAVED AREAS SHALL BE SLEEVED PER PLAN DETAILS. SLEEVE INSTALLATIONS SHALL BE COMPLETED PRIOR TO THE START OF ANY PAVING OPERATIONS (SEE ENGINEERING PLANS).
- 3. THE CONTRACTOR SHALL BE RESPONSIBLE FOR INSTALLING, TESTING, MAINTAINING, REPAIRING, AND OPERATING A COMPLETE AND FULLY FUNCTIONAL IRRIGATION SYSTEM INCLUDING ALL LATERAL PIPING AND FITTINGS AS SPECIFIED AND AS DETAILED, WHETHER OR NOT PIPING IS SHOWN ON THE PLANS.
- 4. ANY SUBSTITUTIONS OR OMISSIONS OF IRRIGATION COMPONENTS AND EQUIPMENT MUST BE APPROVED IN WRITING BY CITY OF SEDONA STAFF PRIOR TO STARTING INSTALLATION.
- 5. CONTRACTOR TO FIELD VERIFY ALL WATER PRESSURE AND FLOWS PRIOR TO INSTALLATION OF SYSTEM. IF INSUFFICIENT PRESSURE IS ENCOUNTERED, NOTIFY OWNER IMMEDIATELY.
- 6. ALL EXISTING IRRIGATION COMPONENTS SHALL BE MAINTAINED IN CURRENT WORKING CONDITION. ALL EXISTING PLANTS SHALL ONTINUE RECEIVING IRRIGATION DURING CONSTRUCTION ACTIVITIES.

IRRIGATION LEGEND

| SYMBOL | EQUIPMENT | SIZE | PRODUCT |
|-------------------------|---|------|---|
| M | WATER METER - POTABLE | _ | _ |
| $\overline{\mathbb{C}}$ | CONTROLLER | TBD | CALSENSE |
| B | BACKFLOW PREVENTER | 1" | FEBCO 825Y |
| Δ | PRESSURE REGULATOR | 1" | SENNINGER PMR-35MF |
| \bowtie | GATE VALVE | 1" | NIBCO T-113-IR |
| | REMOTE CONTROL VALVE ASSEMBLY — DRIP ZONES | _ | RAINBIRD-100-PESB |
| | MAINLINE | 1" | PVC SCH 40 |
| ттт | TREE LATERAL LINE | 3/4" | PVC SCH 40 |
| | SHRUB LATERAL LINE | 3/4" | PVC SCH 40 |
| ===== | SLEEVE UNDER STREET & PATHWAY | 4" | PVC SCH 40 |
| ─ | END CAP AUTOMATIC FLUSHING COMPRESSION END PLUG | | |
| NOT SHOWN | EMITTER ASSEMBLY MULTI-PORT; (1 GPH & 2 GPH) | | RAINBIRD XBT-10-6, XBT-20-6; 1 PER TREE; SHRUBS WITH SAME FLOW RATE TO SHARE |



NOTICE OF EXTENDED PAYMENT PROVISION

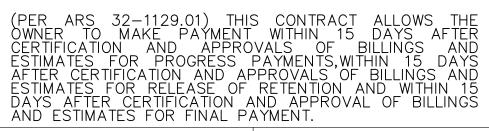


| Symbol | Revisions | Date | Appr. | Designed by: | Date: 27 December 2021 |
|--------|-----------|------|-------|--------------|---------------------------|
| | | | | Drawn by: | Scale: |
| | | | | ALD | N/A |
| | | | | Checked by: | Project Code: |
| | | | | JRW | 091885001 |



COLOR TBD



WWW.KIMLEY-HORN.COM

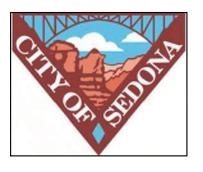

CITY OF SEDONA PUBLIC WORKS DEPARTMENT 102 ROADRUNNER DRIVE

SEDONA, ARIZONA 86336 928-204-7111


UPTOWN SEDONA PARKING GARAGE


LANDSCAPE NOTES

LS01 SHEET NO.

SHEET ID

13 OF 19

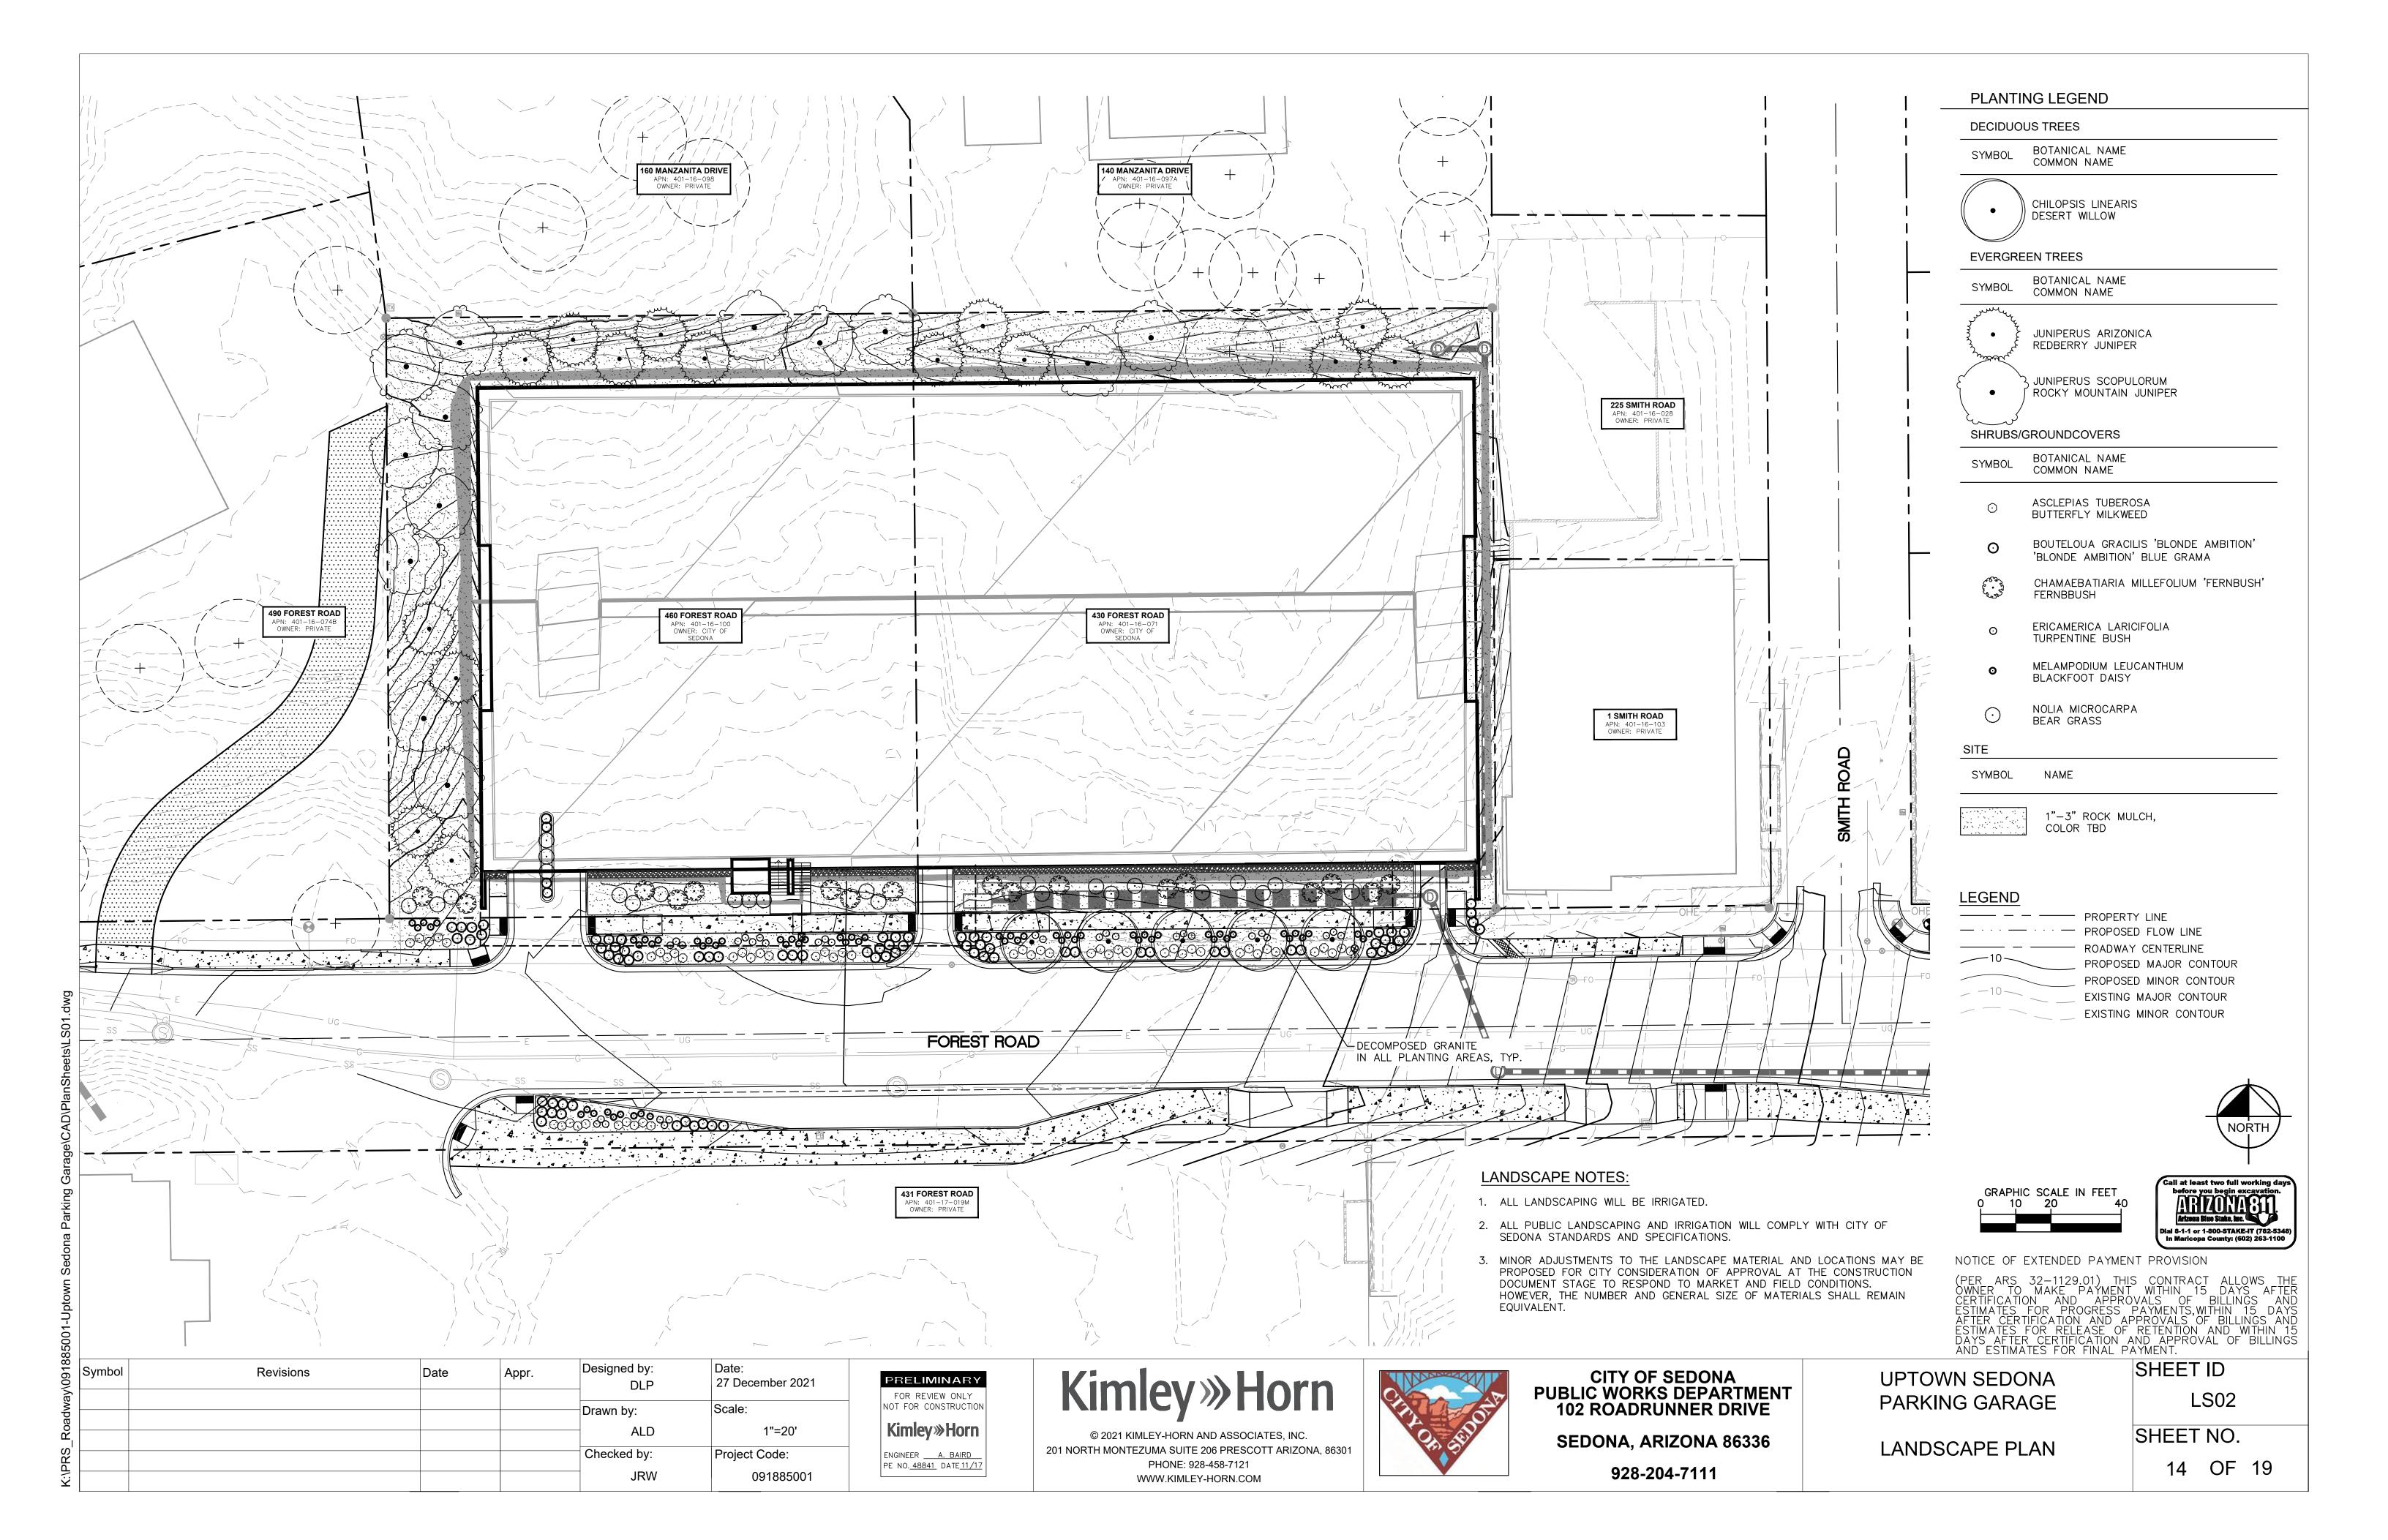

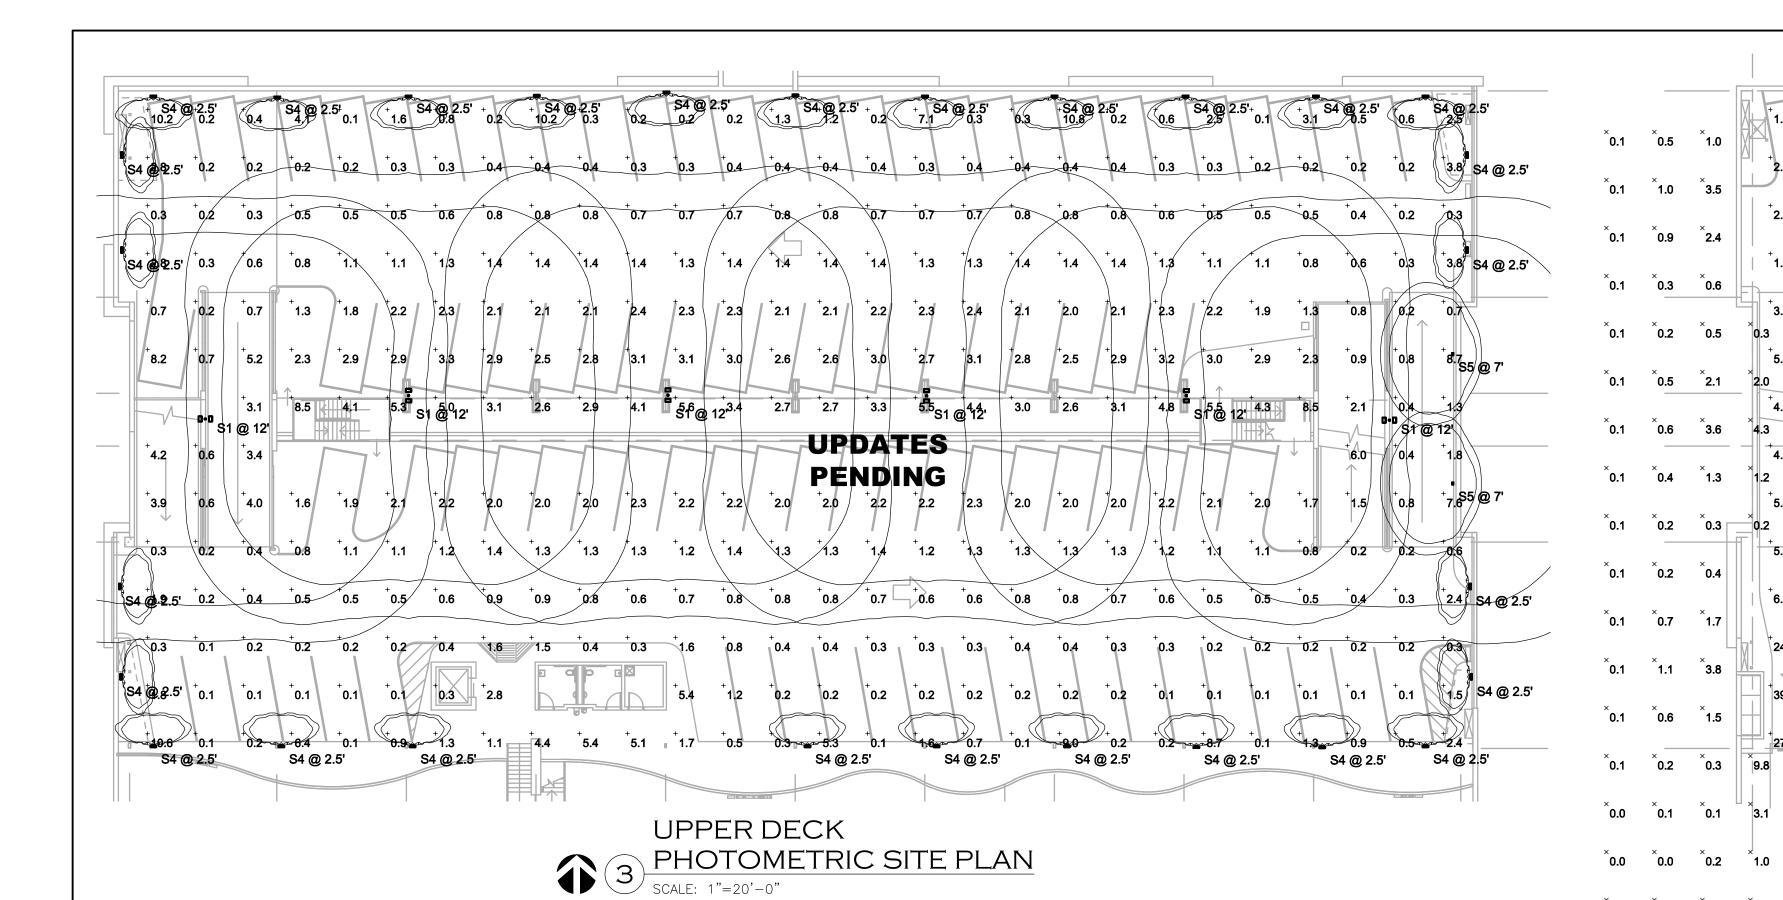

| Schedule | chedule | | | | | | | | | | |
|----------|---------|----------|---------------|--|--|-----------|-----------------|-------------------|---------|--|--|
| Symbol | Label | Quantity | Manufacturer | Catalog Number | Description | Lamp | Lumens Per Lamp | Light Loss Factor | Wattage | | |
| | S1 | 4 | LITHONIA | TWIN HEAD DSXO LED P2 30K T5W VOLTAGE SPA NLTAIR2 FINISH / SSS 10' | DSXO LED P2 30K T5W MVOLT MOUNTED AT 12' AFG | 3000K LED | 5751 | 0.91 | 98 | | |
| | S2 | 8 | LITHONIA | VCPG LED P6 30K 70CRI T5E VOLTAGE PM SPD10KV LDS36 NLTAIR2 FINISH | VCPG LED WITH P6 - PERFORMANCE PACKAGE, 3000K, T5E OPTIC TYPE | 3000K LED | 13197 | 0.91 | 107.69 | | |
| | S3 | 59 | LITHONIA | VCPG LED P3 30K 70CRI T5W VOLTAGE PM SPD10KV LDS36 NLTAIR2 FINISH | VCPG LED WITH P3 — PERFORMANCE PACKAGE, 3000K, T5W OPTIC TYPE | 3000K LED | 5825 | 0.91 | 43.37 | | |
| | S4 | 28 | C.W.COLE | SL612W-AL-H0-15?-3K | 3-3/4"L. X 14"W. X 4"H. LED STEPLIGHT 1 MODULE WITH 24 3000K LEDS WITH CLEAR TEMPERED GLASS LENS | 3000K LED | 300 | 0.91 | 19.54 | | |
| | S5 | 16 | LITHONIA | WDGE2 LED P1 30K 80CRI VW VOLTAGE SRM NLTAIR2 PIR FINISH | WDGE LED WALLPACK VISUAL COMFORT OPTIC WIDE | 3000K LED | 1163 | 0.91 | 10.0002 | | |
| | S6 | 13 | LITHONIA | WDGE2 LED P2 30K 80CRI VW VOLTAGE SRM NLTAIR2 PIR FINISH | WDGE LED WALLPACK VISUAL COMFORT OPTIC WIDE | 3000K LED | 1872 | 0.91 | 15.0178 | | |
| | S7 | 10 | LUMINAIRE LED | APX13 NODIM 25W 30K VOLTAGE FCL FINISH SHCAB | 13" ROUND SURFACE MOUNT LUMINAIRE WITH FLAT FULL CUTOFF VANDAL RESISTANCE LENSE. | 3000K LED | 2523 | 0.91 | 25.3 | | |

| Statistics | | | | | | | | |
|------------------------|--------|--------|---------|--------|---------|---------|--|--|
| Description | Symbol | Avg | Max | Min | Max/Min | Avg/Min | | |
| BASEMENT | + | 3.7 fc | 9.5 fc | 0.9 fc | 10.6:1 | 4.1:1 | | |
| GROUND FLR | + | 5.5 fc | 51.6 fc | 1.0 fc | 51.6:1 | 5.5:1 | | |
| GROUND FLR SITE FC AFG | X | 1.8 fc | 24.1 fc | 0.0 fc | N/A | N/A | | |
| TOP DECK | + | 1.6 fc | 10.8 fc | 0.1 fc | 108.0:1 | 16.0:1 | | |

PHOTOMETRIC NOTES

A. THE PHOTOMETRIC DATA ON THIS SHEET HAS BEEN REVIEWED BY THE ENGINEER FOR COMPLIANCE WITH APPLICABLE LIGHTING CODES. THE CALCULATIONS ARE PERFORMED BY LIGHTING SUPPLIER AND THE ENGINEER'S REVIEW IS NOT A GUARANTEE OF PERFORMANCE. SUBSTITUTIONS TO ANY FIXTURE WILL REQUIRE UPDATED PHOTOMETRICS WHICH WILL BE THE RESPONSIBILITY OF THE CONTRACTOR. THE FIXTURE SCHEDULE SHOWN ON THIS SHEET IS FOR CALCULATION PURPOSES ONLY. DO NOT USE AS A BILL—OF—MATERIAL. REFER TO THE PROJECT

NOTICE OF EXTENDED PAYMENT PROVISION


FIXTURE SCHEDULE.

(PER ARS 32-1129.01) THIS CONTRACT ALLOWS
THE OWNER TO MAKE PAYMENT WITHIN 15 DAYS
AFTER CERTIFICATION AND APPROVALS OF
BILLINGS AND ESTIMATES FOR PROGRESS
PAYMENTS, WITHIN 15 DAYS AFTER CERTIFICATION
AND APPROVALS OF BILLINGS AND ESTIMATES
FOR RELEASE OF RETENTION AND WITHIN 15
DAYS AFTER CERTIFICATION AND APPROVAL OF
BILLINGS AND ESTIMATES FOR FINAL PAYMENT.





JOB NUMBER 20-019

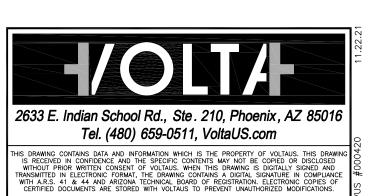

Symbol Revisions

Date Appr.

Designed by:
WB

Date:
27 December 2021

Drawn by:

ETS/PB/DT AS NOTED

Checked by:
WB

Project Code:
GLA PROJECT
NO. 20109

gabor lorant architects

3326 n. 3rd avenue suite 200
phoenix, arizona 85013
tel: 602.667.9090

fax: 602.667.9133

gaborlorant.com





CITY OF SEDONA
PUBLIC WORKS DEPARTMENT
102 ROADRUNNER DRIVE
SEDONA, ARIZONA 86336
928-204-7111

Uptown Sedona
Parking Facility
Detailed Design
Photometric Site Plan

THIS SHEET, ADJUST SCALES ACCORDINGLY

SHEET ID

e1.1

VERIFY SCALES

BAR IS ONE INCH ON

ORIGINAL DRAWING

0

IF NOT ONE INCH ON

×3.0 × 0.8 × 0.1

 $\hat{0}.8$ $\hat{0}.3$ $\hat{0}.1$

0.4 0.4 0.2 0.1

 $\frac{\hat{5.3}}{3.1}$ $\hat{0.4}$ $\hat{0.1}$

_0.4 / ^0.2 ^0.1

× 1.9 × 0.5 × 0.1

× 3.8 × 0.8 × 0.1

× × × 0.4 × 0.1

 $^{+}$ 5.5 $_{83}$ $^{-}$ 50 $^{+}$ 2.7 $^{+}$ 3.4 $^{+}$ 5.4 0 $^{-}$ 5.1 $^{+}$ 5.1 $^{-}$ 7.1 $^{-}$ 4.5 $^{+}$ 4.2 $^{-}$ 73.9 $^{-}$

SHEET NO.

- of #

O.2 0.2 0.3 0.3 0.3 0.3 0.2 0.2 0.1 0.1 0.1

GROUND LEVEL

PHOTOMETRIC SITE PLAN

SCALE: 1"=20'-0"


PENDING


| 1.1 | + + + + + | 1.6 | 1.7 | 2.6 2.7 1.7 1.6 2.5 2.6 1.3 5.0 5.1 3.2 2.9 4.9 4.9 2.6 S3 @ 9' S3 @ 9' 5.5 5.6 3.5 3.0 5.2 5.2 2.9 |
|---|--|--|--|--|
| 2.2 4.2 3.6 | 2.6 2.6 5.2 | 3.1 +5.3 +5.6 +3.3 +3.1 +5.4 +5.6 | 3.3 ⁺ 3.1 ⁺ 5.4 ⁺ 5.6 ⁺ 3.3 ⁺ 3.1 | †5.3 |
| 4.2 ⁺ 4.3 ⁺ 4.8 5.2 S3 @99' \$534@ | 1.2 | 13.3 15.5 Sign 9' 3.6 13.3 15.5 Sign 9' 2.3 4.1 4.2 2.5 2.3 4.1 4.2 | ⁺ 3.6 | +5.4 O S3 @ 9' -4.0 |
| 4.6 4.3 4.8 | 7.6 S7 @ 9' S7 @ 9' | PENDING | + + + + + + | 8.0 4.7 4.2 4.3 S7 @ 9' S7 @ 9' |
| _ | 6.0 6.1 4.9 2.5 1.4 9 9 1.3 2.9 4.9 6.0 6.1 6.0 6.1 4.9 6.0 6.1 6.0 6. | 1,3 2.0 2.0 1.3 1.3 2.0 2.1 2.5 4.4 4.6 2.8 2.6 4.6 4.7 0 S3@9' + + + + S3@9' 2.9 4.8 5.0 3.2 3.1 5.3 5.5 | ⁺ 2.9 | 2.5 5.5 5.9 5.5 5.0 4.6 4.7 4.8 5.2 3.2 1.4 5.\$3 @ \$5.0 S3 @ 9' + 5.4 5.5 3.1 1.3 4.4 3.9 3.7 |
| 2.3 4.7 4.2 | 2.8 2.5 4.7 4.9 2.8 | ⁺ 2.2 ⁺ 3.3 ⁺ 3.1 ⁺ 2.1 ⁺ 2.5 ⁺ 4.7 ⁺ 5.0 | ⁺ 3.0 | ⁺ 4.8 |
| 1.9 | 9' 0 83 0 9' | 2.7 7.8 1.9 1.8 2.7 5.2 5.4 S3 @ 9' | 3.4 | 5.3 5.4 3.3 3.0 5.1 5.2 2.8 53 @ 9' 54.8 4.9 3.0 2.7 4.6 4.7 2.4 |


LOWER LEVEL


PHOTOMETRIC SITE PLAN

SCALE: 1"=20'-0"

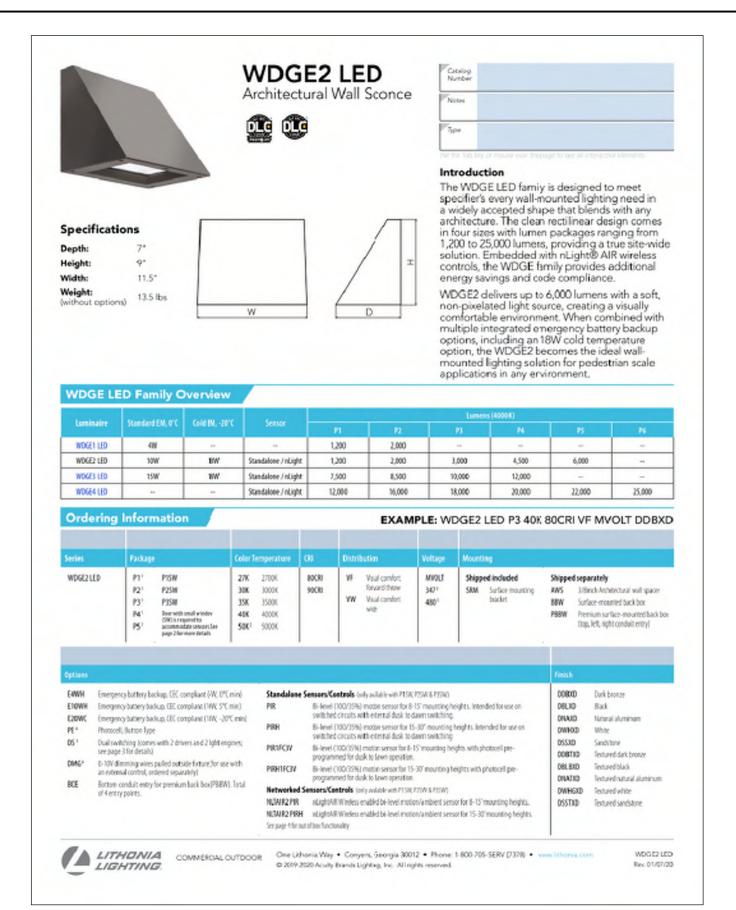

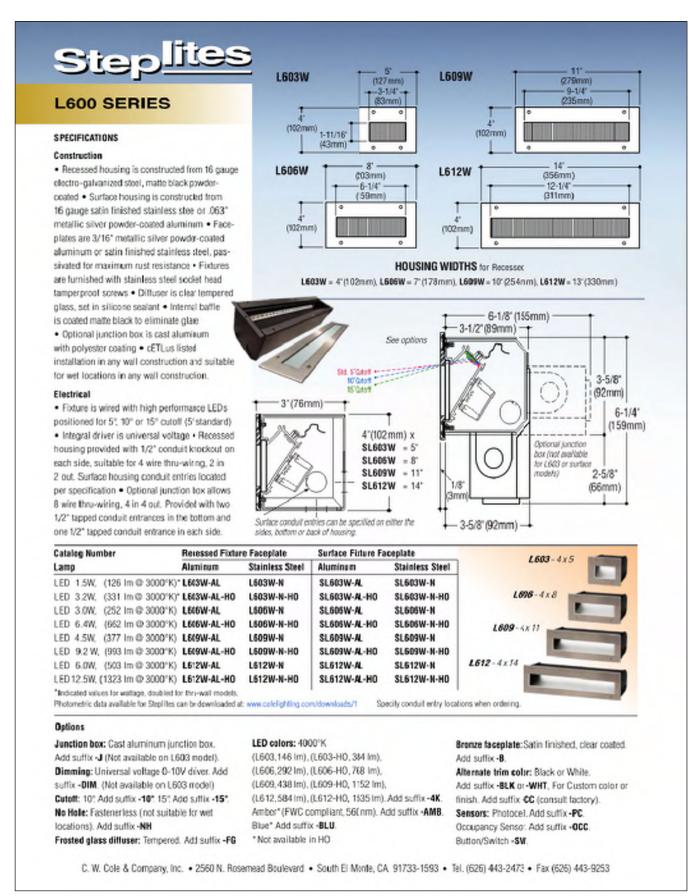

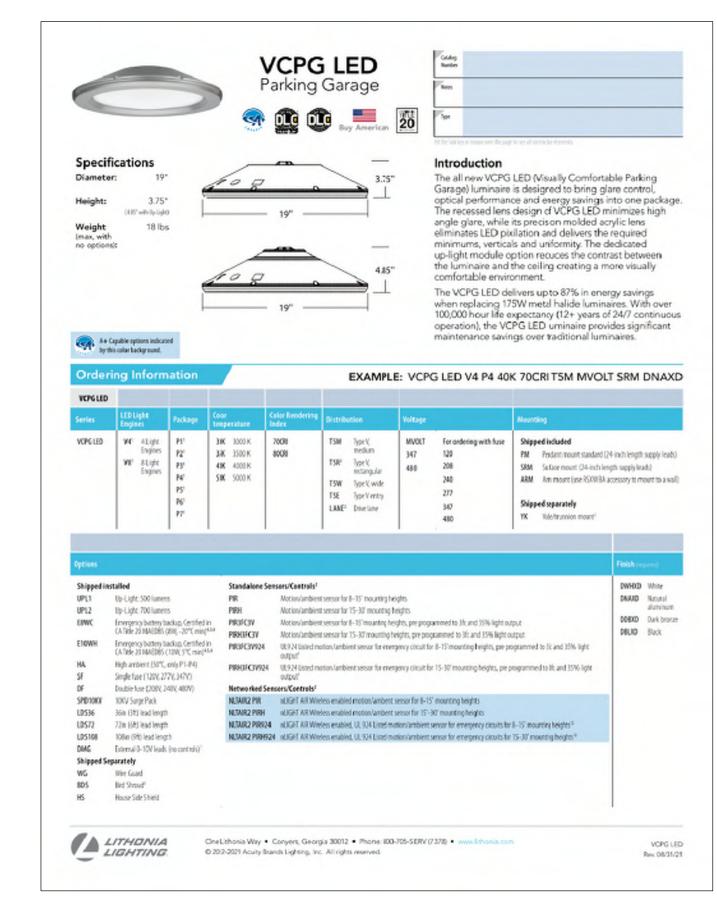


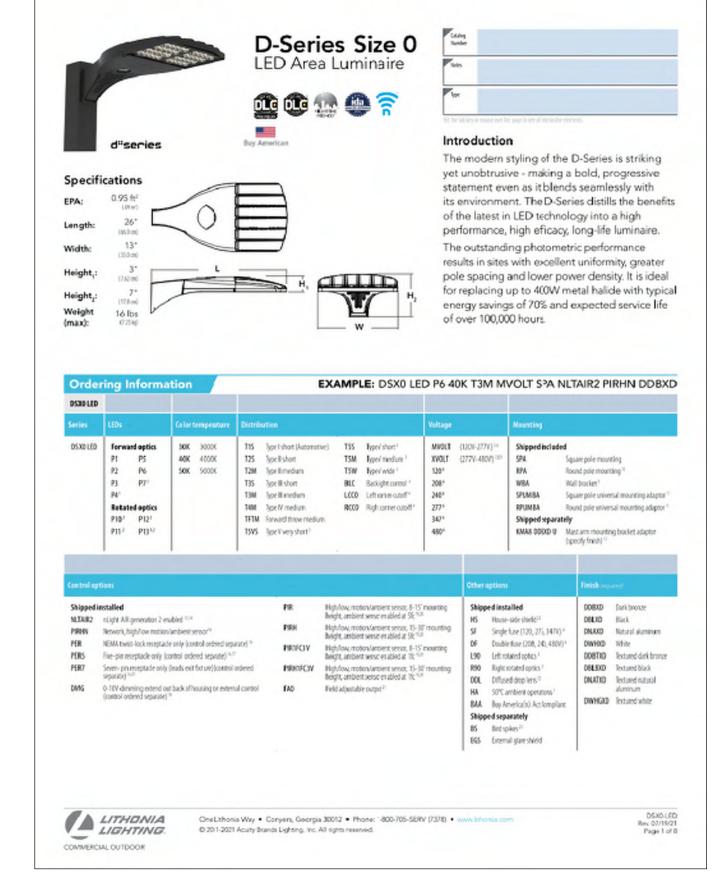








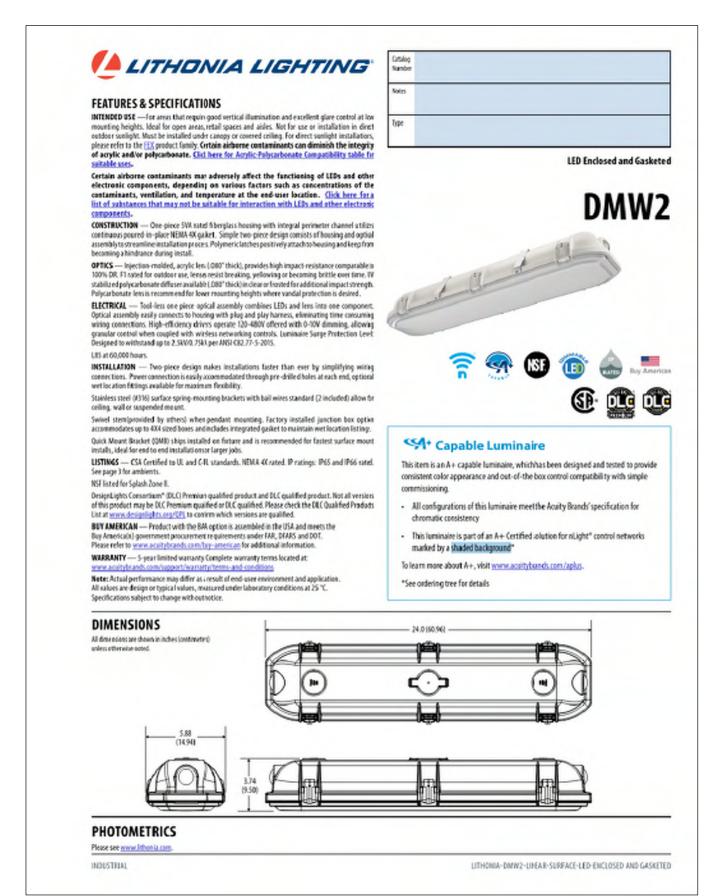



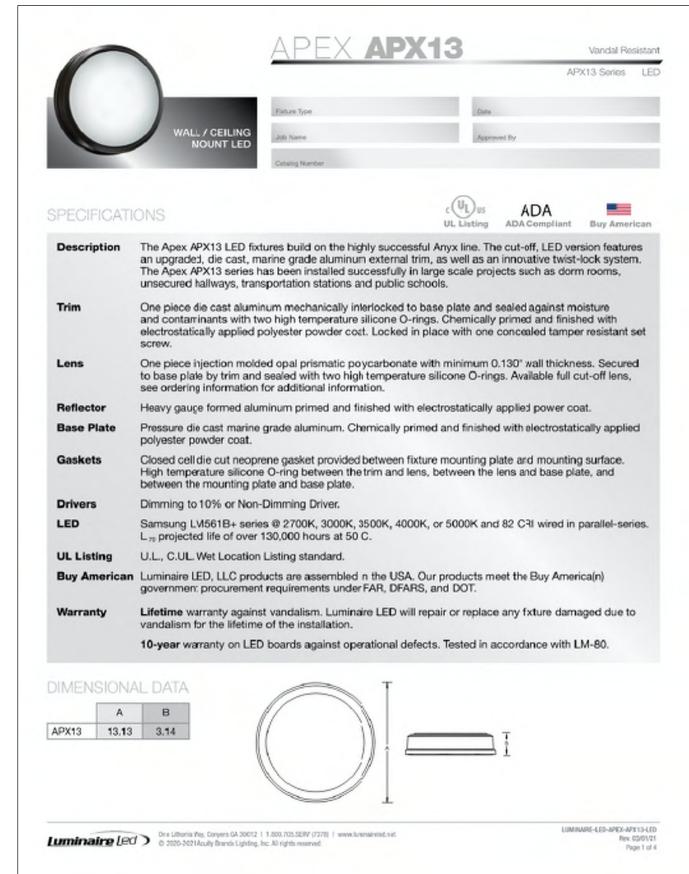


NOTICE OF EXTENDED PAYMENT PROVISION

(PER ARS 32-1129.01) THIS CONTRACT ALLOWS THE OWNER TO MAKE PAYMENT WITHIN 15 DAYS AFTER CERTIFICATION AND APPROVALS OF BILLINGS AND ESTIMATES FOR PROGRESS PAYMENTS, WITHIN 15 DAYS AFTER CERTIFICATION AND APPRÓVALS OF BILLINGS AND ESTIMATES FOR RELEASE OF RETENTION AND WITHIN 15 DAYS AFTER CERTIFICATION AND APPROVAL OF BILLINGS AND ESTIMATES FOR FINAL PAYMENT.





JOB NUMBER 20-019

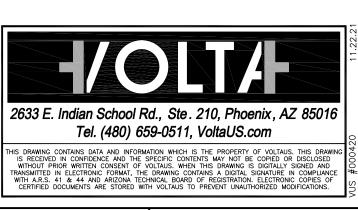

| | STATE LOTHWATEST STATEMENT. | | | 000 1101110211 20 010 | |
|--------|-----------------------------|------|-------|-----------------------|------------------------------|
| Symbol | Revisions | Date | Appr. | Designed by: WB | Date: 27 December 2021 |
| | | | | | Scale: |
| | | | | ETS/PB/DT | AS NOTED |
| | | | | | Project Code: GLA PROJECT |
| | | | | WB | NO. 20109 |

gabor lorant architects 3326 n. 3rd avenue suite 200 phoenix, arizona 85013 tel: 602.667.9090 fax: 602.667.9133 gaborlorant.com

6 FIXTURE TYPE 'S8'

NO SCALE



CITY OF SEDONA PUBLIC WORKS DEPARTMENT **102 ROADRUNNER DRIVE SEDONA, ARIZONA 86336** 928-204-7111

5 FIXTURE TYPE 'S7'

Uptown Sedona Parking Facility Detailed Design Site Lighting Cutsheets

0 IF NOT ONE INCH ON THIS SHEET, ADJUST SCALES ACCORDINGLY SHEET ID


VERIFY SCALES

BAR IS ONE INCH ON

ORIGINAL DRAWING

SHEET NO.

- of #

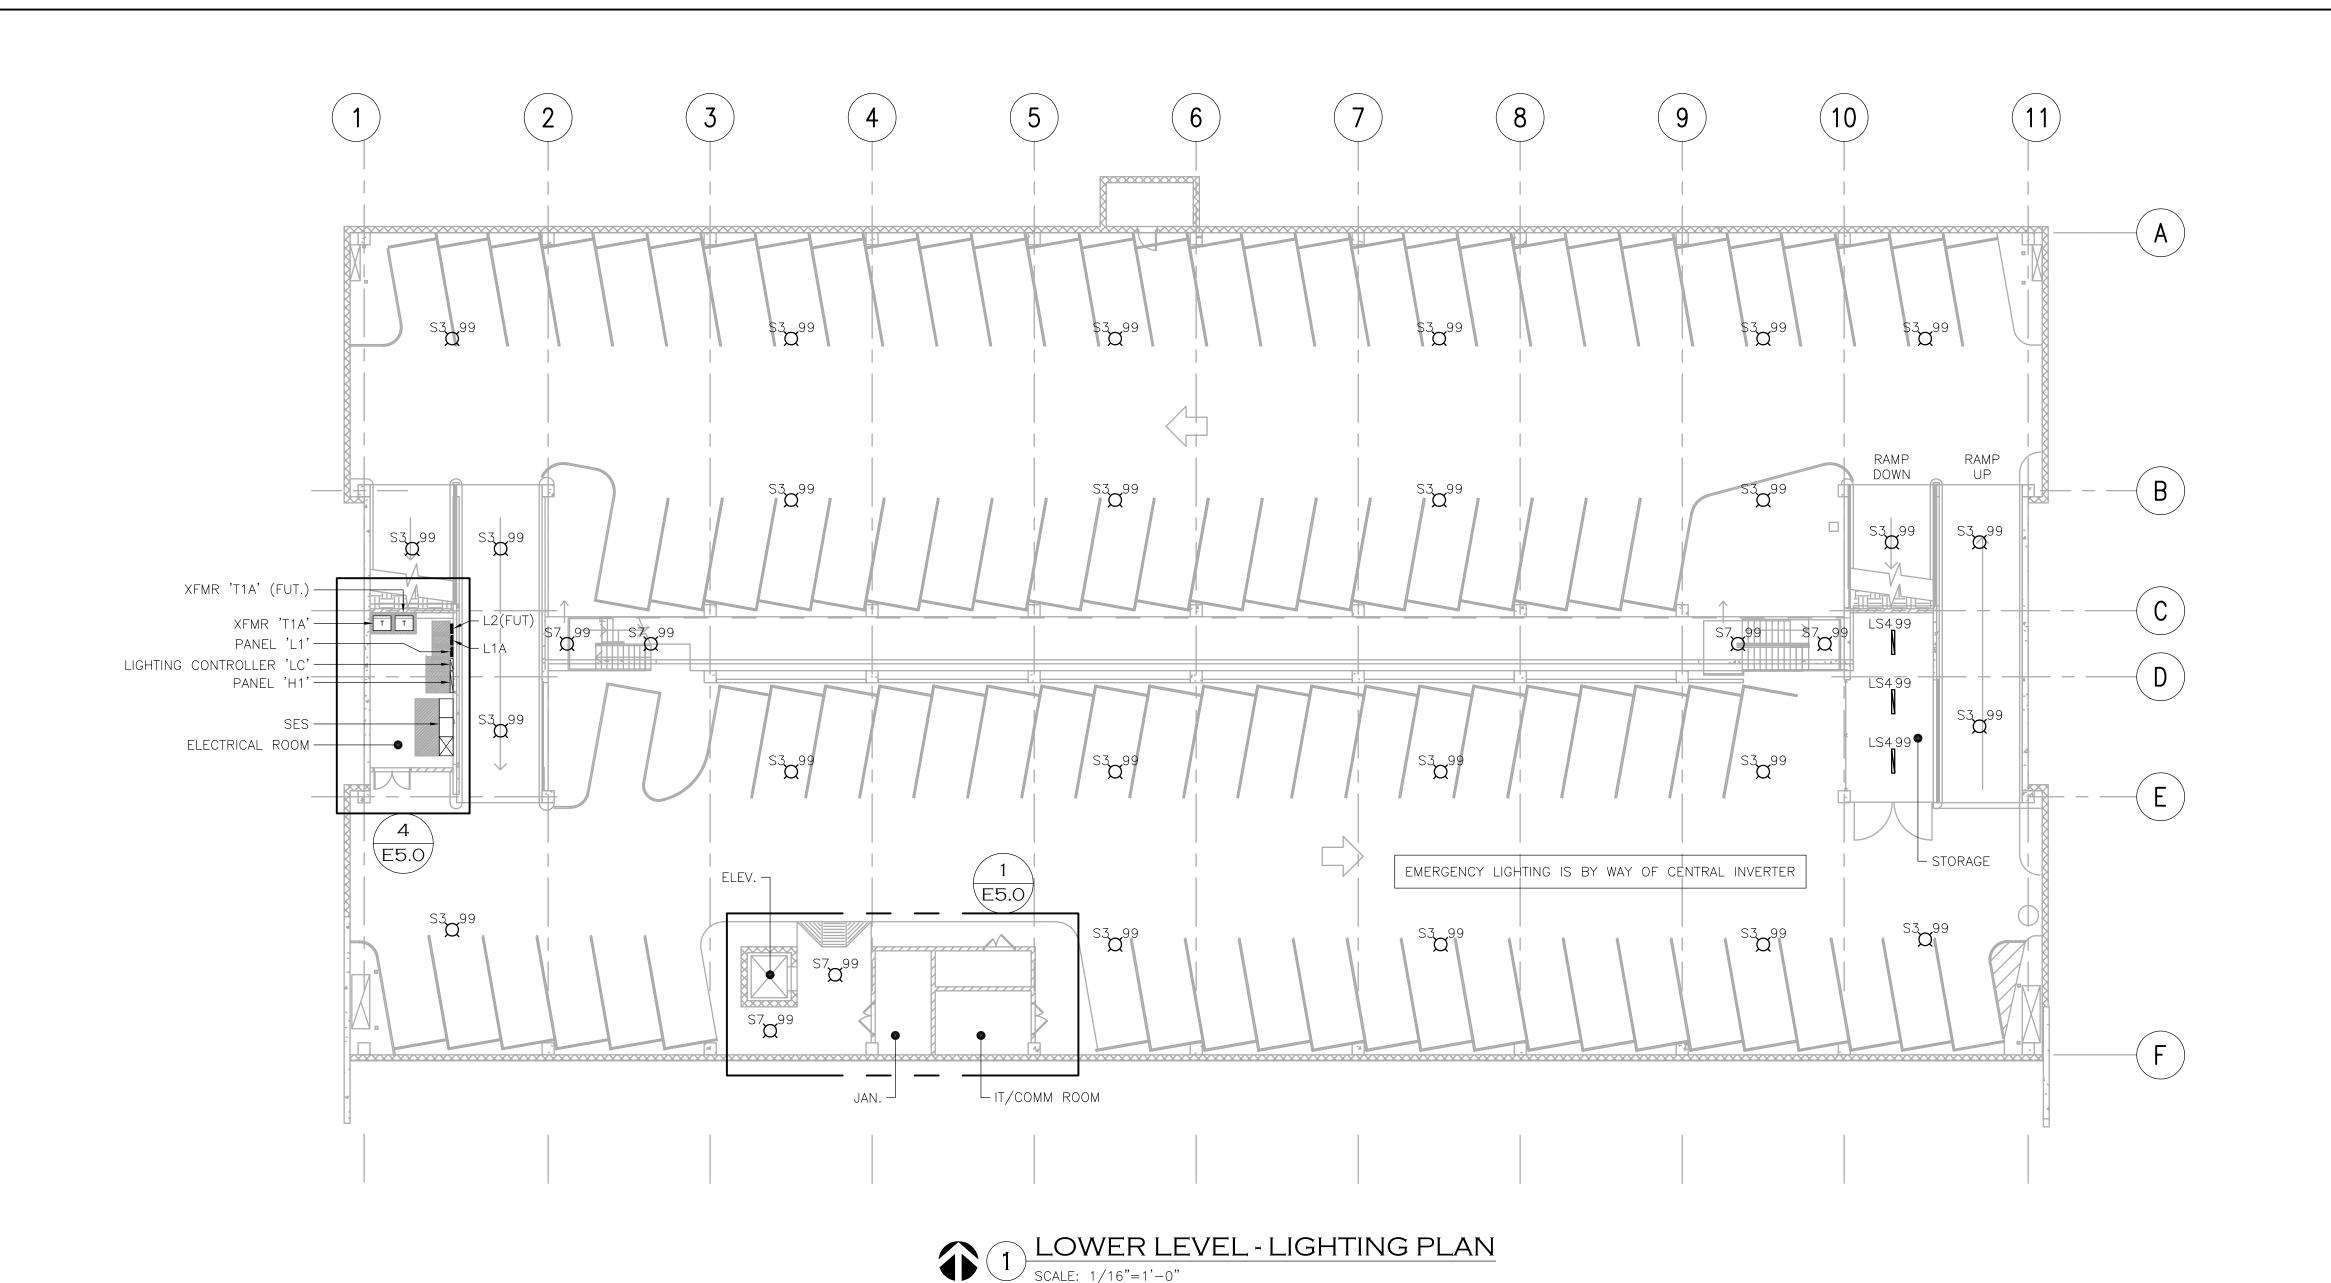

GENERAL NOTES


- A. EMERGENCY AND EXIT SIGNS SHALL BE CONNECTED TO A NON-SWITCHED LEG OF THE NEAREST BRANCH LIGHTING CIRCUIT, 2#12, 1#12G UNLESS NOTED OTHERWISE. REFER TO LEGEND FOR EMERGENCY LIGHT FIXTURE SYMBOLS.
- B. FIXTURES DESIGNATED AS NIGHT LIGHTS SHALL BE SUPPLIED FROM A NON-SWITCHED LEG OF THE BRANCH LIGHTING CIRCUIT FOR ONE BALLAST OF EACH NIGHT LIGHT FIXTURE. IN MANY CASES, EMERGENCY FIXTURES WILL BE DESIGNATED AS NIGHT LIGHTS FOR CONVENIENCE.
- C. IN GENERAL, NON-SWITCHED LEGS FOR NIGHT LIGHTS AND EMERGENCY LIGHTS AND TRAVELER CONDUCTORS FOR 3-WAY SWITCHING ARE NOT SHOWN ON THE PLANS. INSTALL THESE CONDUCTORS AS REQUIRED FOR PROPER OPERATION OF THE LIGHT FIXTURES.
- D. INSTALL FLEXIBLE CONDUIT CONNECTIONS TO FIXTURES (NOT TO EXCEED 6' IN LENGTH) WHEN NECESSARY.
- E. WHEN LIGHTING CONTROL DEVICES ARE INDICATED ON PLANS AND DETAILS, THE CONTRACTOR SHALL INSTALL ANY ASSOCIATED CONTROL WIRING REQUIRED FOR A COMPLETE AND OPERATIONAL SYSTEM.
- F. CONCEAL CONDUITS IN ALL FINISHED AREAS INCLUDING CONCEALMENT WITHIN MASONRY WALLS WHEN PRESENT. (EXCEPTION: ELECTRICAL, MECHANICAL, AND JANITOR ROOMS).
 - WHEN OVERHEAD ELECTRICAL WORK IS EXPOSED: MOUNTING OF ALL ELECTRICAL WORK/CONDUIT SHALL RUN TIGHT WITH DECK IN A CLEAN AND WORKMAN LIKE MANNER. CONTRACTOR MAY RUN CONDUIT UNDER FLOOR AS NECESSARY TO FACILITATE CONCEALMENT OF CONDUITS.

NOTICE OF EXTENDED PAYMENT PROVISION

(PER ARS 32-1129.01) THIS CONTRACT ALLOWS THE OWNER TO MAKE PAYMENT WITHIN 15 DAYS AFTER CERTIFICATION AND APPROVALS OF BILLINGS AND ESTIMATES FOR PROGRESS PAYMENTS, WITHIN 15 DAYS AFTER CERTIFICATION AND APPROVALS OF BILLINGS AND ESTIMATES FOR RELEASE OF RETENTION AND WITHIN 15 DAYS AFTER CERTIFICATION AND APPROVAL OF BILLINGS AND ESTIMATES FOR FINAL PAYMENT.



ENGINEERING 2800 S. RURAL RD. SUITE 101 TEMPE, AZ 85282 (480)968 3070 JOB NUMBER 20-019

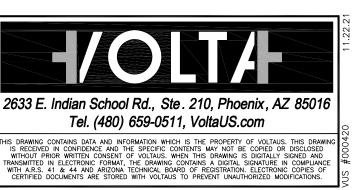


gabor lorant architects

3326 n. 3rd avenue suite 200 phoenix, arizona 85013 tel: 602.667.9090 fax: 602.667.9133

gaborlorant.com



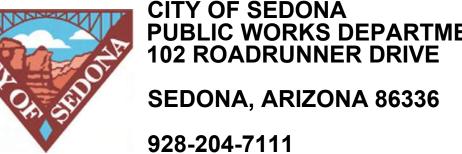

Uptown Sedona Parking Facility Detailed Design Lower Level -Lighting Plan

IF NOT ONE INCH ON THIS SHEET, ADJUST SCALES ACCORDINGLY SHEET ID e3.0


VERIFY SCALES

BAR IS ONE INCH ON


0

ORIGINAL DRAWING

SHEET NO. - of #

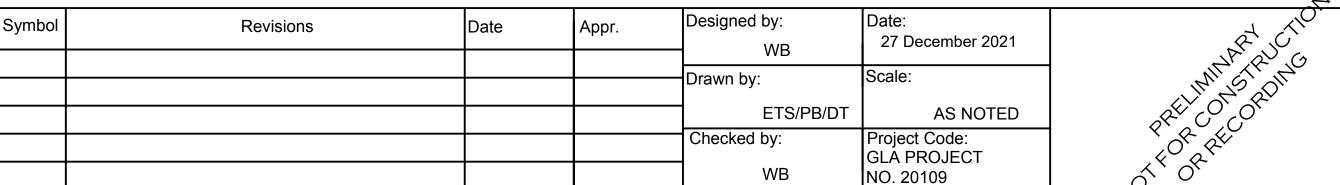

CITY OF SEDONA PUBLIC WORKS DEPARTMENT 102 ROADRUNNER DRIVE

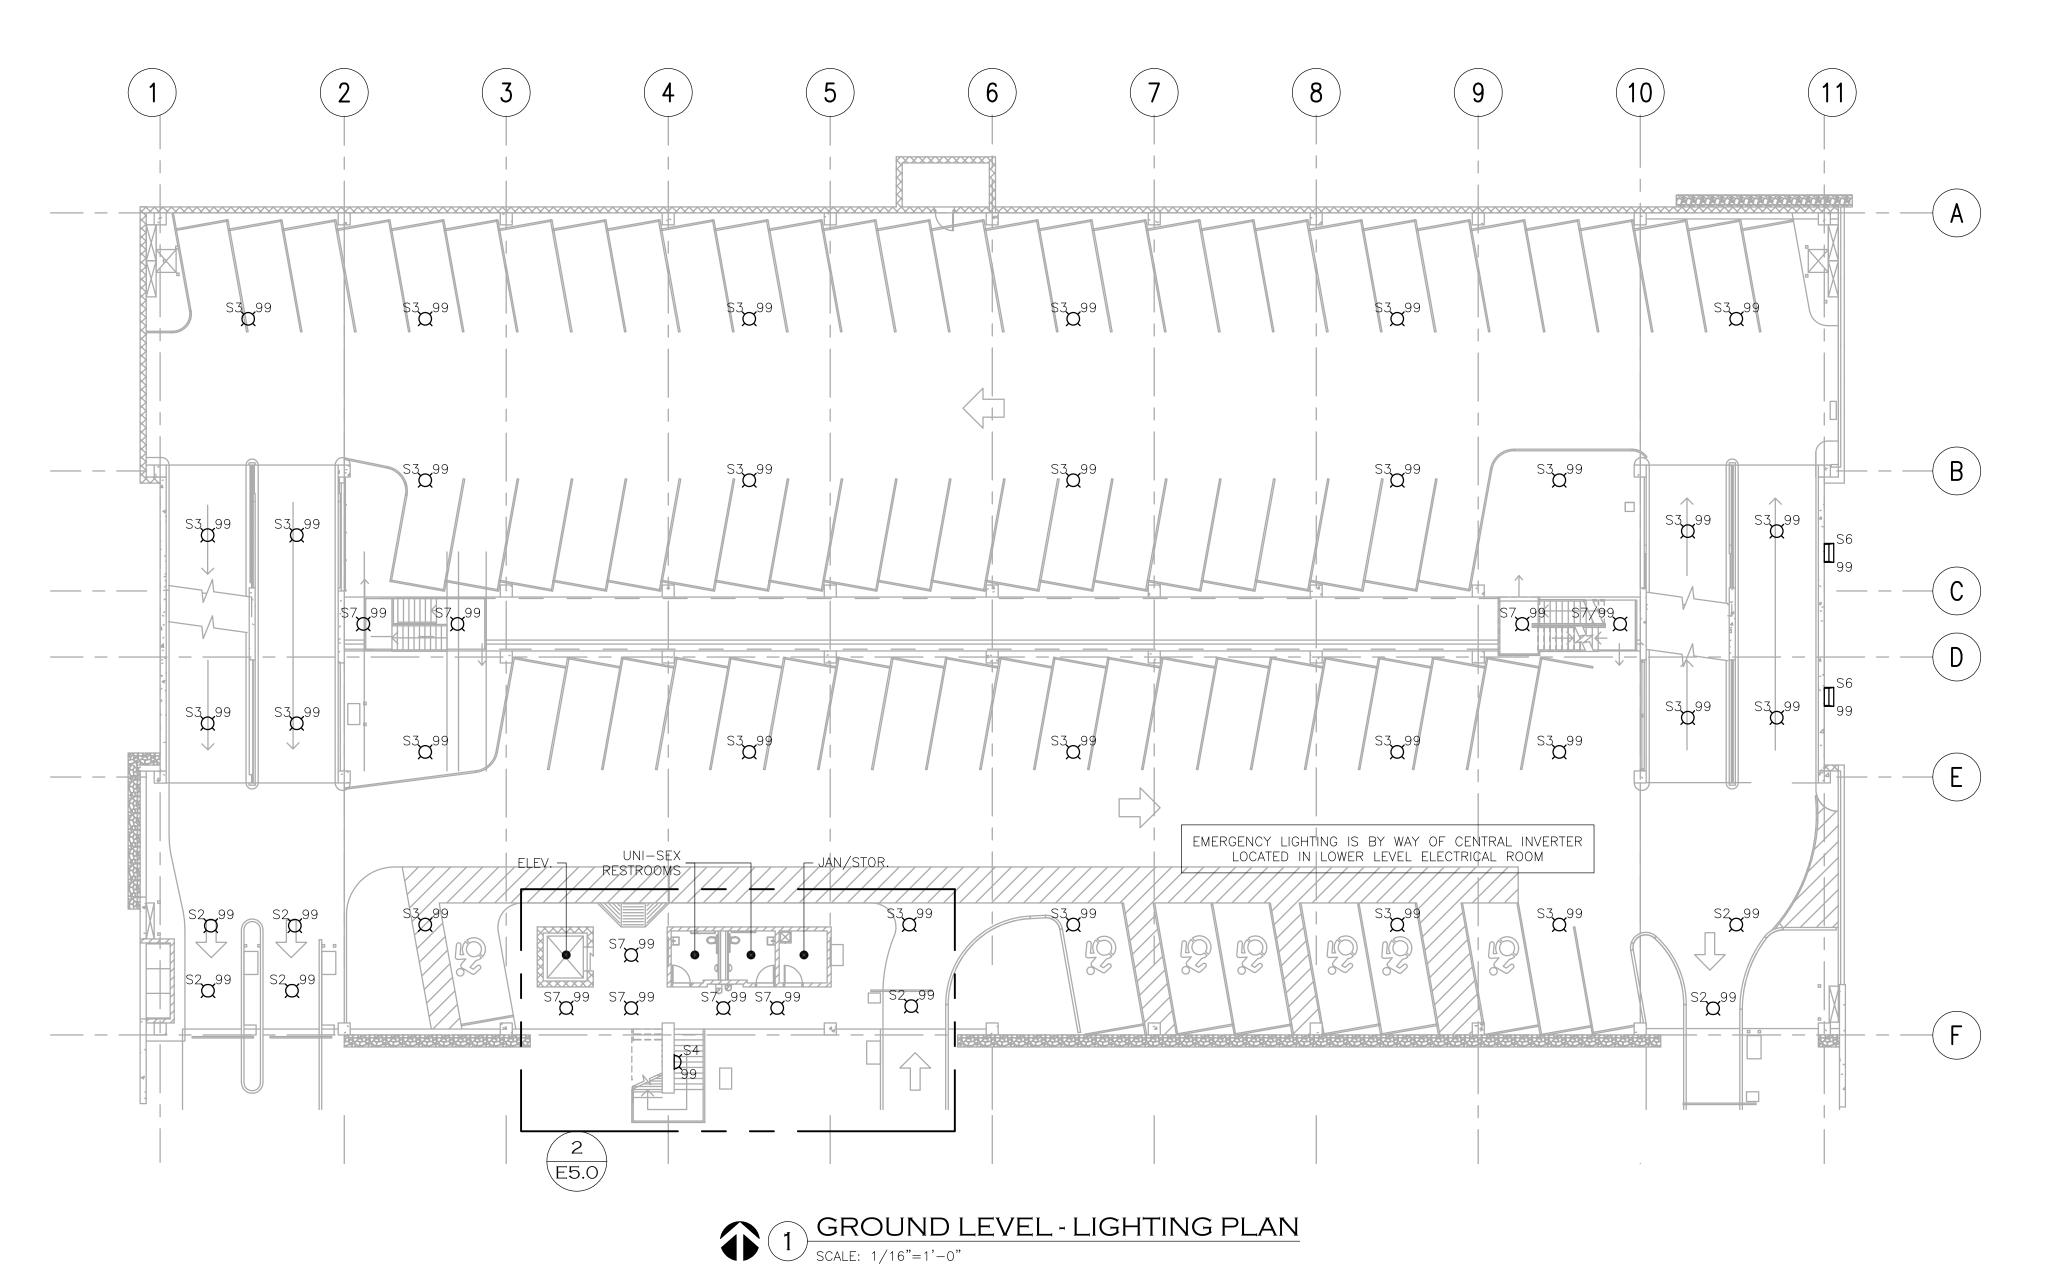

GENERAL NOTES

- A. EMERGENCY AND EXIT SIGNS SHALL BE CONNECTED TO A NON-SWITCHED LEG OF THE NEAREST BRANCH LIGHTING CIRCUIT, 2#12, 1#12G UNLESS NOTED OTHERWISE. REFER TO LEGEND FOR EMERGENCY LIGHT FIXTURE SYMBOLS.
- B. FIXTURES DESIGNATED AS NIGHT LIGHTS SHALL BE SUPPLIED FROM A NON-SWITCHED LEG OF THE BRANCH LIGHTING CIRCUIT FOR ONE BALLAST OF EACH NIGHT LIGHT FIXTURE. IN MANY CASES, EMERGENCY FIXTURES WILL BE DESIGNATED AS NIGHT LIGHTS FOR CONVENIENCE.
- C. IN GENERAL, NON-SWITCHED LEGS FOR NIGHT LIGHTS AND EMERGENCY LIGHTS AND TRAVELER CONDUCTORS FOR 3-WAY SWITCHING ARE NOT SHOWN ON THE PLANS. INSTALL THESE CONDUCTORS AS REQUIRED FOR PROPER OPERATION OF THE LIGHT FIXTURES.
- D. INSTALL FLEXIBLE CONDUIT CONNECTIONS TO FIXTURES (NOT TO EXCEED 6' IN LENGTH) WHEN NECESSARY.
- E. WHEN LIGHTING CONTROL DEVICES ARE INDICATED ON PLANS AND DETAILS, THE CONTRACTOR SHALL INSTALL ANY ASSOCIATED CONTROL WIRING REQUIRED FOR A COMPLETE AND OPERATIONAL SYSTEM.
- F. CONCEAL CONDUITS IN ALL FINISHED AREAS INCLUDING CONCEALMENT WITHIN MASONRY WALLS WHEN PRESENT. (EXCEPTION: ELECTRICAL, MECHANICAL, AND JANITOR ROOMS).
- WHEN OVERHEAD ELECTRICAL WORK IS EXPOSED: MOUNTING OF ALL ELECTRICAL WORK/CONDUIT SHALL RUN TIGHT WITH DECK IN A CLEAN AND WORKMAN LIKE MANNER. CONTRACTOR MAY RUN CONDUIT UNDER FLOOR AS NECESSARY TO FACILITATE CONCEALMENT OF CONDUITS.

VERIFY SCALES

BAR IS ONE INCH ON

ORIGINAL DRAWING

0

NOTICE OF EXTENDED PAYMENT PROVISION


(PER ARS 32-1129.01) THIS CONTRACT ALLOWS THE OWNER TO MAKE PAYMENT WITHIN 15 DAYS AFTER CERTIFICATION AND APPROVALS OF BILLINGS AND ESTIMATES FOR PROGRESS PAYMENTS, WITHIN 15 DAYS AFTER CERTIFICATION AND APPROVALS OF BILLINGS AND ESTIMATES FOR RELEASE OF RETENTION AND WITHIN 15 DAYS AFTER CERTIFICATION AND APPROVAL OF



ENGINEERING



| DAYS AF | EASE OF RETENTION AND WITHIN 15 FER CERTIFICATION AND APPROVAL OF AND ESTIMATES FOR FINAL PAYMENT. | Call 611 or click Ariz | | 300 S. RURAL RD. SUITE MPE, AZ 85282 (480)968 3 JOB NUMBER 20-019 | 1 O 1 IS RECEIVED IN CONFIDENCE AND THE SPECIFIC WITHOUT PRIOR WRITTEN CONSENT OF VOLTAUS. TRANSMITTED IN ELECTRONIC FORMAT, THE DRAWIN WITH A.R.S. 41 & 44 AND ARIZONA TECHNICAL E CERTIFIED DOCUMENTS ARE STORED WITH VOLTA | C CONTENTS MAY NOT BE COPIED OR DISCLOSED S. WHEN THIS DRAWING IS DIGITALLY SIGNED AND NG CONTAINS A DIGITAL SIGNATURE IN COMPLIANCE BOARD OF REGISTRATION. ELECTRONIC COPIES OF AUS TO PREVENT UNAUTHORIZED MODIFICATIONS. | | | | | IF NOT ONE INCH ON THIS SHEET, ADJUST SCALES ACCORDINGLY |
|---------|--|------------------------|-------|---|---|---|--|----------|--|--------------------------------|--|
| Symbol | Revisions | Date | Appr. | Designed by: | Date: 27 December 2021 | \$7.C110. | gabor lorant architects | | CITY OF SEDONA | Uptown Sedona | SHEET ID |
| | | | | Drawn by: | Scale: | MARIANA | 3326 n. 3rd avenue suite 200 | C. T. | PUBLIC WORKS DEPARTMENT 102 ROADRUNNER DRIVE | Parking Facility | e3.1 |
| | | | | ETS/PB/DT Checked by: | AS NOTED Project Code: | PRELITOR PROPERTY. | phoenix, arizona 85013 tel: 602.667.9090 fax: 602.667.9133 | OF CEIDO | SEDONA, ARIZONA 86336 | Detailed Design Ground Level - | SHEET NO. |
| | | | | WB | GLÁ PROJECT NO. 20109 | of of the | gaborlorant.com | | 928-204-7111 | Lighting Plan | - of # |

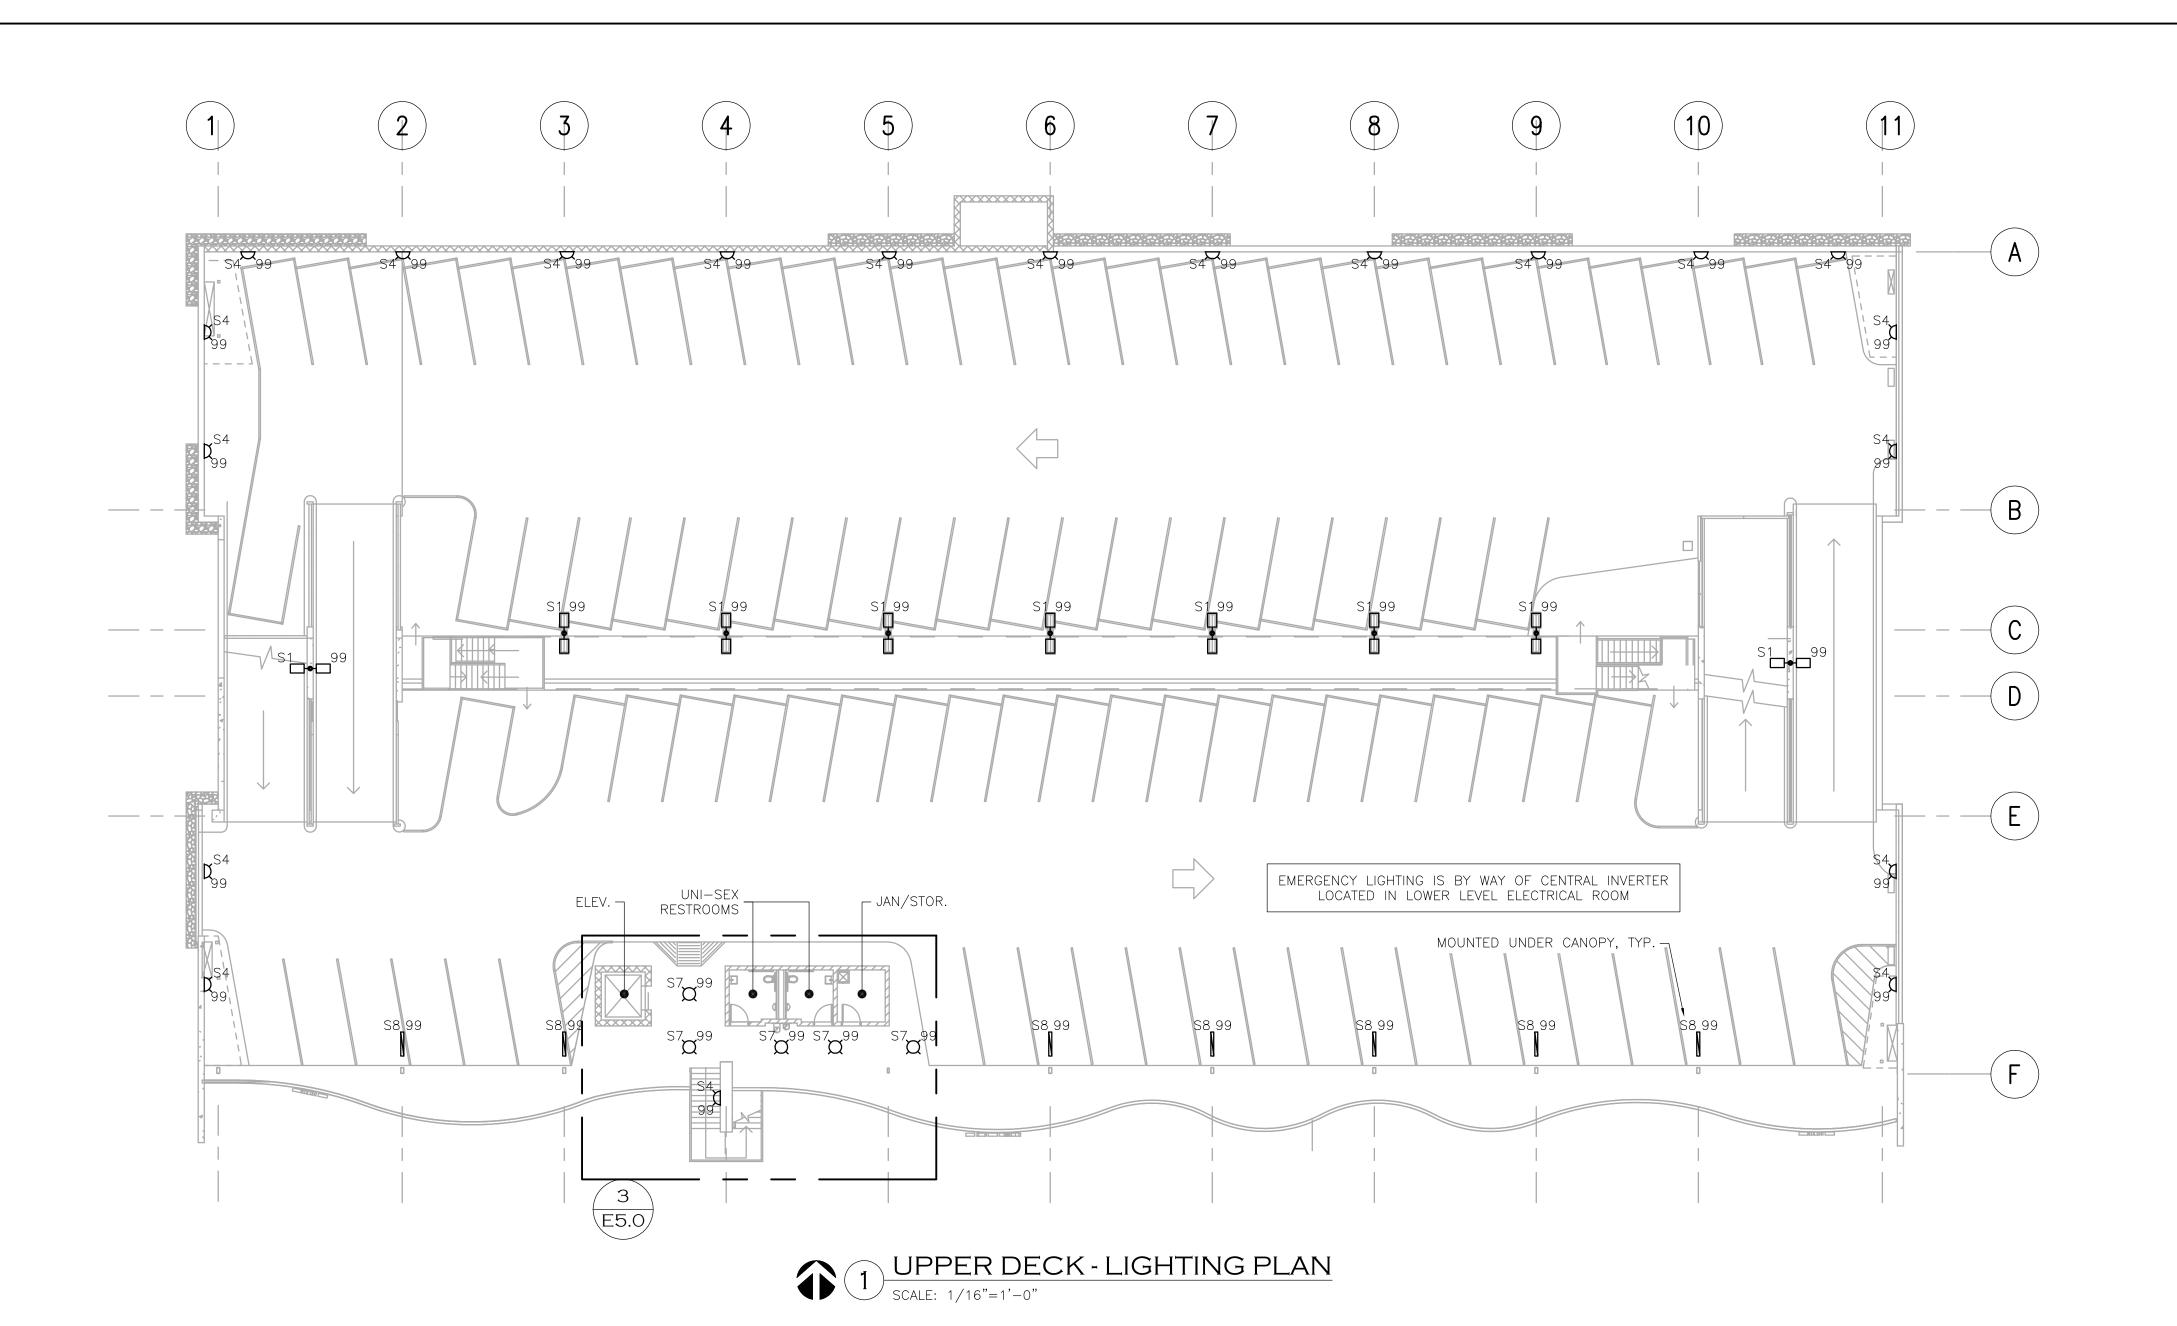

GENERAL NOTES

- A. EMERGENCY AND EXIT SIGNS SHALL BE CONNECTED TO A NON-SWITCHED LEG OF THE NEAREST BRANCH LIGHTING CIRCUIT, 2#12, 1#12G UNLESS NOTED OTHERWISE. REFER TO LEGEND FOR EMERGENCY LIGHT FIXTURE SYMBOLS.
- B. FIXTURES DESIGNATED AS NIGHT LIGHTS SHALL BE SUPPLIED FROM A NON-SWITCHED LEG OF THE BRANCH LIGHTING CIRCUIT FOR ONE BALLAST OF EACH NIGHT LIGHT FIXTURE. IN MANY CASES, EMERGENCY FIXTURES WILL BE DESIGNATED AS NIGHT LIGHTS FOR CONVENIENCE.
- C. IN GENERAL, NON-SWITCHED LEGS FOR NIGHT LIGHTS AND EMERGENCY LIGHTS AND TRAVELER CONDUCTORS FOR 3-WAY SWITCHING ARE NOT SHOWN ON THE PLANS. INSTALL THESE CONDUCTORS AS REQUIRED FOR PROPER OPERATION OF THE LIGHT FIXTURES.
- D. INSTALL FLEXIBLE CONDUIT CONNECTIONS TO FIXTURES (NOT TO EXCEED 6' IN LENGTH) WHEN NECESSARY.
- E. WHEN LIGHTING CONTROL DEVICES ARE INDICATED ON PLANS AND DETAILS, THE CONTRACTOR SHALL INSTALL ANY ASSOCIATED CONTROL WIRING REQUIRED FOR A COMPLETE AND OPERATIONAL SYSTEM.
- F. CONCEAL CONDUITS IN ALL FINISHED AREAS INCLUDING CONCEALMENT WITHIN MASONRY WALLS WHEN PRESENT. (EXCEPTION: ELECTRICAL, MECHANICAL, AND JANITOR ROOMS).

WHEN OVERHEAD ELECTRICAL WORK IS EXPOSED: MOUNTING OF ALL ELECTRICAL WORK/CONDUIT SHALL RUN TIGHT WITH DECK IN A CLEAN AND WORKMAN LIKE MANNER. CONTRACTOR MAY RUN CONDUIT UNDER FLOOR AS NECESSARY TO FACILITATE CONCEALMENT OF CONDUITS.

NOTICE OF EXTENDED PAYMENT PROVISION

Symbol |

(PER ARS 32-1129.01) THIS CONTRACT ALLOWS THE OWNER TO MAKE PAYMENT WITHIN 15 DAYS AFTER CERTIFICATION AND APPROVALS OF BILLINGS AND ESTIMATES FOR PROGRESS PAYMENTS, WITHIN 15 DAYS AFTER CERTIFICATION AND APPROVALS OF BILLINGS AND ESTIMATES FOR RELEASE OF RETENTION AND WITHIN 15 DAYS AFTER CERTIFICATION AND APPROVAL OF BILLINGS AND ESTIMATES FOR FINAL PAYMENT.

Revisions




Appr.

APPLIED **ENGINEERING** 2800 S. RURAL RD. SUITE 101 TEMPE, AZ 85282 (480)968 3070 JOB NUMBER 20-019

WB

Designed by:

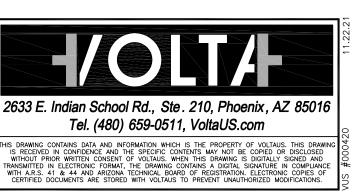

27 December 2021

gabor lorant architects





CITY OF SEDONA PUBLIC WORKS DEPARTMENT 102 ROADRUNNER DRIVE **SEDONA, ARIZONA 86336**

Uptown Sedona Parking Facility
Detailed Design
Upper Deck -

IF NOT ONE INCH ON THIS SHEET, ADJUST SCALES ACCORDINGLY SHEET ID

VERIFY SCALES

BAR IS ONE INCH ON

0

ORIGINAL DRAWING

e3.2

Scale: Drawn by: 3326 n. 3rd avenue suite 200 phoenix, arizona 85013 SHEET NO. AS NOTED ETS/PB/DT tel: 602.667.9090 fax: 602.667.9133 Checked by: Project Code: gaborlorant.com - of # GLÁ PROJECT 928-204-7111 Lighting Plan WB NO. 20109