

CITY OF SEDONA

SIM-11E NAVOTI DR TO DRY CREEK RD SUP IMPROVEMENT PLANS

LOCATED IN PORTIONS OF SECTION 10 & 15, TOWNSHIP 17 NORTH, RANGE 5 EAST, GILA AND SALT RIVER MERIDIAN, YAVAPAI COUNTY, ARIZONA.

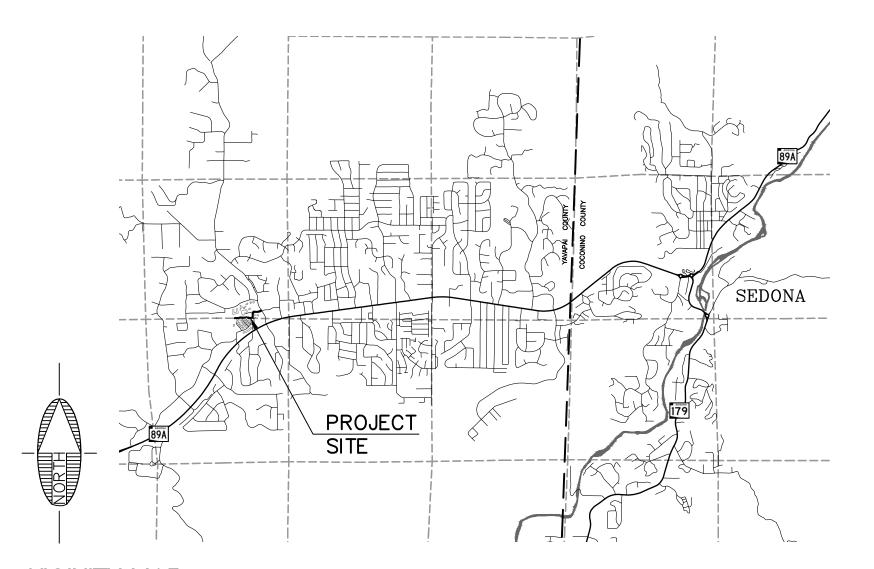

VICINITY MAP NO SCALE

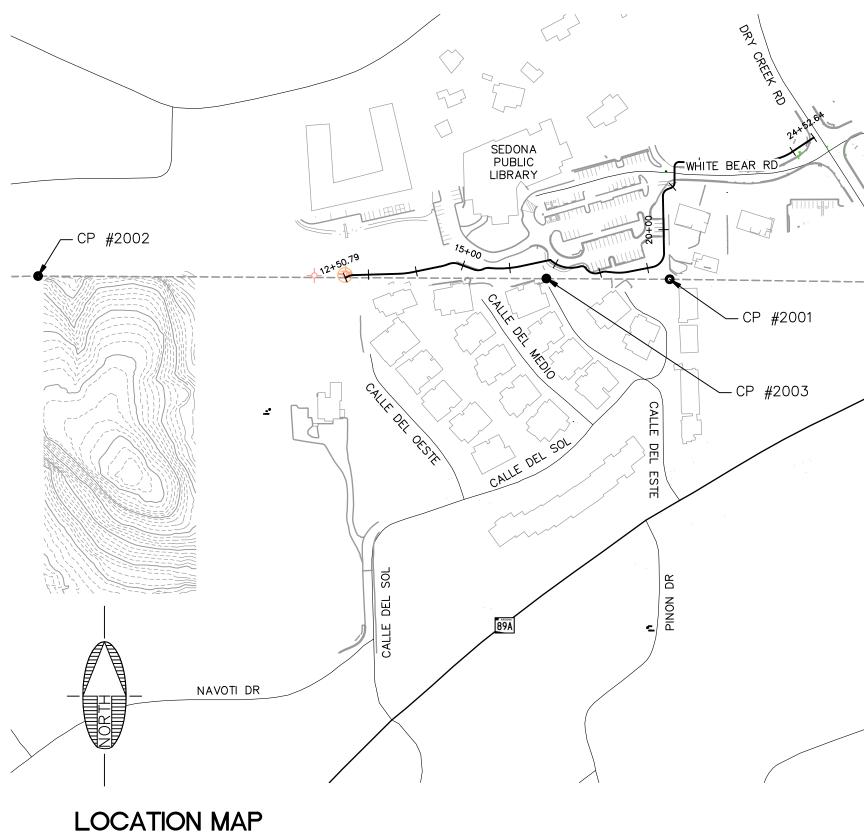

COORDINATE SYSTEM DETAILS

INTERNATIONAL FOOT GEODETIC DATUM: NAD 1983 (NSRS 2007) VERTICAL DATUM: NAVD 1988 (SEE BELOW) SYSTEM: STATE PLANE COORDINATE SYSTEM (CITY OF SEDONA)

ZONE: ARIZONA CENTRAL 0202

NO SCALE

TRANSVERSE MERCATOR LATITUDE OF GRID ORIGIN: 31°00'00" N LONGITUDE OF CENTRAL MERIDIAN: 111°55'00" W NORTHING AT GRID ORIGIN: 0.000 FT EASTING AT CENTRAL MERIDIAN: 700,000 FT CENTRAL MERIDIAN SCALE FACTOR:

ALL DISTANCES AND BEARINGS SHOWN HEREON ARE NOT GRID VALUES BUT PROJECTED FOR THE PRECEDING COORDINATE SYSTEM DEFINITION. THIS DEFINITION IS SUCH THAT GRID DISTANCES ARE NOT EQUIVALENT TO "GROUND" DISTANCES IN THE PROJECT AREA.

ORTOMETRIC HEIGHTS (ELEVATIONS) WERE TRANSFERRED TO THE SITE FROM POINT "VORTEX" (NGS PID AJ5637) USING GPS WITH NGS GEOID MODEL "GEOID12A". ELEVATIONS SHOWN HEREON ARE REFERENCED TO THE PUBLISHED ELEVATION OF THIS STATION.

THE SURVEY WAS CONDUCTED USING GPS REFERENCED TO THE NATIONAL SPATIAL REFERENCE SYSTEM, 2007 READJUSTMENT. A PARTIAL LIST OF POINT COORDINATES FOR THIS SURVEY IS GIVEN BELOW (ADDITIONAL COORDINATES ARE AVAILABLE UPON REQUEST).


POINT #2001 1 1/2" PIPE WITH BRASS TAG STAMPED "RLS 19853" (ON-SITE) N34°51'42.37486" NORTHING: 1405003.888 **EASTING:** LONGITUDE: W111°49'02.88312" 729757.233 ELLIPSOID HEIGHT: 4307.558 FT ELEVATION: 4388.033 FT

POINT #2002 REBAR AND CAP STAMPED "RLS 14184" (ON-SITE) LATITUDE: N34°51'42.45302" NORTHING: 1405010.517 LONGITUDE: W111°49'18.67372" EASTING: 728441.451 ELLIPSOID HEIGHT: 4361.241 FT ELEVATION: 4441.773 FT

☐ ARIZONA PUBLIC SERVICE	RECEIVED:
EL ADIZONA WATER COMPANY	COMPANY REPRESENTATIVE CONTACTED
☐ ARIZONA WATER COMPANY	COMPANY REPRESENTATIVE CONTACTED RECEIVED:
□ SUDDEN LINK	RECEIVED:
	COMPANY REPRESENTATIVE CONTACTED
□ UNISOURCE	COMPANY REPRESENTATIVE CONTACTED RECEIVED:
☐ CENTURY LINK	RECEIVED:
	COMPANY REPRESENTATIVE CONTACTED
☐ CITY OF SEDONA SEWER	RECEIVED:
	COMPANY REPRESENTATIVE CONTACTED

LEGEND

--- RECORD PARCEL BOUNDARIES

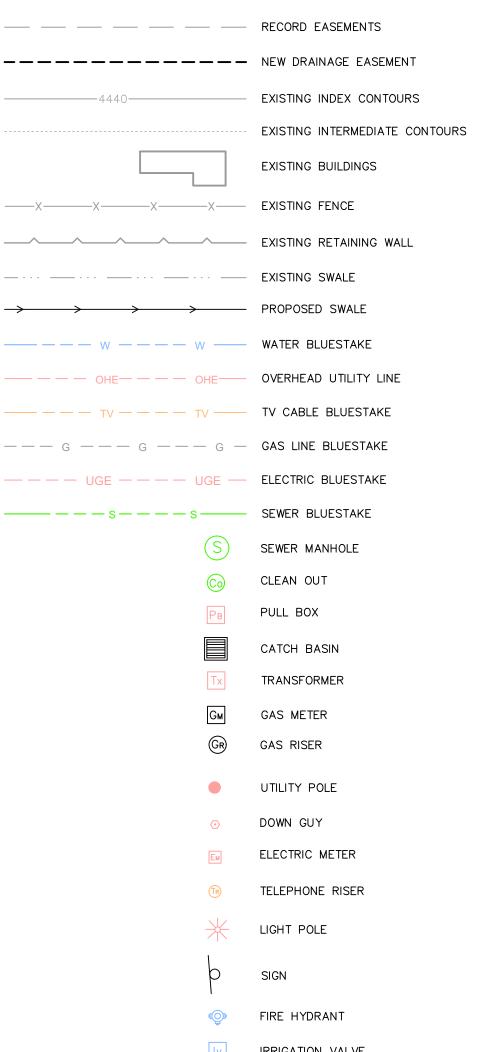

WATER RISER

CORRUGATED METAL PIPE

DECOMPOSED GRANITE

FOUND REBAR WITH CAP

MATCH EXISTING TOP OF WALL

TOP OF FOOTING

HIGH-DENSITY POLYETHYLENE

FOUND PIPE WITH BRASS TAG

CONTACT INFORMATION

CITY OF SEDONA 102 ROADRUNNER DRIVE

SEDONA, ARIZONA 86336 (928) 203-5039

J. ANDY DICKEY, P.E., ASSISTANT CITY MANAGER/DIRECTOR OF PUBLIC WORKS

MAYOR SANDY MORIARTY

CITY COUNCIL KATHY KINSELA TOM LAMIN

VICE MAYOR

HOLLI PLOOG JON THOMPSON

SCOTT JABLOW

CITY MANAGER KAREN OSBORN

ENGINEER SHEPHARD-WESNITZER, INC.

75 KALOFF PLACE SEDONA, ARIZONA 86336

(928) 282-1061 ÀRT BECKWITH, P.E.

"IN ACCORDANCE WITH AAC R18-4-119. ALL MATERIALS INSTALLED AFTER JANUARY 1, 1993, WHICH MAY COME INTO CONTACT WITH DRINKING WATER SHALL CONFORM TO NATIONAL SANITATION FOUNDATION STANDRADS 60 & 61."

SHEET INDEX			
SHT NO.	DWG NO.	TITLE	
1	C1	COVER SHEET	
2	C2	NOTES & DETAILS	
3	С3	LIBRARY PARKING DEMOLITION PLANS	
4	C4	SUP SURVEY CONTROL PLAN	
5	C5	PATH PLAN & PROFILE STA 12+59 TO 15+00	
6	C6	PATH PLAN & PROFILE STA 15+00 TO 20+00	
7	C7	PATH PLAN & PROFILE STA 20+00 TO EOP	

ON MY FIELD OBSERVATION AND INFORMATION PROVIDED BY THE GENERAL CONTRACTOR AND OTHERS, THAT THE WORK ON SHEETS 1 THROUGH 7, MARKED AS "RECORD DRAWING" HAS BEEN CONSTRUCTED IN SUBSTANTIAL CONFORMANCE WITH THESE CONSTRUCTION PLANS, SPECIFICATIONS, INCLUDING CHANGES AND REVISIONS.

REGISTERED LAND SURVEYOR/ENGINEER

REGISTRATION NUMBER EXPIRATION DATE



ARIZONA 811. Arizona Blue Stake, Inc. DRAWING NO.

986 86 06 8


POINT #2003 REBAR AND CAP STAMPED "RLS 13015" (ON-SITE) N34°51'42.39285" NORTHING: 1405005.454 **APPROVAL** LONGITUDE: W111°49'05.96633" EASTING: 729500.317 ELLIPSOID HEIGHT: 4322.740 FT ELEVATION: 4403.232 FT APPROVED: J. ANDY DICKEY, P.E. DIRECTOR OF PUBLIC WORKS, CITY ENGINEER UTILITY COORDINATION BLOCK RECORD DRAWING STATEMENT IRRIGATION VALVE JUNCTION BOX WATER METER

SHALL BE WITHIN THE DESIGNATED AREA ON THE PLANS.


ACCIDENTAL SPILLS SHALL BE PROMPTLY CLEANED UP.

- THE UNCOVERED DISTURBED AREA SHALL BE SEEDED.

PROTECTED AREAS SHALL NOT BE DAMAGED

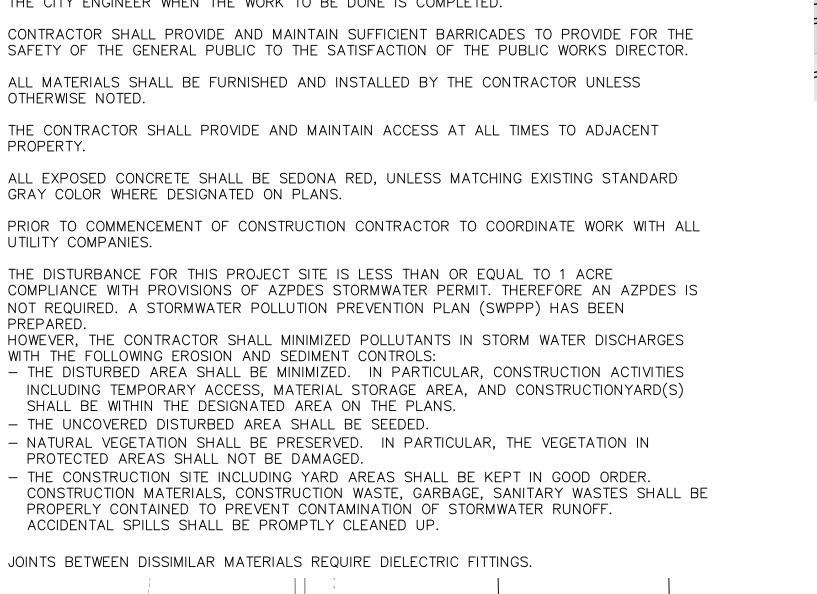

DRIVEWAY

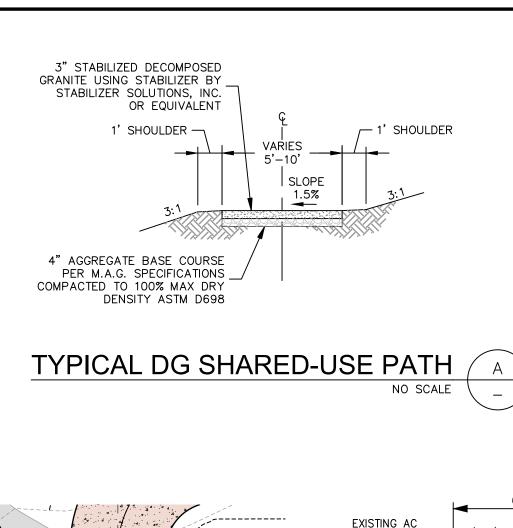

FXISTING

1"=10'

2. (->) INDICATES DIRECTION OF FLOW.

4. ATTACH DIAMOND PLATE COVER WITH 3/8"

FLATHEAD STAINLESS STEEL CAP SCREW

PAINT NUMBER 1-A OR 1-B.


COUNTERSINK. (8 EACH MIN)

PAINT STEEL ACCORDING TO M.A.G. SECTION 790.


CONCRETE SHALL BE CLASS AA PER M.A.G. SECT. 725 AND INSTALLED PER SECT. 505.

0+50

SIDEWALK

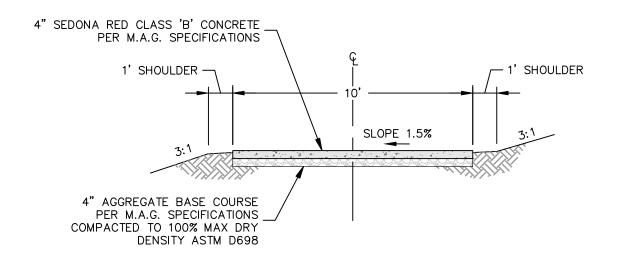

TYPICAL CONCRETE SHARED-USE PATH

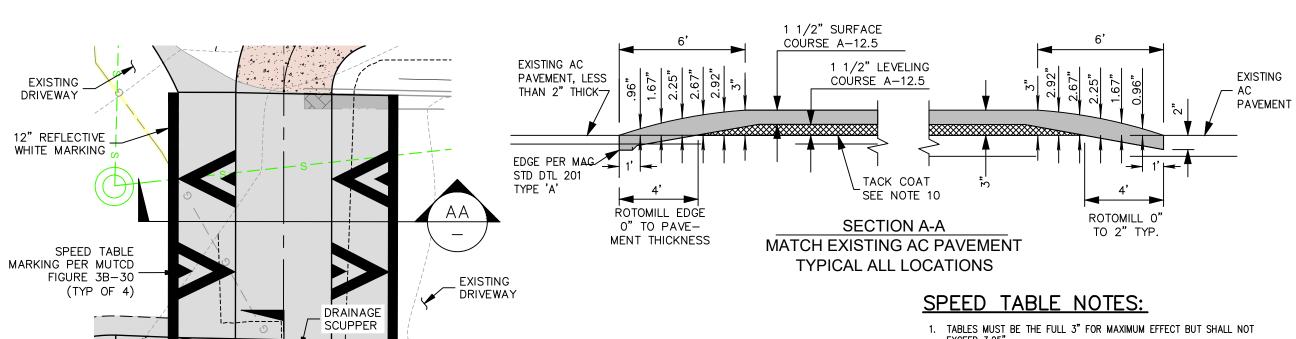

STEEL DIAMOND

SCUPPER SECTION 'BB'

DETAIL 'CC'

RAISED CROSSWALK DETAIL

SEE DETAIL 'CC'

ANGLE BOTH SIDES

- NO.4 REINFORCEMENT

2. TABLES CONSTRUCTED OVER 3.25" OR LESS THAN 3.00" SHALL BE REMOVED AND REPLACED AT THE CONTRACTOR'S EXPENSE. 3. CROSS-SECTION ELEVATIONS SHALL HAVE A MAXIMUM TOLERANCE OF +0.25".

4. SPEED TABLES SHALL NOT BE PLACED OVER MANHOLES, WATER VALVES, SURVEY

MONUMENTS, JUNCTION CHAMBERS, ETC. OR IN CONFLICT WITH DRIVEWAYS. 5. SPEED TABLES MUST BE PLACED AT LOCATIONS APPROVED BY THE CITY. 6. TABLES TO BE CONSTRUCTED WITH ASPHALT MIX APPROVED BY THE AGENCY.

ASPHALT COMPACTION SHALL BE PER MAG SECTION 321. A TACK COAT PER MAG SECTION 713 SHALL BE APPLIED PRIOR TO APPLICATION OF PAVEMENT. 7. INSTALLATION JOINTS:


A. STANDARD INSTALLATION: THE EXISTING ROADWAY SHALL BE MILLED TO A MINIMUM DEPTH OF 3/4" AROUND THE PERIMETER. CROSS SECTION DIMENSIONS DO NOT INCLUDE THE 3/4" MILLING. CONTRACTOR MUST PROVIDE VERIFICATION OF CROSS-SECTION B. ALTERNATIVE INSTALLATION:

FOR TRANSVERSE JOINTS (CROSS ROADWAY), THE EXISTING ASPHALT SHALL BE SAW CUT AND REMOVED FOR A WIDTH OF 24". THE ASPHALT SHALL BE REPLACED WITH THE SAME ASPHALT AND AT THE SAME TIME AS THE HUMP ASPHALT FOR LONGITUDINAL JOINTS. THE EXISTING ASPHALT SHALL RE OVERLAID AND TAPERED IN 12". CROSS-SECTION DIMENSIONS REFLECT DISTANCES FROM THE SURFACE OF EXISTING ASPHALT.

8. CONTACT THE CITY (OR INSPECTOR) ONE WEEK PRIOR TO INSTALLATION TO COORDINATE PAVEMENT MARKINGS AND SIGNING.

9. WARNING SIGN TO BE PLACED 50FT PRIOR TO TABLE. LOCATION TO BE APPROVED BY CITY.

10. TACK TO EDGE OF PAVEMENT IF ASPHALT MATERIAL STILL EXISTS. NO TACK NECESSARY IF DOWN TO SUBGRADE (ABC).

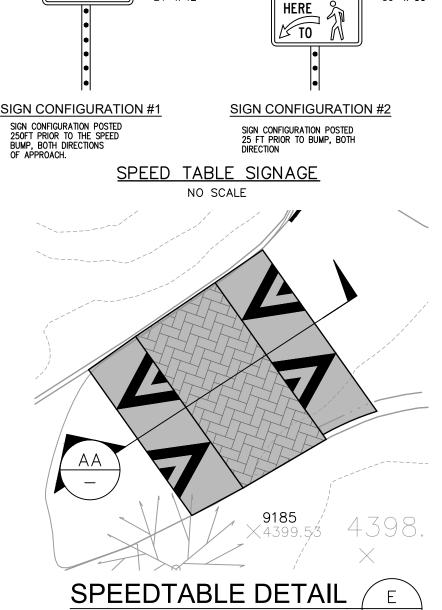

BLACK ON YELLOW

BLACK ON YELLOW

15MPH

250 FT


93.6± ME-


93.52 TC/FL+

NO SCALE

93.2± ME-

93.54 T

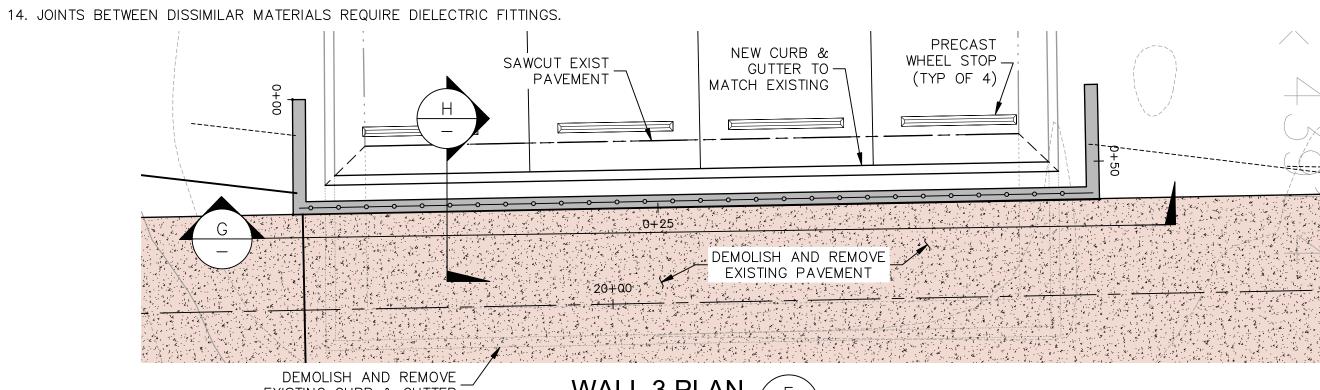

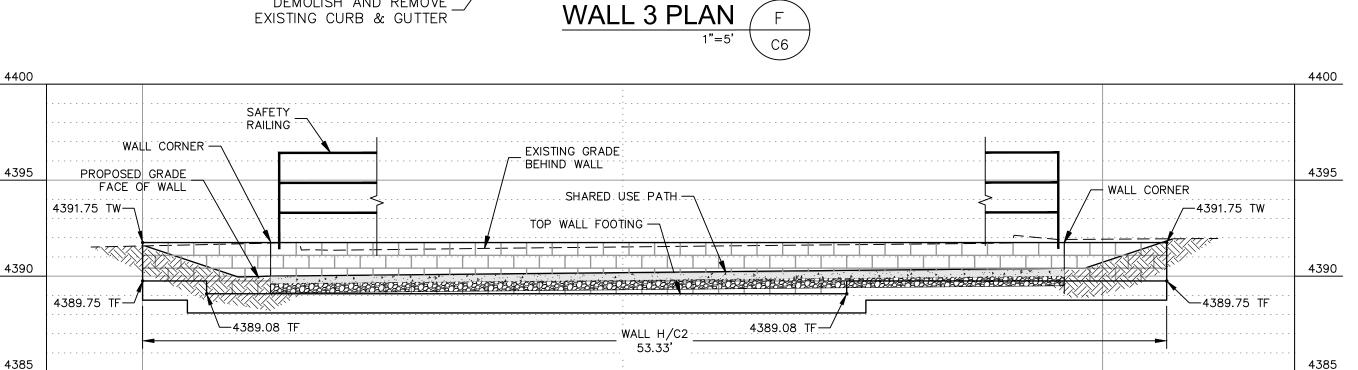

WALL 3 PROFILE

SAFETY RAIL PER M.A.G. STD DTL 145 #4 HORIZ BARS TOP AND 24" O.C. 8" CMU SOLID GROUT #4 BARS @ 48" O.C. HOOK 6" TO TOE OF FTG. PRECAST 5 1/4" PATH WHEEL STOP #4 BARS @ 16" ((3) #4 BARS AS SHOWN -CONCRETE FOOTING



RETAINING WALL NOTES


- 1. MAX CONTROL JOINT SPACING = 24'
- 2. MAX EXPANSION JOINT SPACING =
- 3. FILL ALL CELLS WITH GROUT. PLACE 1 CUBIC FOOT OF LEACH ROCK WRAPED IN FILTER FABRIC PER LINEAL FOOT OF WALL WITH 3" SCH 40 PVC WEEP PIPE @ 6' O.C. FOR
- 4. PLACE VERTICAL STEEL ON EACH SIDE OF CONTROL JOINTS AND

DRAINAGE

EXPANSION JOINTS. 5. CONCRETE FOR ALL RETAINING WALLS SHALL BE CLASS "A" COMPRESSIVE STRENGTH F'c =

2500 PSI AT 28 DAYS.

- 6. ALL REINFORCING IN WALLS AND FOOTINGS SHALL BE GRADE 60.
- 7. WALL FOOTINGS SHALL HAVE AT LEAST 6" OF COVER ABOVE THE TOP OF FOOTING.
- 8. GROUT SHALL ATTAIN A MINIMUM COMPRESSIVE STRENGTH AT 28
- DAYS OF 2000 PSI. 9. FILL BEHIND WALLS TO CONFORM TO M.A.G. SPECIFICATION SECTION 206 "STRUCTURE EXCAVATION &

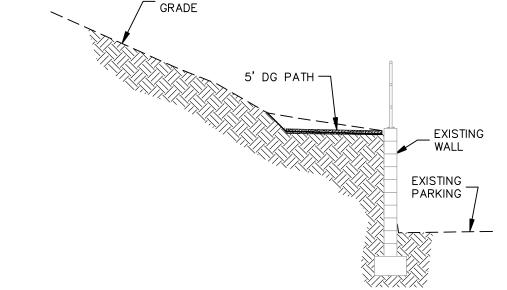

SIDEWALK RAMP DETAIL

5 REMOVE AND DISPOSE EXISTING CONCRETE PAVEMENT 247 SF 203 SY 6 REMOVE AND DISPOSE EXISTING ASPHALT PAVEMENT 247 LF 7 REMOVE AND DISPOSE EXISTING CURB & GUTTER 7 EA 8 REMOVE AND DISPOSE EXISTING TREE 10 REMOVE AND DISPOSE EXISTING VEGETATION 11 REMOVE AND DISPOSE EXISTING RAMP 12 OBLITERATE EXISTING STRIPE CONSTRUCTION NOTES (1) SUBGRADE PREPARATION (2) CONSTRUCT ASPHALT PATCH PER M.A.G. STD. DTL. 200 14 SY (3) CONSTRUCT TYPE 'A' VERTICAL CURB & GUTTER PER M.A.G. STD. DETAIL 220 (GRAY CONCRETE) 216 LF (4) INSTALL PRECAST SAFETY CURB PER M.A.G. STD. DETAIL 150 OR APPROVED EQUAL 4 EA (6) CONSTRUCT 5' SIDEWALK PER M.A.G. STD. DETAIL 230 (GREY CONCRETE) 22 SY (8) CONSTRUCT SIDEWALK RAMP PER DETAIL 'J' ON DWG C2 (9) CONSTRUCT 10' CONCRETE SHARED USE PATH PER DETAIL 'B' ON DWG C2 (COLOR PER PLAN) 927 SY (10) CONSTRUCT DECOMPOSED GRANITE SHARED USE PATH PER DETAIL 'A' ON DWG C2 302 SY (12) CONSTRUCT RETAINING WALL PER DETAILS ON C2 129 SF (13) CONSTRUCT RAISED CROSSWALK PER DETAIL 'D' ON DWG 14) TRIM TREE BRANCHES AS NECESSARY TO PROVIDE CLEARANCE FOR PATH 4 EA (15) CONSTRUCT DRY-STACK RED RETAINING WALL TO LIMIT GRADING @ TREES 120 LF (16) CONSTRUCT CONCRETE PATCH TO MATCH EXISTING 1.5 SY (17) INSTALL SAFETY RAIL AT TOP OF WALL PER M.A.G. STD 42 LF (19) INSTALL SPLIT RAIL WOOD FENCING 157 LF (20) CONSTRUCT 6" ASPHALT SPEED TABLE PER DETAIL 'E' ON 21) INSTALL 4" WHITE STRIPING TO DESIGNATE A "NO PARKING ZONE" (23) INSTALL STOP SIGN AND ONE WAY STRIPING (24) INSTALL "BUMP 15 MPH" PER DETAILS ON C2 2 EA (25) INSTALL "PATH NARROWS. 1 WAY TRAFFIC" SIGN 2 EA (26) INSTALL "PATH ENDS AHEAD" SIGN (28) INSTALL D50=6 (12" THICK) RIP RAP 31.6 SY

QUANTITIES

1 LS

20.5 LF

413.25 LF

15 LF

1 LS

1 EA

1 LS

1 LS

1 EA

1 EA

1 EA

1 LS

1 LS

1 EA

0 LS

DEMOLITION NOTES

1 CLEAR AND GRUB

WARNING SIGN

30" x 30"

BLACK ON YELLOW

YIELD

2 | SAWCUT EXISTING CONCRETE PAVEMENT

3 | SAWCUT EXISTING ASPHALT PAVEMENT

4 | SAWCUT EXISTING CURB & GUTTER AT GUTTER FLOWLINE

NOTE TO CONTRACTOR:

The Engineer has used his best judgment in the estimation of the earthwork for this Project. The earthwork (cut/fill) for this project is designed to balance. The Engineer has no control over varying field conditions and construction methods involved in the site grading. Consequently, actual quantities, cost and time required for this Project may be affected by many factors beyond the Engineer's control, and Engineer shall not be held liable for any deviation from its estimated quantities. It is the responsibility of the Contractor to verify the earthwork quantities. The following is the Engineer's estimate of raw earthwork quantities for this Project. (No shrinkage values are taken into consideration in these quantities).

Cut = 129 C.Y. Fill = 231 C.Y.


(29) RESTRIPE PARKING STALLS (4"x18" WHITE STRIPE)





ARIZONA 811.
Arizona Blue Stake, Inc. DRAWING NO


RETAINING WALL SECTIONS

SECTION

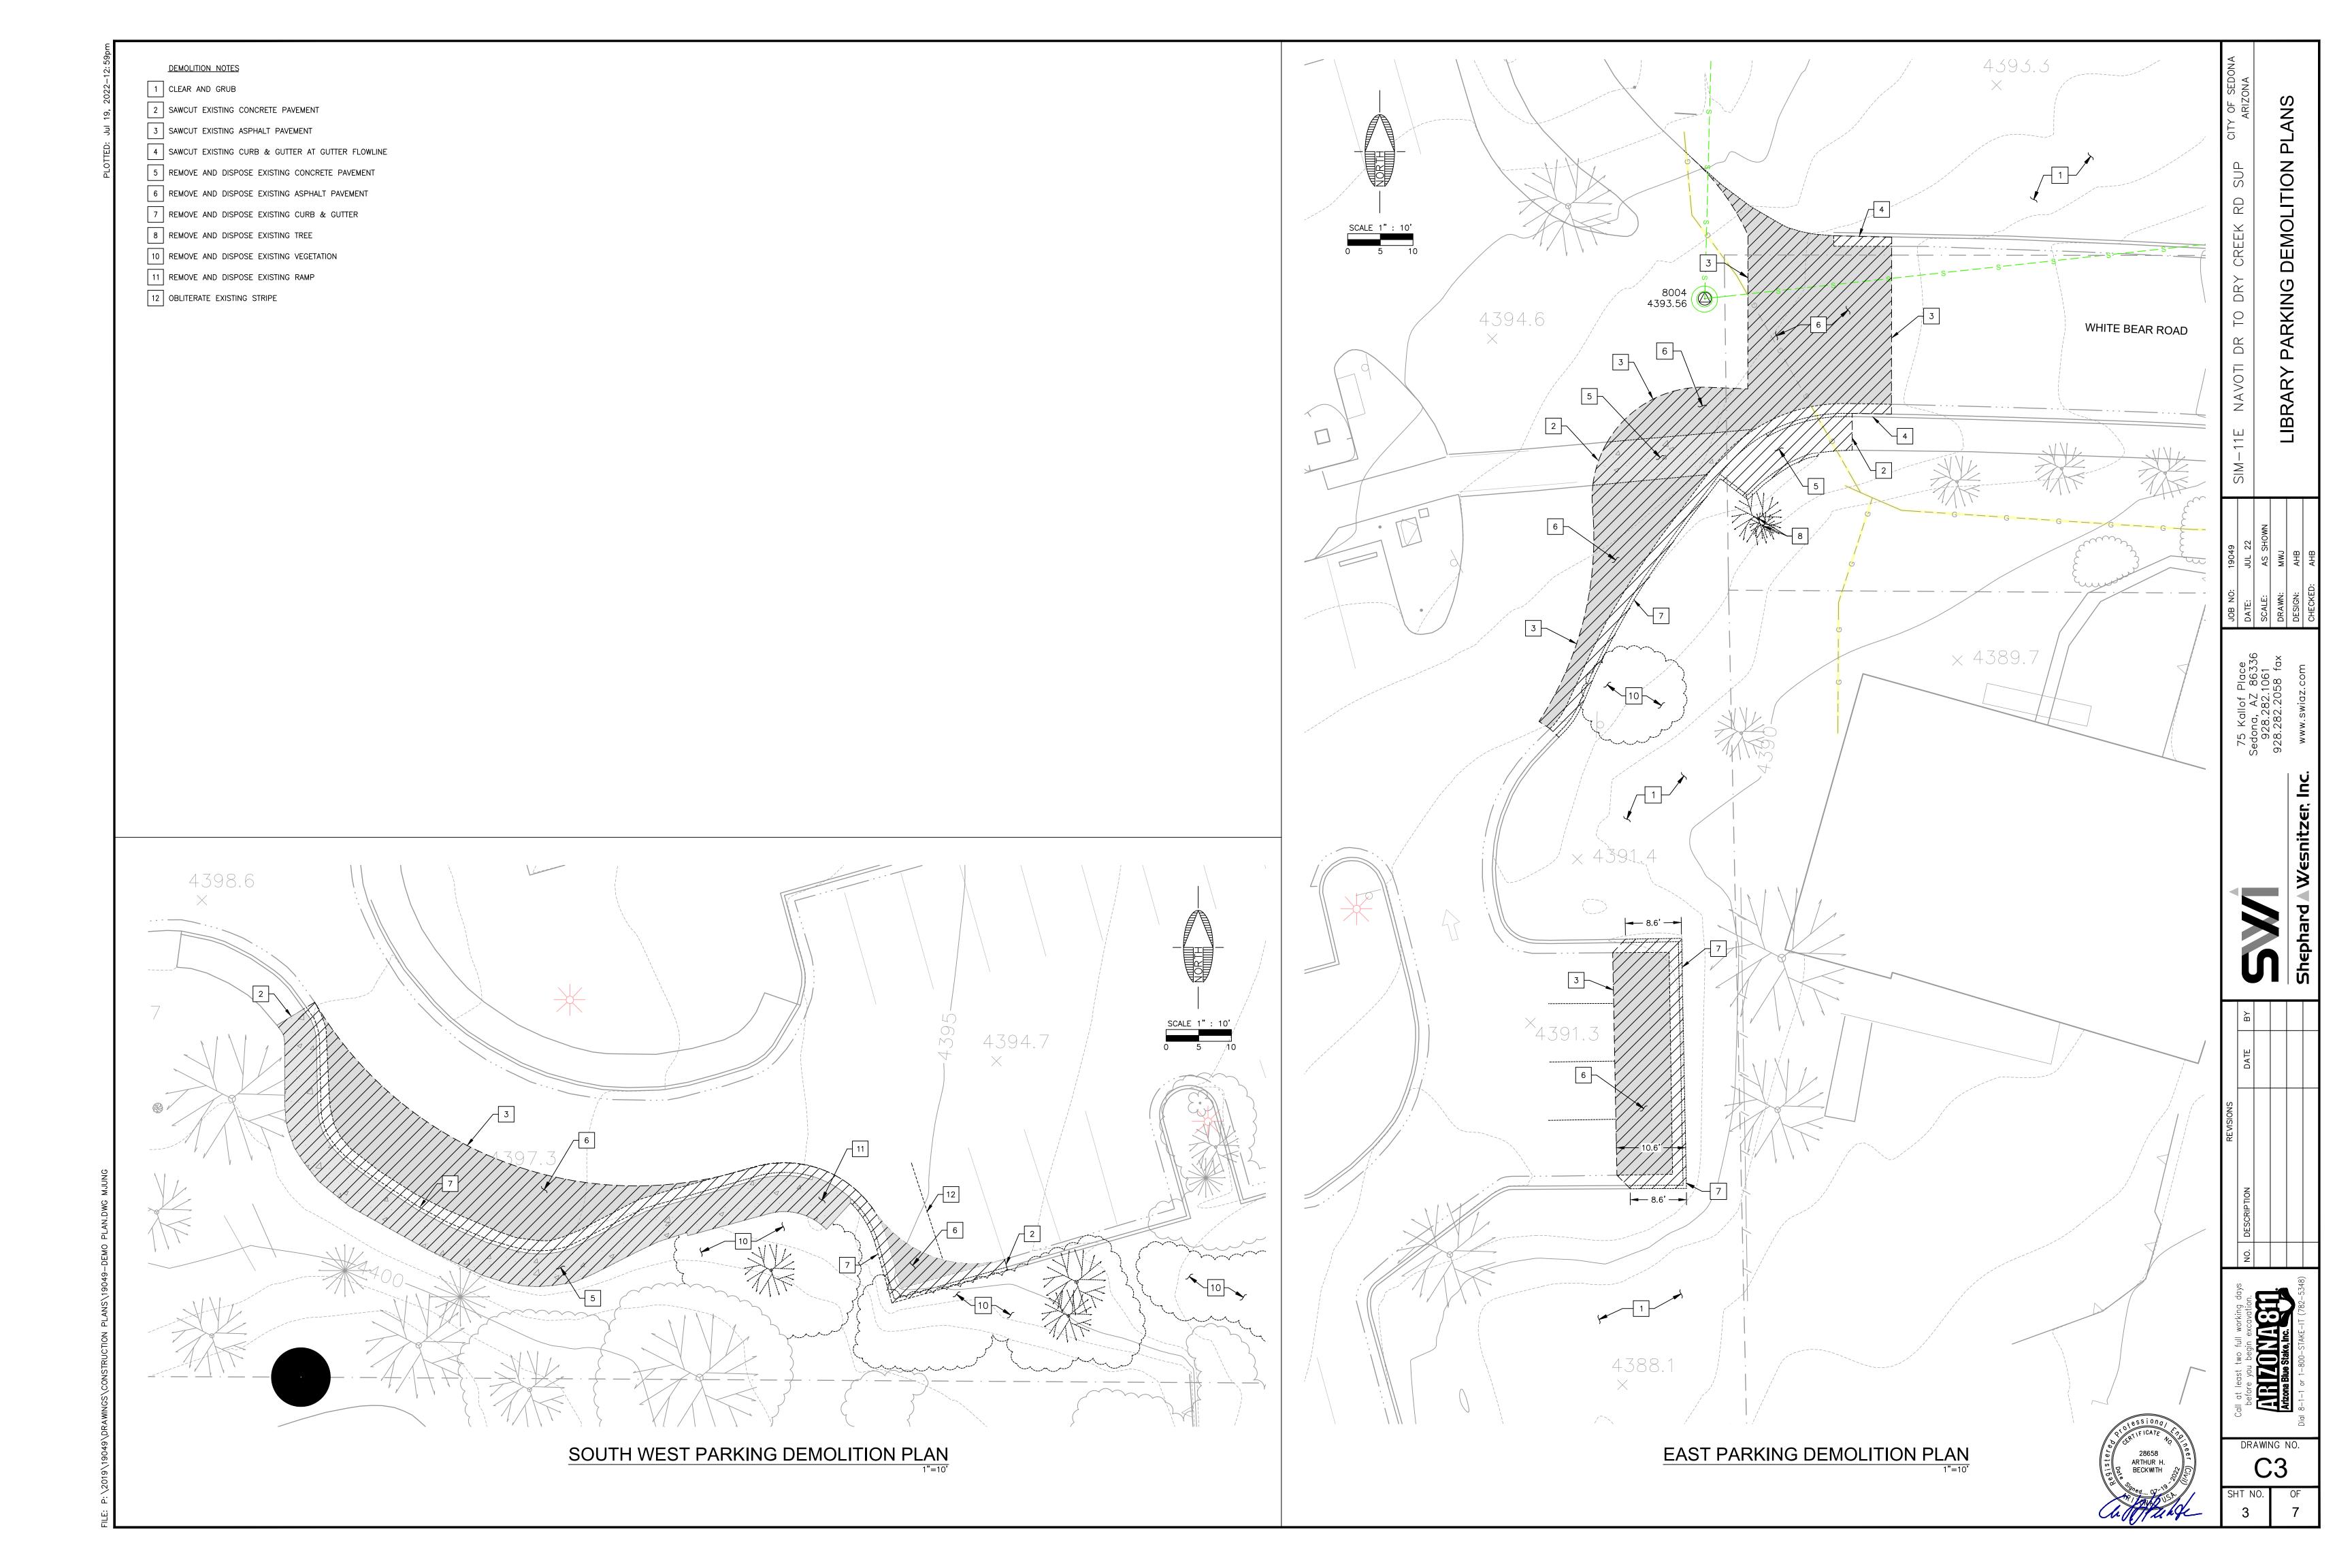

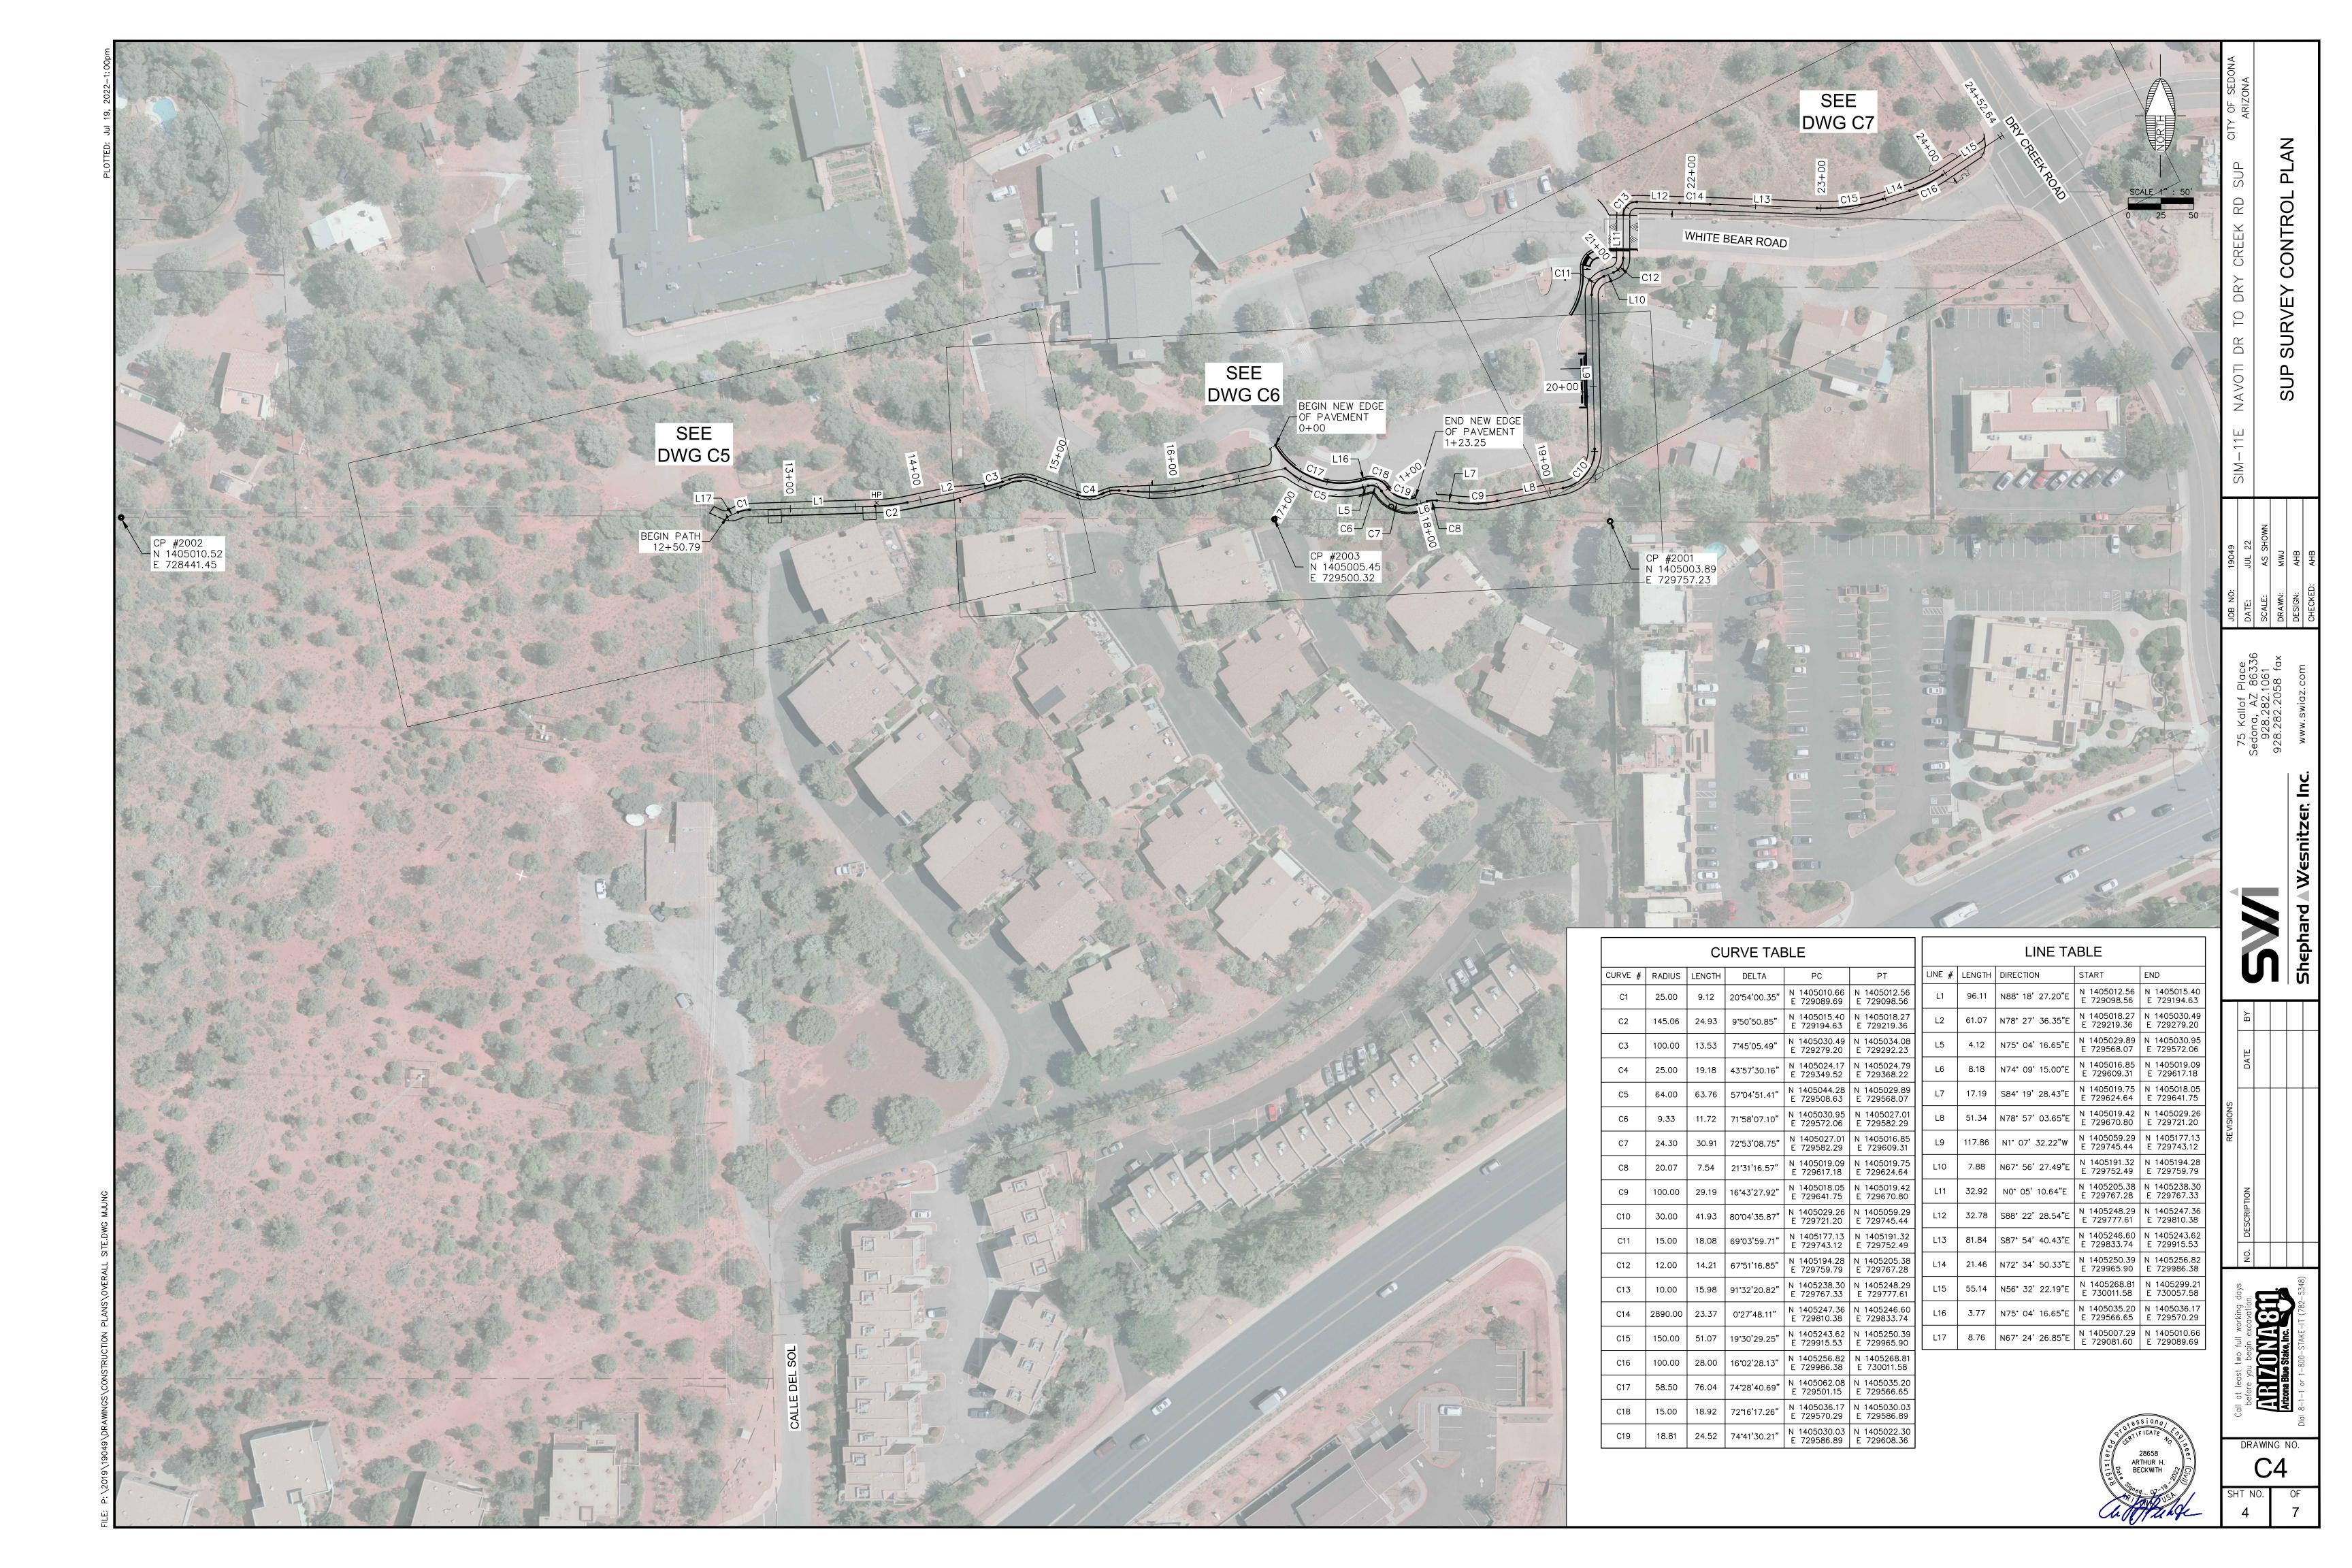

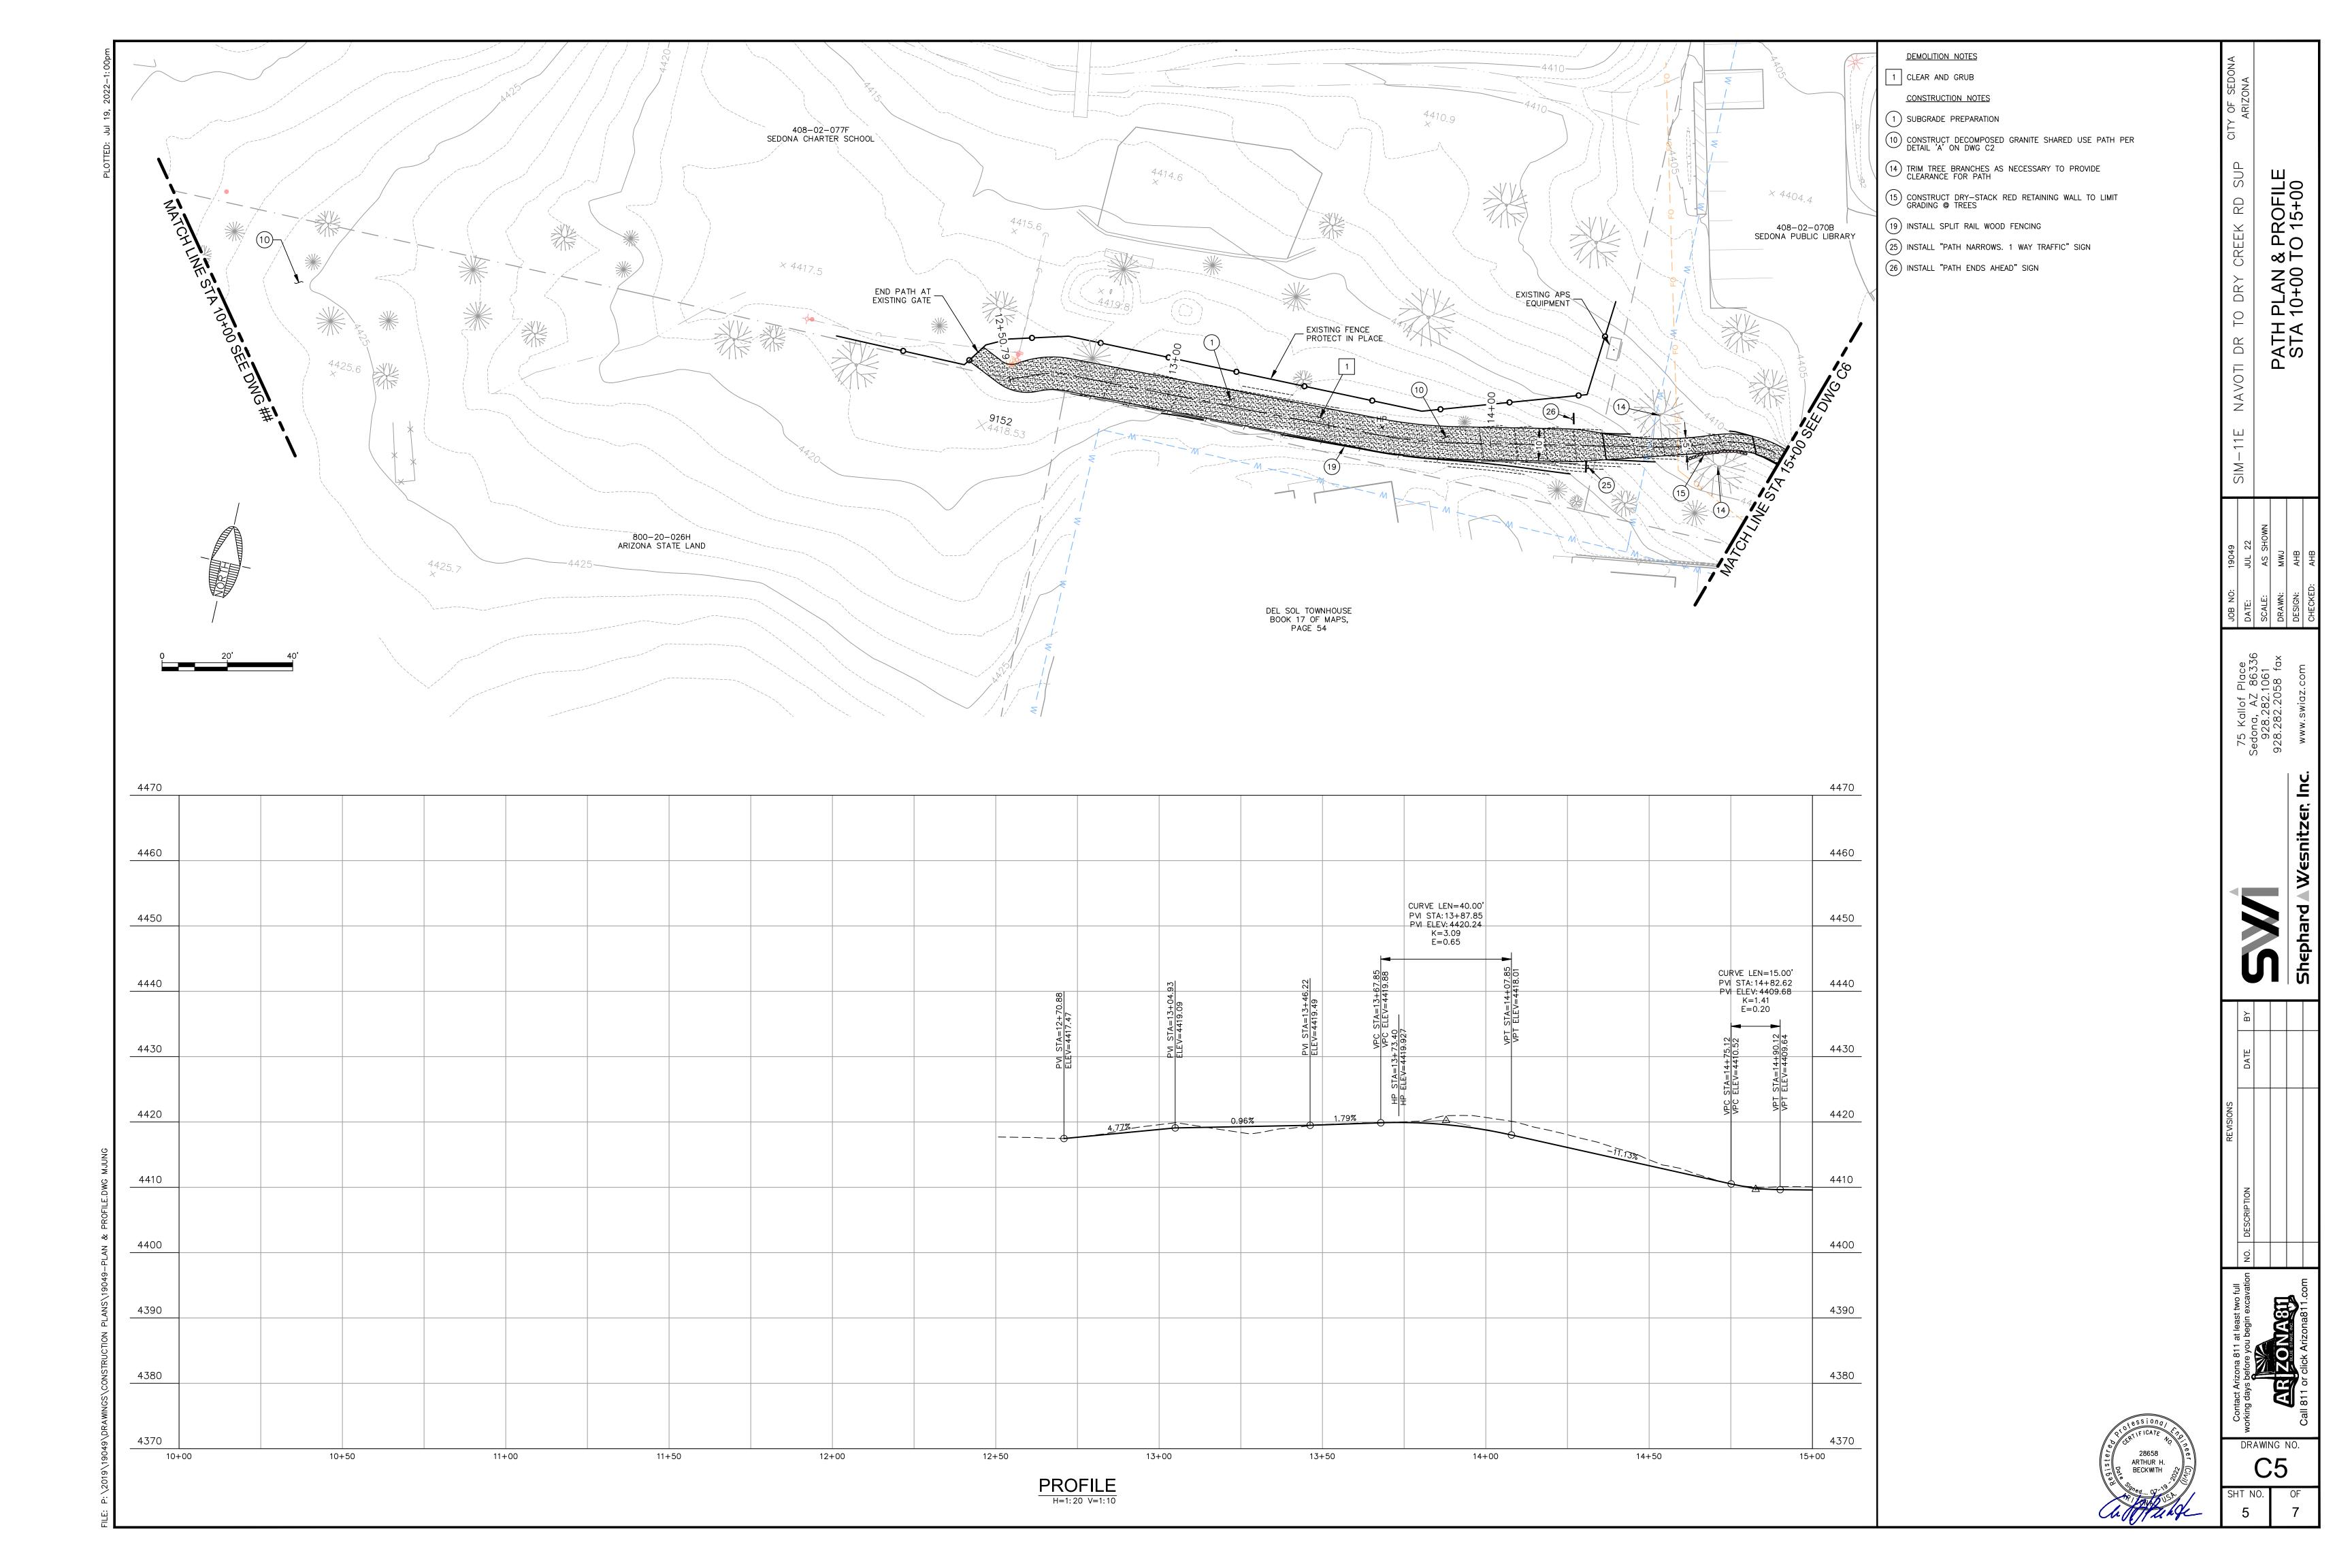

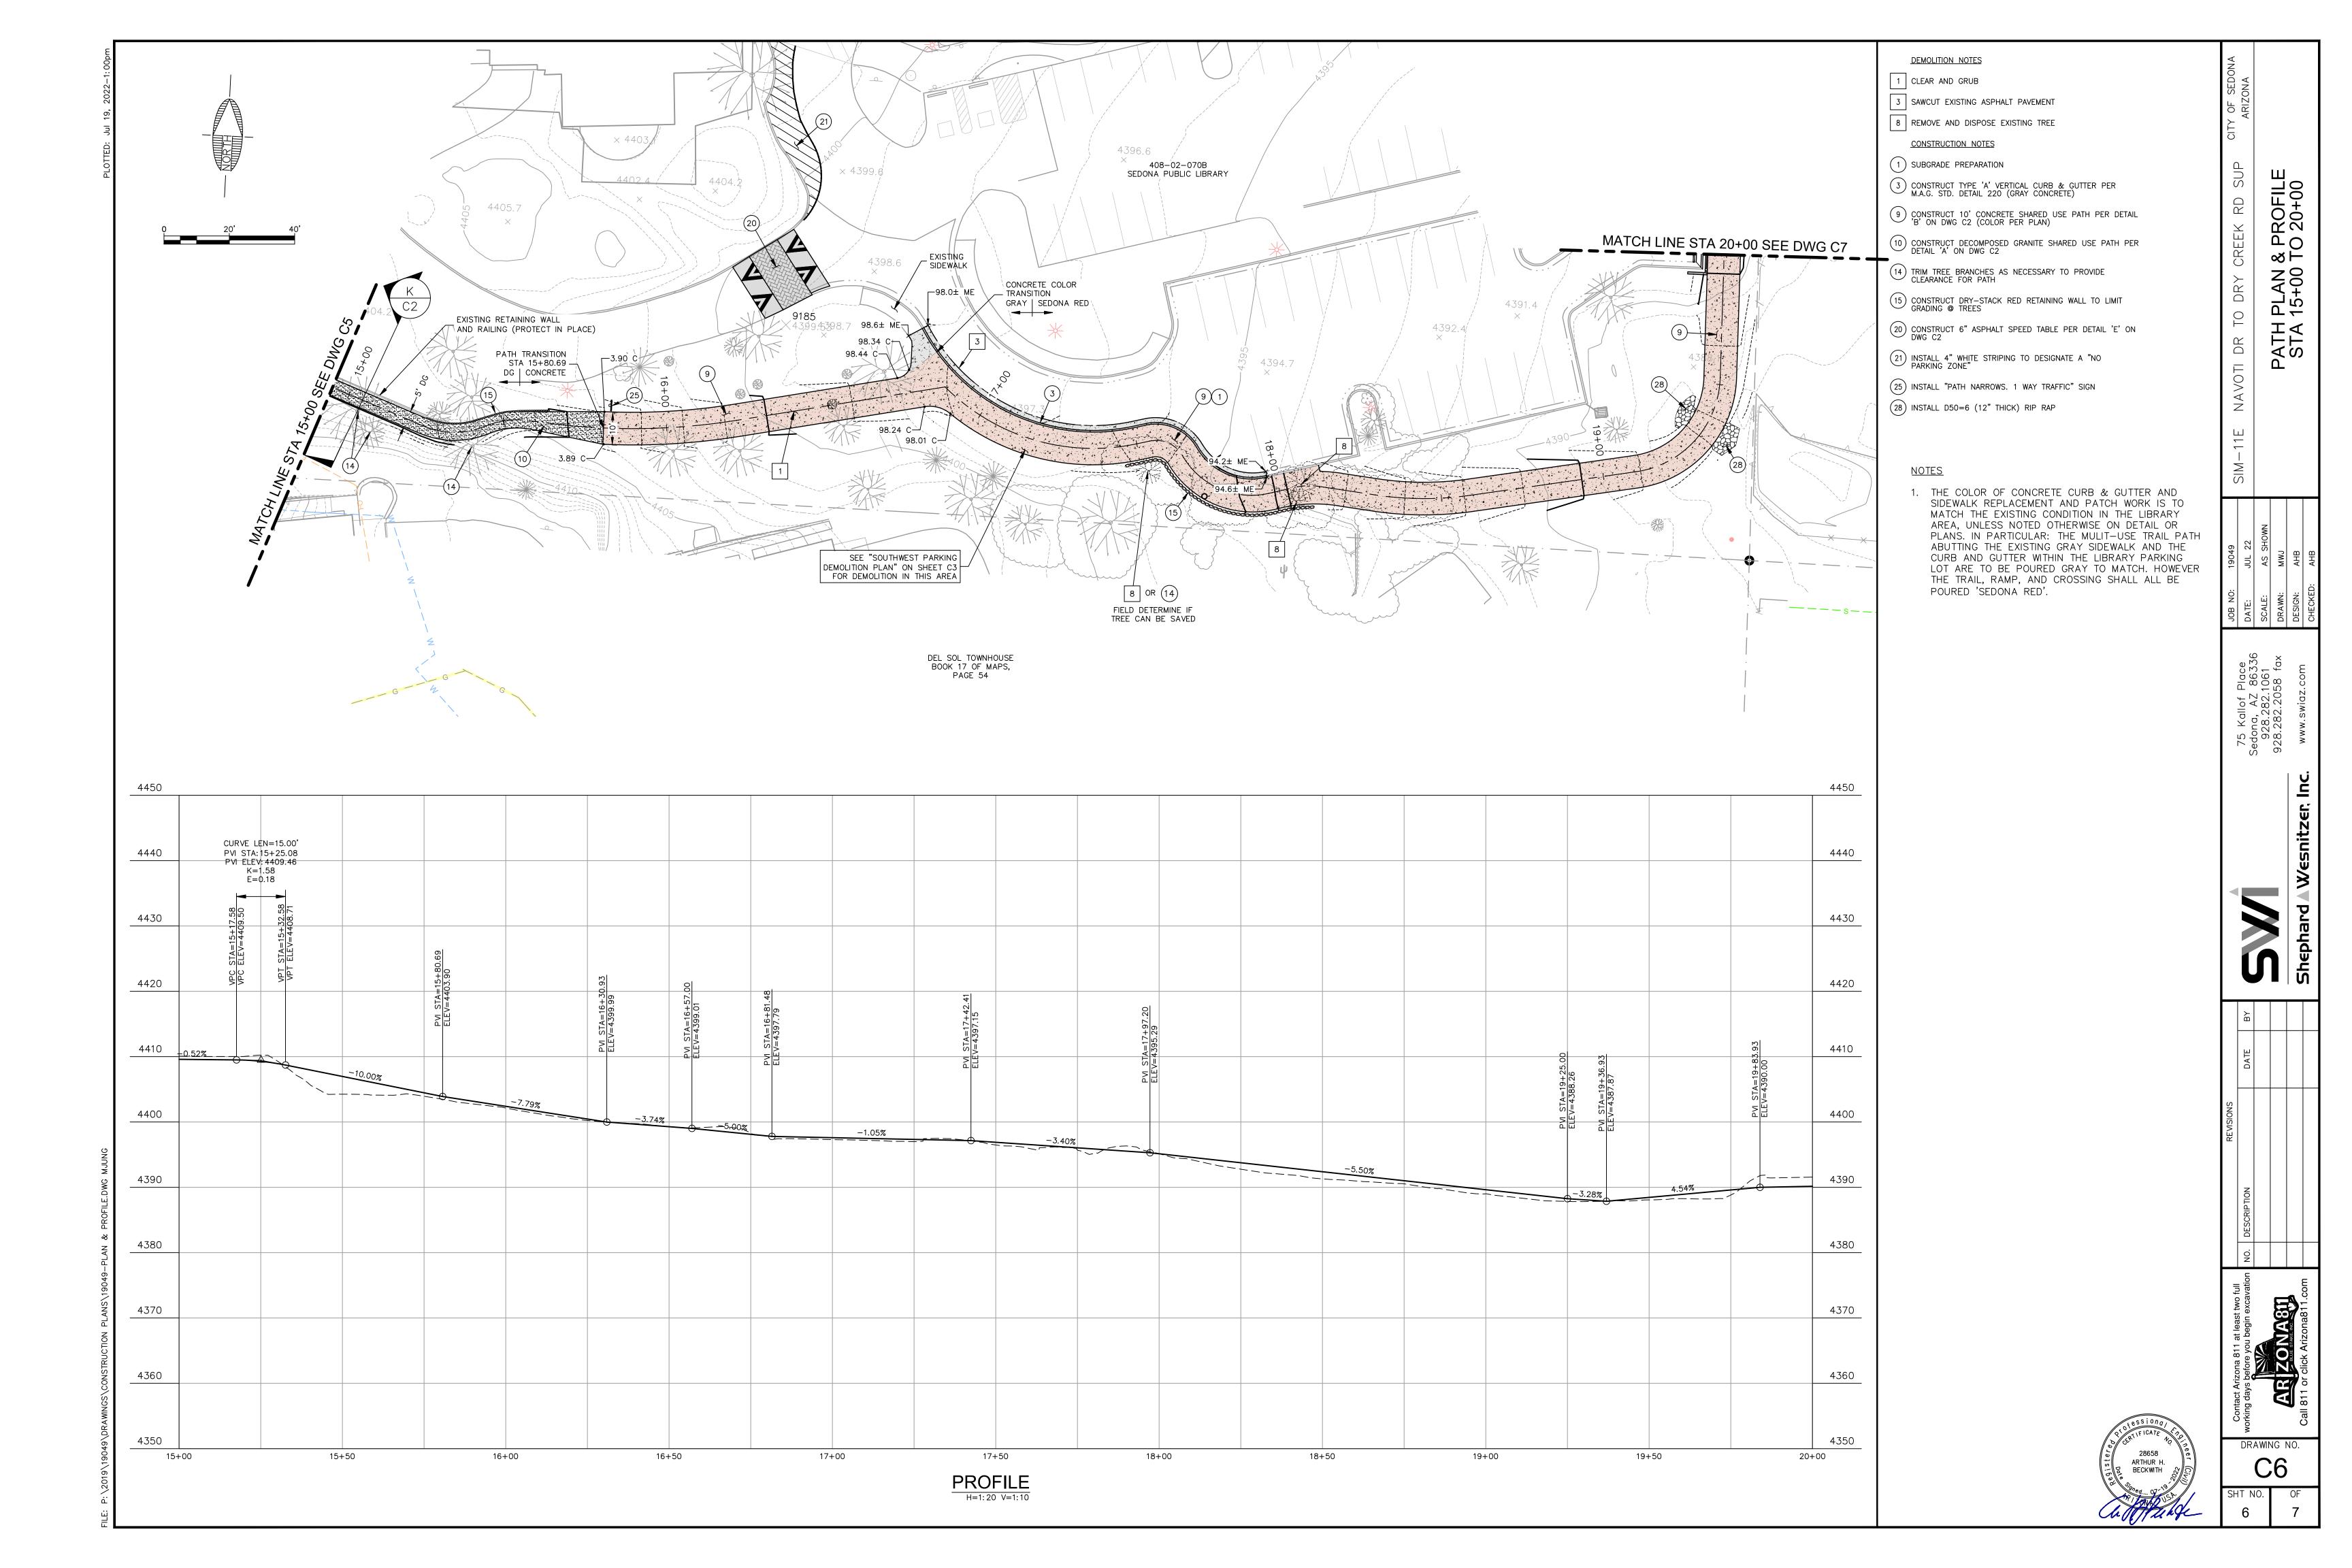



SIDEWALK REPLACEMENT AND PATCH WORK IS TO MATCH THE EXISTING CONDITION IN THE LIBRARY AREA, UNLESS NOTED OTHERWISE ON DETAIL OR PLANS. IN PARTICULAR: THE MULIT-USE TRAIL PATH ABUTTING THE EXISTING GRAY SIDEWALK AND THE CURB AND GUTTER WITHIN THE LIBRARY PARKING LOT ARE TO BE POURED GRAY TO MATCH. HOWEVER THE TRAIL, RAMP, AND CROSSING SHALL ALL BE

DRAWING NO.

I PLAN & PROFILE A 20+00 TO EOP

Д Ж