


CITY OF SEDONA SR 179 PEDESTRIAN CROSSING AT OAK CREEK

LOCATED IN A PORTION OF SECTION 07, TOWNSHIP 17 NORTH, RANGE 6 EAST, GILA AND SALT RIVER MERIDIAN, COCONINO COUNTY, ARIZONA.

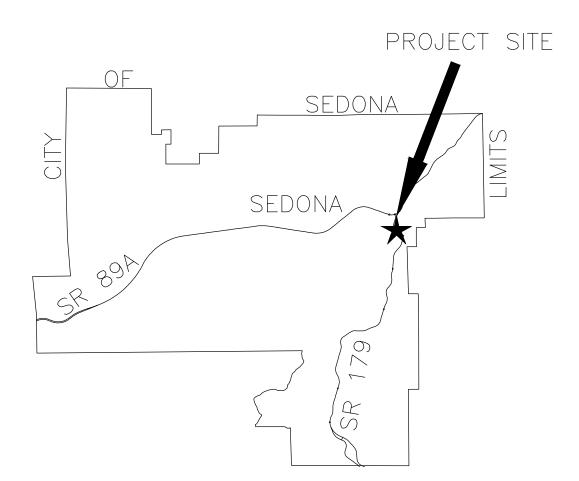


LEGEND

	10 AND 100 YEAR FLOOD PLAIN ELEV
	EXISTING RIGHT OF WAY
	EXISTING EDGE OF PAVEMENT
	EXISTING STRIPING
W	EXISTING WATER LINES
——— E ———	EXISTING UNDERGROUND POWER
—— G ——	EXISTING GAS
ss	
— т —	
CTV	
	FXISTING STORM DRAIN
	EXISTING SEDONA SANITARY SEWER
SL	EXISTING STREET LIGHT LINE
	EXISTING PROPERTY WALL
	RETAINING WALL
	PEDESTRIAN HANDRAIL
Δ Δ Δ	CONCRETE SIDEWALK
	NEW RIGHT OF WAY
	TCE
	PAVEMENT CENTER LINE OR MONUMENT LINE
	EXISTING SIGN
0Q	EXISTING LIGHT POLE
2, , ,	EXISTING TREE TRUNKS

SHT NO.	DWG NO.	DESCRIPTION
1	C1	COVER SHEET
2	C2	GENERAL NOTES SHEET
3-4	C3-C4	TYPICAL SECTIONS SHEETS
5	C5	QUANTITY SUMMARY SHEET
6	C6	DEMOLITION PLAN SHEET
7-8	C7-C8	PLAN & PROFILE SHEETS
9	С9	CONTROL SHEET
10-11	C10-C11	ROADWAY DETAILS
12-14	S1-S3	RETAINING WALL PLAN & ELEVATION SHEETS
15	S4	MASONRY WALL PLAN & ELEVATION SHEET
16	S5	MASONRY WALL STRUCTURAL DETAILS
17-22	S6-S11	MISCELLANEOUS STRUCTURAL DETAILS
23-24	D12-D13	EROSION PROTECTION PLAN SHEETS
25-26	D14-D15	EROSION PROTECTION DETAILS
27-28	HS1-HS2	HARDSCAPE PLAN SHEETS
29-34	HD1-HD6	HARDSCAPE DETAILS
35	T1	SIGNING GENERAL NOTES
36-37	T2-T3	SIGN SUMMARY SHEETS
38	Т4	SIGN FORMAT SHEET
39	T5	SIGNIING PLAN SHEET
40	Т6	LIGHTING GENERAL NOTES SHEET
41	Т7	LIGHTING PLAN SHEET
42	Т8	PEDESTRIAN SIGNAL PLAN SHEET

SHEET INDEX

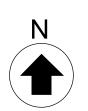

KEY MAP


UTILITY COORDINATION BLOCK

-			
	☐ ARIZONA PUBLIC SERVICE	MATTHEW HERRERA COMPANY REPRESENTATIVE CONTACTED	RECEIVED: <u>09/12/2022</u>
	☐ ARIZONA WATER COMPANY	CASEY GOFF	RECEIVED: <u>09/08/2022</u>
	☐ CENTURY LINK	COMPANY REPRESENTATIVE CONTACTED ARMEN MCNERLIN	RECEIVED: 07/27/2022
		COMPANY REPRESENTATIVE CONTACTED SANFORD YAZZIE	RECEIVED: 08/31/2022
	□ NPG CABLE, LLC	COMPANY REPRESENTATIVE CONTACTED	
	□ UNISOURCE ENERGY SERV.	TAYLOR MATHE COMPANY REPRESENTATIVE CONTACTED	RECEIVED: 01/19/2022
	☐ CITY OF SEDONA	ROBERT WELCH COMPANY REPRESENTATIVE CONTACTED	RECEIVED: <u>08/30/2022</u>



BID ALTERNATIVE #1. SEE SPECIAL PROVISIONS.


BID ALTERNATIVE #2. SEE SPECIAL PROVISIONS.

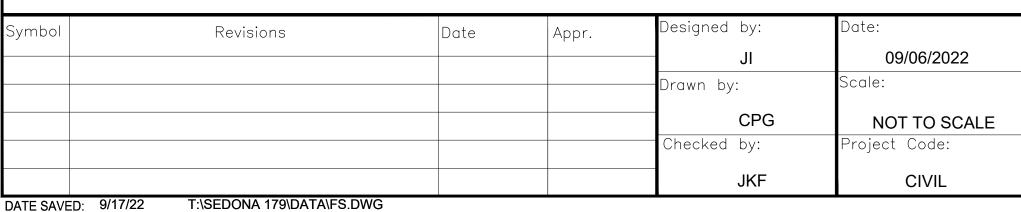







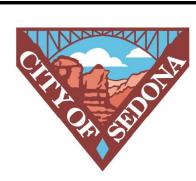

CITY OF SEDONA PUBLIC WORKS DEPARTMENT 102 ROADRUNNER DRIVE

SEDONA, ARIZONA 86336 928-204-7111

SR 179 PEDESTRIAN CROSSING AT OAK CREEK SEDONA ARIZONA

CONTACT INFORMATION

MAYOR

VICE MAYOR

CITY COUNCIL

CITY MANAGER

APPROVED:

ENGINEER

CITY OF SEDONA

(928) 204-7111

J. ANDY DICKEY, P.E. DIRECTOR OF PUBLIC WORKS/CITY ENGINEER

SANDY MORIARTY

SCOTT JABLOW

KATHY KINSELLA

KAREN OSBURN

TEMPE, AZ 85281 (480)966 - 8295

J. ANDY DICKEY, P.E. DIRECTOR OF PUBLIC WORKS/CITY ENGINEER

STEPHEN DOUBEK, P.E.

APPROVALS

(PER ARS 32-1129.01) THIS CONTRACT ALLOWS THE OWNER TO

PAYMENTS, WITHIN 15 DAYS AFTER CERTIFICATION AND APPROVAL OF BILLINGS AND ESTIMATES FOR RELEASE OF RETENTION AND

MAKE PAYMENT WITHIN 15 DAYS AFTER CERTIFICATION AND APPROVAL OF BILLINGS AND ESTIMATES FOR PROGRESS

WITHIN 15 DAYS AFTER CERTIFICATION AND APPROVAL OF

RECORD DRAWING STATEMENT

MY FIELD OBSERVATION AND INFORMATION PROVIDED BY THE

SHEETS 1 THROUGH , MARKED AS "RECORD DRAWING" HAS

GENERAL CONTRACTOR AND OTHERS, THAT THE WORK ON

BEEN CONSTRUCTED IN SUBSTANTIAL CONFORMANCE WITH THESE CONSTRUCTION PLANS, SPECIFICATIONS, INCLUDING

REGISTERED LAND SURVEYOR/ENGINEER DATE

BILLINGS AND ESTIMATES FOR FINAL PAYMENT.

CHANGES AND REVISIONS.

REGISTRATION NUMBER

9/29/2022

HEREBY STATE BASED ON

EXPIRATION DATE

NOTICE OF EXTENDED PAYMENT PROVISION

DATE

WSP USA

JESSICA WILLIAMSON

1230 W. WASHINGTON ST, SUITE 405

TOM LAMKIN HOLLI PLOOG JON THOMPSON

102 ROADRUNNER DRIVE SEDONA, ARIZONA 86336

COVER SHEET

HEET ID C1 SHEET NO.

Call 811 or click Arizona811.com

Contact Arizona 811 at least two full

GENERAL NOTES

- 1. ALL CONSTRUCTION SHALL BE PERFORMED IN ACCORDANCE WITH CONTRACT SPECIAL PROVISIONS AND DETAILS, CITY OF SEDONA SUPPLEMENTS TO MAG STANDARD SPECIFICATIONS AND DETAILS (CITY CODE TITLE 12.05.110), AND MAG STANDARD SPECIFICATIONS AND DETAILS, IN THAT ORDER OF PRECEDENCE, AT THE TIME OF CONSTRUCTION BID.
- 2. FACILITIES WHICH ARE NOT SPECIFICALLY LOCATED WITH ACTUAL VERTICAL AND HORIZONTAL CONTROLS, ARE LOCATED ONLY APPROXIMATELY AND TO THE BEST AVAILABLE INFORMATION PROVIDED BY VARIOUS OWNERS OF THE FACILITIES, AND SUPPLEMENTED BY VISUAL SURFACE INFORMATION WHERE APPROPRIATE. ACCURACY, LOCATION AND COMPLETENESS OF THIS INFORMATION SHALL BE VERIFIED BY THE CONTRACTOR PRIOR TO INITIATION OF CONSTRUCTION.
- 3. TWO WORKING DAYS BEFORE CONSTRUCTION, THE CONTRACTOR SHALL CONTACT BLUESTAKE TO FIND AND FLAG UNDERGROUND UTILITIES. THE CONTRACTOR SHALL CONTACT OTHER APPROPRIATE UTILITIES DIRECTLY IF THEY ARE NOT ON BLUESTAKE SYSTEM.
- 4. UNLESS OTHERWISE NOTED, STATIONS SHOWN ON PIPE PROFILES ARE ALONG CENTERLINE OF PIPE.
- 5. ALL EXISTING DRIVEWAYS AND ALL EXISTING ALLEYS SHALL BE GRADED TO MATCH THE NEW WORK IN ACCORDANCE WITH STD. DETAIL P-1164, UNLESS OTHERWISE SPECIFIED. EXISTING SURFACING SHALL BE REMOVED AND REPLACED AS NECESSARY.
- 6. UNLESS OTHERWISE PROVIDED ON THE PLANS, EXISTING A.C. OR P.C.C. DRIVEWAYS AND SIDEWALKS WHICH FALL WITHIN OR ABUT THE RIGHT OF WAY SHALL BE CONNECTED TO THE NEW WORK AS FOLLOWS:

THE SPACE BETWEEN THE BACK OF NEW DRIVEWAY ENTRANCES AND EXISTING A.C. DRIVEWAYS SHALL BE FILLED WITH A MINIMUM OF 3" A.C.S.C. ON 100% COMPACTED NATIVE SOIL. WHERE EXISTING PAVEMENT AND BASE THICKNESS EXCEED THE MINIMUMS, MATCH THE EXISTING.

THE SPACE BETWEEN THE BACK OF NEW SIDEWALKS AND EXISTING PRIVATE SIDEWALKS, AND THE SPACE BETWEEN THE BACK OF NEW DRIVEWAY ENTRANCES AND EXISTING P.C.C. DRIVEWAYS SHALL BE FILLED WITH P.C.C.. THE THICKNESS AND CLASS SHALL MATCH THAT OF THE NEW SIDEWALK OR DRIVEWAY ENTRANCE.

UNLESS OTHERWISE PROVIDED ON THE PLANS, THE SPACE BETWEEN THE BACK OF THE NEW SIDEWALKS, AND EXISTING A.C. PARKING LOTS, WHICH FALL WITHIN OR ABUT THE R/W SHALL BE FILLED WITH 2" A.C.S.C. ON 100% COMPACTED NATIVE SOIL.

- 7. ALL QUANTITIES SHOWN ARE APPROXIMATE AND ARE FURNISHED SOLELY FOR THE CONTRACTOR'S CONVENIENCE. IT IS THE SOLE RESPONSIBILITY OF THE CONTRACTOR TO VERIFY THE ACTUAL QUANTITIES OF WORK REQUIRED AND BASE HIS BID ON HIS OWN INDEPENDENT ESTIMATE OF THE WORK SCOPE AND QUANTITIES OF MATERIALS REQUIRED. THEY DO NOT NECESSARILY CORRESPOND TO BID SCHEDULE ITEMS. PAYMENT WILL BE BASED ON BID SCHEDULE ITEMS. THE CONTRACTOR SHALL NOT BE RELIEVED OF RESPONSIBILITY FOR INDEPENDENTLY ESTIMATING QUANTITIES PRIOR TO BIDDING. THE CONTRACTOR REPRESENTS THAT THE TOTAL CONTRACT SUM IS ADEQUATE COMPENSATION FOR COMPLETING THE ENTIRE PROJECT AS SHOWN ON THE PLANS.
- 8. THE LOCATION OF EXISTING FEATURES INDICATED ON THE PLANS ARE APPROXIMATE. THE CONTRACTOR SHALL NOT BE RELIEVED OF RESPONSIBILITY FOR MAKING COMPLETE AND ACCURATE ON—SITE DETERMINATIONS OF THE LOCATIONS OF ALL UTILITIES, STRUCTURES AND FIELD CONDITIONS, WHICH MAY AFFECT THE PROGRESS OF THE WORK.
- 9. THESE PLANS ARE SUBJECT TO THE INTERPRETATION OF INTENT BY THE ENGINEER. ALL QUESTIONS REGARDING THESE PLANS SHALL BE DIRECTED TO THE ENGINEER. ANY INTERPRETATION OF THE PLANS BY ANYONE OTHER THAN THE ENGINEER SHALL BE RESPONSIBLE FOR AND CONSEQUENCES THEREOF.

- 10. ADEQUATE DRAINAGE OF THE CONSTRUCTION AREA SHALL BE PROVIDED AT ALL TIMES. CONSTRUCTION DRAINS SHALL BE PROVIDED AS NEEDED TO ENABLE WATER TO DRAIN FROM THE CONSTRUCTION AREA WITHOUT DAMAGING THE WORK IN PROGRESS. TO FURTHER PROMOTE ADEQUATE DRAINAGE OF THE SITE, AND DRAINAGE INFRASTRUCTURE SHALL BE CONSTRUCTED FROM DOWNSTREAM TO UPSTREAM IN SUCH A WAY THAT DURING CONSTRUCTION THEY DO NOT IMPEDE THE FLOW OF WATER FROM THE CONSTRUCTION AREA.
- DAMAGE TO ADJACENT PROPERTIES OR TO ANY PORTION OF THE WORK CAUSED BY THE CONTRACTOR'S FAILURE TO PROVIDE ADEQUATE DRAINAGE OF THE CONSTRUCTION SITE OR TO ORDER THE WORK SO AS TO MINIMIZE THE POSSIBLE EXTENT OF SUCH DAMAGE SHALL BE REPAIRED AT THE CONTRACTOR'S EXPENSE.
- 11. EXACT POINT OF MATCHING AND TERMINATION OF IMPROVEMENTS MAY BE ADJUSTED IN THE FIELD BY THE ENGINEER IF NECESSARY.
- 12. ELEVATIONS SHOWN ON THE PLANS ARE TO FINISHED GRADE, UNLESS OTHERWISE NOTED OR SPECIFIED.
- 13. A SET OF SIGNED APPROVED CONSTRUCTION DOCUMENTS WILL BE KEPT DURING WORK HOURS AT THE JOB SITE ON WHICH ALL CHANGES OR VARIATIONS IN THE WORK, INCLUDING ALL EXISTING UTILITIES, ARE TO BE RECORDED AND/OR CORRECTED DAILY AND SUBMITTED TO THE CITY ENGINEER WHEN THE WORK IS COMPLETED.
- 14. CONTRACTOR SHALL PROVIDE AND MAINTAIN SUFFICIENT BARRICADES TO PROVIDE FOR THE SAFETY OF THE GENERAL PUBLIC TO THE SATISFACTION OF THE CITY ENGINEER.
- 15. ALL MATERIALS SHALL BE FURNISHED AND INSTALLED BY THE CONTRACTOR UNLESS OTHERWISE NOTED.
- 16. PRIOR TO COMMENCEMENT OF CONSTRUCTION THE CONTRACTOR SHALL COORDINATE WORK WITH ALL UTILITY COMPANIES AND ADJACENT PROPERTY OWNERS.
- 17. THE CONTRACTOR SHALL NOTIFY THE ENGINEER IMMEDIATELY IF THERE ARE ANY DISCREPANCIES ON THESE PLANS THAT COME TO HIS ATTENTION PRIOR TO OR DURING CONSTRUCTION.
- 18. THE CONTRACTOR SHALL PROVIDE AND MAINTAIN ACCESS AT ALL TIMES. RESTRICTED PARKING IS TO BE LIMITED TO THE IMMEDIATE WORK AREA ONLY. ALL OTHER PARKING IS TO REMAIN OPEN AT ALL TIMES.
- 19. THE CONTRACTOR IS RESPONSIBLE FOR SECURING A STAGING AND EQUIPMENT STORAGE AREA.
- 20. NO CONTRACTOR ON—SITE OFFICE IS REQUIRED. CONTRACTOR TO PROVIDE THE REQUIRED EMERGENCY CONTACTS.
- 21. ANY WORK PERFORMED WITHOUT THE KNOWLEDGE AND APPROVAL OF THE CITY ENGINEER OR HIS AUTHORIZED REPRESENTATIVE IS SUBJECT TO REMOVAL AND REPLACEMENT AT THE CONTRACTOR'S EXPENSE.
- 22. THE CITY ENGINEER MAY ORDER ANY OR ALL MATERIALS USED IN THE WORK TO BE TESTED ACCORDING TO THE AMERICAN ASSOCIATION OF STATE HIGHWAY AND TRANSPORTATION OFFICIALS (AASHTO) AND THE AMERICAN SOCIETY FOR TESTING AND MATERIALS (ASTM) STANDARDS. THE CONTRACTOR SHALL, AT HIS EXPENSE, SUPPLY ALL SAMPLES REQUIRED FOR TESTING.
- 23. THE CONTRACTOR SHALL BE RESPONSIBLE FOR MAINTENANCE OF THE STREETS AND OF PARTIALLY COMPLETED PORTIONS OF THE WORK UNTIL FINAL ACCEPTANCE OF THE WORK. THE CONTRACTOR SHALL SUBMIT TO THE CITY ENGINEER FOR APPROVAL A CONSTRUCTION SCHEDULE FOR ANY STREETS REQUIRED TO BE CLOSED OR PARTIALLY CLOSED FOR THE CONSTRUCTION ACTIVITY. THE CONTRACTOR SHALL REOPEN THE STREETS NO LATER THAN THE OPENING DATE SHOWN ON THE CONSTRUCTION SCHEDULE OR UPON ORDER OF THE CITY ENGINEER. THE REGULATION AND CONTROL OF CONSTRUCTION TRAFFIC SHALL BE AS DIRECTED BY THE CITY ENGINEER OR HIS AUTHORIZED REPRESENTATIVE.
- 24. DISPOSAL OF ALL WASTE MATERIAL, BROKEN CONCRETE, ETC. WILL BE THE RESPONSIBILITY OF THE CONTRACTOR, SUBJECT TO THE APPROVAL OF THE ENGINEER.
- 25. THE CONTRACTOR SHALL OBTAIN ALL THE NECESSARY PERMITS FROM THE CITY OF SEDONA FOR WORK WITHIN THEIR JURISDICTIONS.
- 26. CONSTRUCTION SHALL NOT INTERFERE WITH MAIL DELIVERY AND WILL ALLOW FOR UNINTERRUPTED TRASH PICKUP.
- 27. ALL TAPER, RADII AND TURNOUT DIMENIONS ARE TO THE EDGE OF NEW PAVEMENT, UNLESS OTHERWISE NOTED. ALL STATION AND CALLOUT DISTANCES LEFT AND RIGHT REFER TO THE CONSTRUCTION CENTERLINE UNLESS OTHERWISE NOTED.

- 28. THE CONTRACTOR SHALL MAINTAIN UTILITY SERVICES AND DRAINAGE WITHOUT INTERRUPTION THROUGHOUT THIS CONTRACT.
- 29. ALL EXPOSED CONCRETE SHALL BE DAVIS COLORS. SEE SPECIAL PROVISIONS.

STRUCTURAL NOTES

- 1. "CLEAR" DIMENSIONS FOR DEPTH OF REINFORCING STEEL ARE FROM FACE OF CONCRETE TO FACE OF BARS.
- 2. ALL EXPOSED EDGES OF CONCRETE SHALL BE BEVELED OR ROUNDED UNLESS OTHERWISE NOTED.
- 3. ALL EXPOSED CONCRETE SURFACES SHALL BE FINISHED IN ACCORDANCE WITH ARIZONA DEPT. OF TRANSPORTATION STANDARD SPECIFICATION 601-3.05 FINISHING FORMED CONCRETE, UNLESS OTHERWISE SPECIFIED.

ADOT ENCROACHMENT PERMIT GENERAL NOTES

- 1. ALL WORK WITHIN THE ARIZONA DEPARTMENT OF TRANSPORTATION RIGHT-OF-WAY, HELD EITHER IN EASEMENT, FEE OR DEDICATED, SHALL BE DESIGNED AND CONSTRUCTED IN ACCORDANCE WITH ADOT PUBLICATIONS AS CURRENTLY REVISED, INCLUDING BUT NOT LIMITED TO THE FOLLOWING:
- 1. STANDARD SPECIFICATIONS FOR ROAD AND BRIDGE CONSTRUCTION 2021 EDITION
- 2. CONSTRUCTION STANDARD DRAWINGS MAY 2012 EDITION INCLUDING REVISIONS 3. TRAFFIC ENGINEERING STANDARDS, GUIDELINES AND REFERENCES
- 3.a. GUIDELINES AND PROCESSES CURRENT VERSIONS
 3.b. ARIZONA MANUAL OF APPROVED SIGNS (MOAS)
- 3.c. SIGNING AND MARKING STANDARD DRAWINGS
- 3.d. SIGNALS AND LIGHTING STANDARD DRAWINGS
- 3.e. MANUAL OF UNIFORM TRAFFIC CONTROL DEVICES 2009 EDITION
- 3.f. ARIZONA SUPPLEMENT TO MANUAL OF UNIFORM TRAFFIC CONTROL DEVICES 2009 EDITION
- 4. ANY AND ALL OTHER ADOT TRAFFIC ENGINEERING REFERENCES 5. ADOT APPROVED PRODUCTS LIST CURRENT EDITION
- 6. EROSION AND POLLUTION CONTROL MANUAL FOR HIGHWAY DESIGN AND CONSTRUCTION DECEMBER 2012
- 7. EROSION/SEDIMENT AND WATER QUALITY PROTECTION BEST MANAGEMENT PRACTICES (BMP) DETAILS
- 2. IN ADDITION ANY AND ALL MATERIALS UTILIZED IN CONSTRUCTION WITHIN THE RIGHTS—OF—WAY OF THE ARIZONA DEPARTMENT OF TRANSPORTATION SHALL MEET THE REQUIREMENTS OF STANDARD SPECIFICATIONS FOR ROAD AND BRIDGE CONSTRUCTION 2021 EDITION AND/OR BE AN APPROVED MATERIAL LISTED IN THE CURRENT ADOT APPROVED PRODUCTS LIST ALSO KNOWN AS THE APL.
- 3. ADOT STANDARD SPECIFICATIONS FOR ROAD AND BRIDGE CONSTRUCTION 2021 EDITION SECTION 106.08 SHALL APPLY WHEN PLANS REQUIRE THE USE OF AN ALTERNATIVE OR A SUBSTITUTION ARTICLE OF EQUIPMENT, MATERIAL OR PROCESS
- 4. SECTION 106.14 OF THE ADOT STANDARD SPECIFICATIONS FOR ROAD AND BRIDGE CONSTRUCTION 2021 EDITION SHALL APPLY WHEN A PRODUCT THAT IS NOT LISTED IN THE CURRENT APL IS PROPOSED FOR USE.
- 5. ALL MATERIALS UTILIZED FOR A PERMITTED ACTIVITY SHALL BE SAMPLED AND TESTED IN ACCORDANCE WITH THE REQUIREMENTS OF THE FOLLOWING UNLESS OTHERWISE APPROVED IN WRITING BY THE ADOT:
 - 1. SECTION 106.04 OF ADOT STANDARD SPECIFICATIONS FOR ROAD AND BRIDGE CONSTRUCTION 2021 EDITION
 - 2. THE ADOT MATERIALS TESTING MANUAL
 - 3. THE ADOT MATERIALS TESTING MANUAL


 3. THE ADOT MATERIALS POLICY AND PROCEDURES DIRECTIVES MANUAL
 - 4. APPLICABLE FEDERAL, AASHTO OR ASTM SPECIFICATION OR TEST
 DESIGNATIONS
 - 5. APPLICABLE SPECIFICATION OR TEST DESIGNATIONS OF OTHER RECOGNIZED ORGANIZATIONS
- 6. THE TERM "ENGINEER" AS STATED IN SECTION 106.08 AND SECTION 106.14 OF THE ADOT STANDARD SPECIFICATIONS FOR ROAD AND BRIDGE CONSTRUCTION 2021 EDITION SHALL REFER TO THE ADOT DISTRICT DEVELOPMENT ENGINEER, THE DISTRICT ASSISTANT DISTRICT ENGINEER AND/OR THE DISTRICT ENGINEER.
- 7. ALL ADOT RIGHT-OF-WAY MARKERS AND/OR PROPERTY CORNERS SHALL BE PRESERVED, OR BE RE-ESTABLISHED UPON COMPLETION OF THE WORK BY A SURVEYOR LICENSED BY THE STATE OF ARIZONA.

EARTHWORK SUMMARY

STRUCTURAL EXCAVATION 933 CY
STRUCTURAL BACKFILL 1015 CY
CHANNEL EXCAVATION 1765 CY
SHRINK (20%) 525 CY
GROUND COMPACTION (0.2') 23 CY
WASTE 2185 CY

NOTES:

- 1. ALL PROJECT EARTHWORK WITH THE EXCEPTION OF CHANNEL EXCAVATION SHALL BE CONSIDERED INCIDENTAL TO SUBGRADE PREPARATION. SEE SPECIAL PROVISIONS.
- 2. THE ABOVE QUANTITIES REPRESENT FINAL EARTHWORK. THIS IS ANTICIPATED TO BE A WASTE PROJECT SINCE THE AVAILABLE GEOTECHNICAL INFORMATION INDICATES THAT THERE IS SUITABLE MATERIAL ON—SITE. NO SEPARATE MEASUREMENT AND PAYMENT WILL BE MADE FOR IMPORT MATERIAL, THE AVAILABILITY OF EARTHWORK MATERIAL DURING CONSTRUCTION (INTERIM EARTHWORK QUANTITIES) WILL DEPEND ON THE CONTRACTOR'S CONSTRUCTION PHASING.

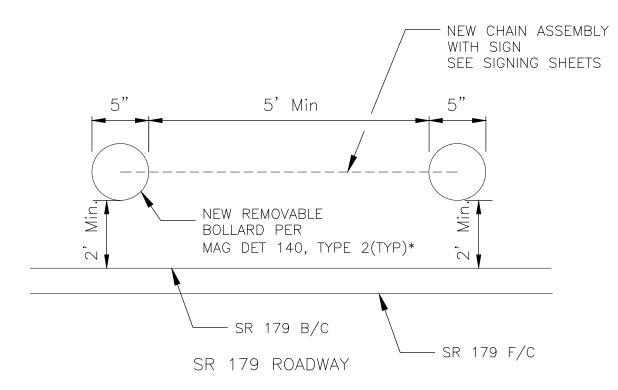

* SEE PLANS FOR LOCATION INFORMATION. BOLLARDS SHALL BE PLACED SUCH THAT AT LEAST 5-FT WIDTH OF SIDEWALK AND RAMP IS AVAILABLE FOR PEDESTRIAN USE. FINAL BOLLARD LOCATIONS SHALL BE FIELD VERIFIED AND APPROVED BY THE ENGINEER.

BOLLARDS WITH CHAIN

NTS

**THE DESIGN OF THESE PLANS IS BASED UPON DOCUMENTED COORDINATION TO—DATE THAT THE CITY OF SEDONA MAINTENANCE FORCES WILL PROVIDE AND PLACE BARRICADES AND/OR SIGNAGE TO CLOSE THE CROSSING PRIOR TO OAK CREEK FLOODING.

Symbol	Revisions	Date	Appr.	Designed by:	Date:
				JI	09/06/2022
				——Drawn by:	Scale:
				CPG	NOT TO SCALE
				Checked by:	Project Code:
				JKF	CIVIL








CITY OF SEDONA
PUBLIC WORKS DEPARTMENT
102 ROADRUNNER DRIVE


SEDONA, ARIZONA 86336 928-204-7111 SR 179 PEDESTRIAN CROSSING AT OAK CREEK SEDONA ARIZONA SHEET ID

GENERAL NOTES SHEET

SHEET NO.

4

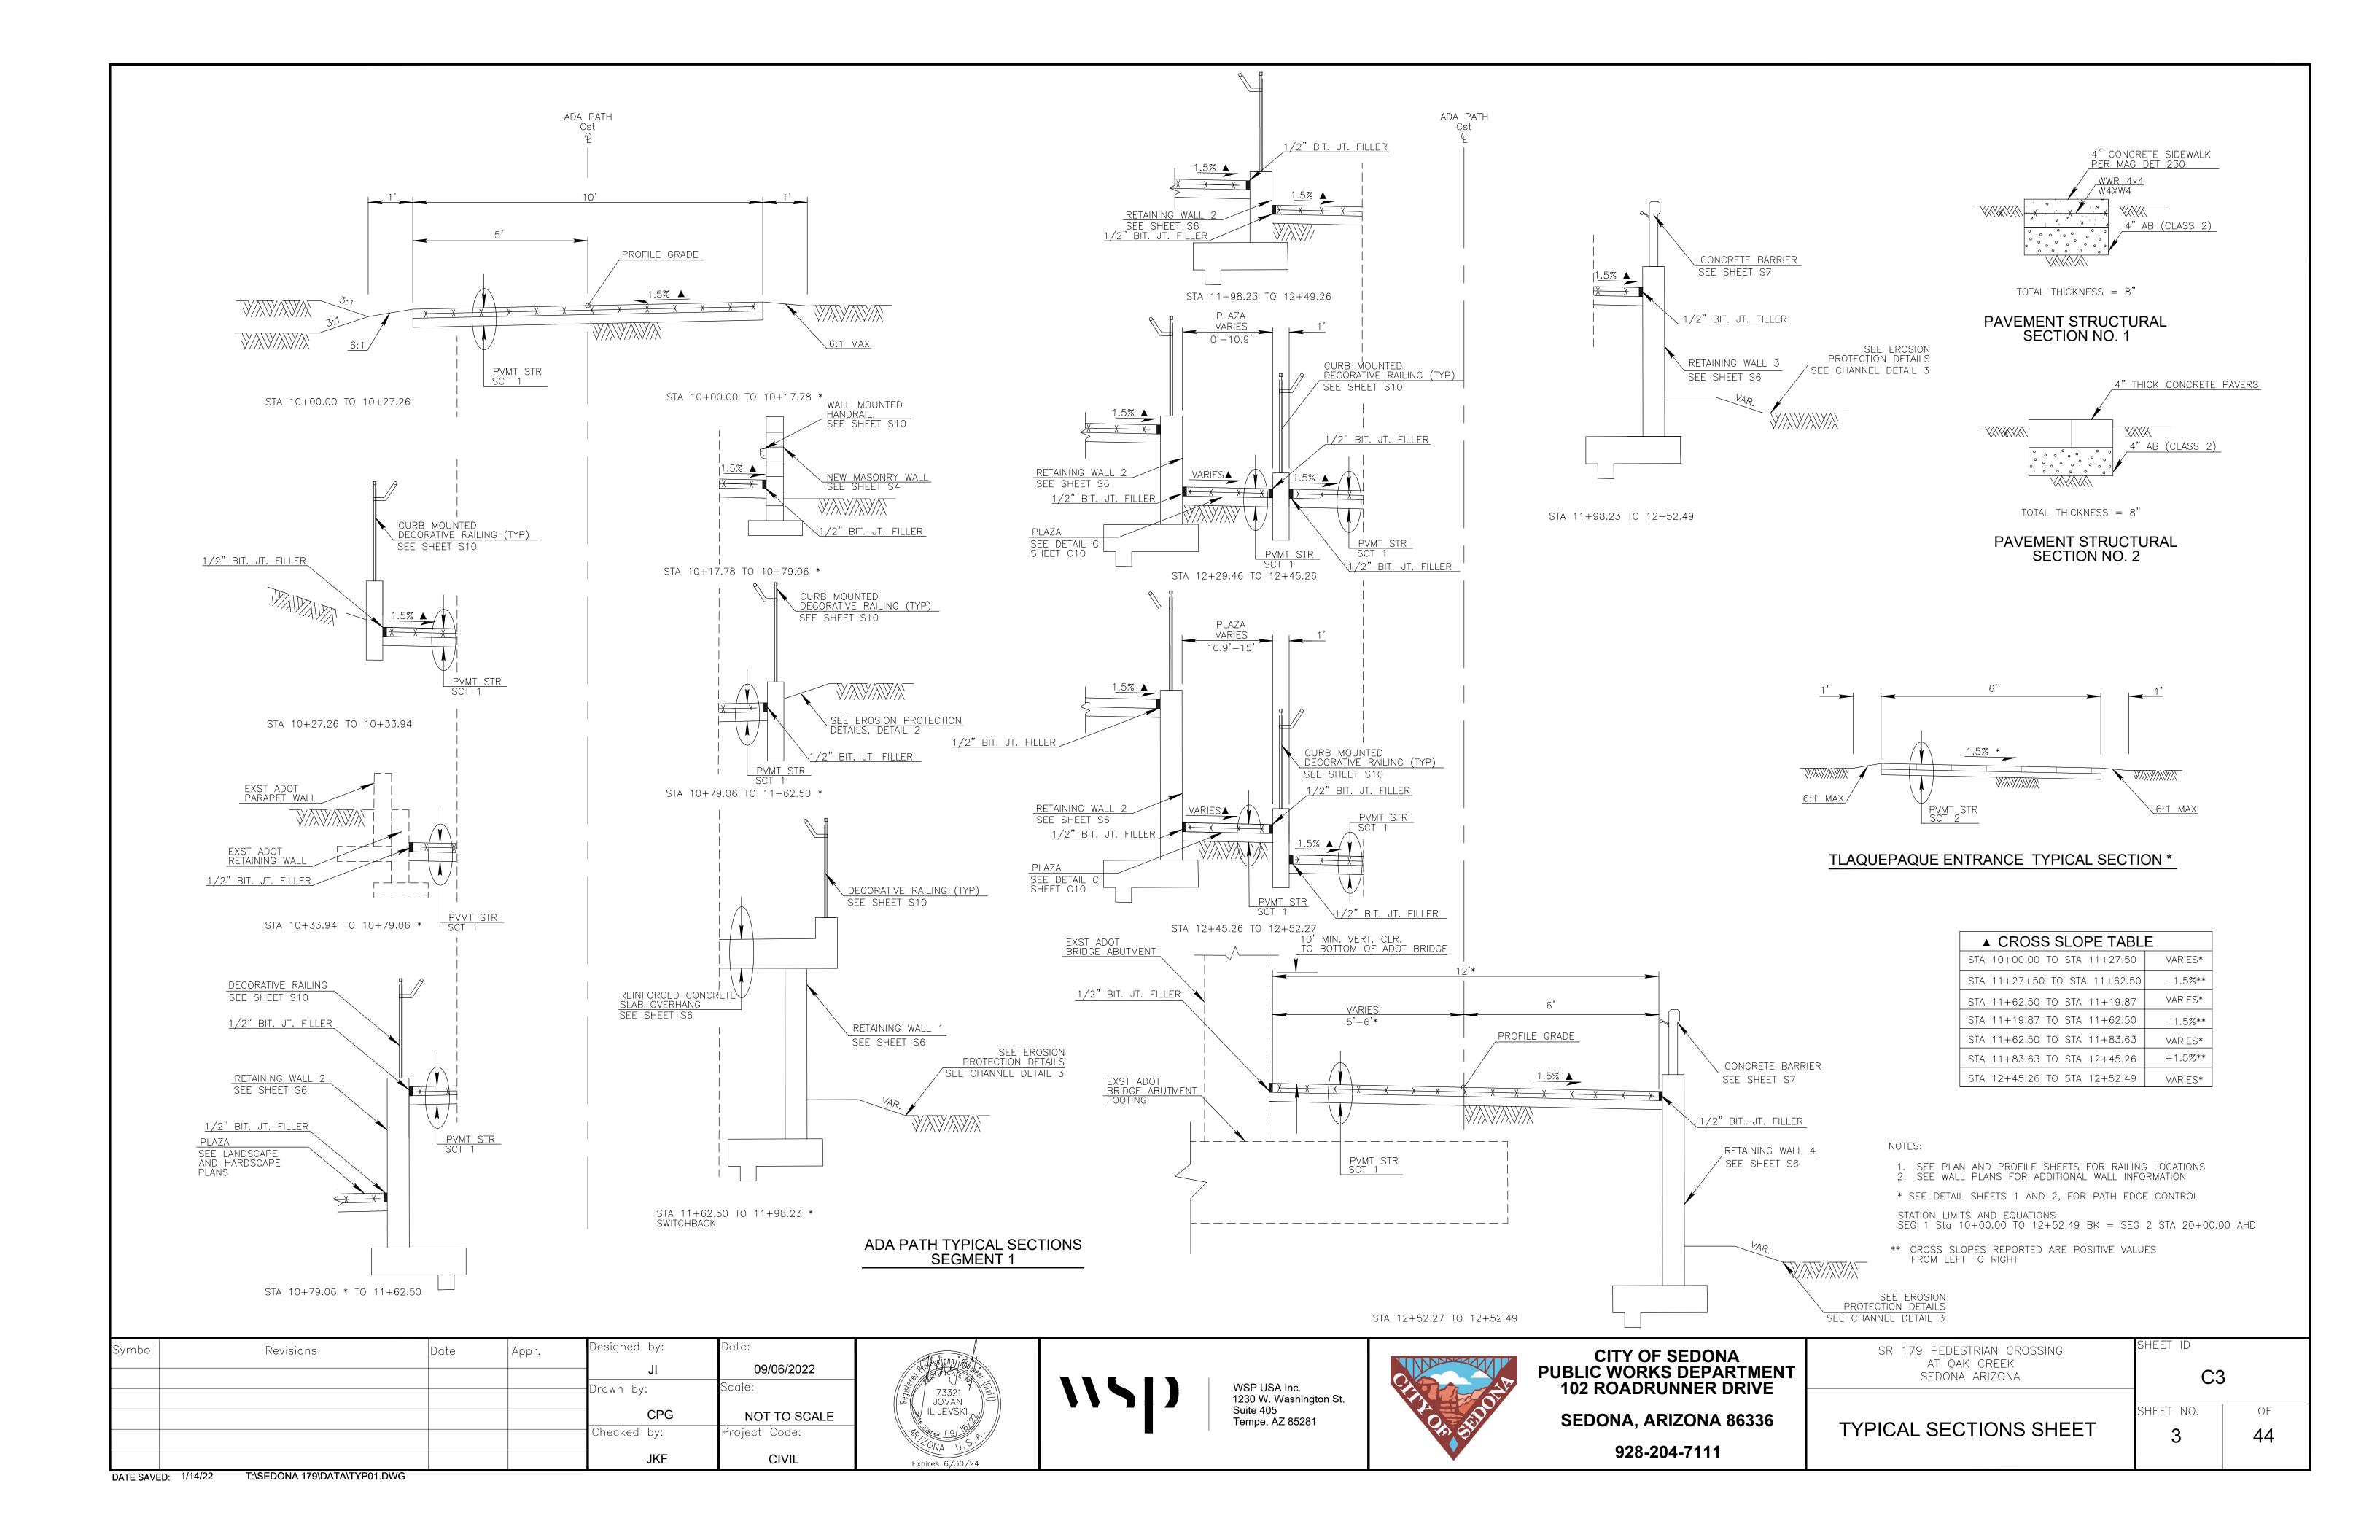

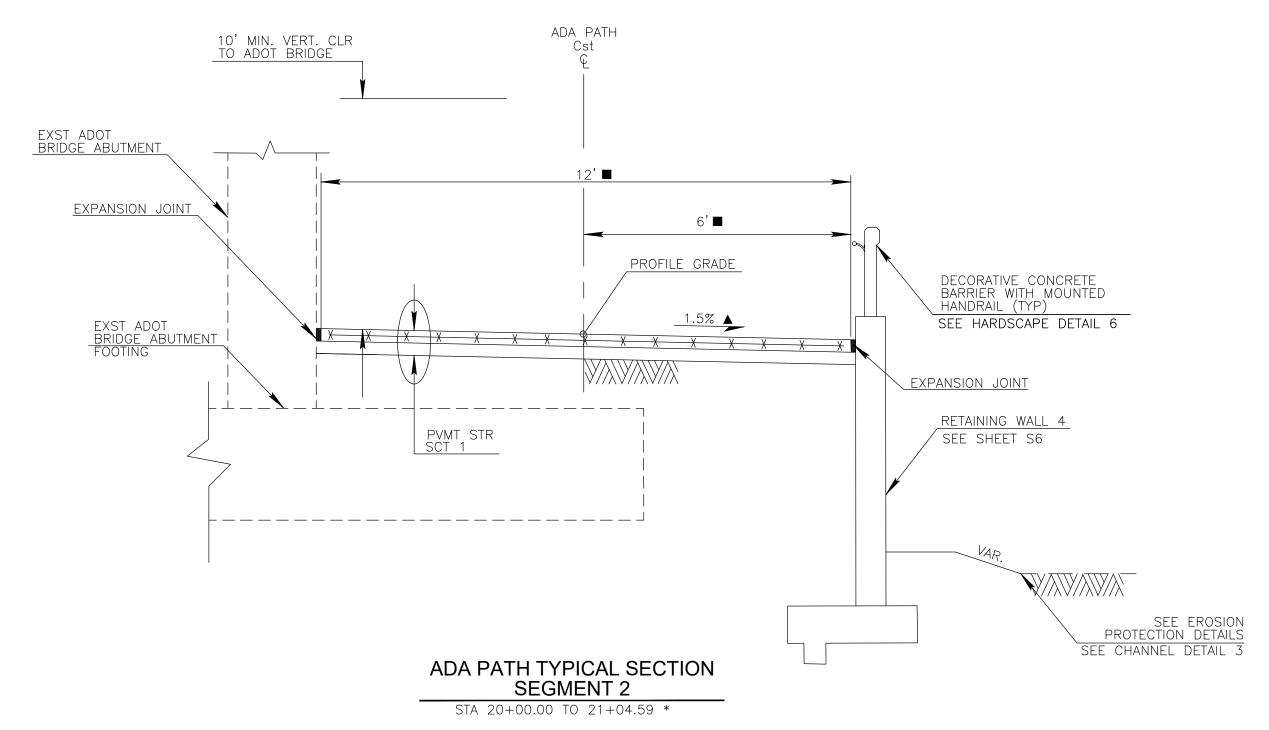


▲ CROSS SLOPE TABLE						
STA 20+00.00 TO STA 20+05.00	VARIES*					
STA 20+05.00 TO STA 20+99.59	+1.5%**					
STA 20+99.59 TO STA 21+04.59	VARIES*					
STA 22+00.00 TO STA 23+75.45	+1.5%**					
STA 23+75.45 TO STA 23+87.66	VARIES*					

	■ PATH WIDTH							
STA	20+00.00	ТО	STA	20+43.01	12'			
STA	20+43.01	ТО	STA	20+65.55	VARIES			
STA	20+65.55	ТО	STA	20+99.59	12'			
STA	20+99.59	ТО	STA	21+04.59	VARIES			
STA	22+00.00	ТО	STA	23+29.18	10'			
STA	23+29.18	ТО	STA	23+87.86	VARIES			

- 1. SEE PLAN AND PROFILE SHEETS FOR HANDRAIL LOCATIONS
 2. SEE WALL PLANS FOR ADDITIONAL WALL INFORMATION
- * SEE DETAIL SHEETS 1 AND 2, FOR PATH EDGE CONTROL

STATION LIMITS AND EQUATIONS SEG 2 Sta 20+00.00 AHD TO 21+04.59 BK= SEG 3 Sta 22+00.00 AHD TO 23+87.66

** CROSS SLOPES REPORTED ARE POSITIVE VALUES FROM LEFT TO RIGHT

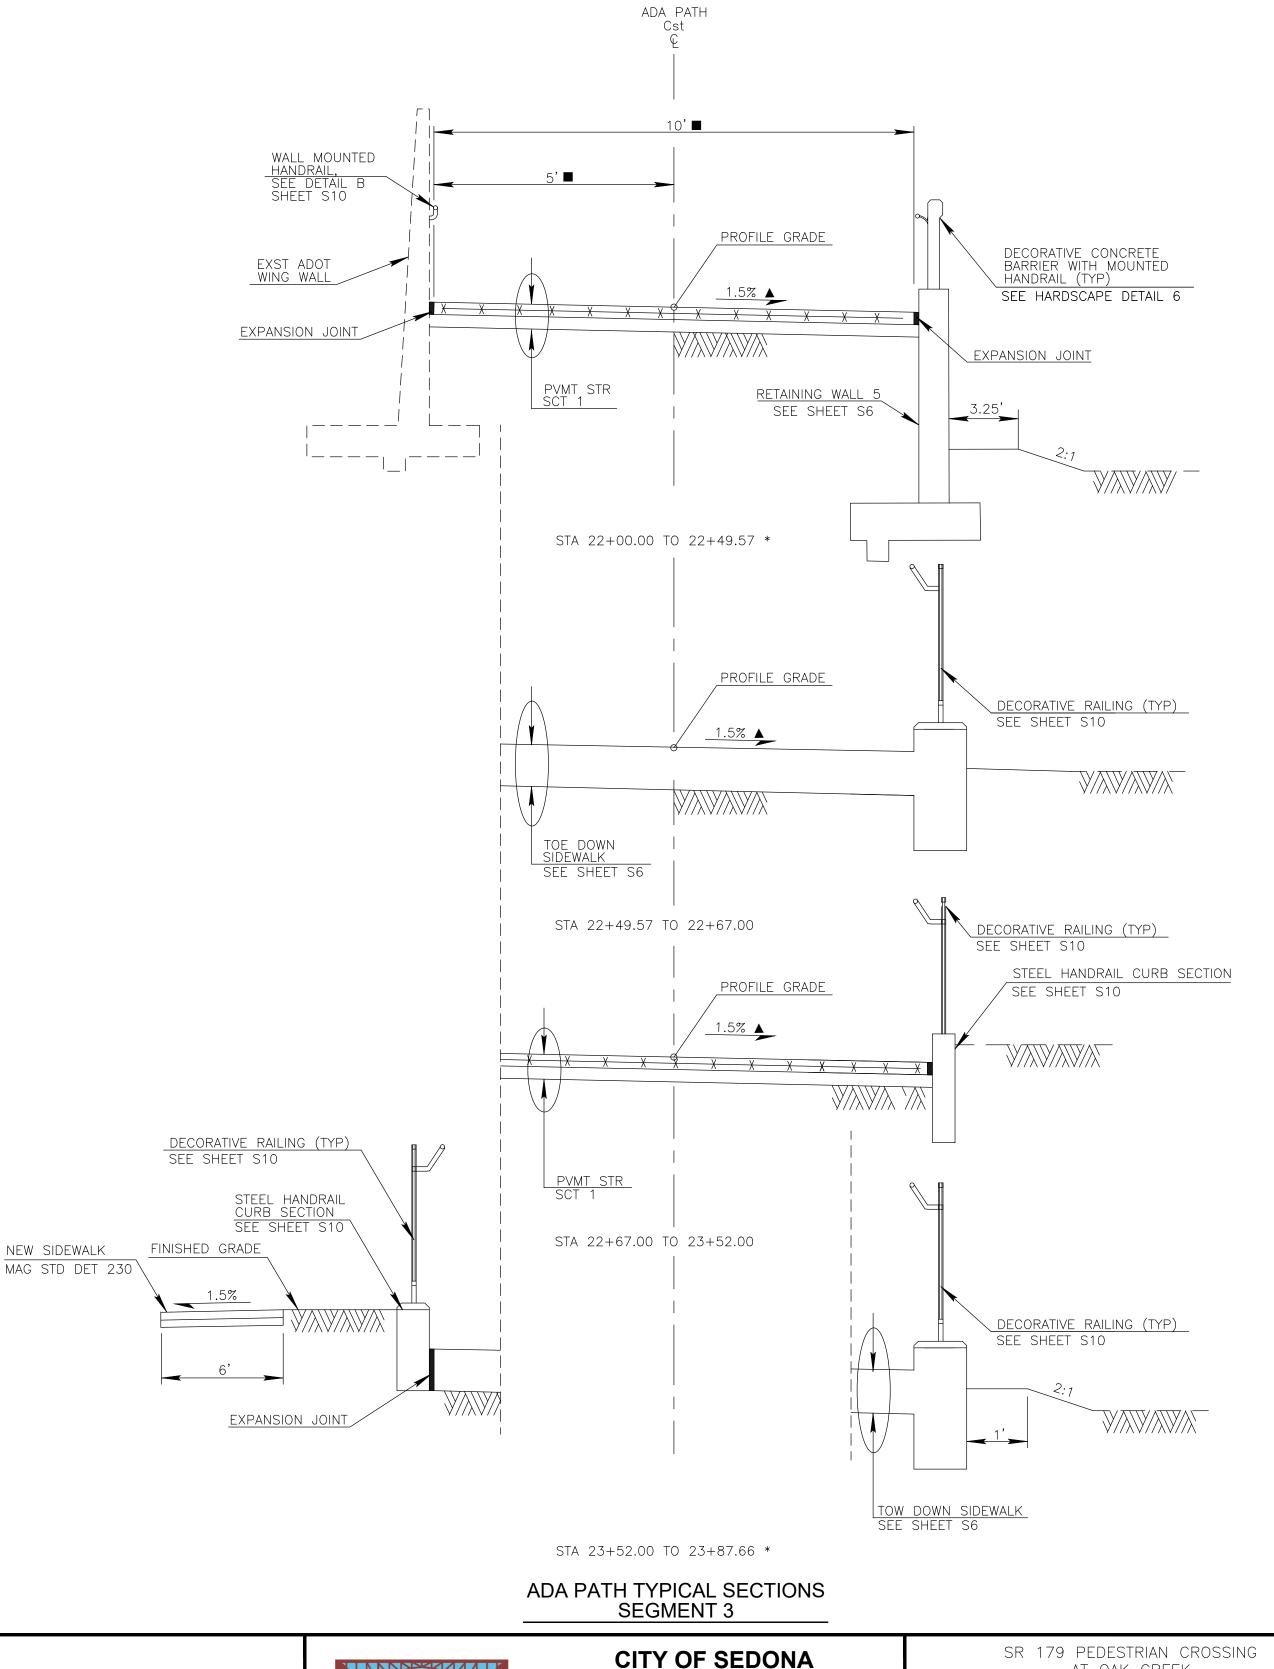

Symbol Revisions

Date Appr.

Designed by:

JI 09/06/2022


Drawn by:

CPG NOT TO SCALE

Checked by:

Project Code:

JKF CIVIL

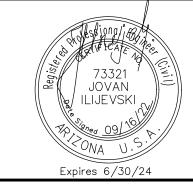



WSP USA Inc. 1230 W. Washington St. Suite 405 Tempe, AZ 85281



CITY OF SEDONA
PUBLIC WORKS DEPARTMENT
102 ROADRUNNER DRIVE

SEDONA, ARIZONA 86336 928-204-7111 SR 179 PEDESTRIAN CROSSING AT OAK CREEK SEDONA ARIZONA

TYPICAL SECTIONS

C4

SHEET NO. OF

4 44

HEET ID

DATE SAVED: 9/17/22 T:\SEDONA 179\DATA\TYP02.DWG

ITEM DESCRIPTION	UNIT	QUANTITY TOTAL
MATERIALS TESTING	JOB	1
CONSTRUCTION SURVEY AND LAYOUT	JOB	1
AS-BUILT PREPARATION	JOB	1
MOBILIZATION/DEMOBILIZATION	JOB	1
MAINTENANCE AND PROTECTION OF TRAFFIC	JOB	1
STORM WATER POLLUTION PREVENTION PLAN	JOB	1
REMOVE AND SALVAGE EXISTING PROPERTY WALL	LF	78
REMOVE EXST SITE WALL	LF	22
REMOVE AND SALVAGE EXST POLE WITH WIND ART	EACH	3
REMOVE AND SALVAGE EXST TLAQUEPAQUE ARCH SIGN	EACH	1
REMOVE EXST ASPHALTIC CONCRETE PAVEMENT	SY	15
REMOVE EXST CONCRETE SIDEWALK	SF	381
REMOVE AND STOCKPILE EXISTING EROSION PROTECTION	LSUM	1
REMOVE EXST GABIONS	SF	120
REMOVE AND RELOCATE EXST WATER QUALITY BOX	EACH	1
RELOCATE FIRE HYDRANT	EACH	1
RELOCATE EXSTING PROPERTY WALL LIGHTS	EACH	2
RELOCATE AND ROTATE EXST WATER METER	EACH	1
RELOCATE EXST LIGHT POLE	EACH	2
RELOCATE EXST CATV BOX	EACH	1
ADJUST VALVE BOX AND COVER TO GRADE PER MAG STD DTL 270	EACH	1
REMOVE EXST DUMPED RIPRAP	CU. YD.	735
RELOCATE EXST TELCO PEDESTAL	EACH	1
TREE PROTECTION SHORING	LSUM	1
TEMPORARY FILL STABILIZATION	LSUM	1
SUBGRADE PREP	SY	764
CHANNEL EXCAVATION (INCL. HAUL OFFSITE)	CY	1,765
AGGREGATE BASE COURSE	TON	151
SIDEWALK TOEDOWN	SF	611
CONCRETE SIDEWALK PER MAG STD DTL 230 WITH MESH	SF	5,589
CONCRETE PAVERS	SF	104
CURB MOUNTED DECORATIVE RAILING	LF	129
MEDIAN BOLLARDS AND CHAIN (SPECIAL DETAIL)	EACH	4
3-FT MAN GATE WITH LOCK	EACH	1
REINFORCED CONCRETE CANTILEVER RETAINING WALL	SF	3,214
MASONRY PROPERTY WALL	SF	700
SHORT CONCRETE GRAVITY WALL	SF	51
REINFORCED CONCRETE SLAB OVERHANG	SF	572
NEW MODIFIED MAG 206 CONCRETE SCUPPER	EACH	•
NEW DRAIN INLECTED COOLE	EACH	4
PRESSURE INJECTED GROUT	LSUM	240
PLACE SALVAGED DUMPED RIVER ROCK	CY	340
GABION MATTRESS AND BASKETS	CY	31
LANDSCAPING	LSUM	1

ITEM DESCRIPTION	UNIT	QUANTITY TOTAL
IRRIGATION	LSUM	1
FORCE ACCOUNT WORK (LS AND IR RESTORATION)	LSUM	1
TLAQUEPAQUE PROPERTY SYCAMORE TREE PROTECTION	LSUM	1
CONCRETE BARRIER	LF	208
CONCRETE BARRER WITH HANDRAIL	LF	52
DECORATIVE RAILING	LF	663
DECORATIVE RAILING WITH HANDRAIL	LF	216
HANDRAIL (WALL ATTACHMENT)	LF	243
TRASH RECEPTACLE	EACH	3
SIGN POST (PERFORATED) (2 S)	L.FT.	32
SIGN POST (PERFORATED) (2 1/2 S)	L.FT.	32
FOUNDATION FOR SIGN POST (CONCRETE)	EACH	5
WARNING, MARKER, OR REGULATORY SIGN PANEL	SF	14
FLAT SHEET ALUMINUM SIGN PANEL	SF	32
WATERBORNE-TYPE I PAVEMENT MARKING(PAINTED)(YELLOW)	LF	126
ELECTRICAL CONDUIT (1") (PVC)	LF	80
ELECTRICAL CONDUIT (1 1/2") (PVC)	LF	760
PULL BOX (NO. 5)	EACH	4
PULL BOX (6" x 6" In Wall)	EACH	3
PULL BOX (8" x 6" In Wall)	EACH	9
CONDUCTOR (NO. 12)	LF	1,920
CONDUCTOR (NO. 10)	LF	540
CONDUCTOR (NO. 8)	LF	1,520
CONDUCTOR (INSULATED BOND)	LF	840
METER PEDESTAL CABINET (LIGHTING)	EACH	1
FORCE ACCOUNT WORK (ELECTRICAL SERVICE)	L.SUM	1
MISCELLANEOUS WORK (LED Rope)	LF	40
MISCELLANEOUS WORK (POLE (14') (Decorative))	EACH	5
MISCELLANEOUS WORK (POLE FOUNDATION (STANDARD BASE))	EACH	5
MISCELLANEOUS WORK (MAST ARM (Decorative))	EACH	5
MISCELLANEOUS WORK (LUMINAIRE (LED) (GBLF3 Decorative))	EACH	5
MISCELLANEOUS WORK (Step Light Wall Fixture)	EACH	20
PAINT EXST ADOT FACILITIES	LSUM	1
CONCRETE STAIN COLOR TREATMENT	EACH	1
WINDOW AND FRAME ART PANEL	LSUM	2
BARREL SIGN BASE	EACH	3

ITEM DESCRIPTION	UNIT	QUANTITY TOTAL
MATERIALS TESTING	JOB	1
CONSTRUCTION SURVEY AND LAYOUT	JOB	1
AS-BUILT PREPARATION	JOB	1
MOBILIZATION/DEMOBILIZATION	JOB	1
MAINTENANCE AND PROTECTION OF TRAFFIC	JOB	1
STORM WATER POLLUTION PREVENTION PLAN	JOB	1
REMOVE AND SALVAGE EXST DECORATIVE BOULDER	EACH	1
ADJUST VALVE BOX AND COVER TO GRADE PER MAG STD DTL 270	EACH	1
REMOVE CURB AND GUTTER	LF	11
REMOVE SINGLE CURB	LF	35
REMOVE CONCRETE SIDEWALK	SF	1,579
REMOVE AND REINSTALL SIGN	EACH	1,575
OBLITERATE PAVEMENT MARKING (STRIPE)	LACIT	2,619
JACKING, BORING OR TUNNELING PIPE	LF	150
ADJUST STORM DRAIN MANHOLE TO GRADE, MAG DTL 422	EACH	130
<u>`</u>		
AGGREGATE BASE COURSE	TON	47
CONCRETE SIDEWALK PER MAG STD DTL 230 WITH MESH	SF	2,157
CURB & GUTTER MAG STD DTL 220, TYPE A	LF . =	15
SINGLE CURB, MAG DTL 222 TYPE A	LF	132
DETECTABLE WARNING	EACH	3
PERPENDICULAR CURB RAMP, MODIFIED MAG DTL 238-1	EACH	1
LANDSCAPING	LSUM	1
IRRIGATION	LSUM	1
DECORATIVE RAILING	LF	111
PREFORMED PAVEMENT MARKING TYPE 1 (PERMANENT)	L.FT.	1,944
SIGN POST (PERFORATED) (2 1/2 S)	L.FT.	36
SIGN POST (PERFORATED) (2 1/2 T)	L.FT.	20
FOUNDATION FOR SIGN POST (CONCRETE)	EACH	5
WARNING, MARKER, OR REGULATORY SIGN PANEL	SF	68
SLIP BASE (FOR PERFORATED POST)	EACH	2
METER PEDESTAL CABINET (LIGHTING)	EACH	1
METER PEDESTAL CABINET (LIGHTING) METER PEDESTAL CABINET (BATTERY BACKUP, SIGNAL)	EACH	1
CONTROL CABINET (TYPE IV)	EACH	1
,		1
POLE (TYPE A)	EACH	4
POLE FOUNDATION (TYPE A)	EACH	4
TRAFFIC SIGNAL FACE (TYPE F) (MOD H)	EACH	4
TRAFFIC SIGNAL FACE (PEDESTRIAN)(MAN/HAND)	EACH	4
PEDESTRIAN PUSH BUTTON (AUDIBLE)	EACH	4
TRAFFIC SIGNAL MOUNTING ASSEMBLY (TYPE IV)	EACH	4
TRAFFIC SIGNAL MOUNTING ASSEMBLY (TYPE XI)	EACH	4
ELECTRICAL CONDUIT (2") (PVC)	LF	210
ELECTRICAL CONDUIT (3") (PVC)	LF	690
PULL BOX (NO. 5)	EACH	2
PULL BOX (NO. 7)	EACH	6
PULL BOX (NO. 7) (WITH EXTENSION)	EACH	1
CONDUCTORS (TRAFFIC SIGNALS)	L.SUM	1
MISCELLANEOUS (ELECTRICAL)	L.SUM	
MISCELLANEOUS WORK (SIGN MOUNT BRACKET)	EACH	4
,		
MISCELLANEOUS WORK (POLE (30') (Decorative))	EACH	2
MISCELLANEOUS WORK (POLE FOUNDATION (STANDARD BASE))	EACH	2
FORCE ACCOUNT WORK (ELECTRICAL SERVICE)	L.SUM	
MISCELLANEOUS WORK (MAST ARM (Decorative))	EACH	2
MISCELLANEOUS WORK (LUMINAIRE (LED) (Glaswerks Decorative))	EACH	2




BID ALTERNATIVE #1. SEE SPECIAL PROVISIONS.

Symbol	Revisions	Date	Appr.	Designed by:	Date:
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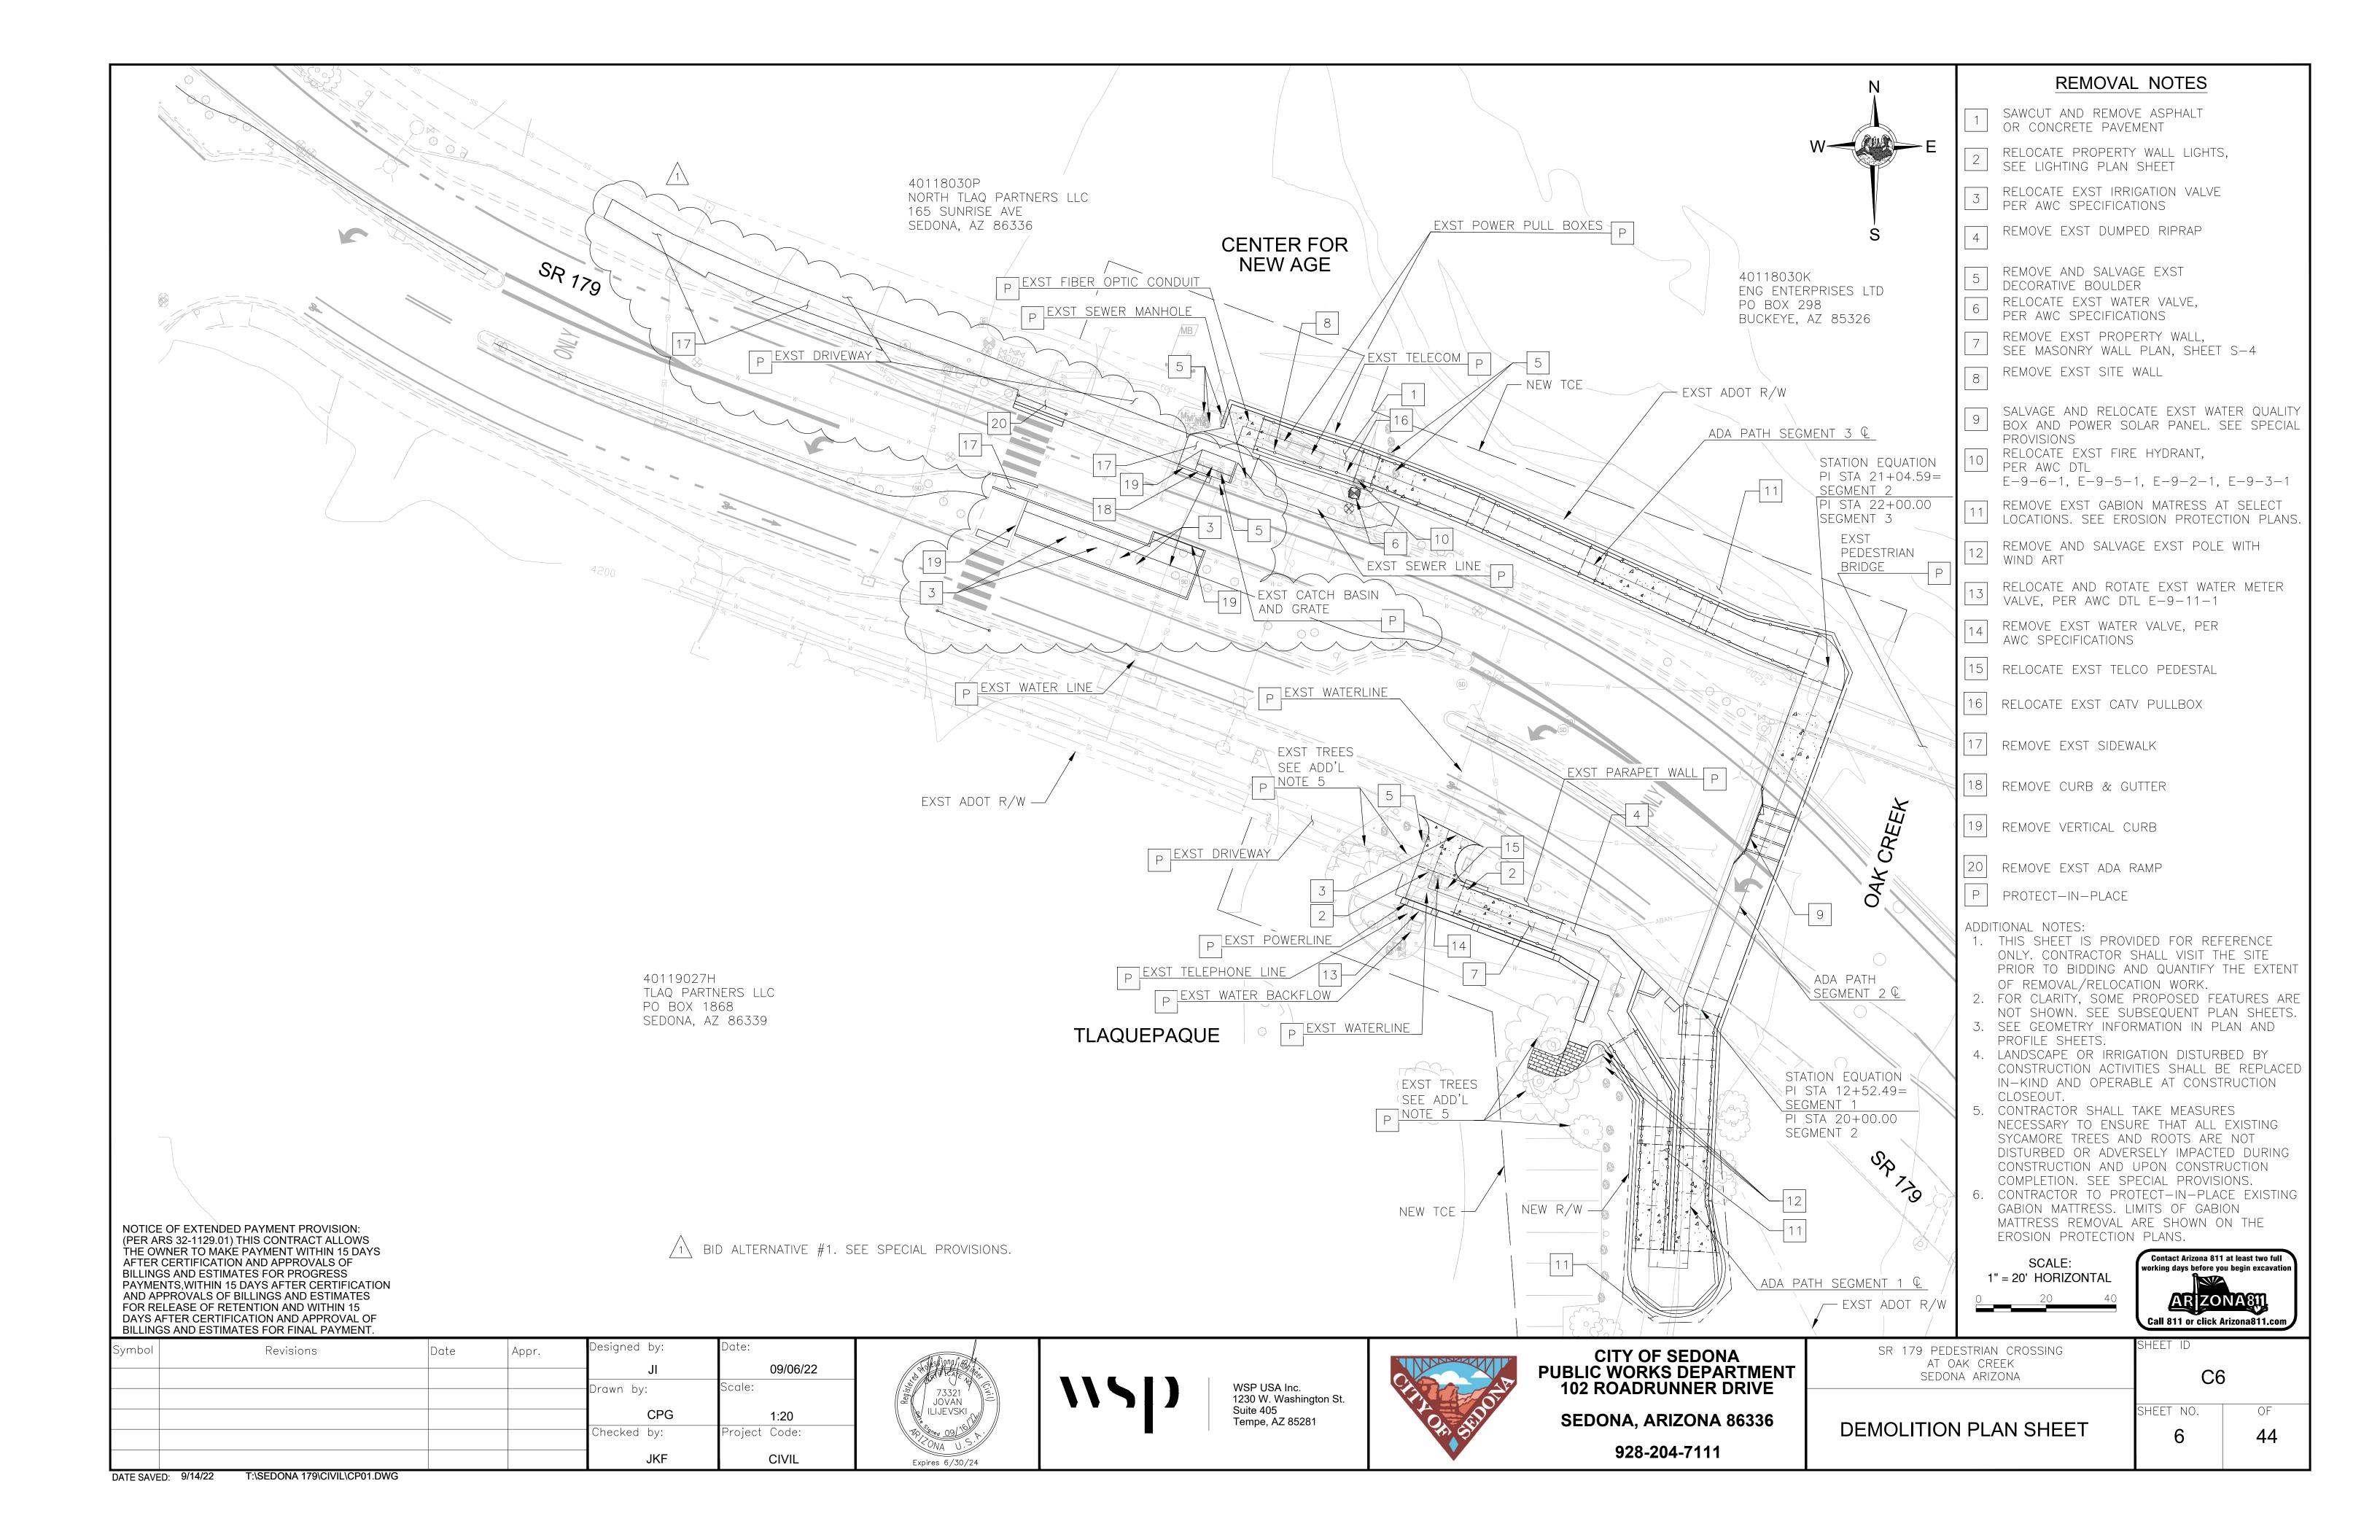






CITY OF SEDONA PUBLIC WORKS DEPARTMENT 102 ROADRUNNER DRIVE SEDONA, ARIZONA 86336

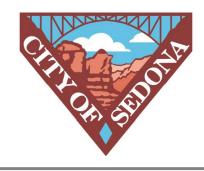
928-204-7111

SR 179 PEDESTRIAN CROSSING AT OAK CREEK SEDONA ARIZONA	C5	
QUANTITY SUMMARY SHEET	SHEET NO.	



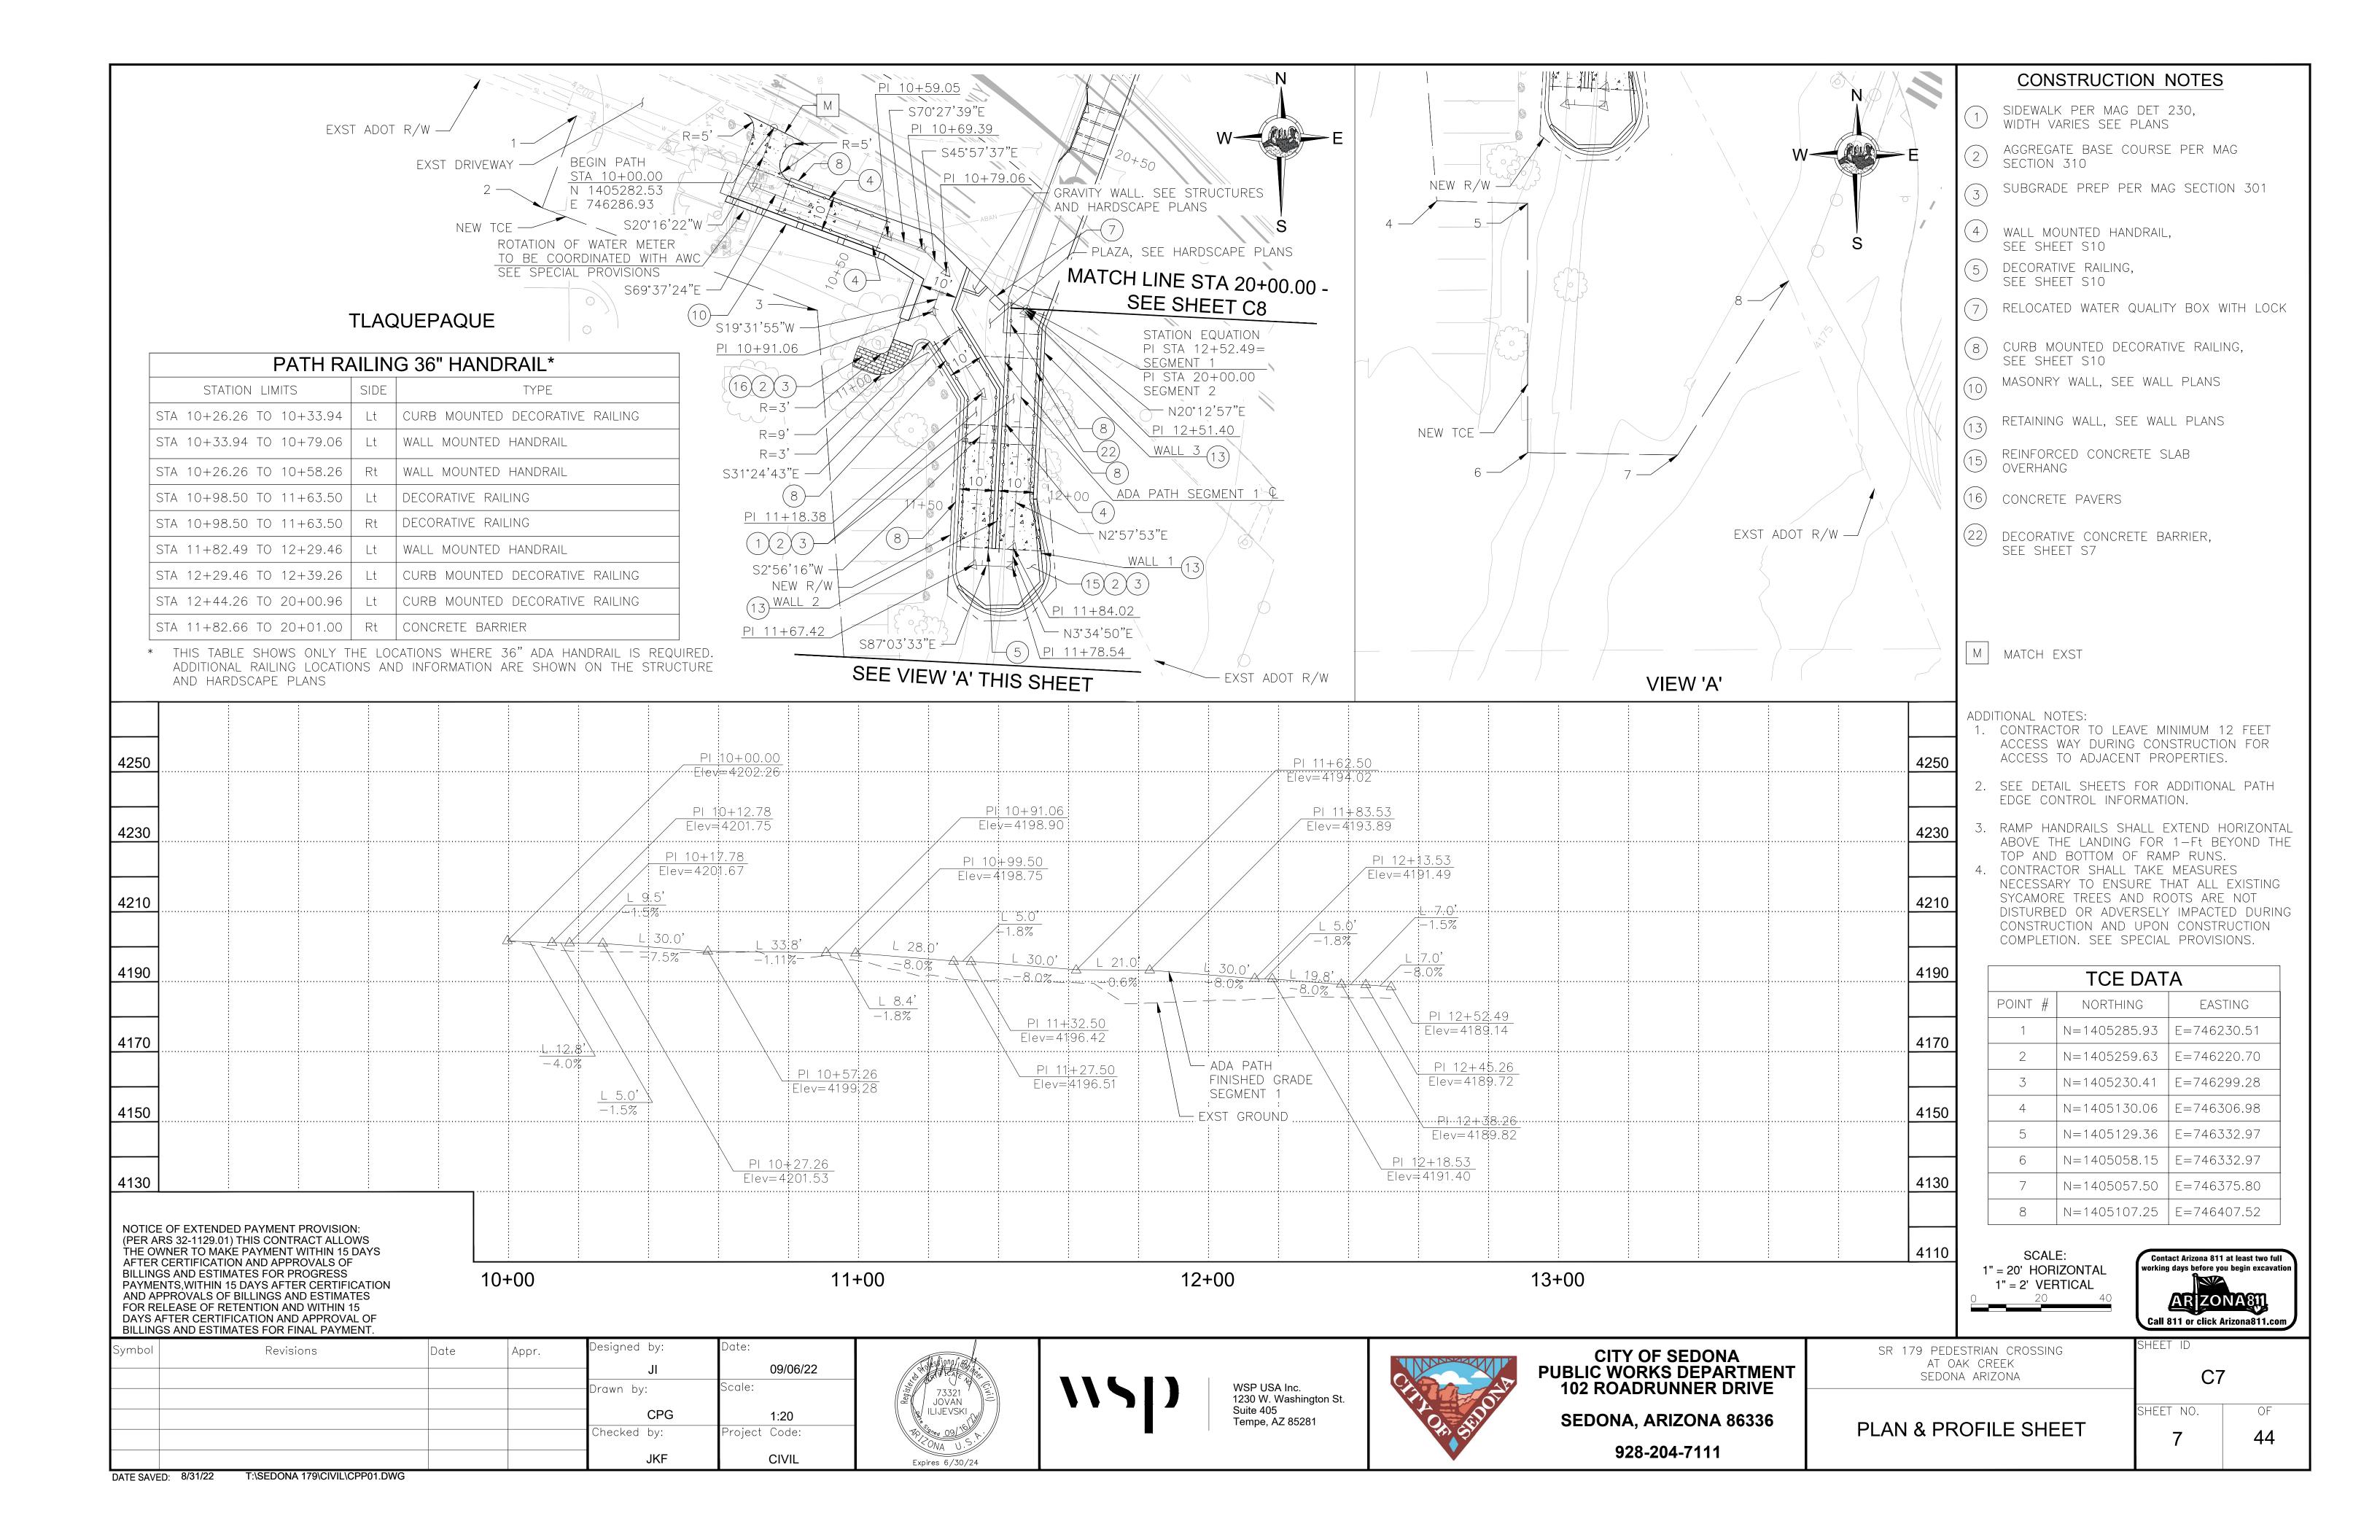

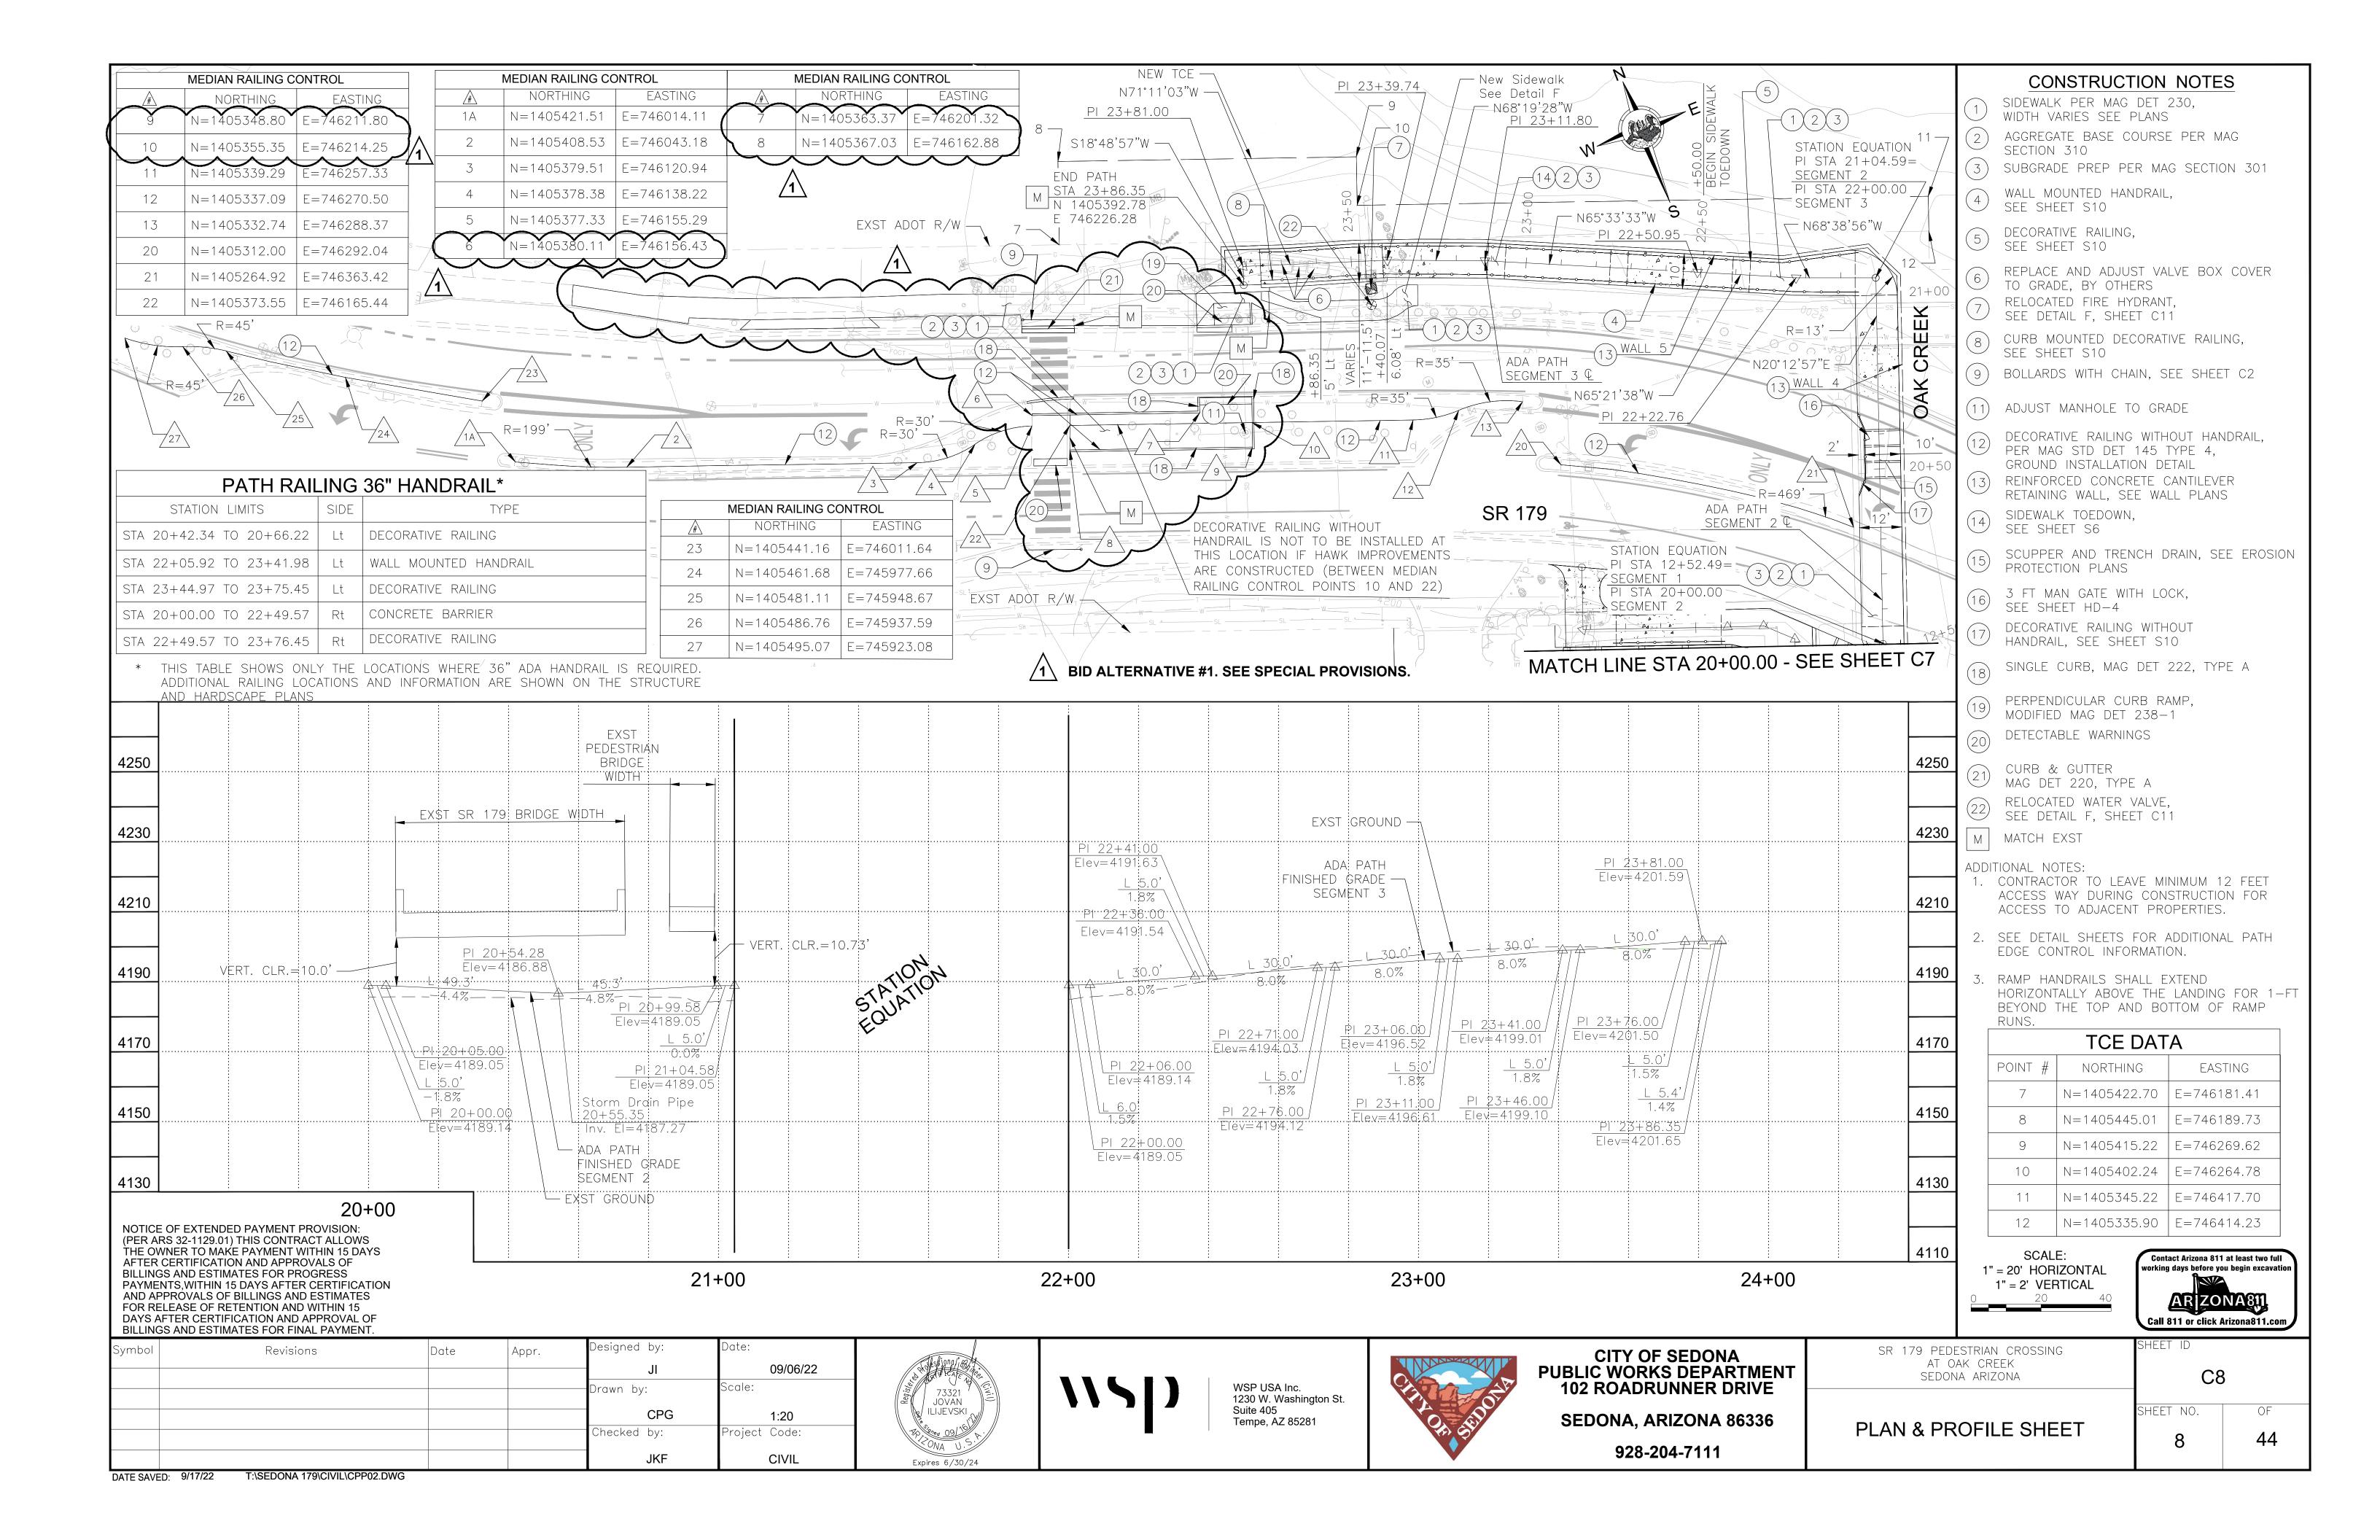

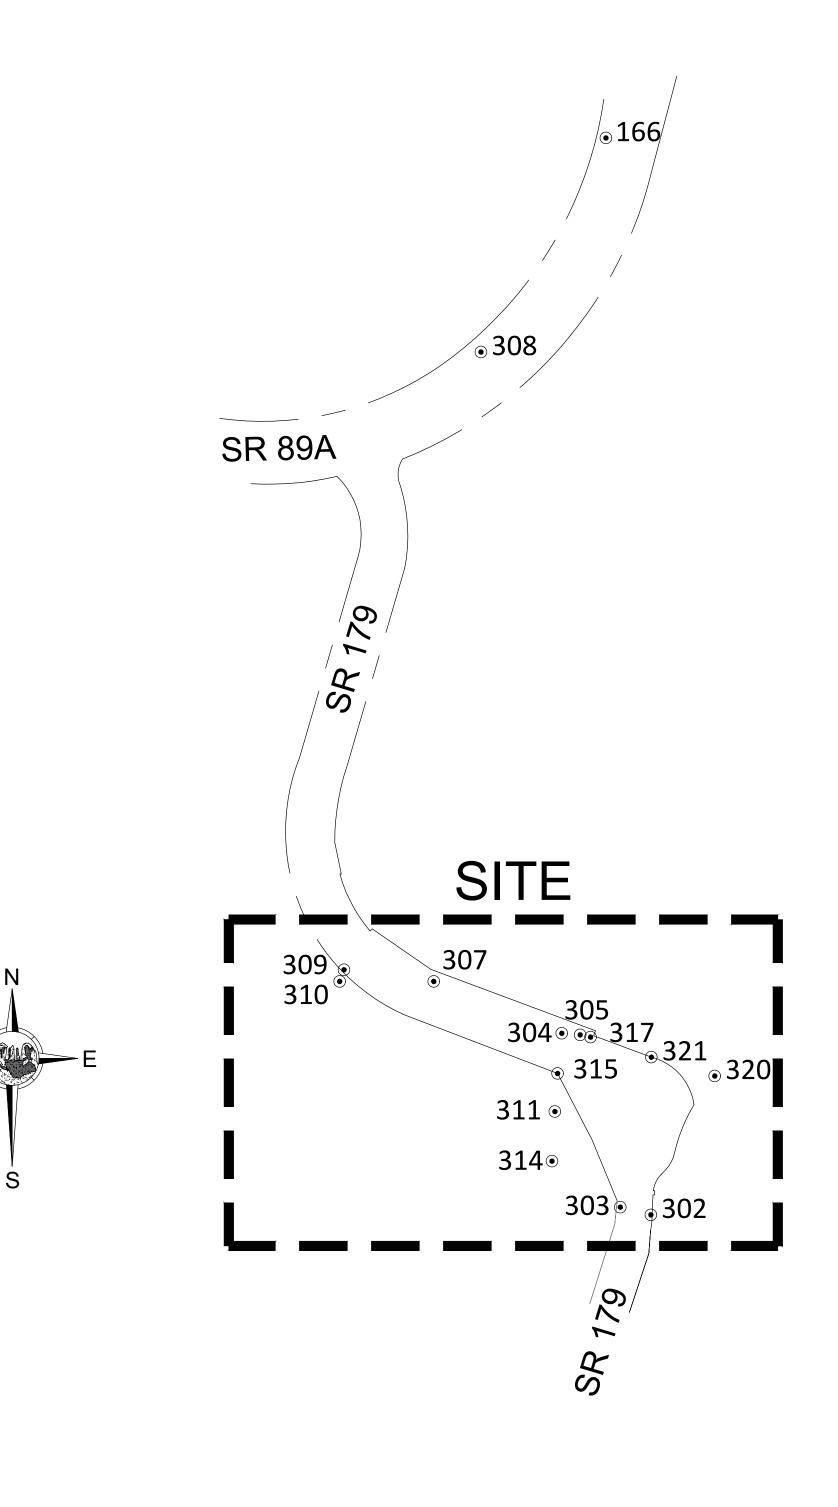

BASIS OF SURVEY CONTROL

HORIZONTAL AND VERTICAL DATA IS BASED ON THE CITY OF SEDONA CONTROL SURVEY PERFORMED BY SHEPARD WESNITZER. INC., PROJECT NO. 06237, DATED 11/02/2007.

COORDINATE SYSTEM DETAILS

GEODETIC DATUM: NAD 1983 (NSRS 2007)

<u>VERTICAL DATUM:</u> NAVD 1988


SYSTEM: STATE PLANE COORDINATE SYSTEM (CITY OF SEDONA)

ZONE: ARIZONA CENTRAL 0202

COORDINATE SYSTEM DETAIL BENCHMARKS

Point Table					
Point #	Raw Description	Northing	Easting	Elevation	
166	FOUND ALUMINUM CAP STAMPED 1978 PROJECT BENCHMARK	1407195.71	746435.76	4301.82	
302	FOUND NAIL & WASHER STAMPED RM PLS 19817	1404952.43	746529.40	4208.16	
303	SCRIBED X SITE TEMPORARY BENCHMARK	1404968.34	746465.75	4207.45	
304	SCRIBED X SITE TEMPORARY BENCHMARK	1405330.54	746343.86	4203.57	
305	FOUND ALUMINUM CAP STAMPED ADOT	1405327.37	746382.24	4204.58	
307	SCRIBED X SITE TEMPORARY BENCHMARK	1405438.58	746077.11	4201.01	
308	FD ALUMINUM CAP STAMPED 4281.77 PROJECT SECONDARY BENCHMARK	1406749.83	746175.50	4285.29	
309	SCRIBED X SITE TEMPORARY BENCHMARK	1405462.86	745890.27	4204.67	
310	FD ALUMINUM CAP STAMPED ADOT	1405438.71	745881.26	4198.70	
311	SCRIBED X SITE TEMPORARY BENCHMARK	1405167.60	746329.54	4197.27	
314	FOUND REBAR & CAP	1405064.17	746323.44	4194.82	
315	FOUND ALUMINUM CAP IN CONCRTETE STAMPED ADOT 259+70.76	1405246.86	746335.28	4199.09	
317	SET REBAR SITE TEMPORARY BENCHMARK	1405322.53	746403.86	4182.30	
320	FOUND COTTON PICKER SPINDLE	1405241.62	746662.60	4209.78	
321	FOUND ALUMINUM CAP STAMPED ADOT 257+99.49 PLS 19817	1405280.76	746530.67	4189.26	

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				JM	SURVEY

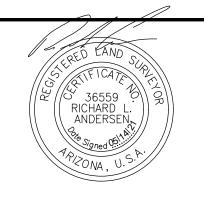





CITY OF SEDONA
PUBLIC WORKS DEPARTMENT
102 ROADRUNNER DRIVE


SEDONA, ARIZONA 86336 928-204-7111 SR 179 PEDESTRIAN CROSSING AT OAK CREEK SEDONA ARIZONA SHEET ID

C9

SHEET NO. OF

CONTROL SHEET

9 4

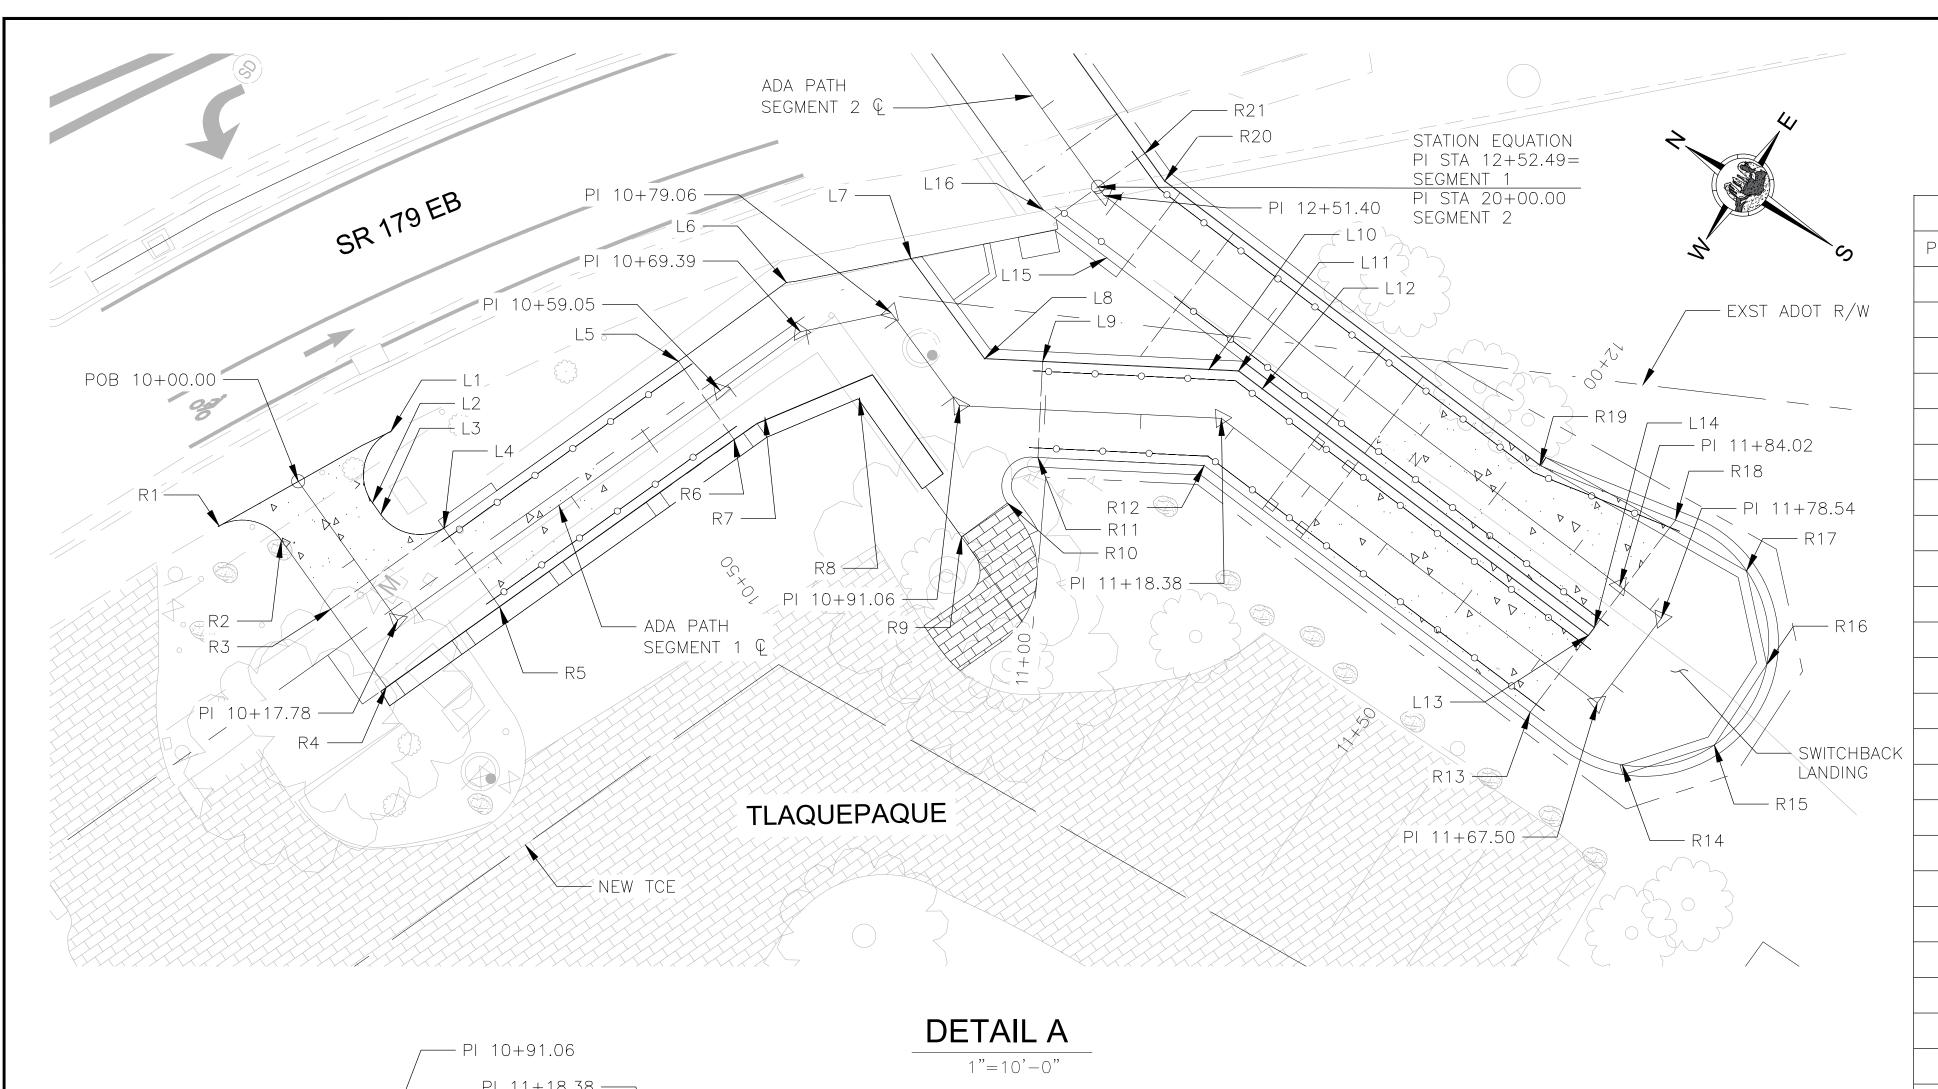

	PATH EDGE CONTROL					
	POINT #	NORTHING	EASTING	ELEVATION	POINT #	
	L1	N=1405277.48	E=746296.64	MATCH EXST	P1	
	L2	N=1405274.89	E=746289.44	4201.88	P2	
	L3	N=1405273.49	E=746288.92	4201.61	P3	
	L4	N=1405267.23	E=746291.40	4199.34	P4	
	L5	N=1405256.78	E=746319.52	4199.14	P5	
	L6	N=1405252.12	E=746332.64	4198.99	P6	
	L7	N=1405242.78	E=746341.99	4198.86	P7	
	L8	N=1405230.57	E=746337.66	4198.82	P8	
	L9	N=1405225.40	E=746340.81	4197.45	P9	
	L10	N=1405210.63	E=746349.83	4197.25	P10	
	L11	N=1405207.95	E=746351.46	4197.05	T1	
	L12	N=1405204.88	E=746351.30	4193.95	T2	
	L13	N=1405162.37	E=746349.12	4193.95	Т3	
CK	L14	N=1405162.31	E=746350.22	4189.64	Т4	
	L15	N=1405225.96	E=746353.51	4189.08	T5	
	L16	N=1405232.78	E=746353.87	4202.24	Т6	
	R1	N=1405286.79	E=746278.35	MATCH EXST		
	R2	N=1405278.35	E=746280.06	4202.24		
	R3	N=1405272.23	E=746277.82	4202.09		
	R4	N=1405262.91	E=746274.36	4201.67		
	R5	N=1405257.87	E=746287.92	4201.46		
	R6	N=1405247.43	E=746316.05	4199.21		
	R7	N=1405246.05	E=746319.75	4199.17		
	R8	N=1405239.07	E=746326.97	4199.00		
	R9	N=1405222.14	E=746320.96	4198.83		
	R10	N=1405220.15	E=746326.57	4198.74		
	R11	N=1405220.19	E=746332.28	4198.68		
	R12	N=1405205.40	E=746341.31	4197.29		
	R13	N=1405162.88	E=746339.13	4194.08		
	R14	N=1405151.85	E=746339.99	4194.01		
	R15	N=1405145.08	E=746347.08	4193.94		
	R16	N=1405145.26	E=746357.08	4193.88		
	R17	N=1405152.50	E=746363.99	4193.83		
	R18	N=1405161.59	E=746364.20	4193.75		
	R19	N=1405176.47	E=746360.96	4192.64		
	R20	N=1405225.44	E=746363.50	4189.49		
	R21	N=1405228.78	E=746364.73	4189.23		

PATH EDGE CONTROL

	DETAIL A
PI 10+91.06	1"=10'-0"
/ PI 11+18.38 ——	
TLAQUEPAQUE ENTRANCE T3	PI 12+51.40 PI 12+51.40 ADA PATH SEGMENT 1 © EXST ADOT R/W PR PR PR PR PR PR PR PR PR P
DETAIL B	DETAIL C
<u> </u>	1"=10'-0"

Symbol	Revisions	Date	Appr.	Designed by:	Date:
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WSP USA Inc. 1230 W. Washington St. Suite 405 Tempe, AZ 85281

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CITY OF SEDONA
PUBLIC WORKS DEPARTMENT
102 ROADRUNNER DRIVE
SEDONA, ARIZONA 86336

928-204-7111

SR	179 PEDESTRIAN CROSSING AT OAK CREEK SEDONA ARIZONA	

PATH EDGE CONTROL

N=1405208.18 | E=746352.55

N=1405217.28 E=746346.10

N=1405230.69 | E=746338.80

P4 N=1405236.04 E=746340.70

P5 N=1405234.36 E=746345.44

P6 N=1405236.83 E=746348.01

P8 N=1405228.95 E=746353.67

P9 N=1405223.95 E=746353.41

P10 N=1405216.96 E=746353.05

T1 N=1405216.44 E=746325.09

T3 N=1405214.42 E=746309.36

T4 N=1405220.17 E=746311.14

T5 | N=1405218.19 | E=746316.29

T6 N=1405219.98 E=746320.20

N=1405212.60 E=746314.10

N=1405231.13 | E=746353.78

NORTHING

ELEVATION

4190.56

4189.92

4189.86

4189.89

4189.84

4189.84

4189.78

4189.74

4189.80

4189.86

4198.15

4198.56

MATCH EXIST

MATCH EXIST


4198.65


4198.89


DETAIL SHEET 1


C10
SHEET NO. OF

DATE SAVED: 9/17/22 T:\SEDONA 179\DATA\DTL01.DWG

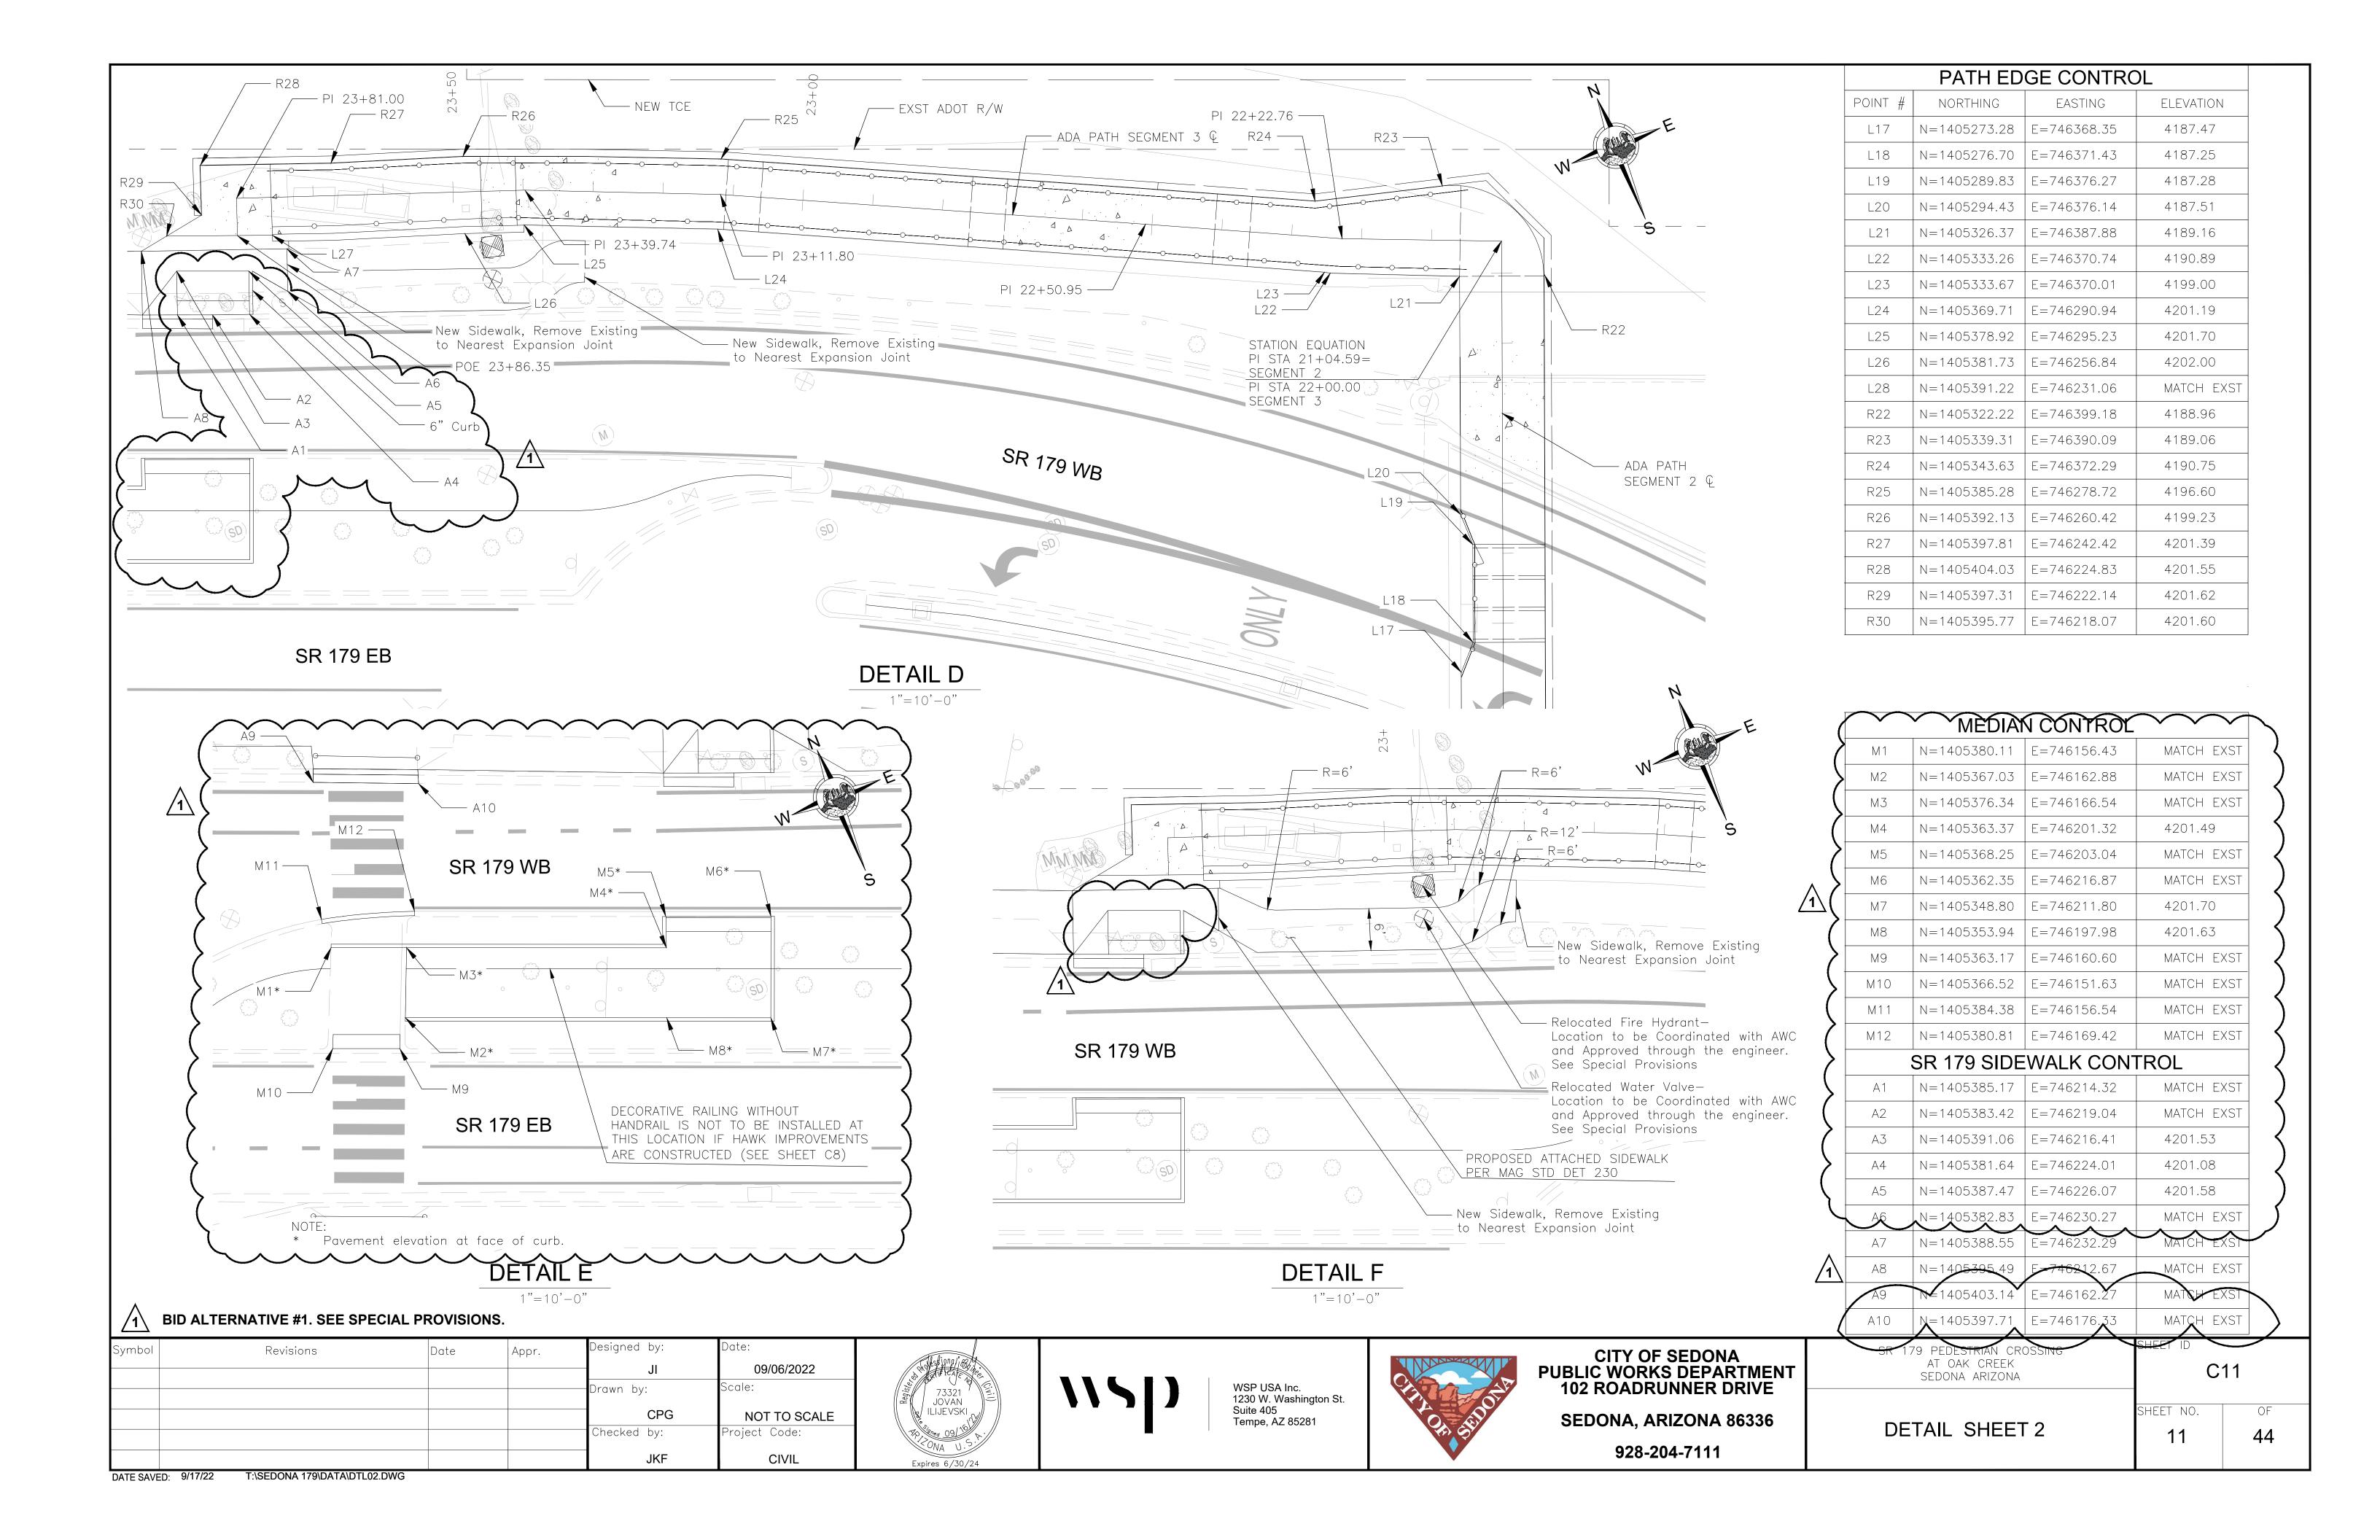


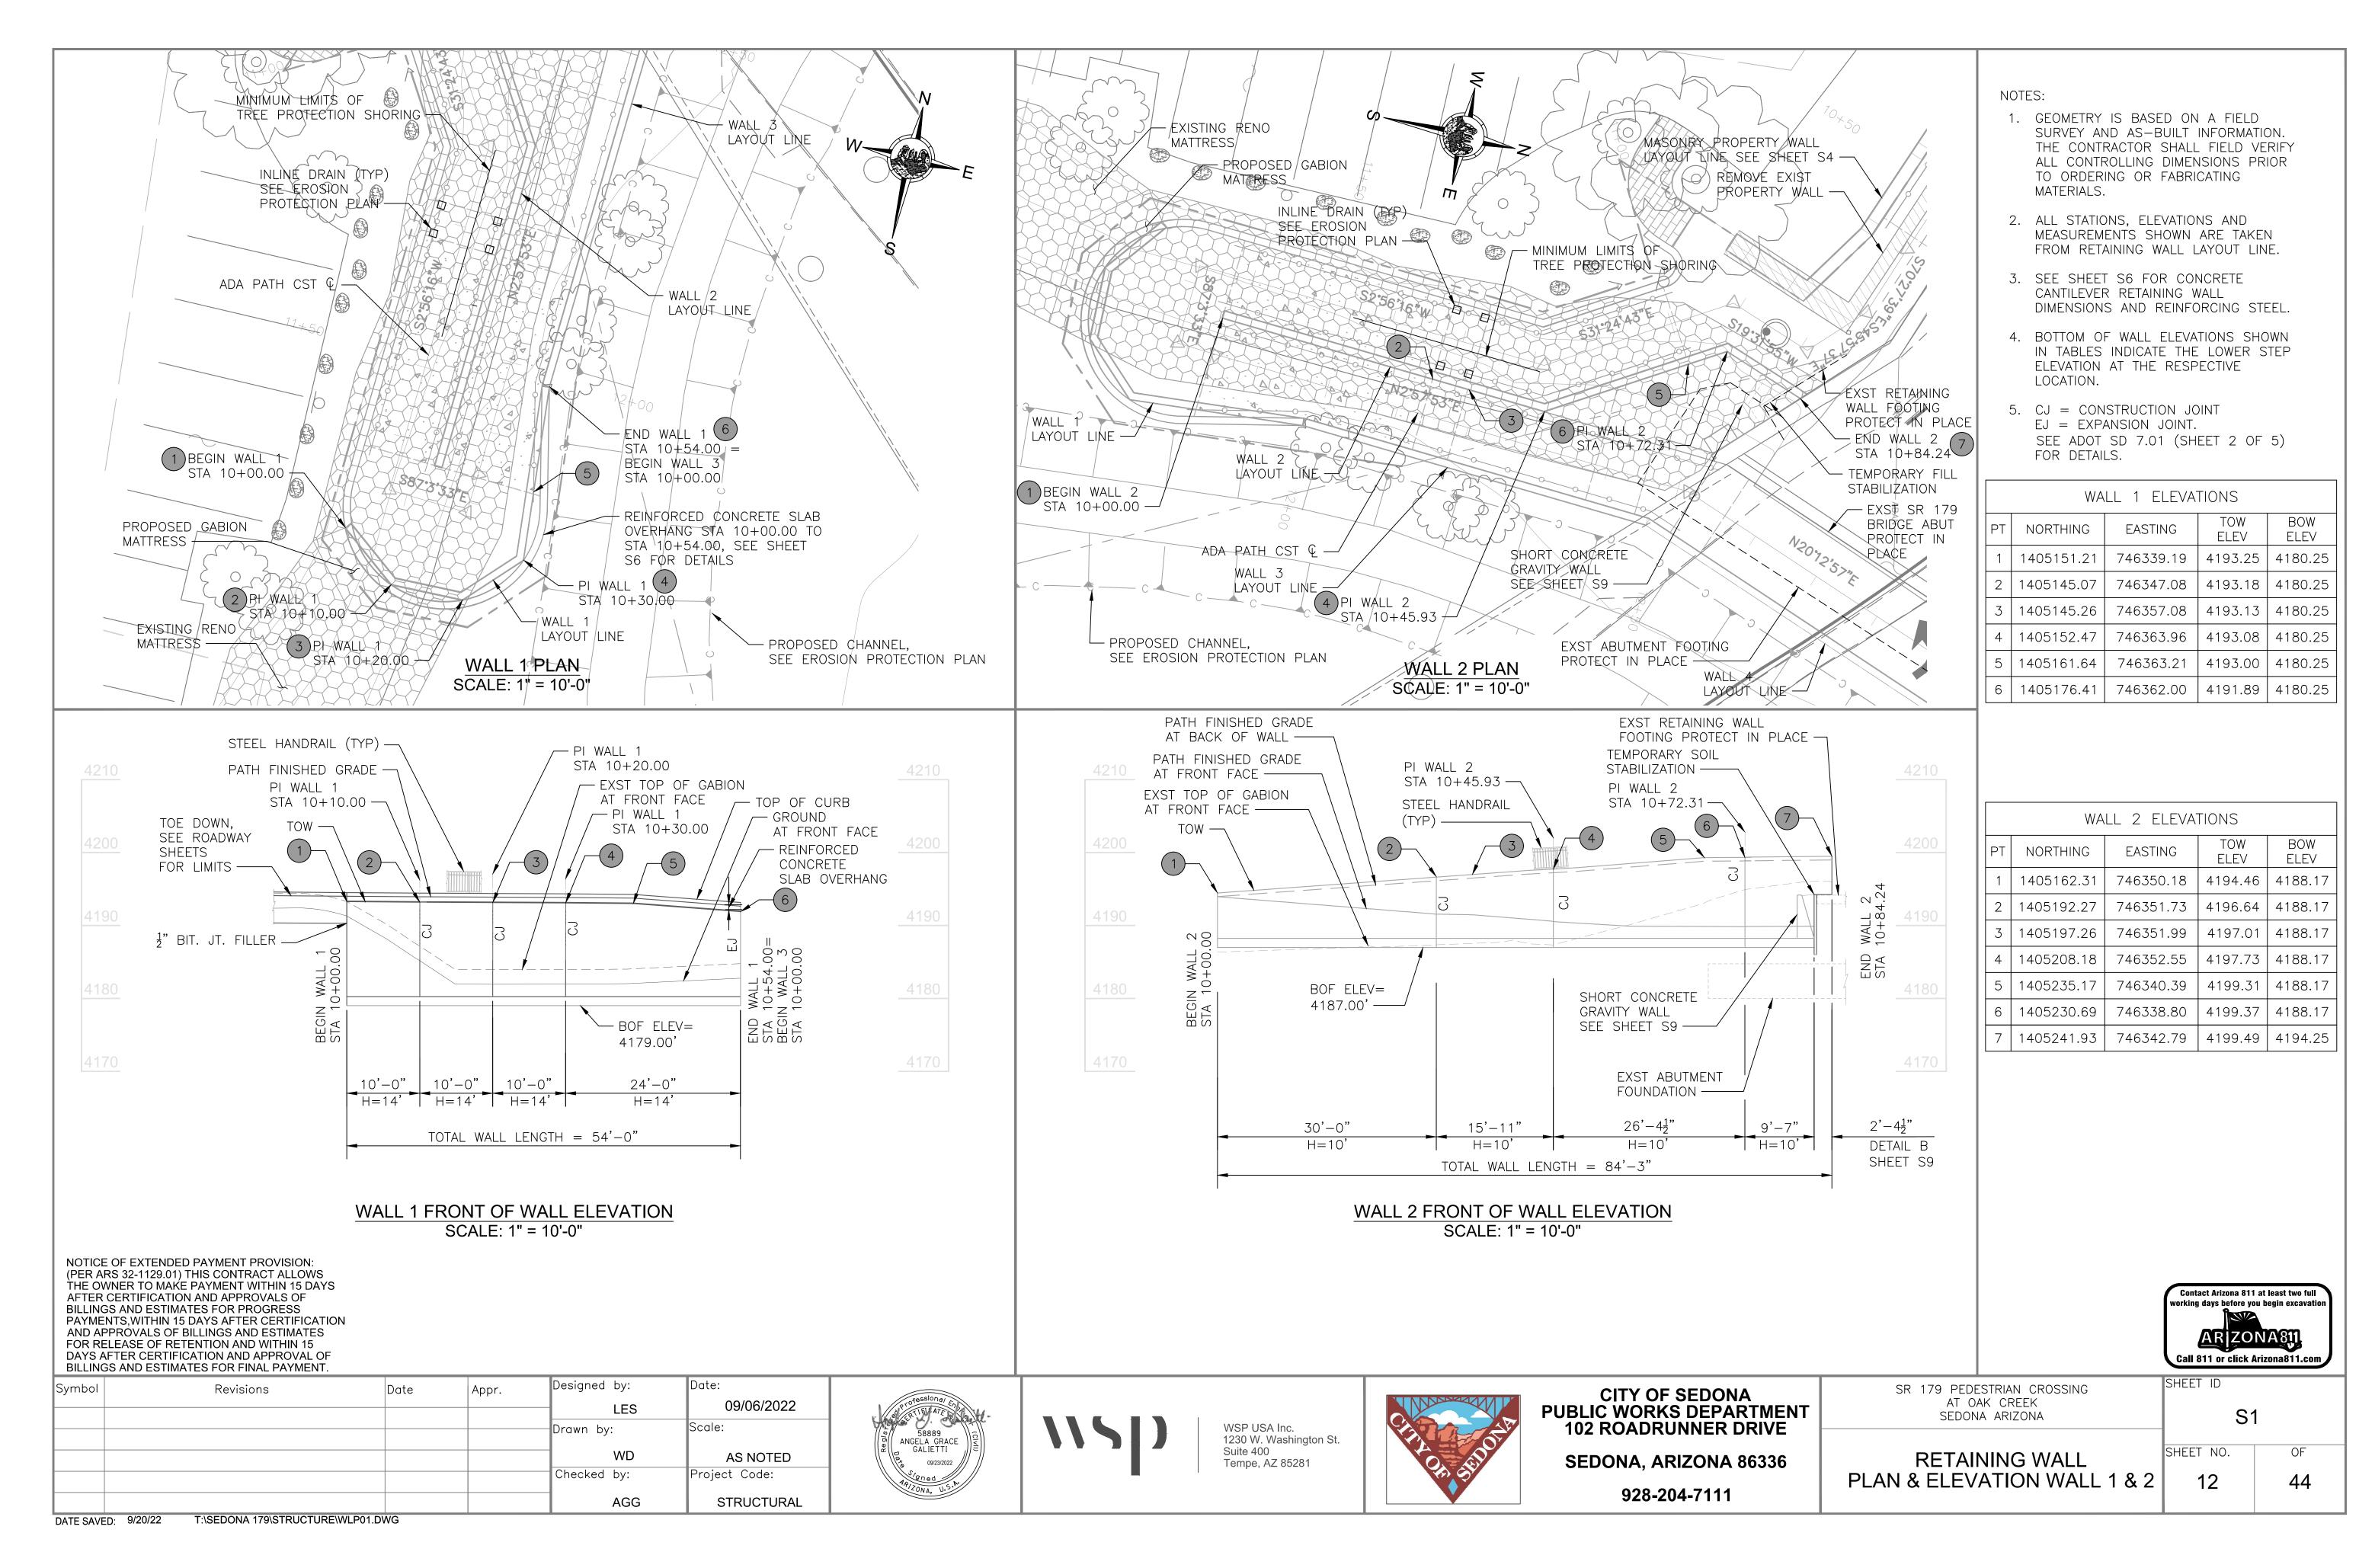

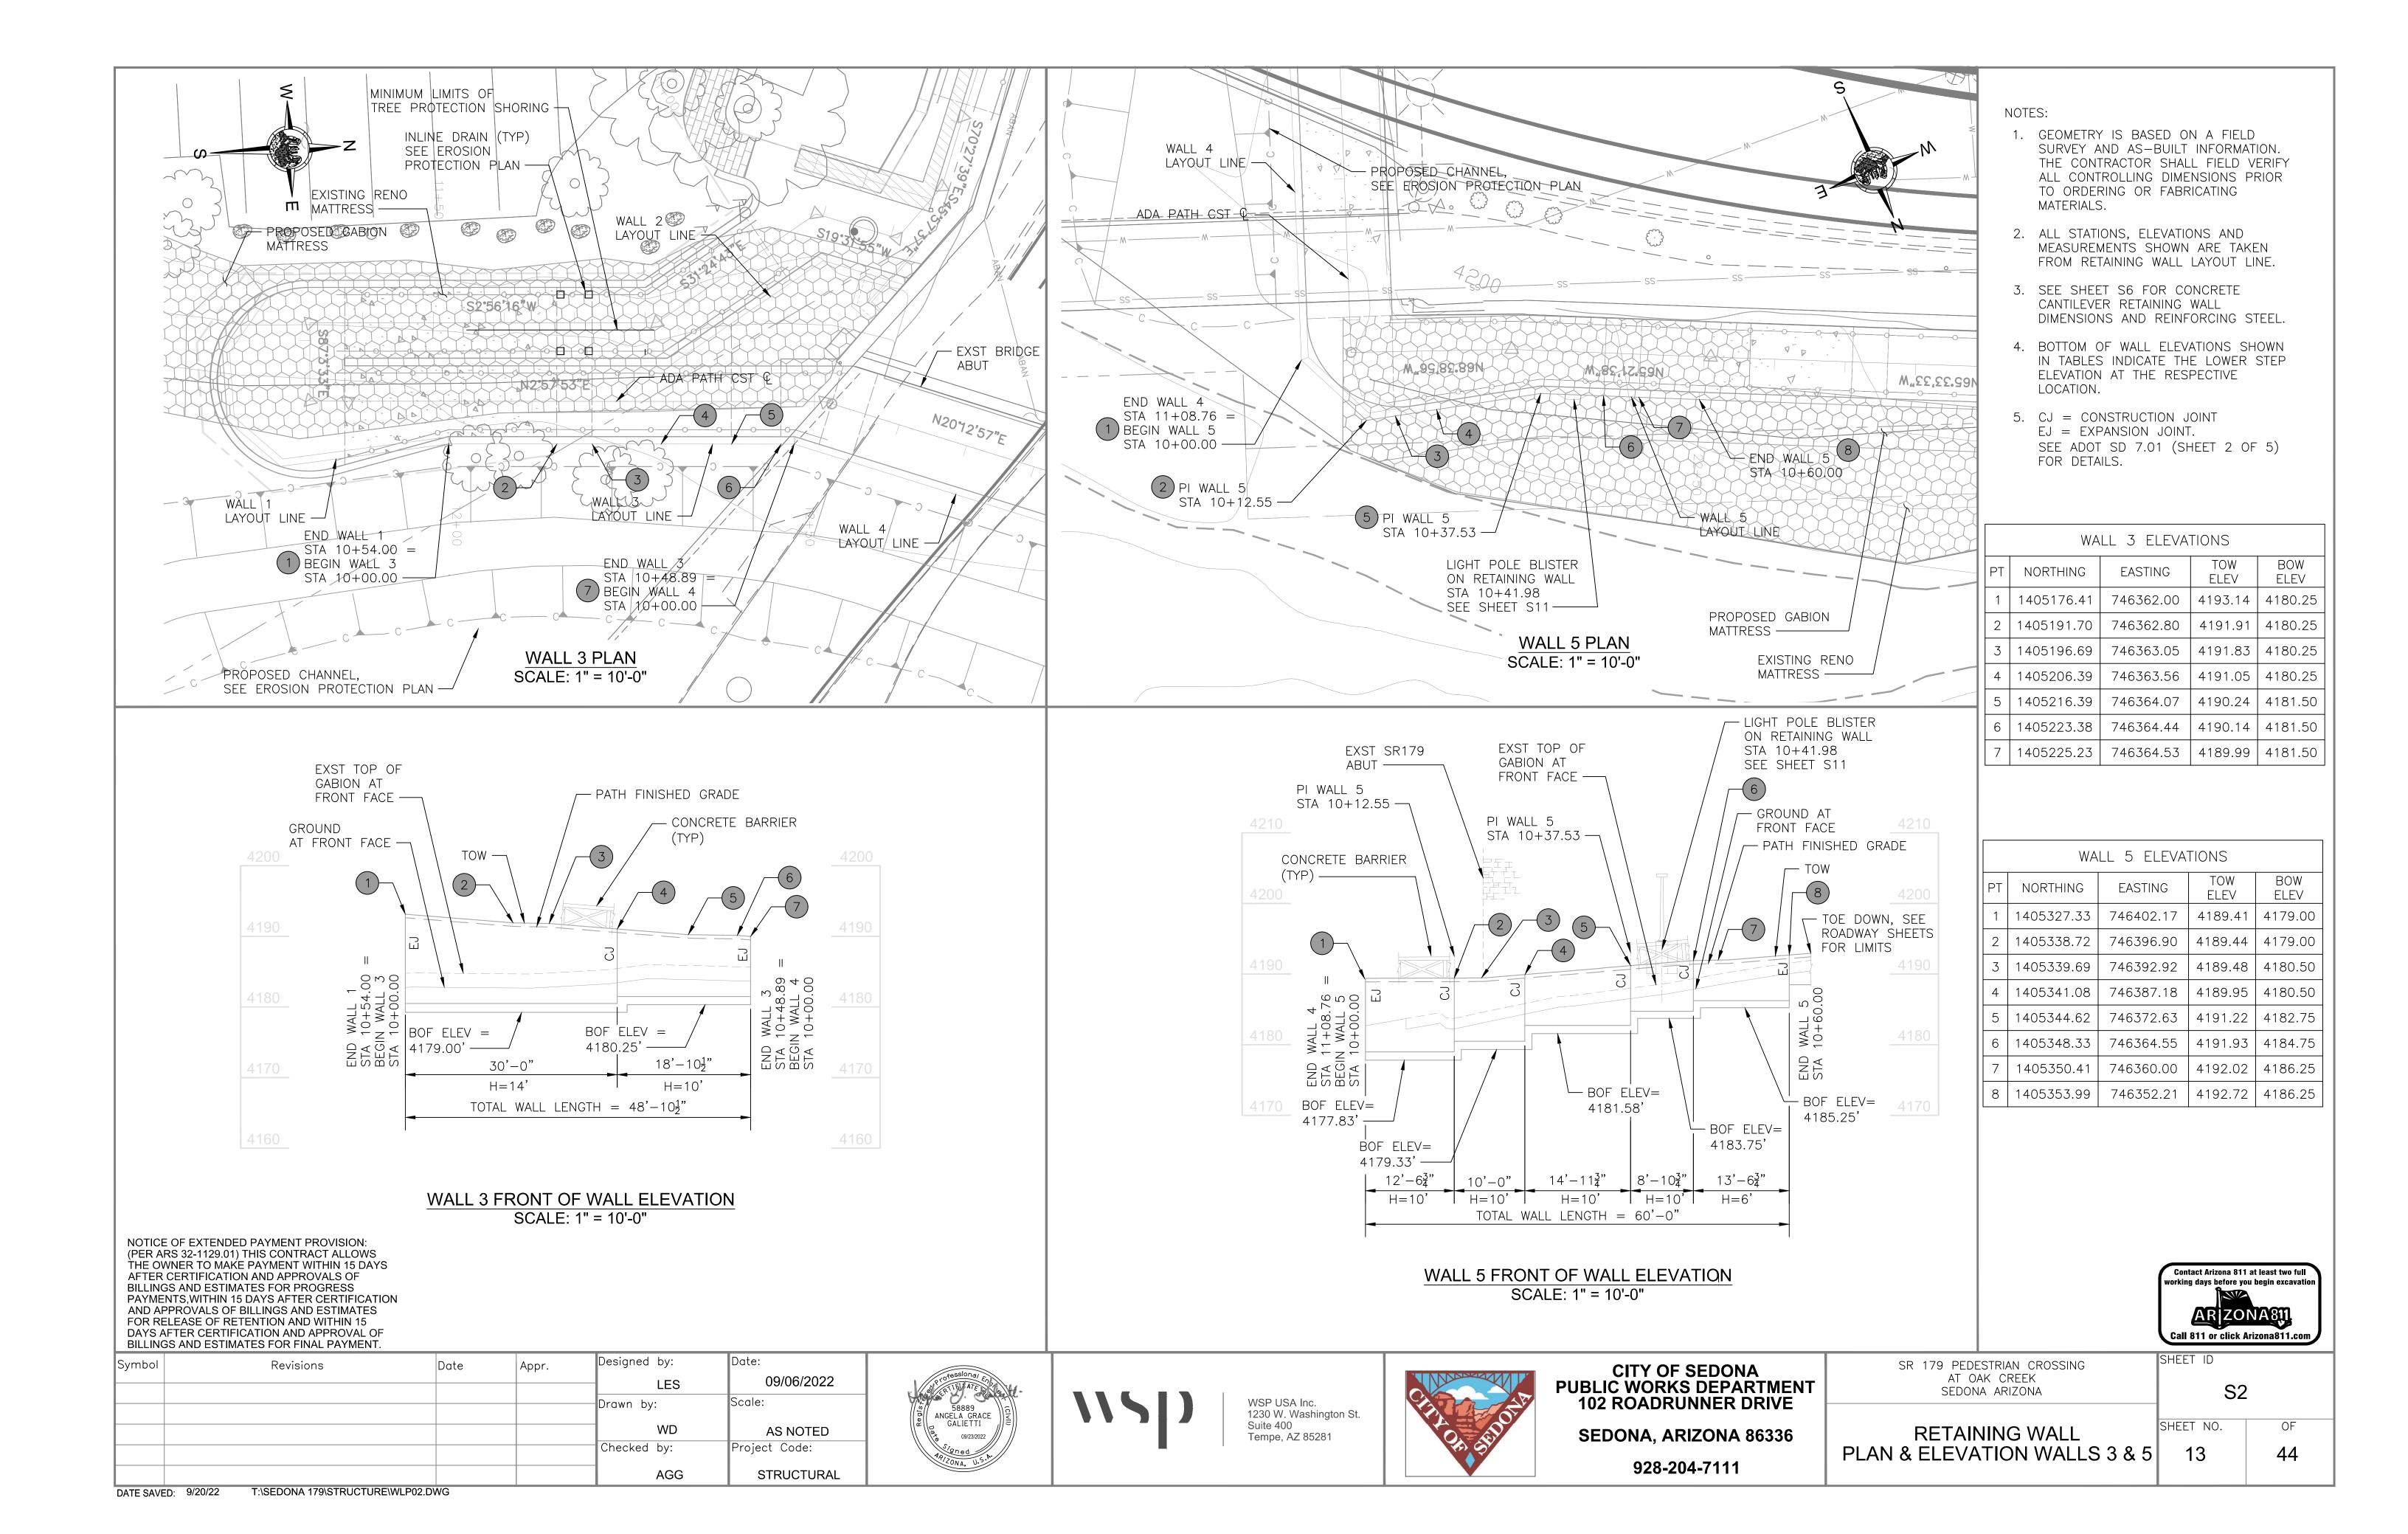

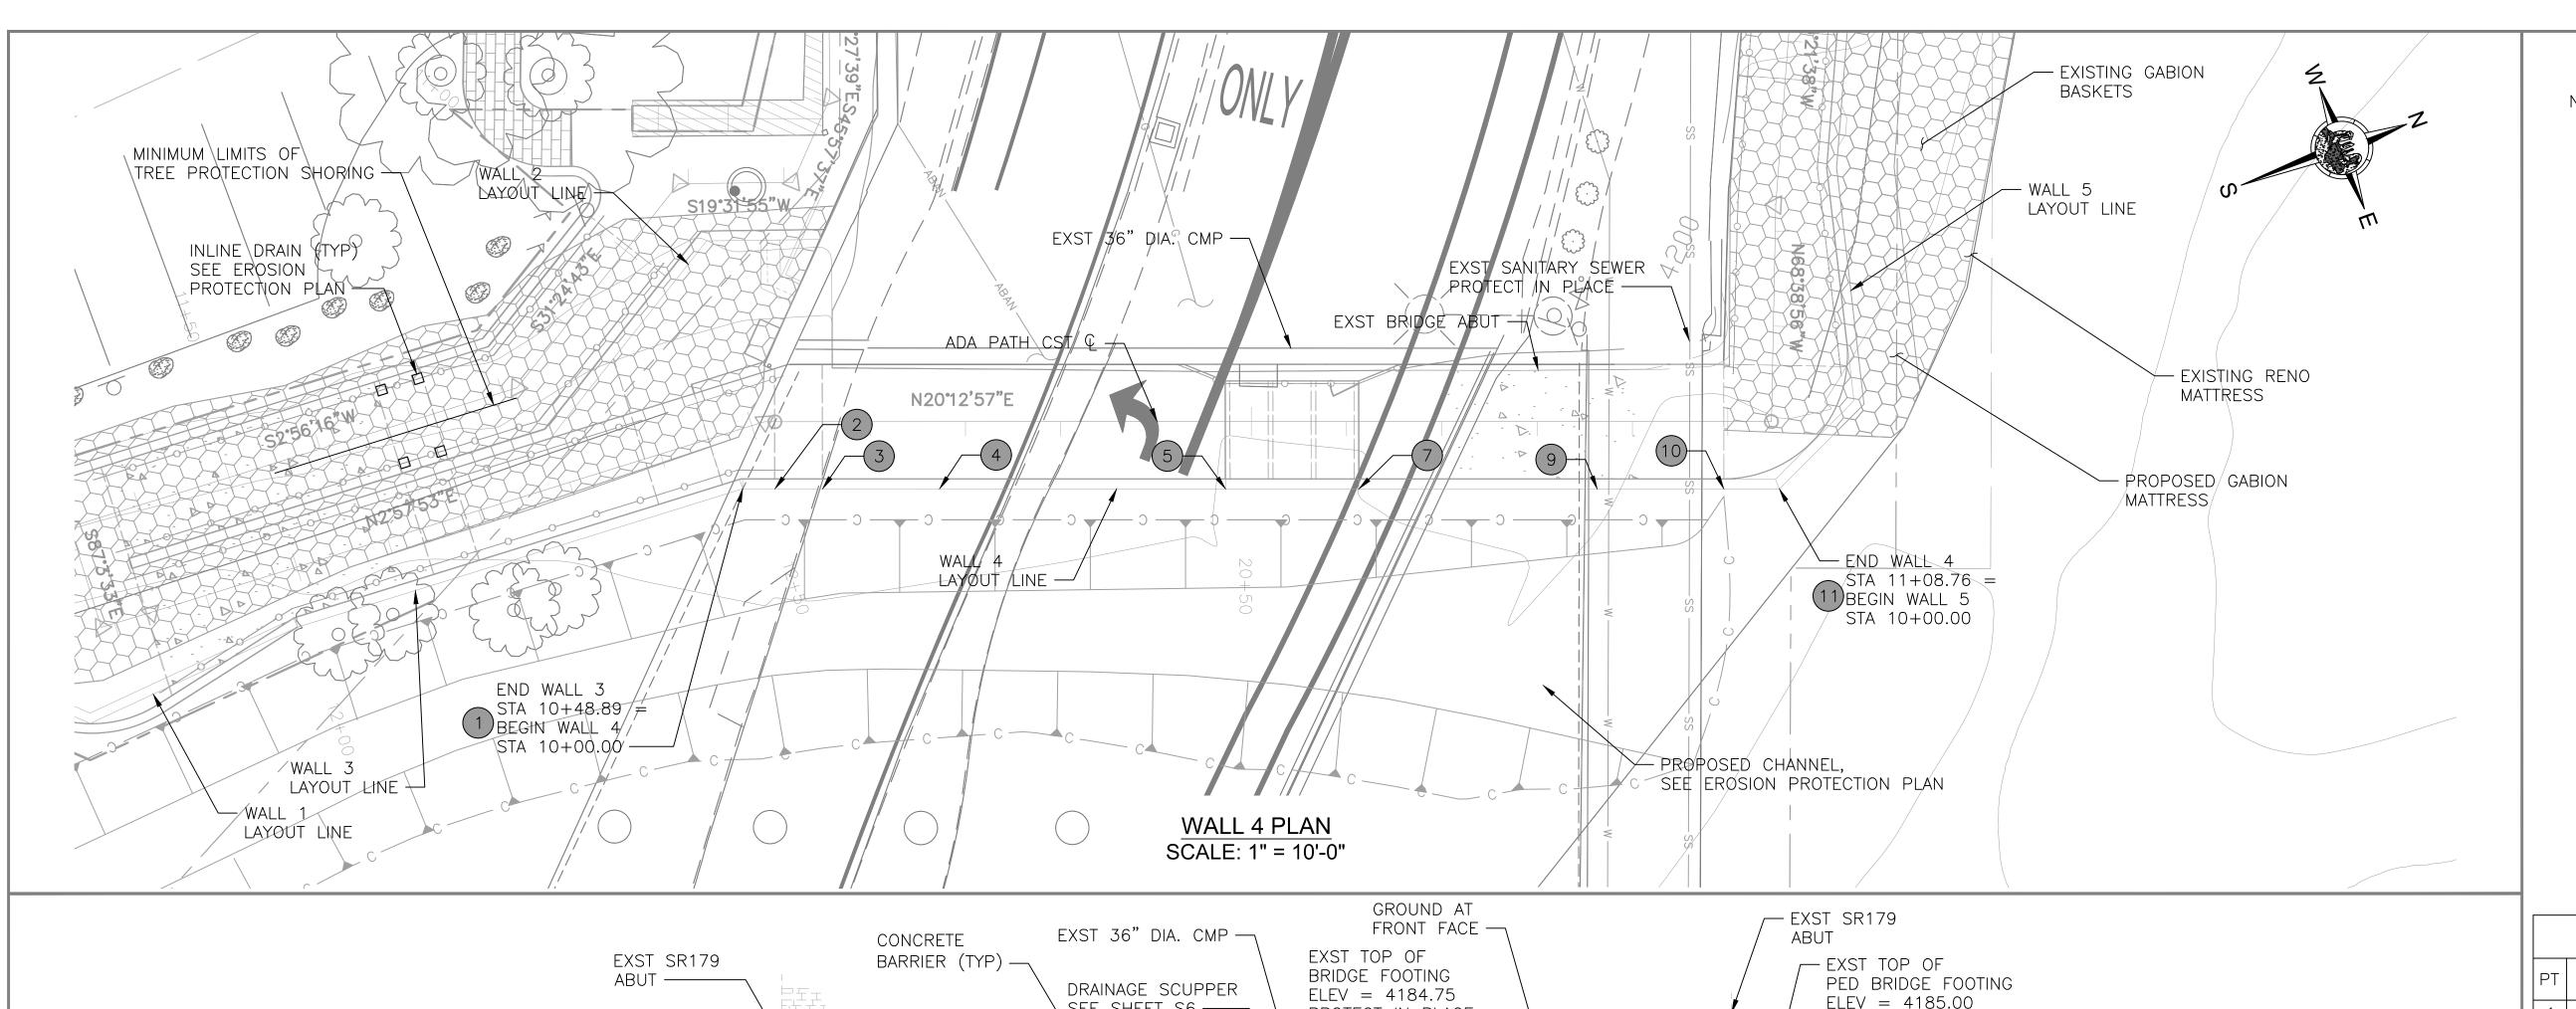

- 1. GEOMETRY IS BASED ON A FIELD SURVEY AND AS-BUILT INFORMATION. THE CONTRACTOR SHALL FIELD VERIFY ALL CONTROLLING DIMENSIONS PRIOR TO ORDERING OR FABRICATING MATERIALS.
- 2. ALL STATIONS, ELEVATIONS AND MEASUREMENTS SHOWN ARE TAKEN FROM RETAINING WALL LAYOUT LINE.
- 3. SEE SHEET S6 FOR CONCRETE CANTILEVER RETAINING WALL DIMENSIONS AND REINFORCING STEEL.
- 4. BOTTOM OF WALL ELEVATIONS SHOWN IN TABLES INDICATE THE LOWER STEP ELEVATION AT THE RESPECTIVE LOCATION.
- 5. CJ = CONSTRUCTION JOINT EJ = EXPANSION JOINT.SEE ADOT SD 7.01 (SHEET 2 OF 5) FOR DETAILS.

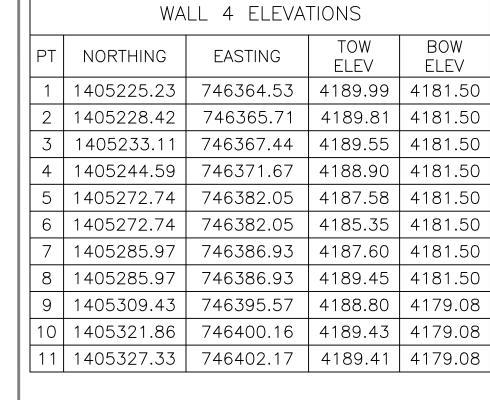

WALL 4 FRONT OF WALL ELEVATION SCALE: 1" = 10'-0"

TOTAL WALL LENGTH = 108'-9"

14'-1"

H=6

NOTICE OF EXTENDED PAYMENT PROVISION: (PER ARS 32-1129.01) THIS CONTRACT ALLOWS THE OWNER TO MAKE PAYMENT WITHIN 15 DAYS AFTER CERTIFICATION AND APPROVALS OF BILLINGS AND ESTIMATES FOR PROGRESS PAYMENTS, WITHIN 15 DAYS AFTER CERTIFICATION AND APPROVALS OF BILLINGS AND ESTIMATES FOR RELEASE OF RETENTION AND WITHIN 15 DAYS AFTER CERTIFICATION AND APPROVAL OF BILLINGS AND ESTIMATES FOR FINAL PAYMENT.

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					AGG	STRUCTURAL



SEE SHEET S6 —

BOF ELEV =

30'-0"

H = 10'

4180.25 -

PATH

 $20'-7\frac{1}{2}"$

H = 10'

FINISHED GRADE -



PROTECT IN PLACE —

8 TOW —

25'-0"


H = 10'

BOF ELEV =

4177.83 ——

 $19'-0\frac{1}{2}$ "

H = 10'

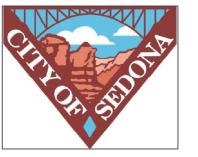

CITY OF SEDONA PUBLIC WORKS DEPARTMENT 102 ROADRUNNER DRIVE
SEDONA, ARIZONA 86336

928-204-7111

SR	179 PEDESTRIAN CROSSING AT OAK CREEK SEDONA ARIZONA

SHEET ID **S**3


RETAINING WALL PLAN & ELEVATION WALL 4 SHEET NO.

Contact Arizona 811 at least two full

vorking days before you begin excavatio

Call 811 or click Arizona811.com

DATE SAVED: 9/20/22 T:\SEDONA 179\STRUCTURE\WLP03.DWG

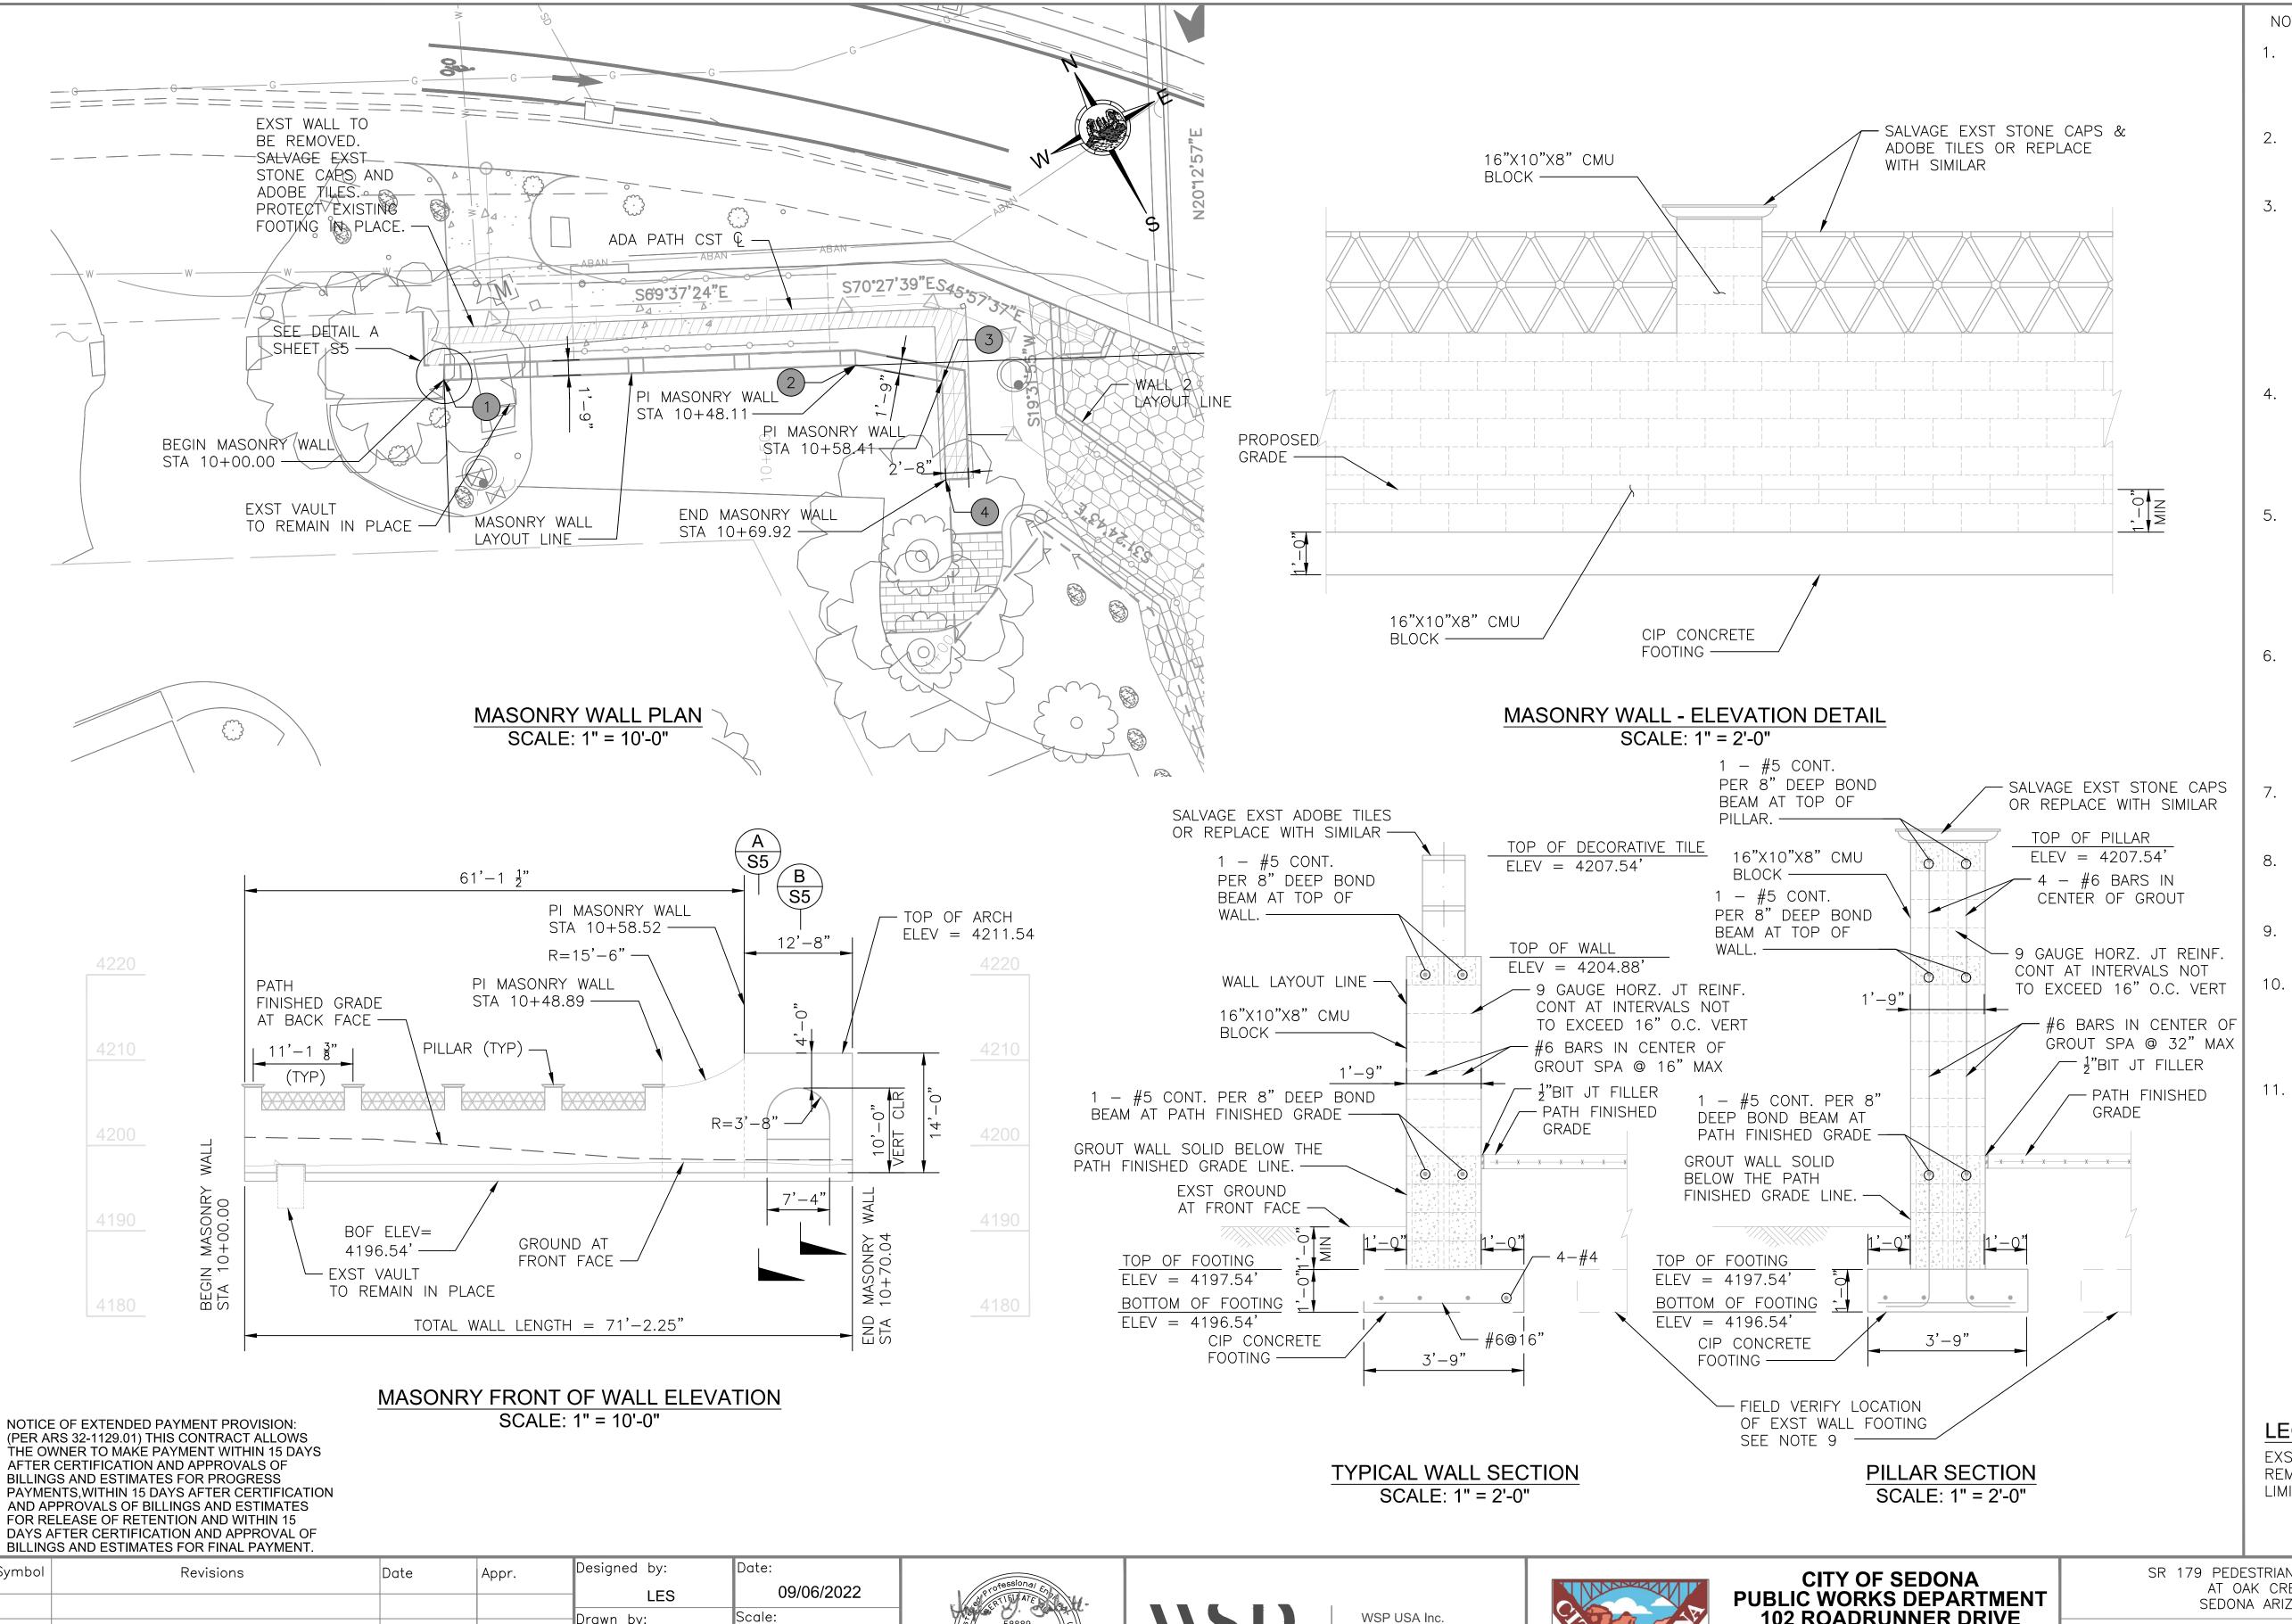

- 1. ALL BLOCK AND RAILING TO BE FIELD VERIFIED AND SHALL MATCH EXISTING CONDITIONS. RAILING MATERIALS AND AESTHETICS SHALL MATCH EXISTING CONDITION.
- 2. ALL CONCRETE SHALL BE MAG CLASS A PER SECTION 725 OF MAG STANDARD SPECIFICATIONS, UNLESS NOTED OTHERWISE.
- 3. REINFORCING STEEL SHALL CONFORM TO ASTM SPECIFICATION A934 EPOXY COATED REINFORCING BARS. ALL REINFORCING SHALL BE GRADE 60. ALL BENDS AND HOOKS SHALL MEET THE REQUIREMENTS OF OF AASHTO LRFD ARTICLE 5.10. ALL BEND DIMENSIONS FOR REINFORCING STEEL SHALL BE OUT-TO-OUT OF BARS. ALL PLACEMENT DIMENSIONS FOR REINFORCING STEEL SHALL BE TO CENTER OF BARS UNLESS NOTED OTHERWISE.
- 4. HOLLOW CONCRETE MASONRY UNITS SHALL CONFORM TO ASTM SPECIFICATION C90. ALL BLOCKS SHALL BE GRADE N, TYPE 1 WITH F'M = 1,900 PSI. RUNNING BOND, MORTAR TYPE S, WITH 1,800 PSI AND GROUT WITH 2,500 PSI SHALL BE USED.
- 5. NEW SPREAD FOOTING SHALL BEAR ON FIRM UNDISTURBED SOIL (CONTROLLED COMPACTED FILL) 2'-0" MINIMUM BELOW FINISHED GRADE. DESIGN SOIL BEARING VALUE = 4,000 PSF. FOUNDATION EXCAVATION SHALL BE INSPECTED BY SOILS ENGINEER PRIOR TO PLACEMENT OF CONCRETE.
- 6. ALL EXISTING SPREAD FOOTINGS TO BE LEFT IN PLACE. ANY EXISTING FOOTING THAT IS SPECIFIED TO BE USED UNDER NEW WALL SHALL BE INSPECTED BY THE ENGINEER PRIOR TO WALL INSTALLATION TO DETERMINE STRUCTURAL ADEQUACY OF EXISTING FOUNDATION.
- COMPACT BACKFILL FOR FOOTING AN WALL BASE MINIMUM 95% OF ASTM D698 MAXIMUM DRY DENSITY.
- 8. MECHANICALLY VIBRATE GROUT IN VERTICAL SPACES IMMEDIATELY AFTER POURING. MAXIMUM GROUT LIFT SHALL BE 4'-0".
- 9. PLACE CONTROL JOINTS IN MASONRY WALL AT MAXIMUM OF 24'-0" SPACING.
- 10. EXISTING WALL FOOTING SHALL REMAIN IN PLACE UNLESS CONFLICTING WITH PROPOSED FOOTING. SAW CUT AND REMOVE CONFLICTING AREA ONLY. PLACE 1" BIT. JT. FILLER BETWEEN EXISTING AND PROPŌSED CONCRETE.
- 11. SPECIAL INSPECTION IS REQUIRED FOR ALL MASONRY WALL CONSTRUCTION. VERTICAL CELLS CONTAINING REINFORCEMENTS SHALL BE GROUTED SOLID FULL HEIGHT. BOND BEAMS WITH REINFORCEMENTS SHALL BE GROUTED SOLID FULL LENGTH.

	MASONRY WALL					
Р	Ť	NORTHING	EASTING			
	1)	1405261.52	746272.94			
	2)	1405244.68	746318.18			
	3	1405239.08	746326.77			
(2	4)	1405227.86	746322.78			

LEGEND

EXST WALL REMOVAL LIMITS

Contact Arizona 811 at least two full vorking days before you begin excavatior Call 811 or click Arizona811.com

Symbol	Revisions	Date	Appr.	Designed by:	Date:
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				Checked by:	Project Code:
				AGG	STRUCTURAL







1230 W. Washington St.

Tempe, AZ 85281

Suite 400

102 ROADRUNNER DRIVE

SEDONA, ARIZONA 86336 928-204-7111

SR	179 PEDESTRIAN CROSSING
	AT OAK CREEK
	SEDONA ARIZONA


S4 SHEET NO.


SHEET ID

MASONRY WALL PLAN & ELEVATION

44 15

OF

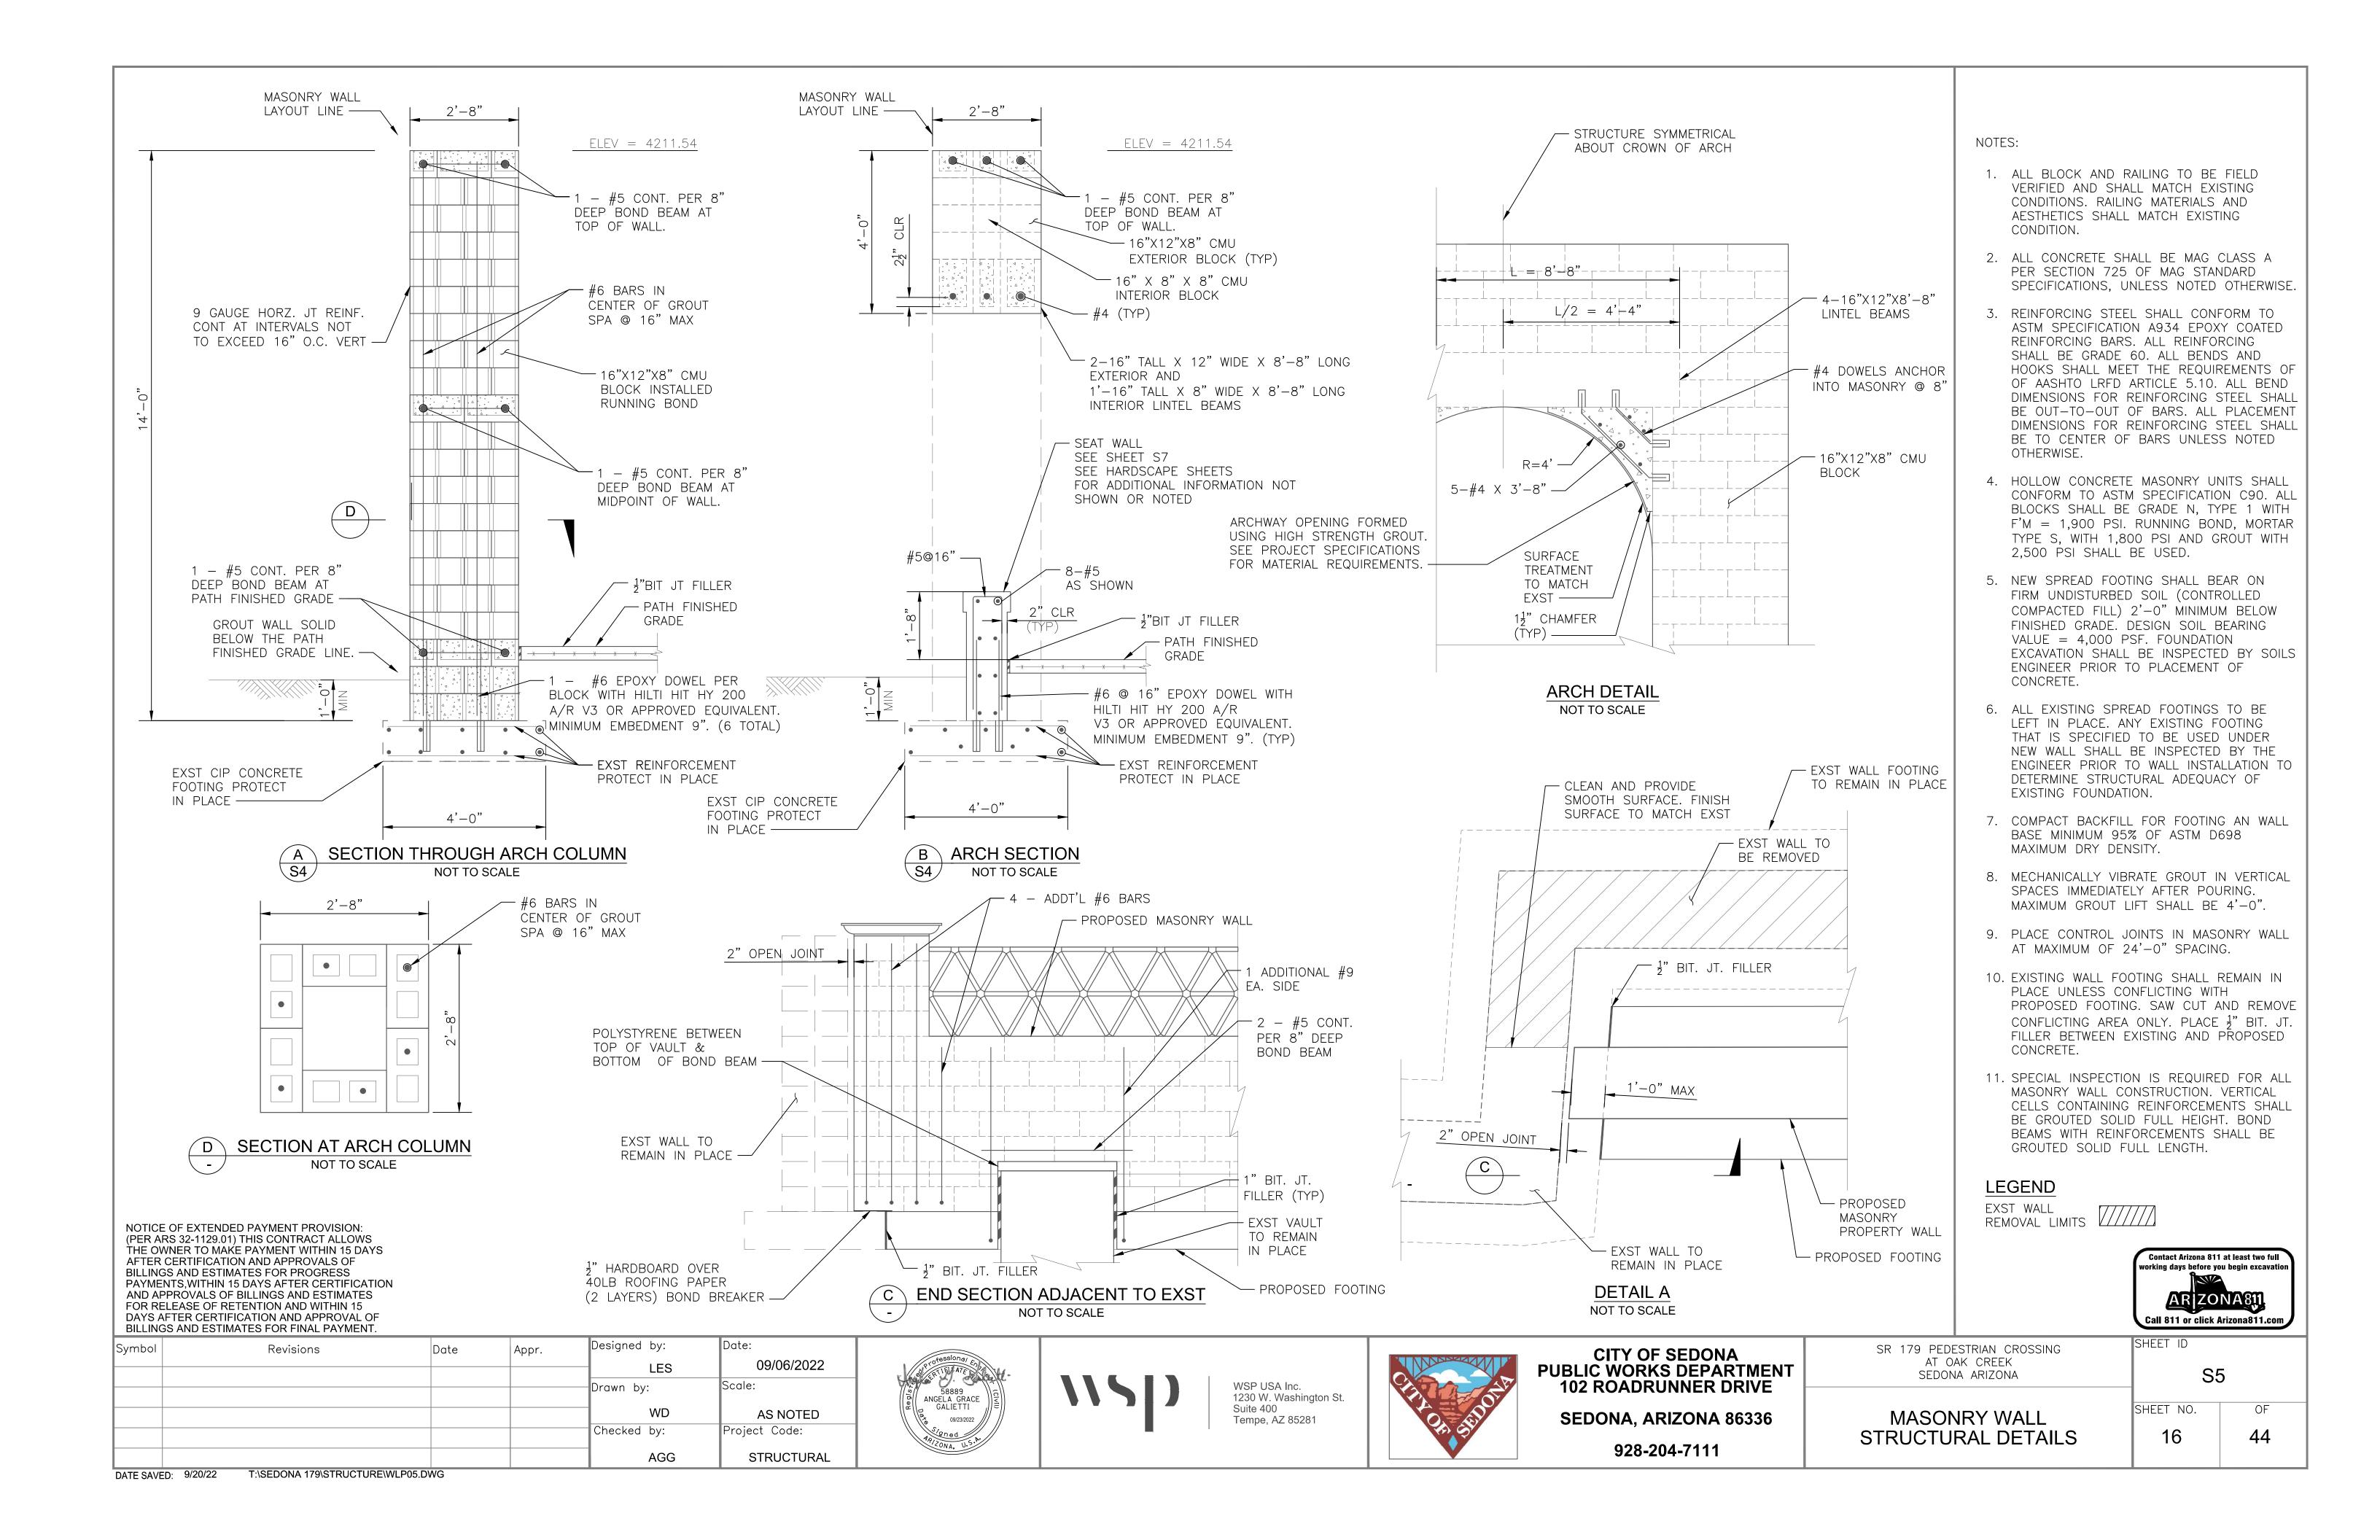

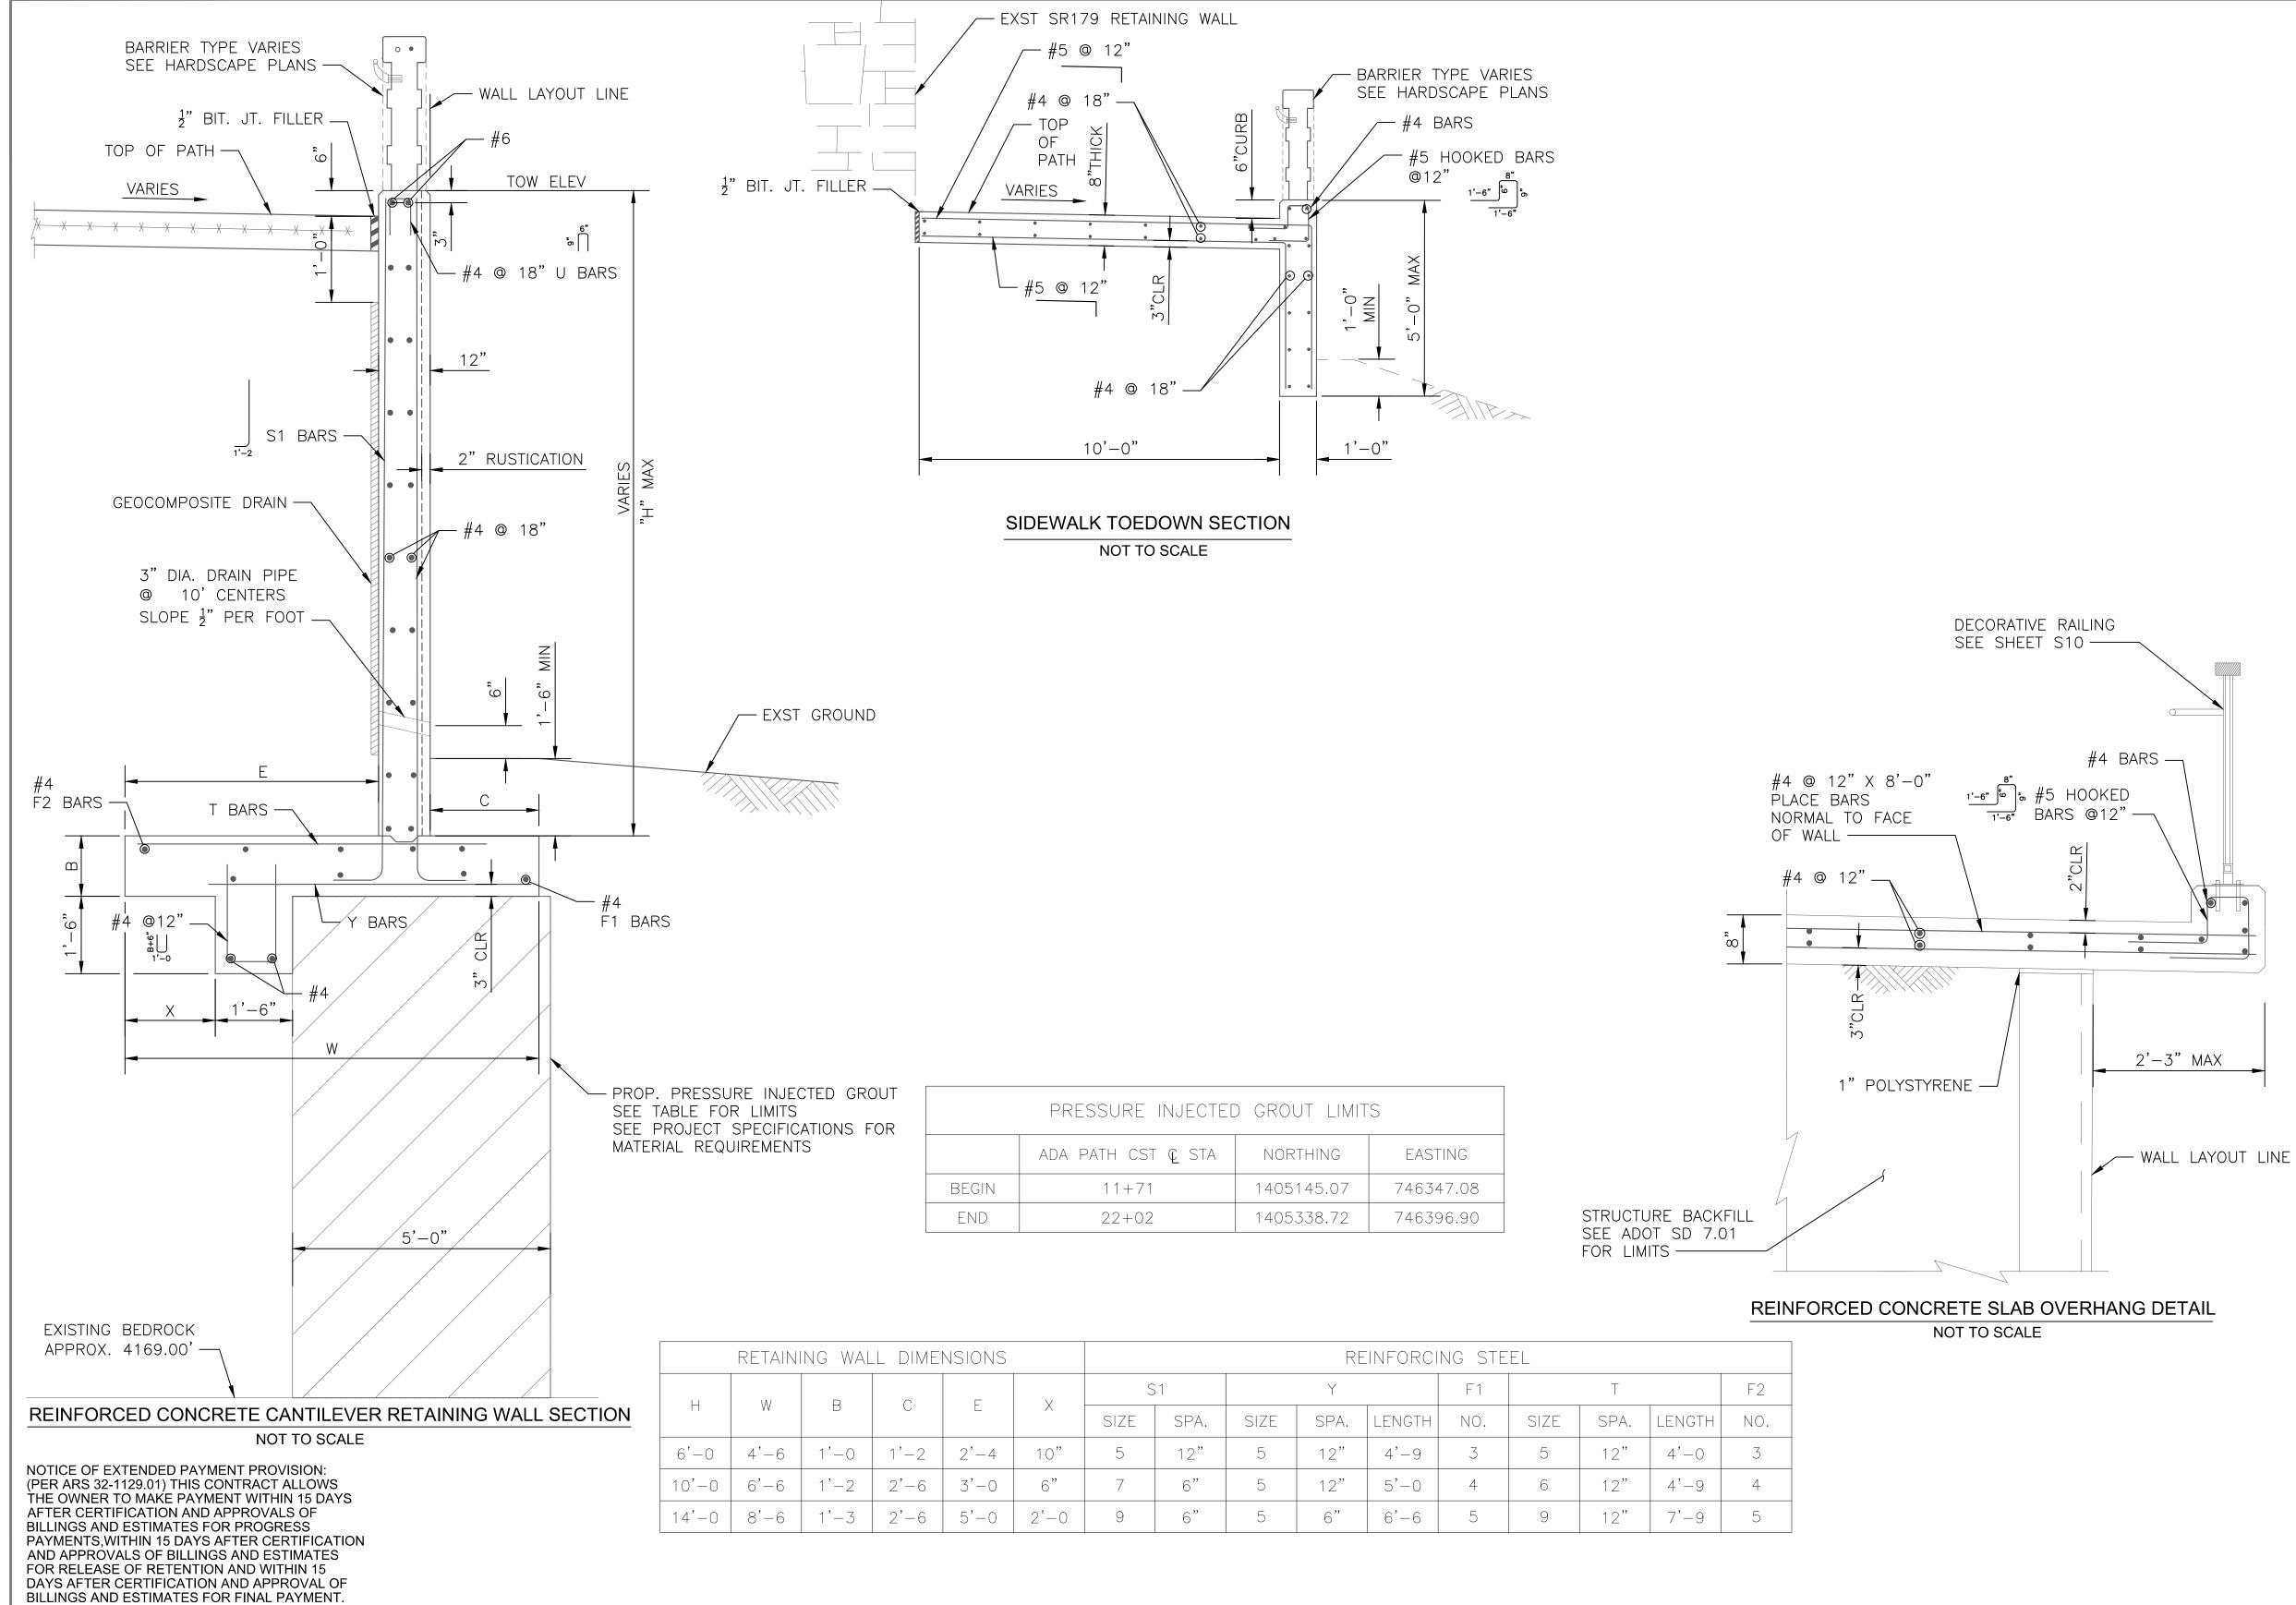

- 1. ALL CONCRETE SHALL BE MAG CLASS
 A PER SECTION 725 OF MAG
 STANDARD SPECIFICATIONS, UNLESS
 NOTED OTHERWISE. CANTILEVER
 RETAINING WALL CONCRETE SHALL BE
 ADOT CLASS "S", THE 28-DAY
 COMPRESSIVE STRENGTH SHALL BE F'C
 = 3000 PSI.
- 2. REINFORCING STEEL SHALL CONFORM TO ASTM SPECIFICATION A934 EPOXY COATED REINFORCING BARS. ALL REINFORCING SHALL BE GRADE 60. ALL BENDS AND HOOKS SHALL MEET THE REQUIREMENTS OF OF AASHTO LRFD ARTICLE 5.10. ALL BEND DIMENSIONS FOR REINFORCING STEEL SHALL BE OUT—TO—OUT OF BARS. ALL PLACEMENT DIMENSIONS FOR REINFORCING STEEL SHALL BE TO CENTER OF BARS UNLESS NOTED OTHERWISE.
- 3. SEE ADOT SD 7.01, CASE I FOR RETAINING WALL DIMENSIONS AND REINFORCING DETAILS NOT SHOWN OR NOTED.
- 4. TOP OF WALL SHALL BE 6" ABOVE TOP OF PATH, EXCEPT AT OVERHANG SLAB. SEE ROADWAY SHEETS.
- 5. THE EXPOSED FACE OF WALLS SHALL BE RUSTICATED. SEE AESTHETIC REQUIREMENTS FOR ADDITIONAL INFORMATION.
- 6. MINIMUM LAP LENGTH FOR BAR SPLICES SHALL BE:

#4 1'-0" #5 1'-3" #6 1'-8" #7 2'-2"


7. SEE PROJECT TECHNICAL SPECIFICATIONS FOR PRESSURE INJECTED GROUT REQUIREMENTS.



Symbol	Revisions	Date	Appr.	Designed by:	Date:
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				WD	AS NOTED
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				AGG	STRUCTURAL





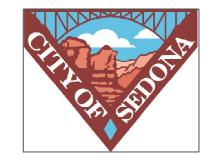

CITY OF SEDONA PUBLIC WORKS DEPARTMENT 102 ROADRUNNER DRIVE	-
SEDONA ARIZONA 86336	

SEDONA, ARIZONA 86336 928-204-7111

SR 179 PE	DESTRIAN	CROSSING
AT	OAK CRE	EK
SED	ONA ARIZO	ANC


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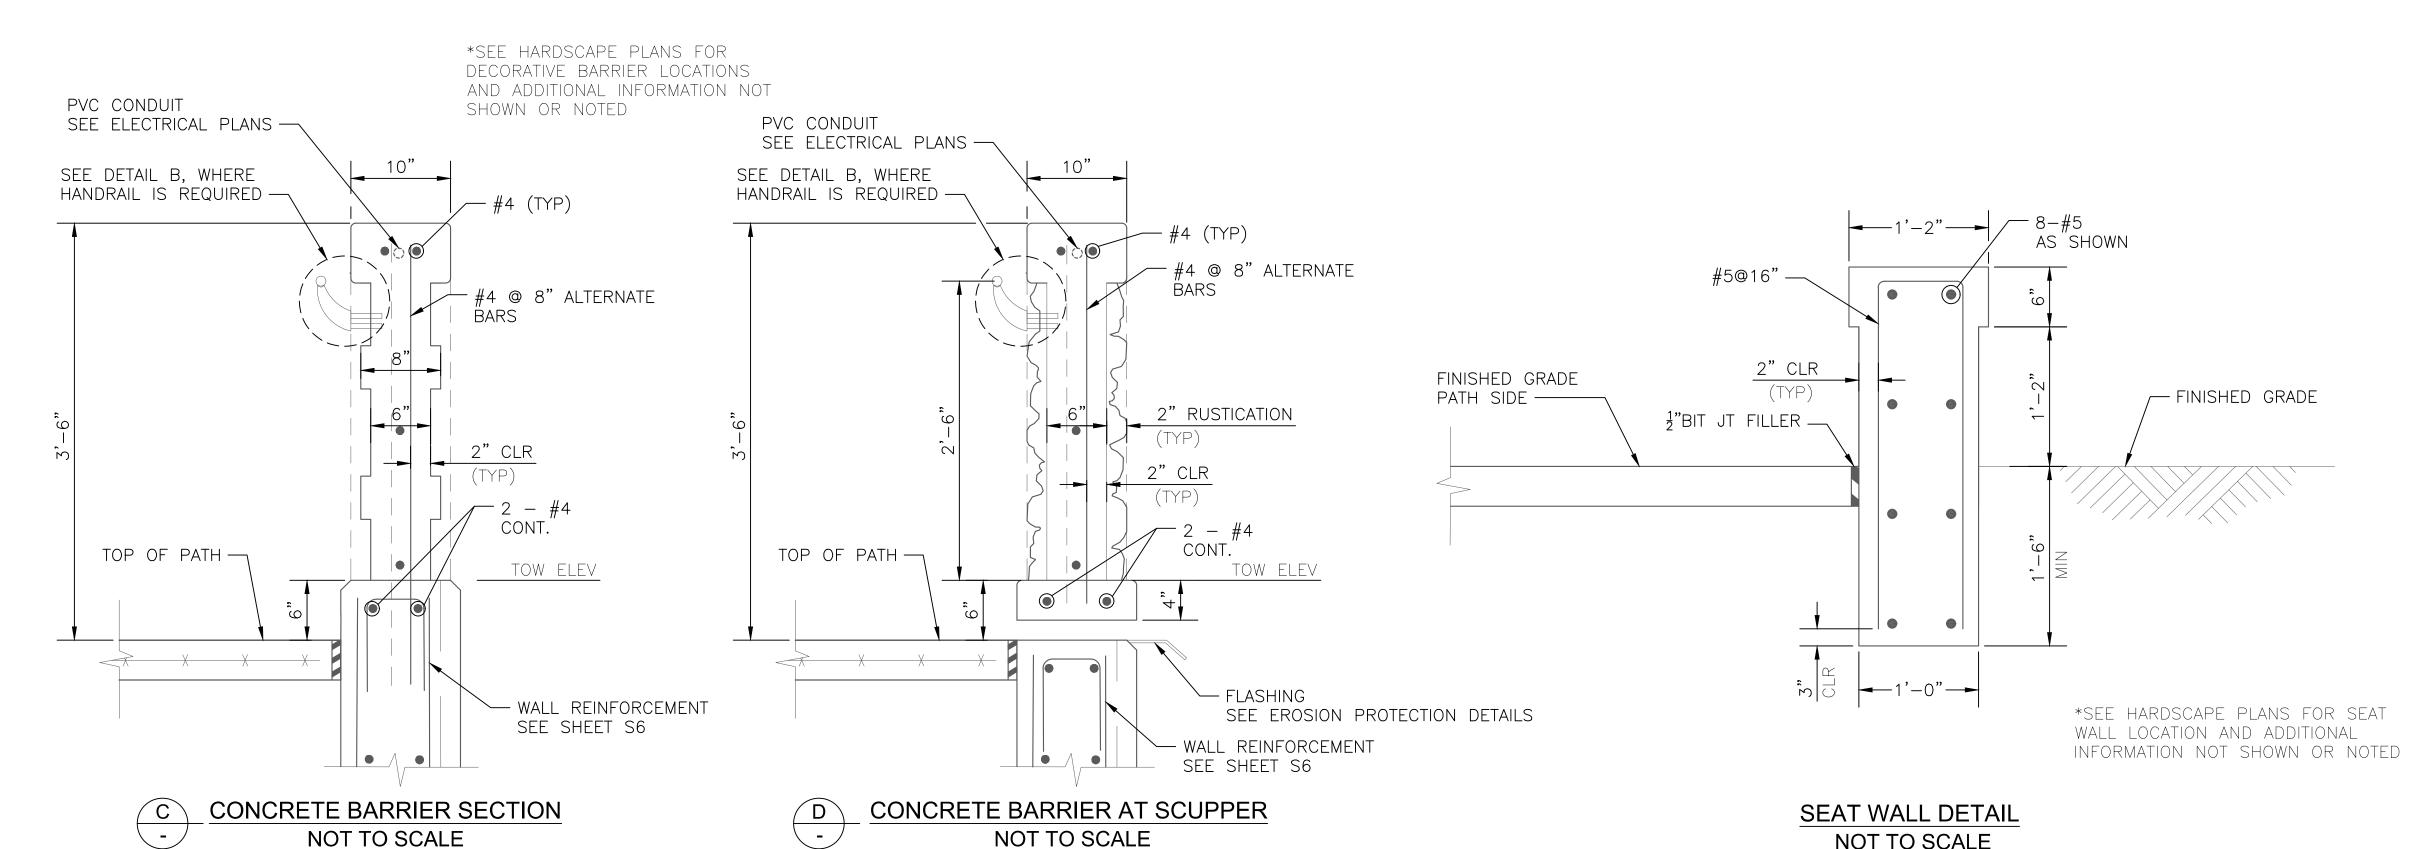
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MISCELLANEOUS STRUCTURAL DETAILS 1 17 0F


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NOT TO SCALE



NOTICE OF EXTENDED PAYMENT PROVISION: (PER ARS 32-1129.01) THIS CONTRACT ALLOWS THE OWNER TO MAKE PAYMENT WITHIN 15 DAYS AFTER CERTIFICATION AND APPROVALS OF BILLINGS AND ESTIMATES FOR PROGRESS PAYMENTS, WITHIN 15 DAYS AFTER CERTIFICATION AND APPROVALS OF BILLINGS AND ESTIMATES FOR RELEASE OF RETENTION AND WITHIN 15 DAYS AFTER CERTIFICATION AND APPROVAL OF BILLINGS AND ESTIMATES FOR FINAL PAYMENT.



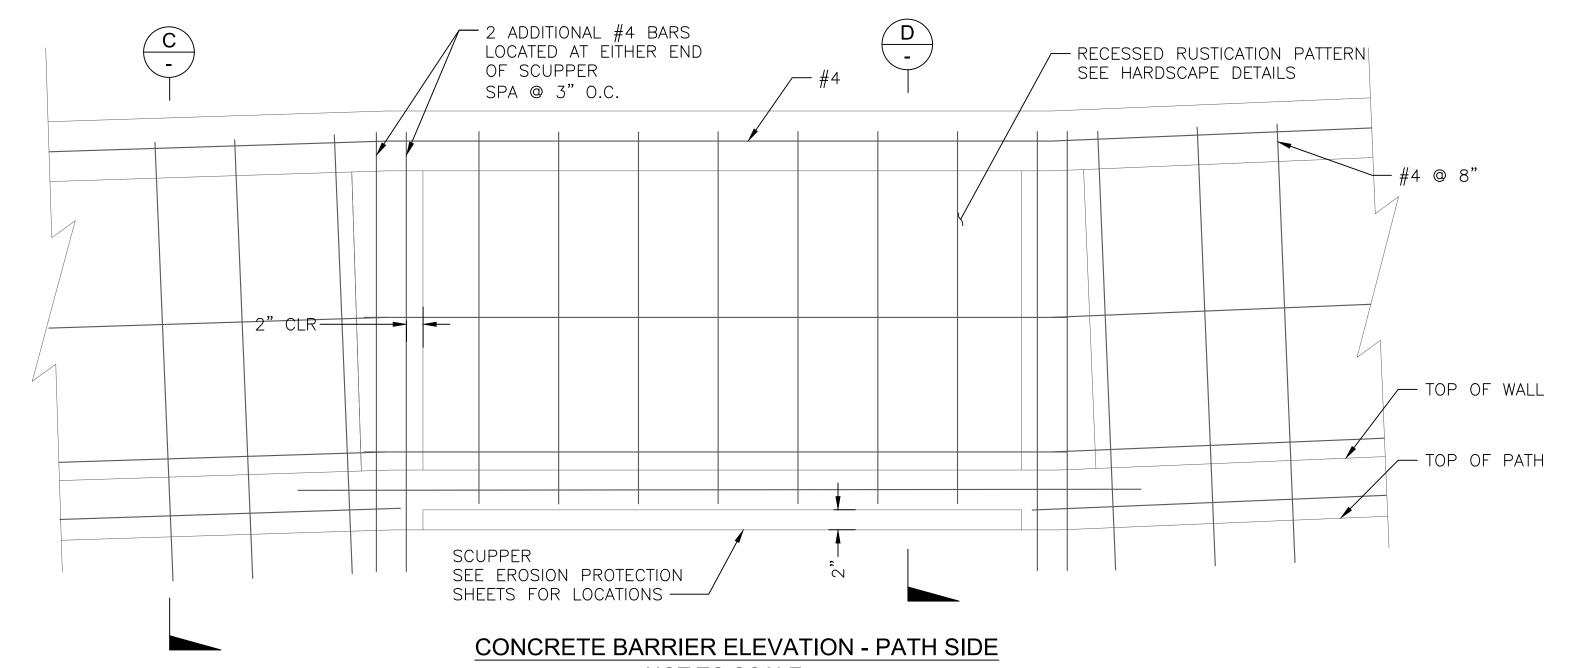

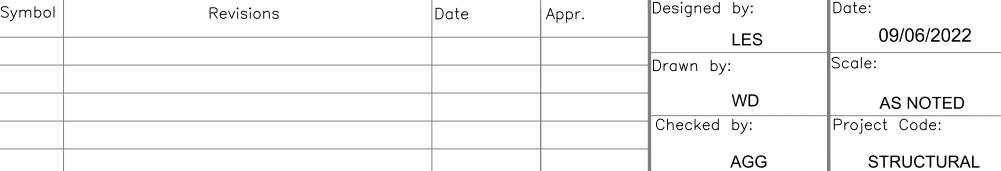



WSP USA Inc.

Tempe, AZ 85281

Suite 400

1230 W. Washington St.

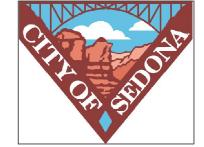

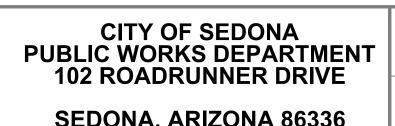

SEDONA, ARIZONA 86336	
928-204-7111	

SR	179	PEDESTRIAN	CROSSING
		AT OAK CREI	EK
	S	EDONA ARIZO	ANC

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		S7	
SHEET	NO		

MISCELLANEOUS STRUCTURAL DETAILS 2

NOTES:

1. ALL CONCRETE SHALL BE MAG CLASS A PER SECTION 725 OF MAG

STANDARD SPECIFICATIONS, UNLESS

2. REINFORCING STEEL SHALL CONFORM

AND HOOKS SHALL MEET THE

OUT-TO-OUT OF BARS. ALL PLACEMENT DIMENSIONS FOR

3. MINIMUM LAP LENGTH FOR BAR

SPLICES SHALL BE:

#4 1'-0" #5 1'-3"

#6 1'-8" #7 2'-2"

TO ASTM SPECIFICATION A934 EPOXY COATING REINFORCING. ALL BENDS

REQUIREMENTS OF OF AASHTO LRFD ARTICLE 5.10. ALL BEND DIMENSIONS FOR REINFORCING STEEL SHALL BE

REINFORCING STEEL SHALL BE TO CENTER OF BARS UNLESS NOTED

NOTED OTHERWISE.


OTHERWISE.

Contact Arizona 811 at least two full

Call 811 or click Arizona811.com

DATE SAVED: 9/20/22 T:\SEDONA 179\STRUCTURE\WLP07.DWG

NOT TO SCALE

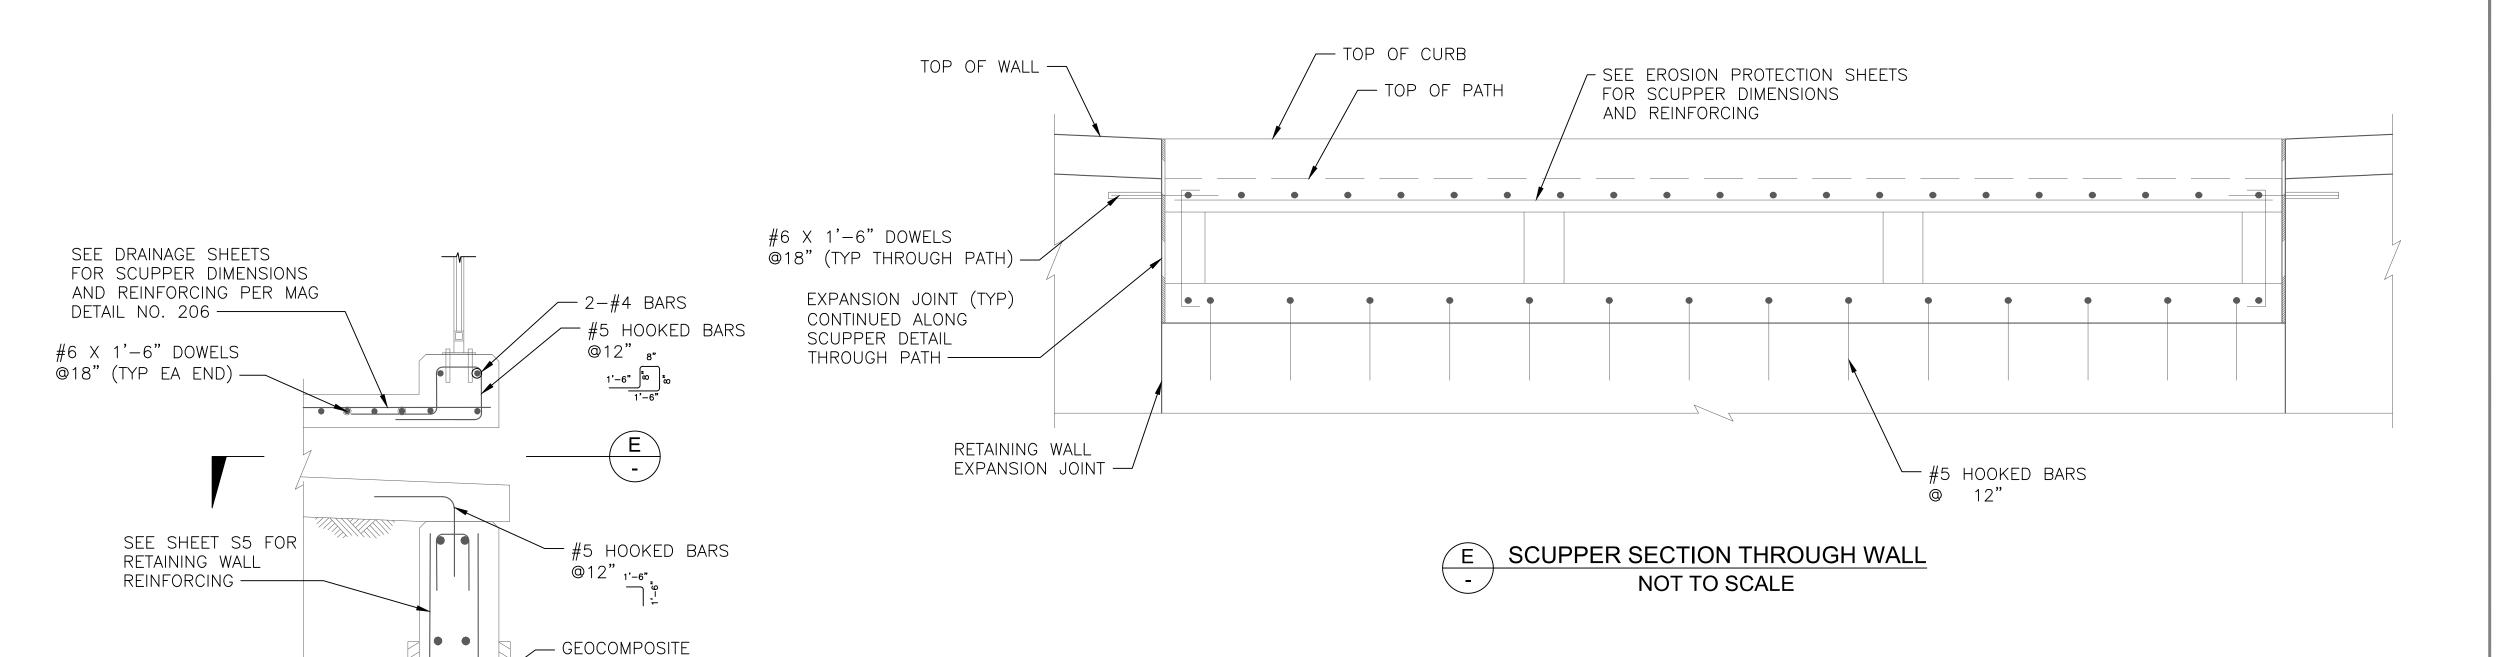

- 1. ALL CONCRETE SHALL BE MAG CLASS A PER SECTION 725 OF MAG STANDARD SPECIFICATIONS, UNLESS NOTED OTHERWISE.
- 2. REINFORCING STEEL SHALL CONFORM TO ASTM SPECIFICATION A934 EPOXY COATING REINFORCING. ALL BENDS AND HOOKS SHALL MEET THE REQUIREMENTS OF OF AASHTO LRFD ARTICLE 5.10. ALL BEND DIMENSIONS FOR REINFORCING STEEL SHALL BE OUT—TO—OUT OF BARS. ALL PLACEMENT DIMENSIONS FOR REINFORCING STEEL SHALL BE TO CENTER OF BARS UNLESS NOTED OTHERWISE.
- 3. MINIMUM LAP LENGTH FOR BAR SPLICES SHALL BE:

#4 1'-0" #5 1'-3" #6 1'-8" #7 2'-2"

SCUPPER CONNECTION DETAIL
NOT TO SCALE

DRAIN (TYP)

NOTICE OF EXTENDED PAYMENT PROVISION:
(PER ARS 32-1129.01) THIS CONTRACT ALLOWS
THE OWNER TO MAKE PAYMENT WITHIN 15 DAYS
AFTER CERTIFICATION AND APPROVALS OF
BILLINGS AND ESTIMATES FOR PROGRESS
PAYMENTS, WITHIN 15 DAYS AFTER CERTIFICATION
AND APPROVALS OF BILLINGS AND ESTIMATES
FOR RELEASE OF RETENTION AND WITHIN 15
DAYS AFTER CERTIFICATION AND APPROVAL OF
BILLINGS AND ESTIMATES FOR FINAL PAYMENT.

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				WD	AS NOTED
				Checked by:	Project Code:
				AGG	STRUCTURAL







CITY OF SEDONA PUBLIC WORKS DEPARTMENT 102 ROADRUNNER DRIVE	
SEDONA, ARIZONA 86336	

928-204-7111

MISCELLANEOUS
STRUCTURAL DETAILS 3


SR 179 PEDESTRIAN CROSSING AT OAK CREEK SEDONA ARIZONA

	Call 811 or click	Arizona811.com
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	S	3
	SHEET NO.	OF
3	19	44

Contact Arizona 811 at least two full

working days before you begin excavatior

DATE SAVED: 9/20/22 T:\SEDONA 179\STRUCTURE\WLP08.DWG

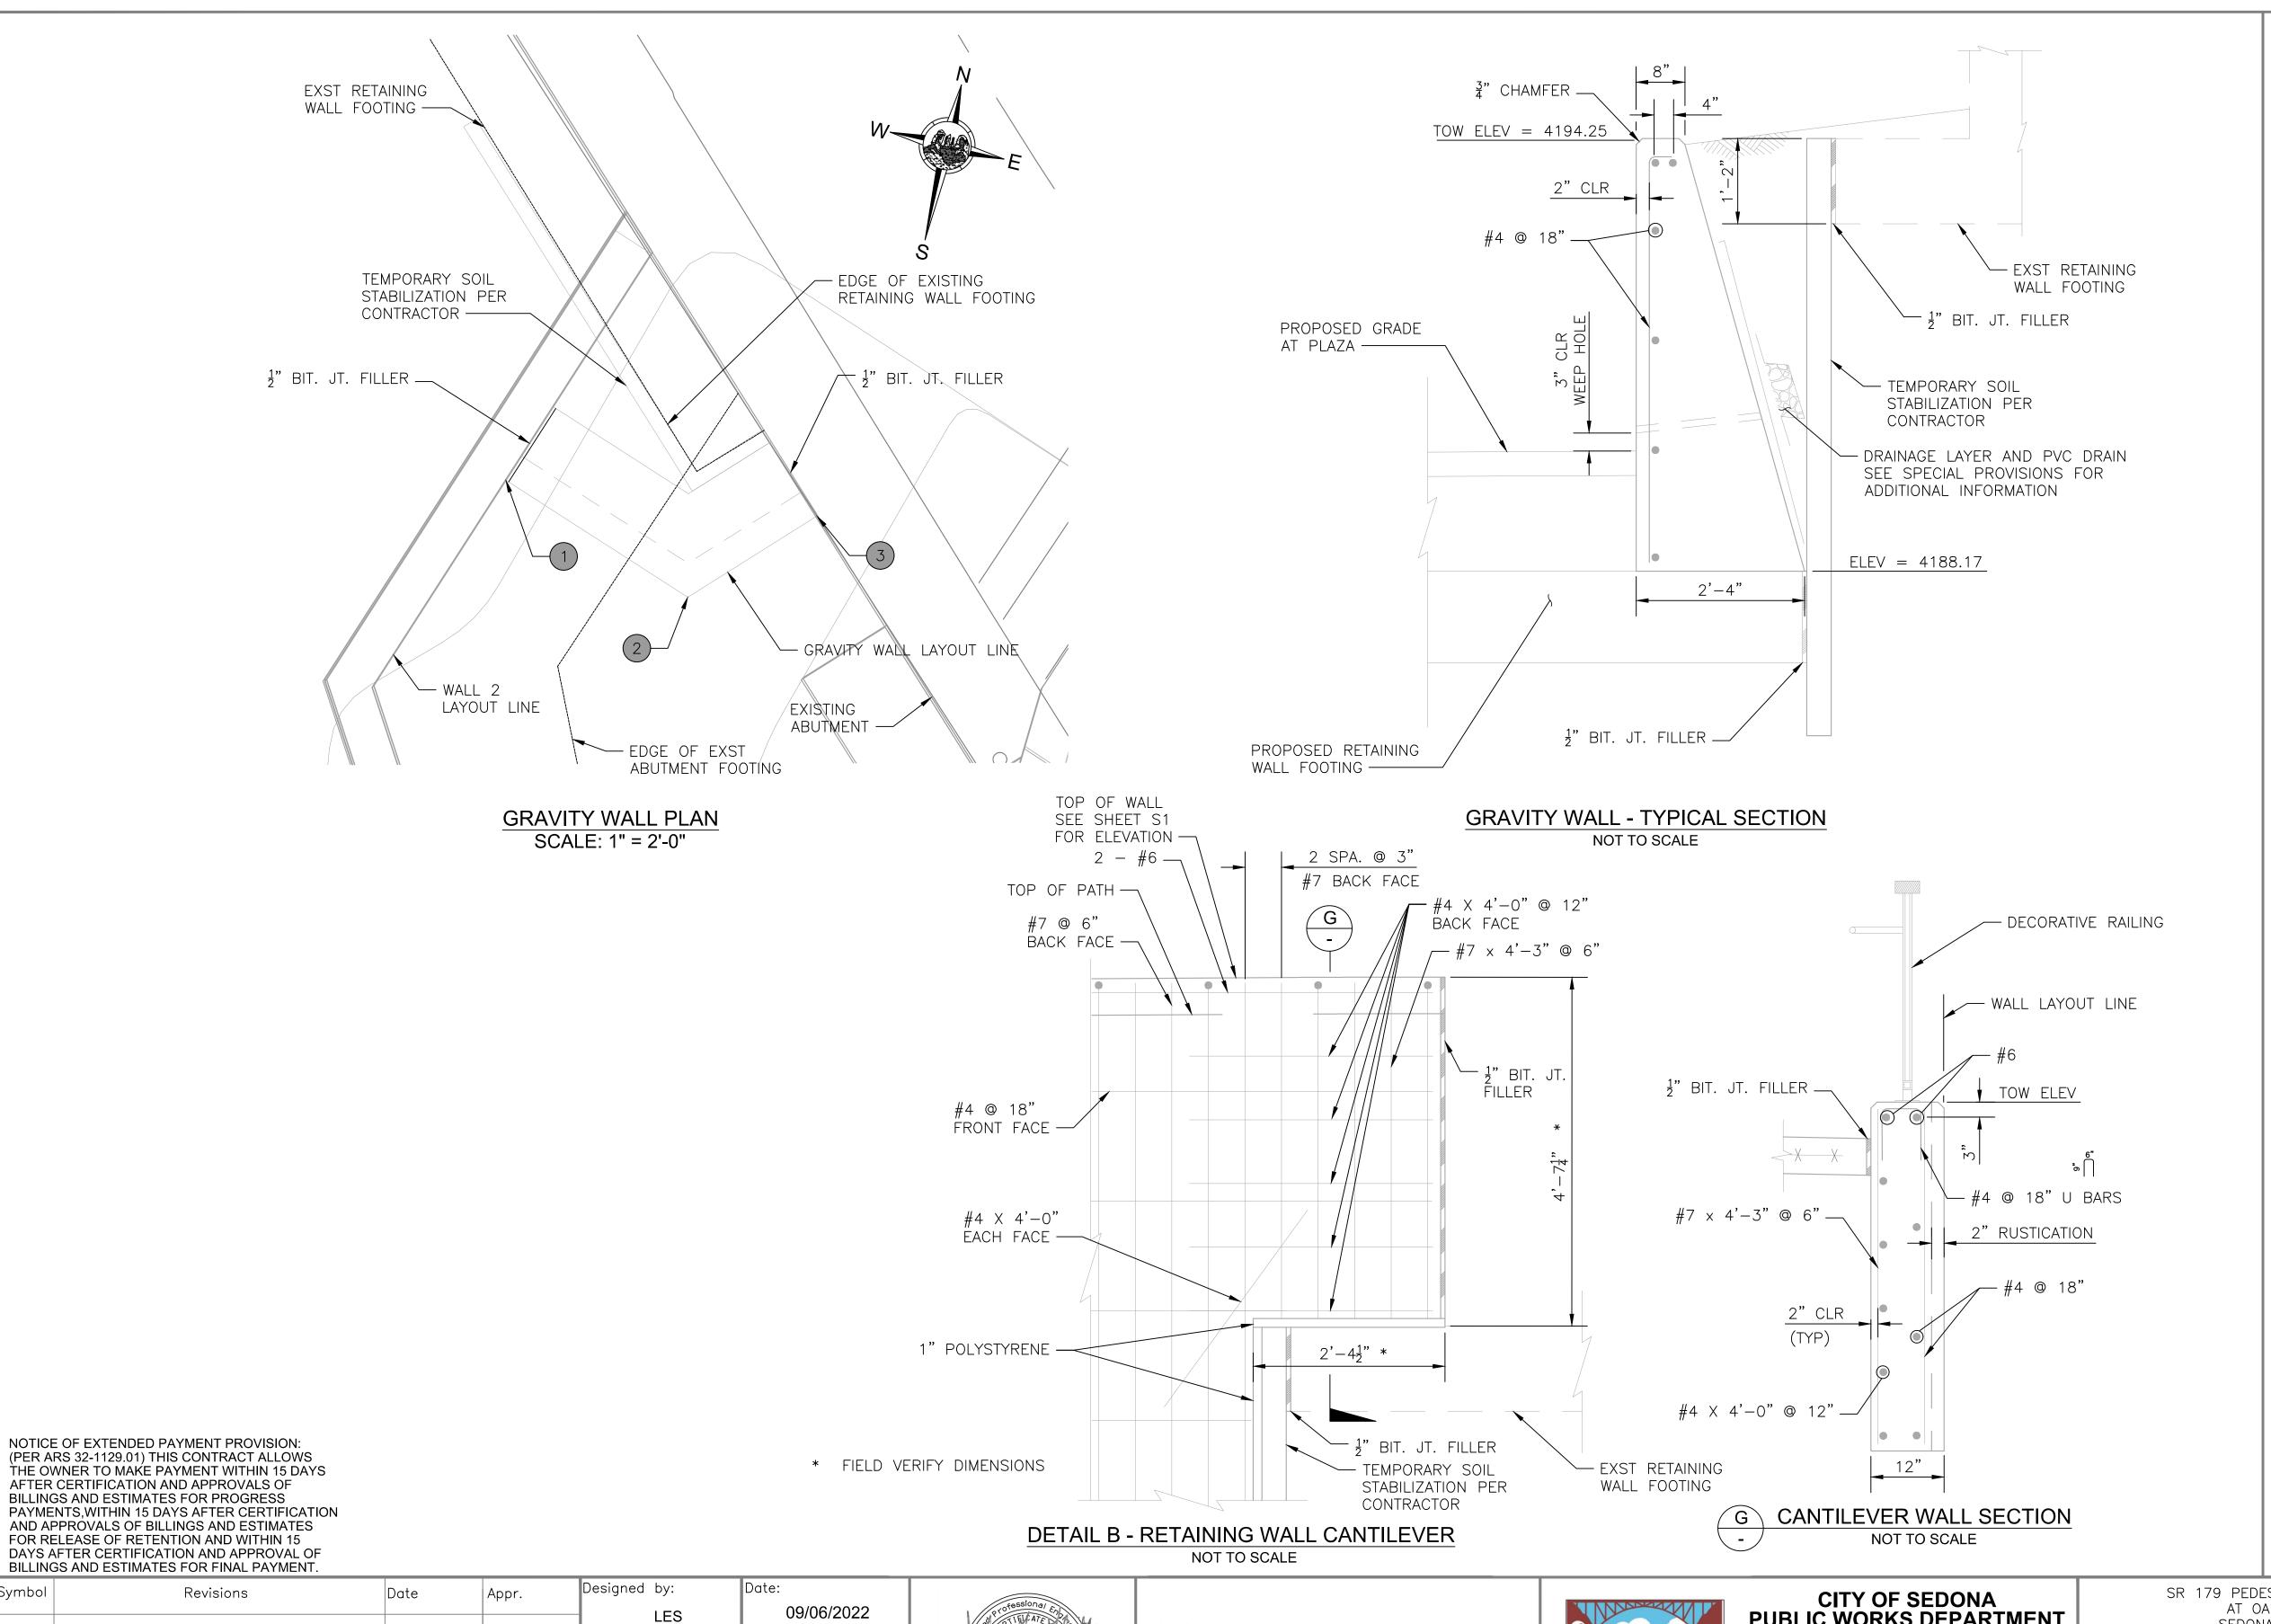

GRAVITY WALL NOTES:

- 1. CONCRETE FOR GRAVITY WALL SHALL BE CLASS A PER SECTION 725 OF MAG STANDARD SPECIFICATIONS.
- 2. REINFORCING STEEL SHALL CONFORM TO ASTM SPECIFICATION A934 EPOXY COATED REINFORCING BARS. ALL REINFORCING SHALL BE GRADE 60. ASTM A884, CLASS A WELDED WIRE FABRIC REINFORCING (WWR) MAY BE SUBSTITUTED ON AN EQUAL AREA BASIS.
- 3. ALL BENDS AND HOOKS SHALL MEET THE REQUIREMENTS OF OF AASHTO LRFD ARTICLE 5.10. ALL BEND DIMENSIONS FOR REINFORCING STEEL SHALL BE OUT—TO—OUT OF BARS. ALL PLACEMENT DIMENSIONS FOR REINFORCING STEEL SHALL BE TO CENTER OF BARS UNLESS NOTED OTHERWISE.
- 4. AGGREGATE SHALL BE PER MAG TABLE 605-1 F1 OR F2. GEOSYNTHETIC FABRIC SHALL BE PER MAG TABLE 796-2 CLASS B. PROVIDE A CONTINUOUS 1'X1' CLEAN GRAVEL OR CRUSHED ROCK DRAIN. WRAP DRAINAGE AREA AS SHOWN WITH GEOTEXTILE FABRIC. PROVIDE A 8"X8" GALVANIZED MESH WITH \(\frac{1}{4}\)" OPENINGS, AT THE INSIDE END OF THE PVC DRAIN PIPE. PROVIDE 2' DIA. PVC DRAIN PIPE (SCH. 40) AT 10 FT. MAX SPACING LOCATE 2'-0" MIN. FROM WALL JOINTS.
- 5. THE EXPOSED FACE OF WALLS SHALL BE RUSTICATED. SEE AESTHETIC REQUIREMENTS FOR ADDITIONAL INFORMATION.

	GRAVITY WALL				
PT	NORTHING	EASTING			
1	1405236.04	746340.70			
2	1405234.36	746345.44			
3	1405236.90	746347.94			



DILLINGO AIN	DECTIMATED FOR FINAL FATMENT.				
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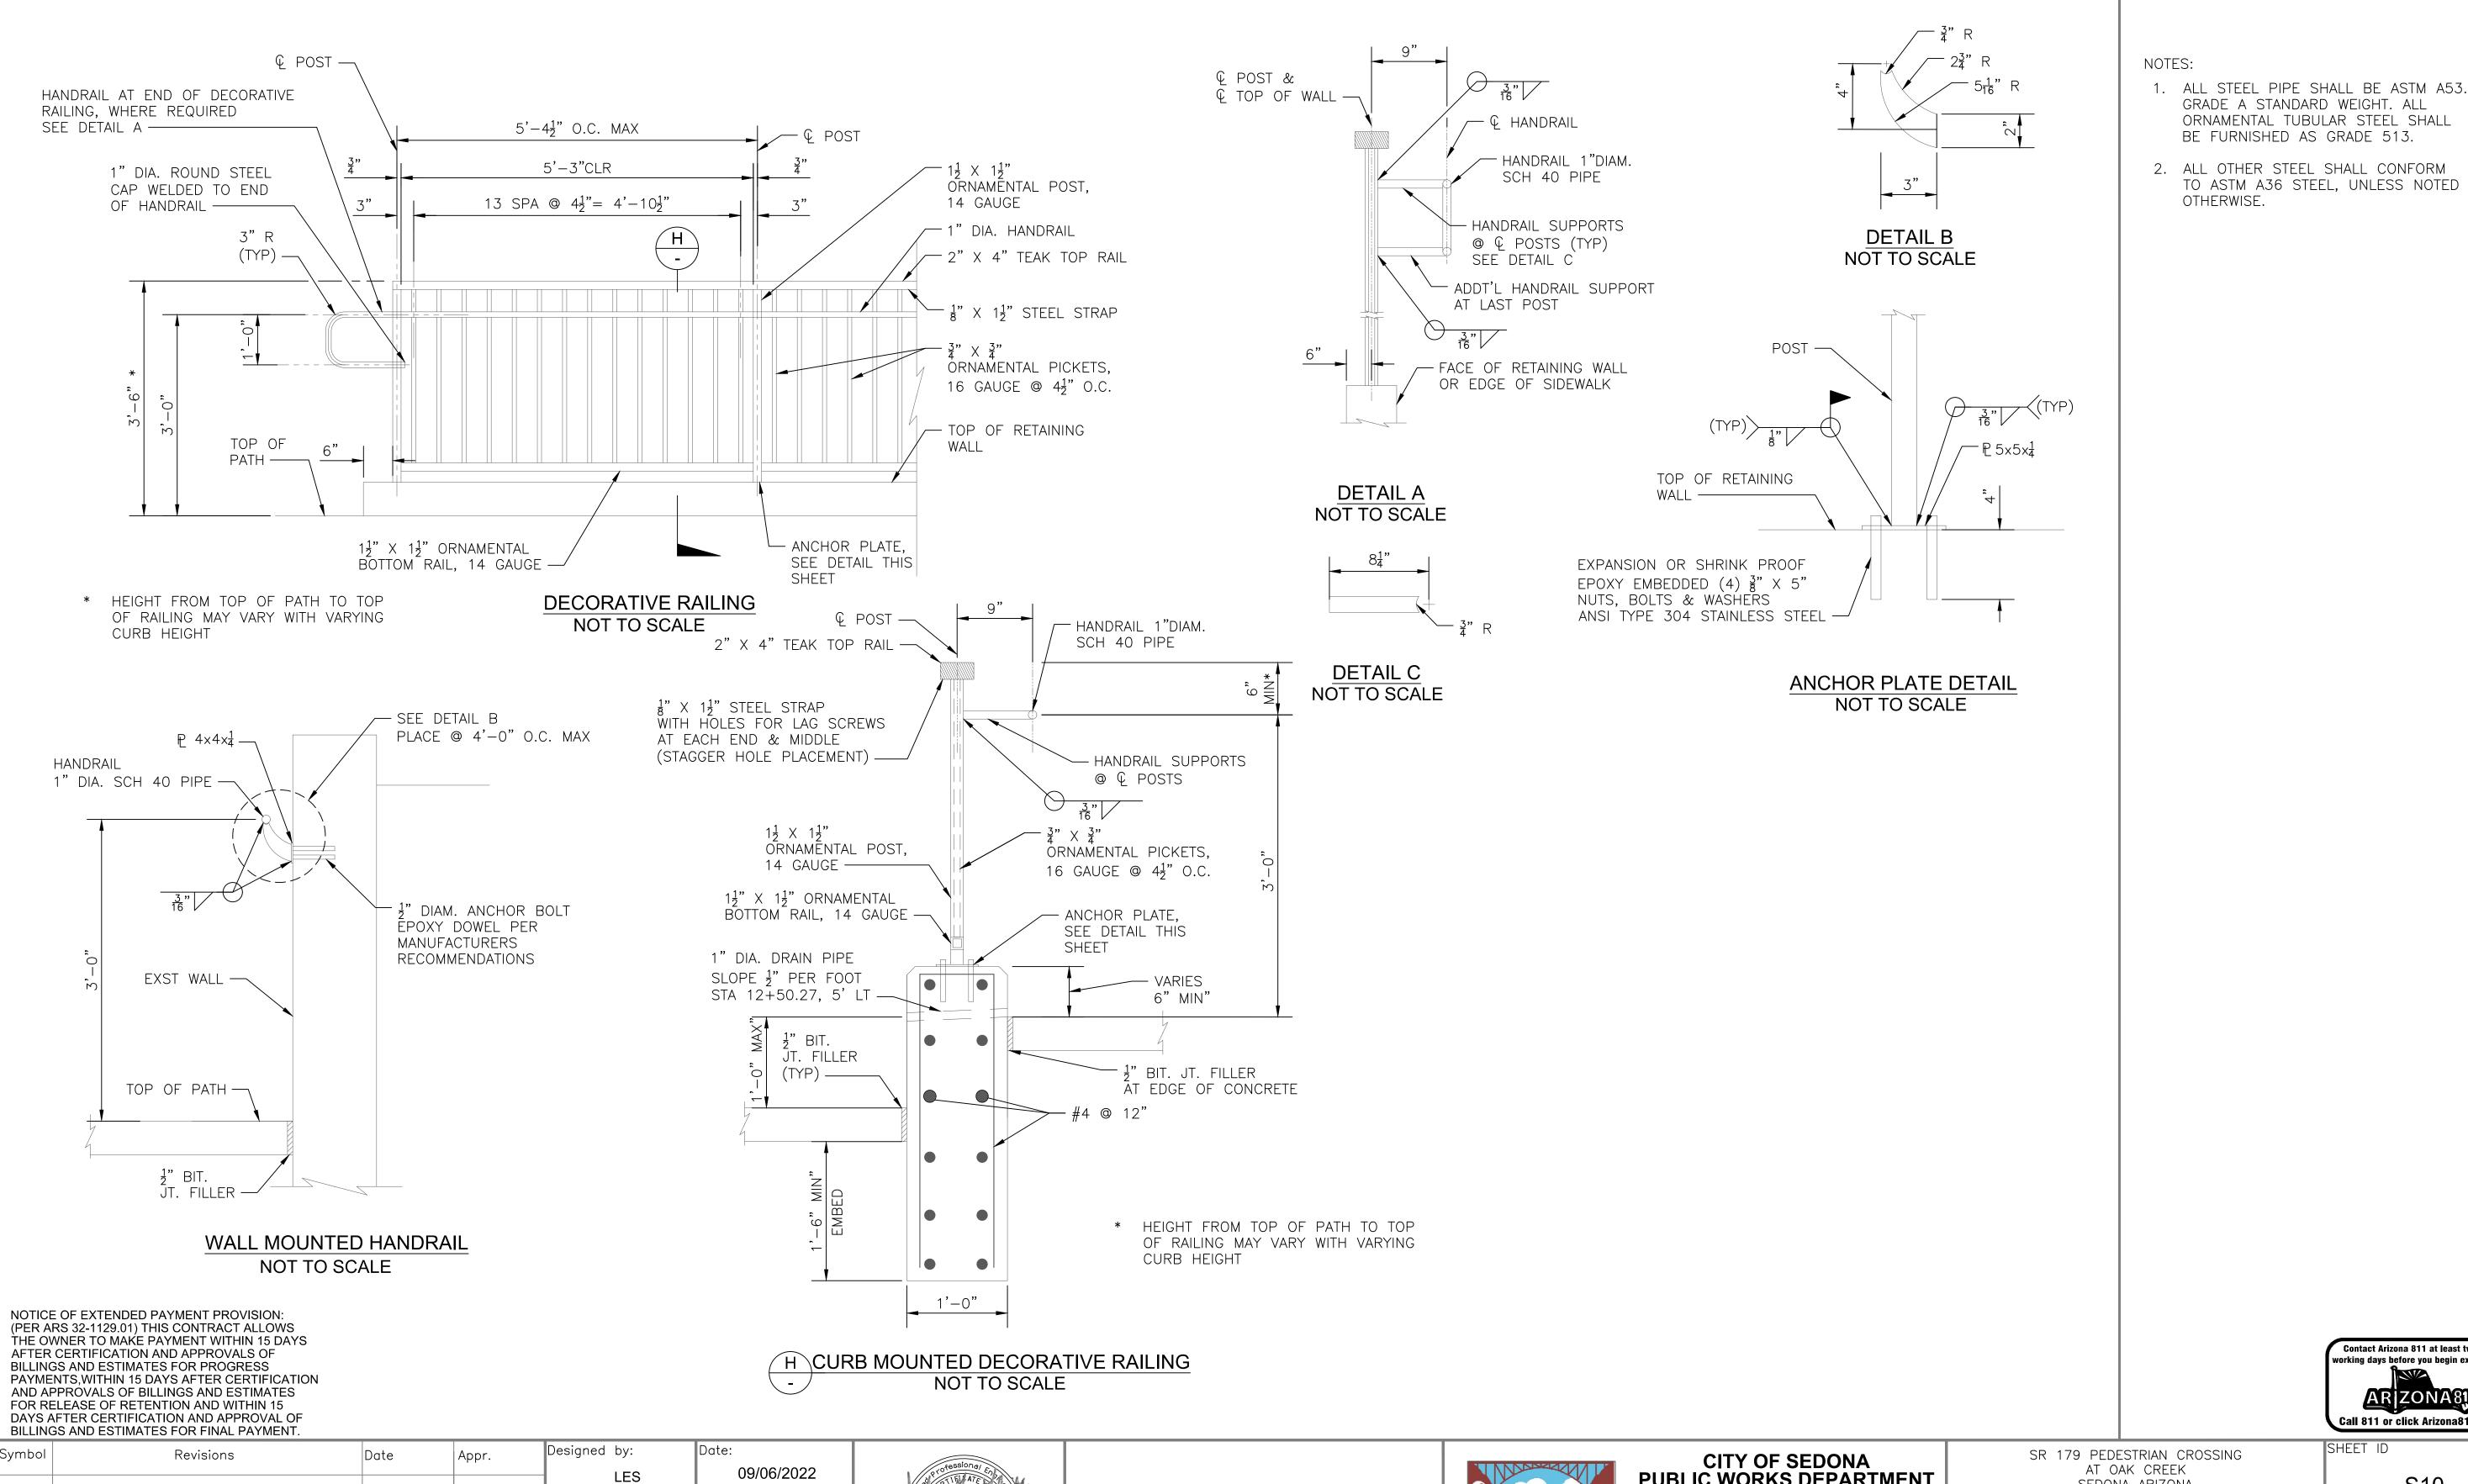
CITY OF SEDONA
PUBLIC WORKS DEPARTMENT
102 ROADRUNNER DRIVE
SEDONA, ARIZONA 86336

SEDONA, ARIZONA 86336 928-204-7111 SR 179 PEDESTRIAN CROSSING AT OAK CREEK SEDONA ARIZONA

SHEET ID S9

MISCELLANEOUS STRUCTURAL DETAILS 4 SHEET NO. OF **44**

DATE SAVED: 9/20/22 T:\SEDONA 179\STRUCTURE\WLP09.DWG



58889 ANGELA GRACE GALIETTI

09/23/2022

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Checked by:

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Project Code:



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Suite 400

1230 W. Washington St.

PUBLIC WORKS DEPARTMENT 102 ROADRUNNER DRIVE

SEDONA, ARIZONA 86336 928-204-7111

AT OAK CREEK SEDONA ARIZONA MISCELLANEOUS SHEET ID S10 SHEET NO.

Contact Arizona 811 at least two full

working days before you begin excavatior

Call 811 or click Arizona811.com

GRADE A STANDARD WEIGHT. ALL

BE FURNISHED AS GRADE 513.


OTHERWISE.

ORNAMENTAL TUBULAR STEEL SHALL

TO ASTM A36 STEEL, UNLESS NOTED

STRUCTURAL DETAILS 5

21 44

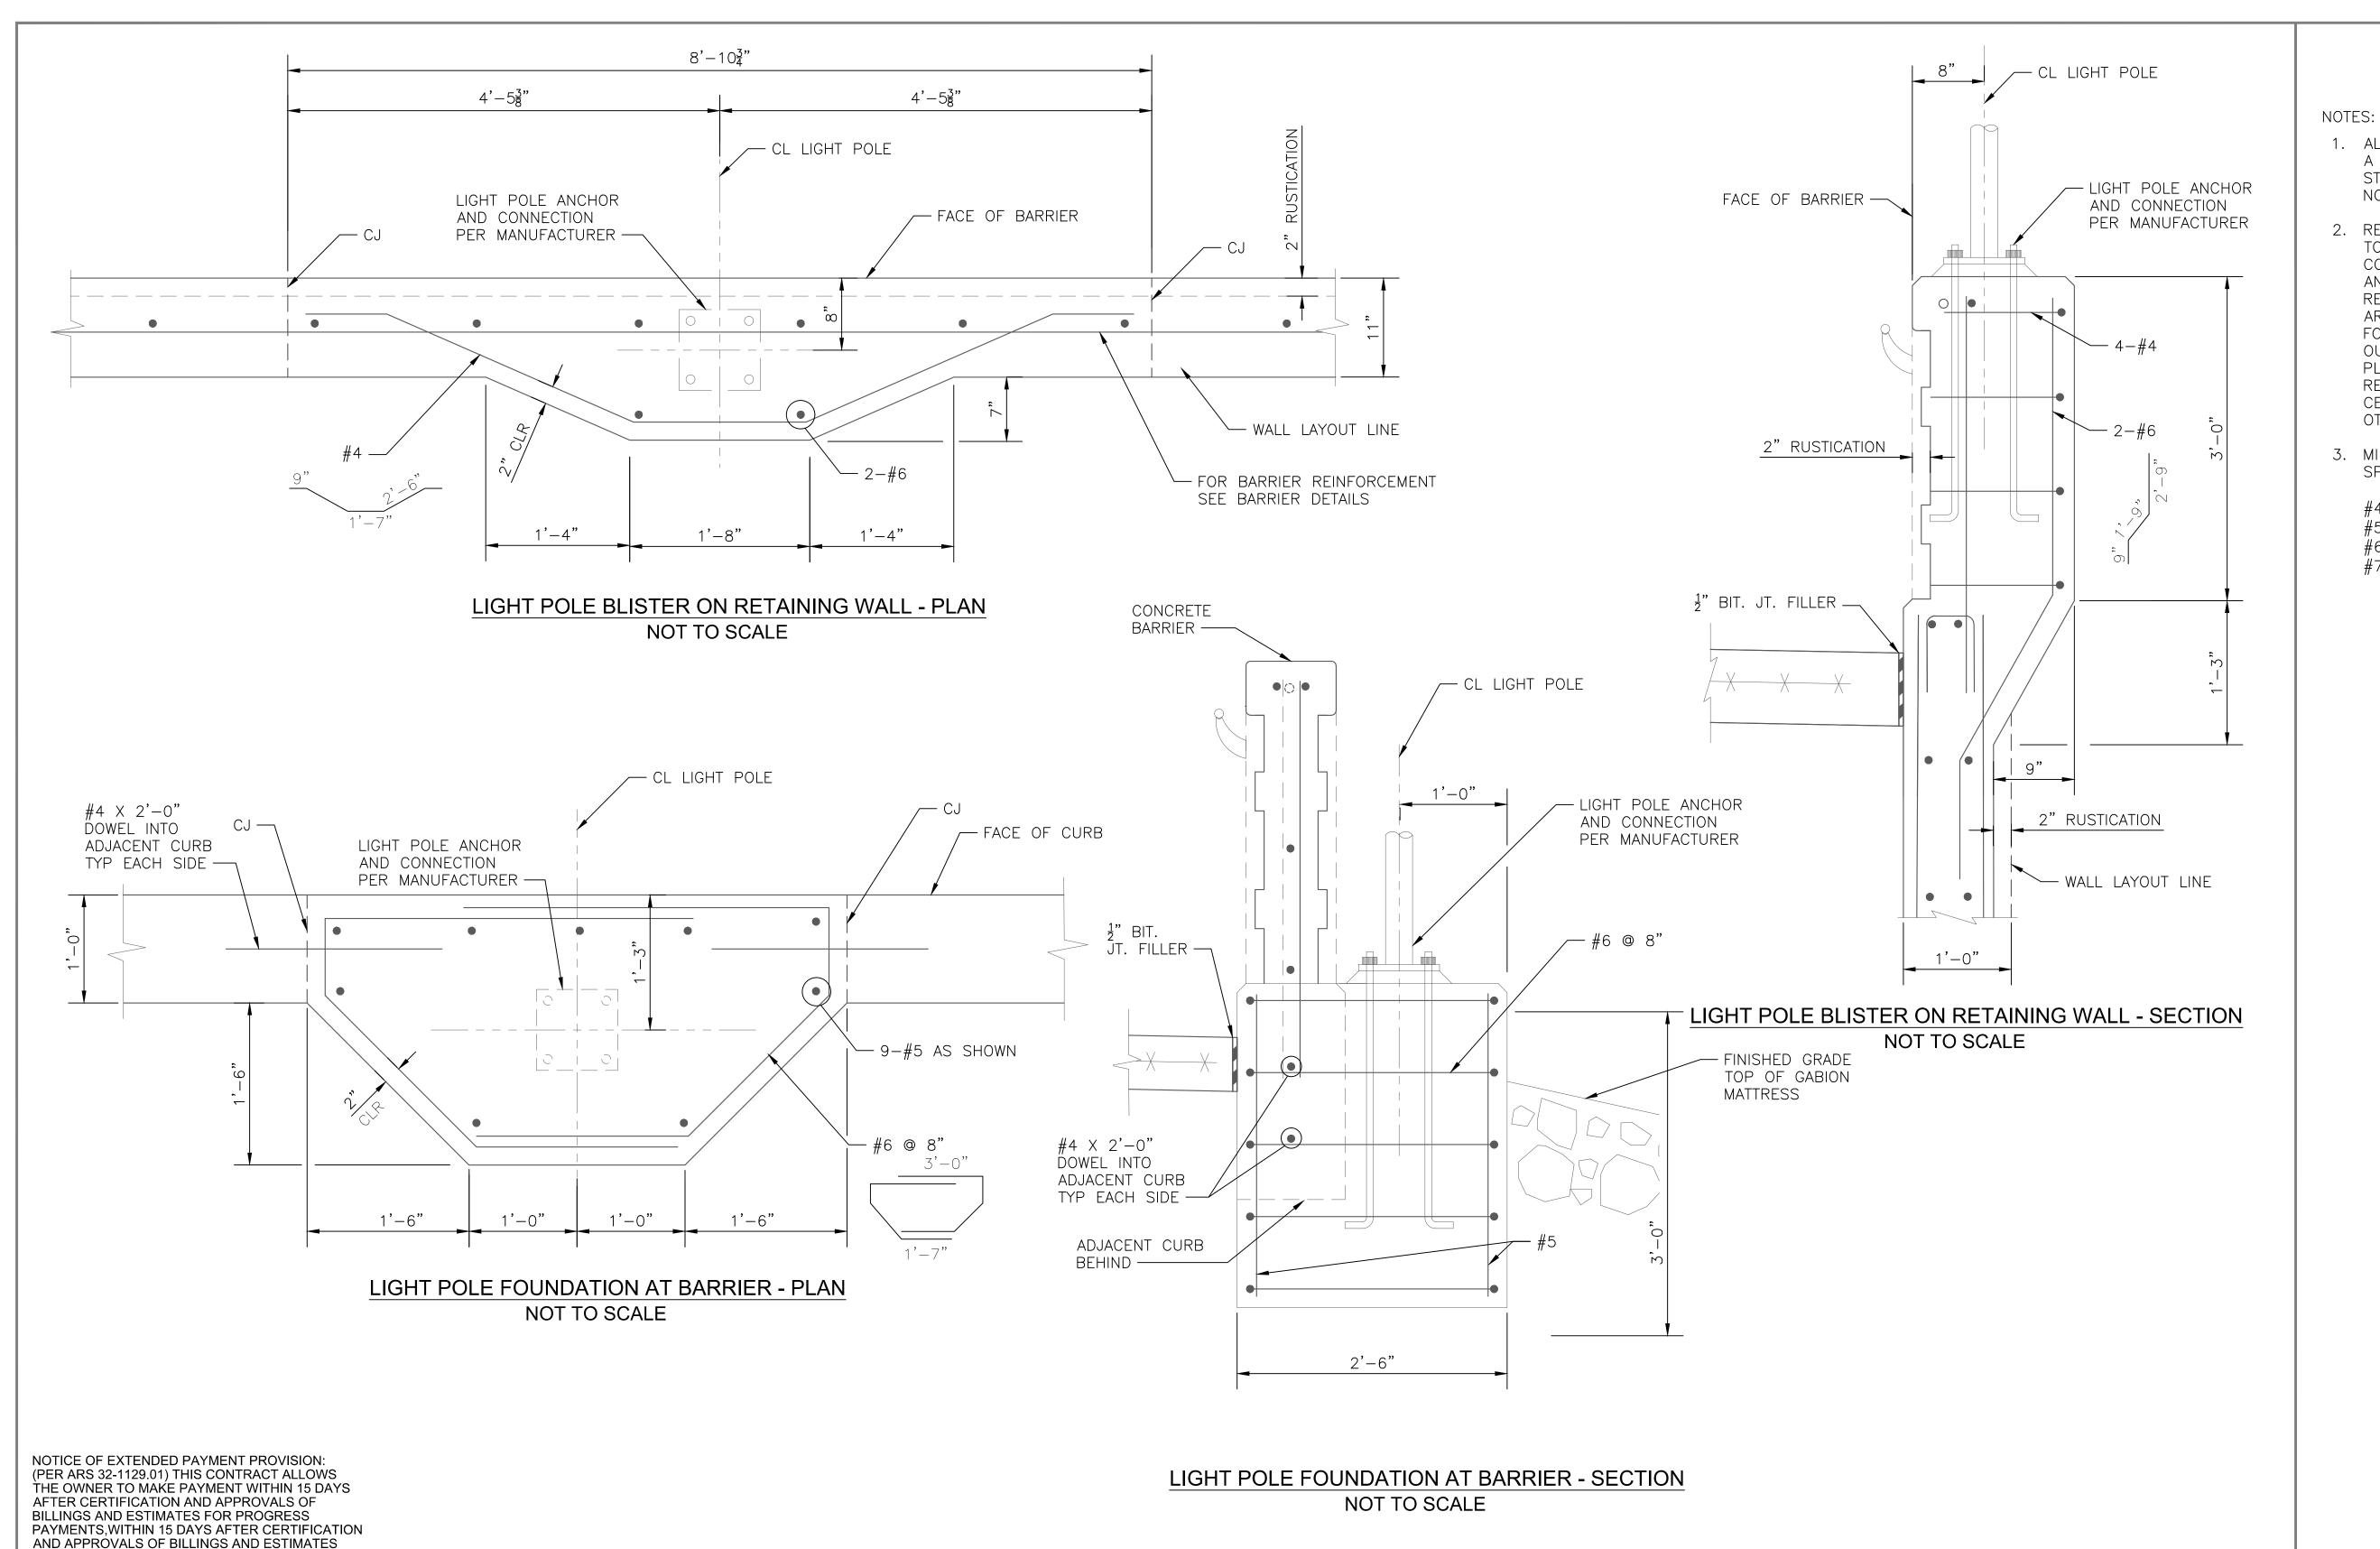

- 1. ALL CONCRETE SHALL BE MAG CLASS A PER SECTION 725 OF MAG STANDARD SPECIFICATIONS, UNLESS NOTED OTHERWISE.
- 2. REINFORCING STEEL SHALL CONFORM TO ASTM SPECIFICATION A934 EPOXY COATING REINFORCING. ALL BENDS AND HOOKS SHALL MEET THE REQUIREMENTS OF OF AASHTO LRFD ARTICLE 5.10. ALL BEND DIMENSIONS FOR REINFORCING STEEL SHALL BE OUT—TO—OUT OF BARS. ALL PLACEMENT DIMENSIONS FOR REINFORCING STEEL SHALL BE TO CENTER OF BARS UNLESS NOTED OTHERWISE.
- 3. MINIMUM LAP LENGTH FOR BAR SPLICES SHALL BE:

#4 1'-0" #5 1'-3" #6 1'-8" #7 2'-2"

Contact Arizona 811 at least two full working days before you begin excavation

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Call 811 or click Arizona811.com

Symbol Revisions

Date Appr.

Designed by:
LES 09/06/2022


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Scale:
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Checked by: Project Code:

AGG STRUCTURAL



WSP USA Inc. 1230 W. Washington St. Suite 400 Tempe, AZ 85281

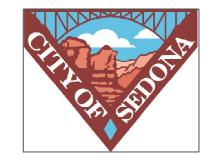

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CITY OF SEDONA PUBLIC WORKS DEPARTMENT 102 ROADRUNNER DRIVE	
SEDONA, ARIZONA 86336	

928-204-7111

SR 179 PEDESTRIAN CROSSING AT OAK CREEK SEDONA ARIZONA

SHEET ID

S11


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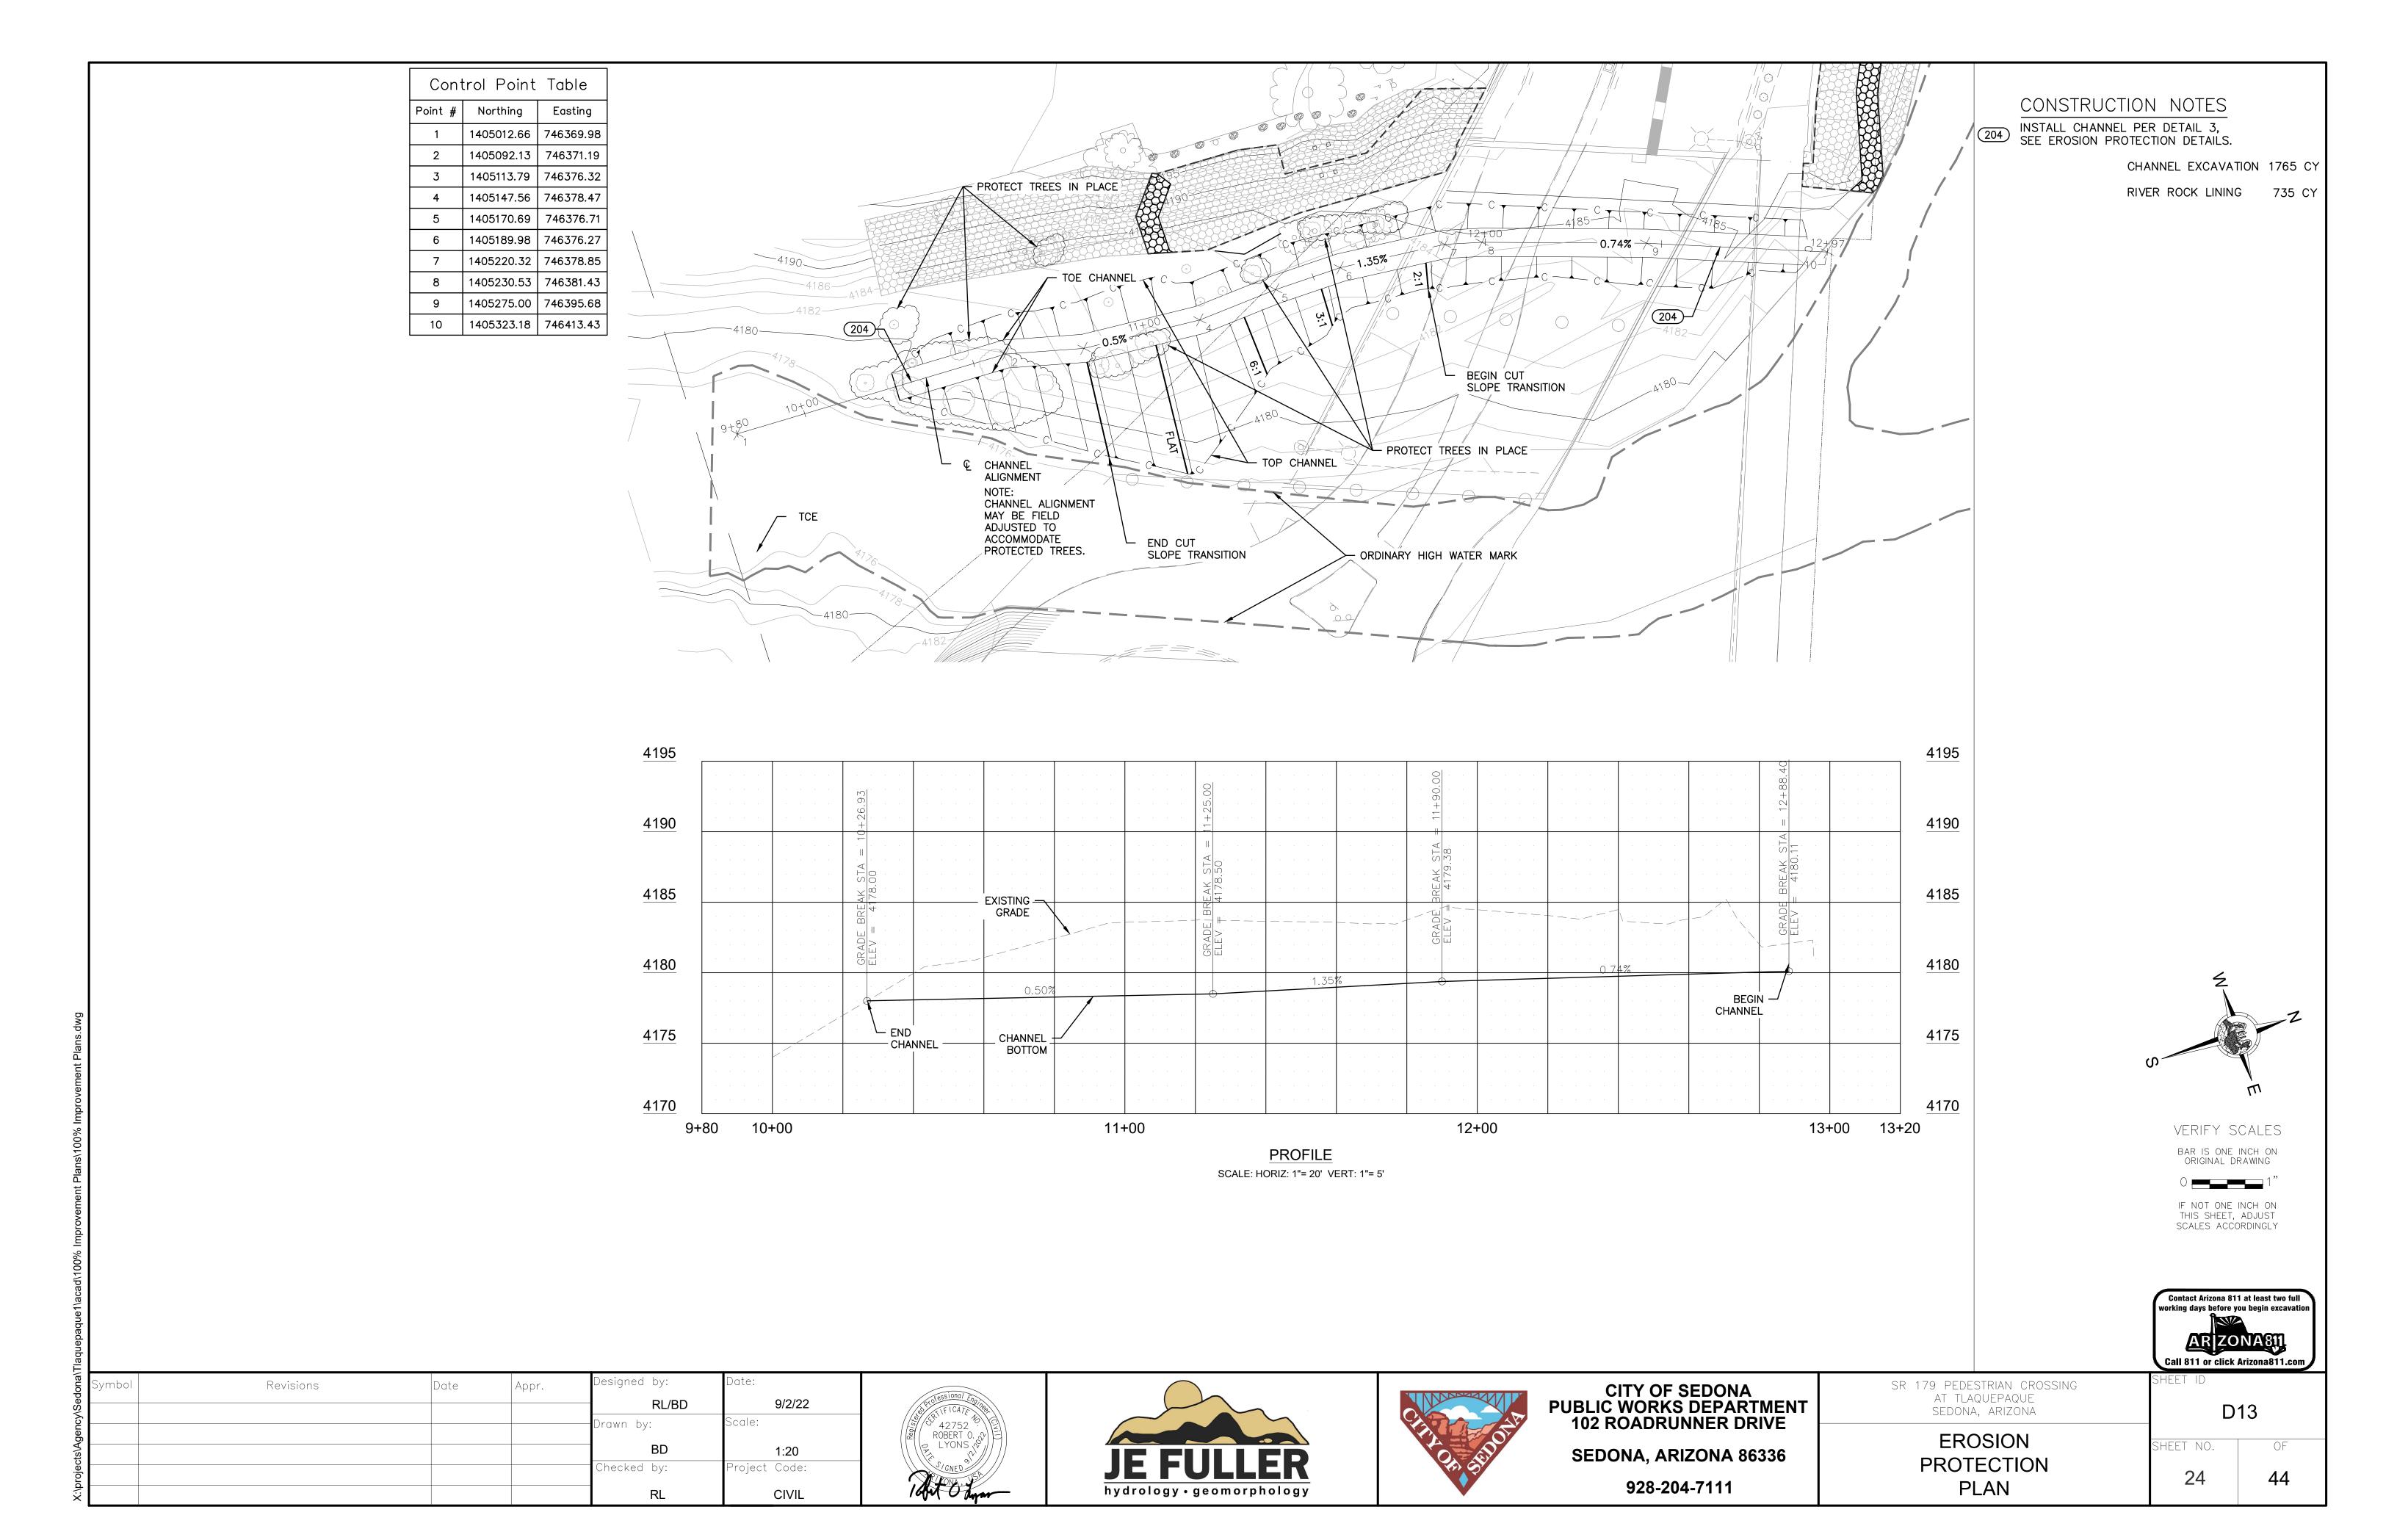
MISCELLANEOUS STRUCTURAL DETAILS 6


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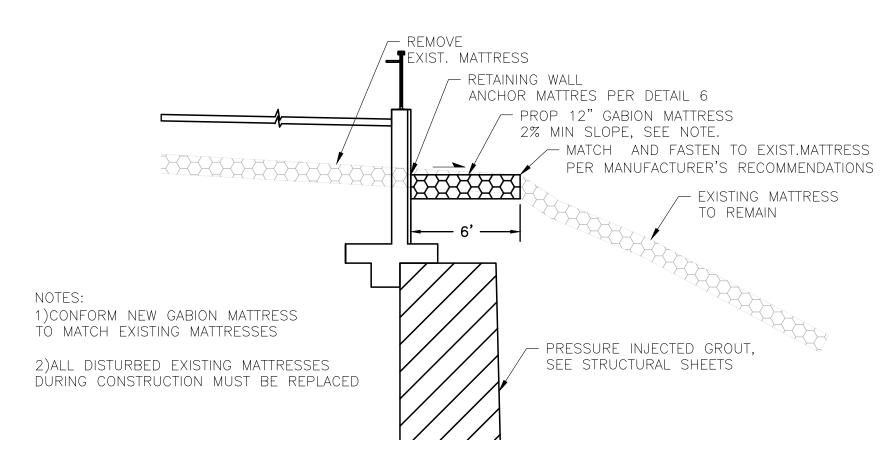
FOR RELEASE OF RETENTION AND WITHIN 15 DAYS AFTER CERTIFICATION AND APPROVAL OF

BILLINGS AND ESTIMATES FOR FINAL PAYMENT.






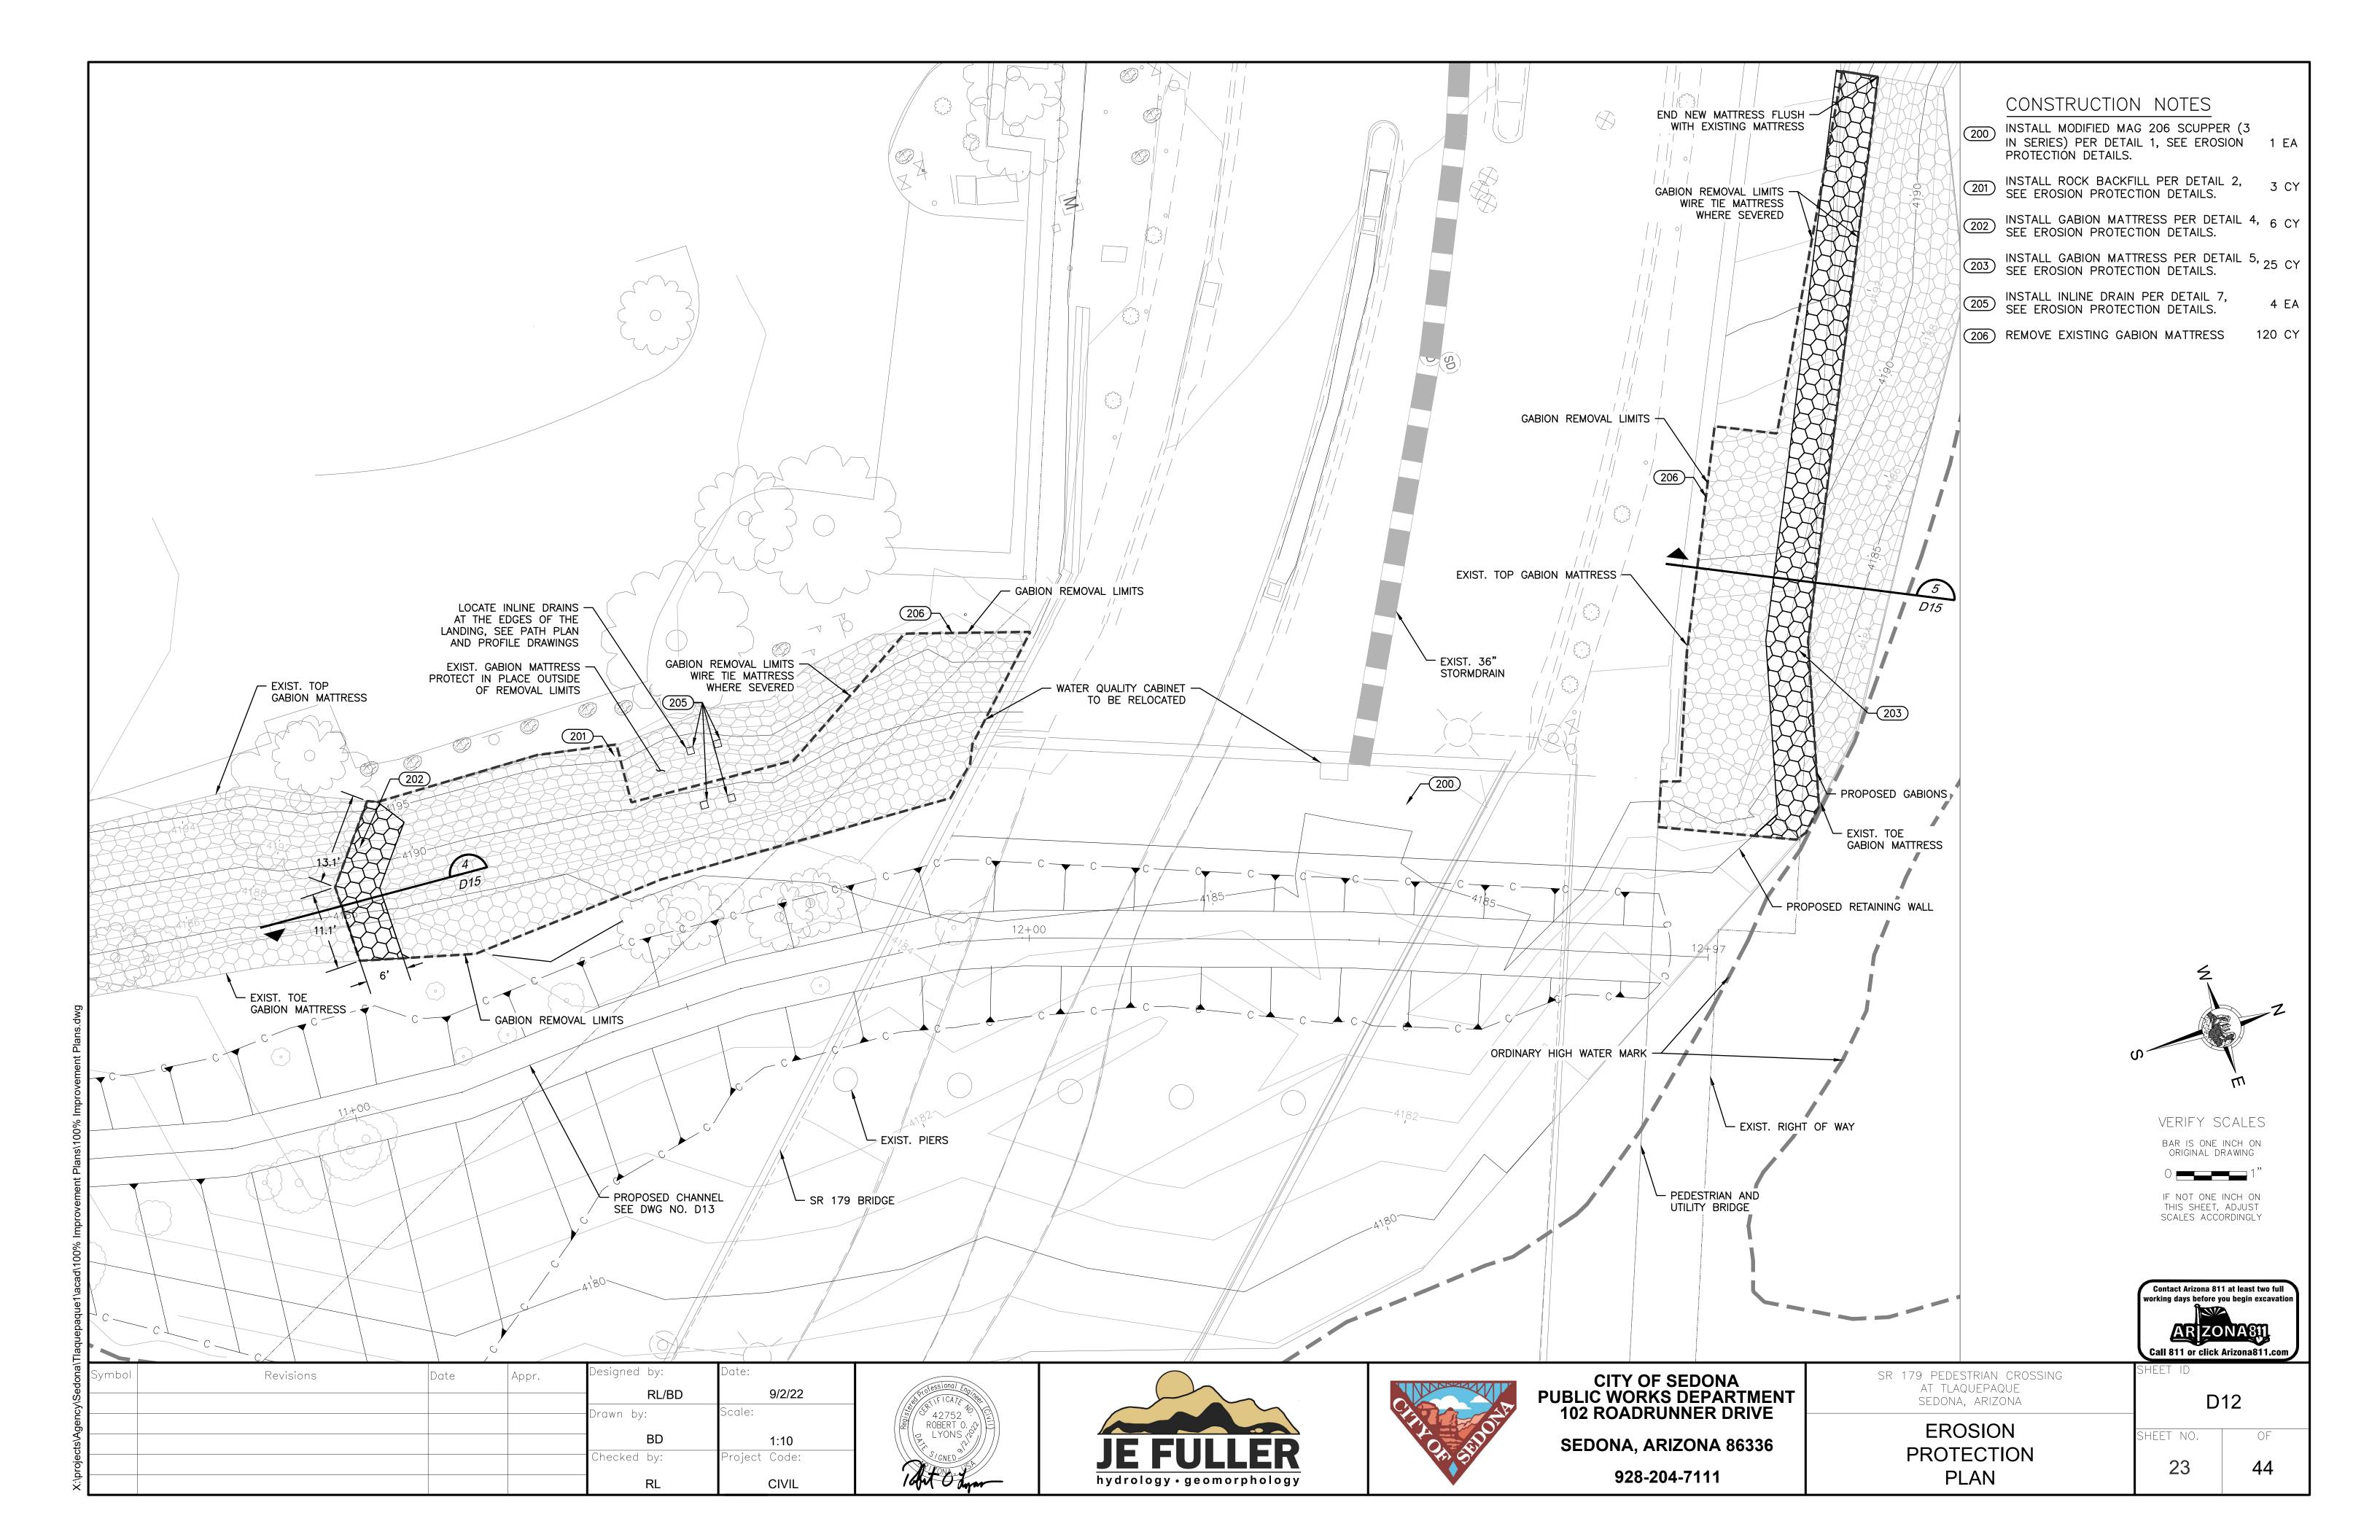


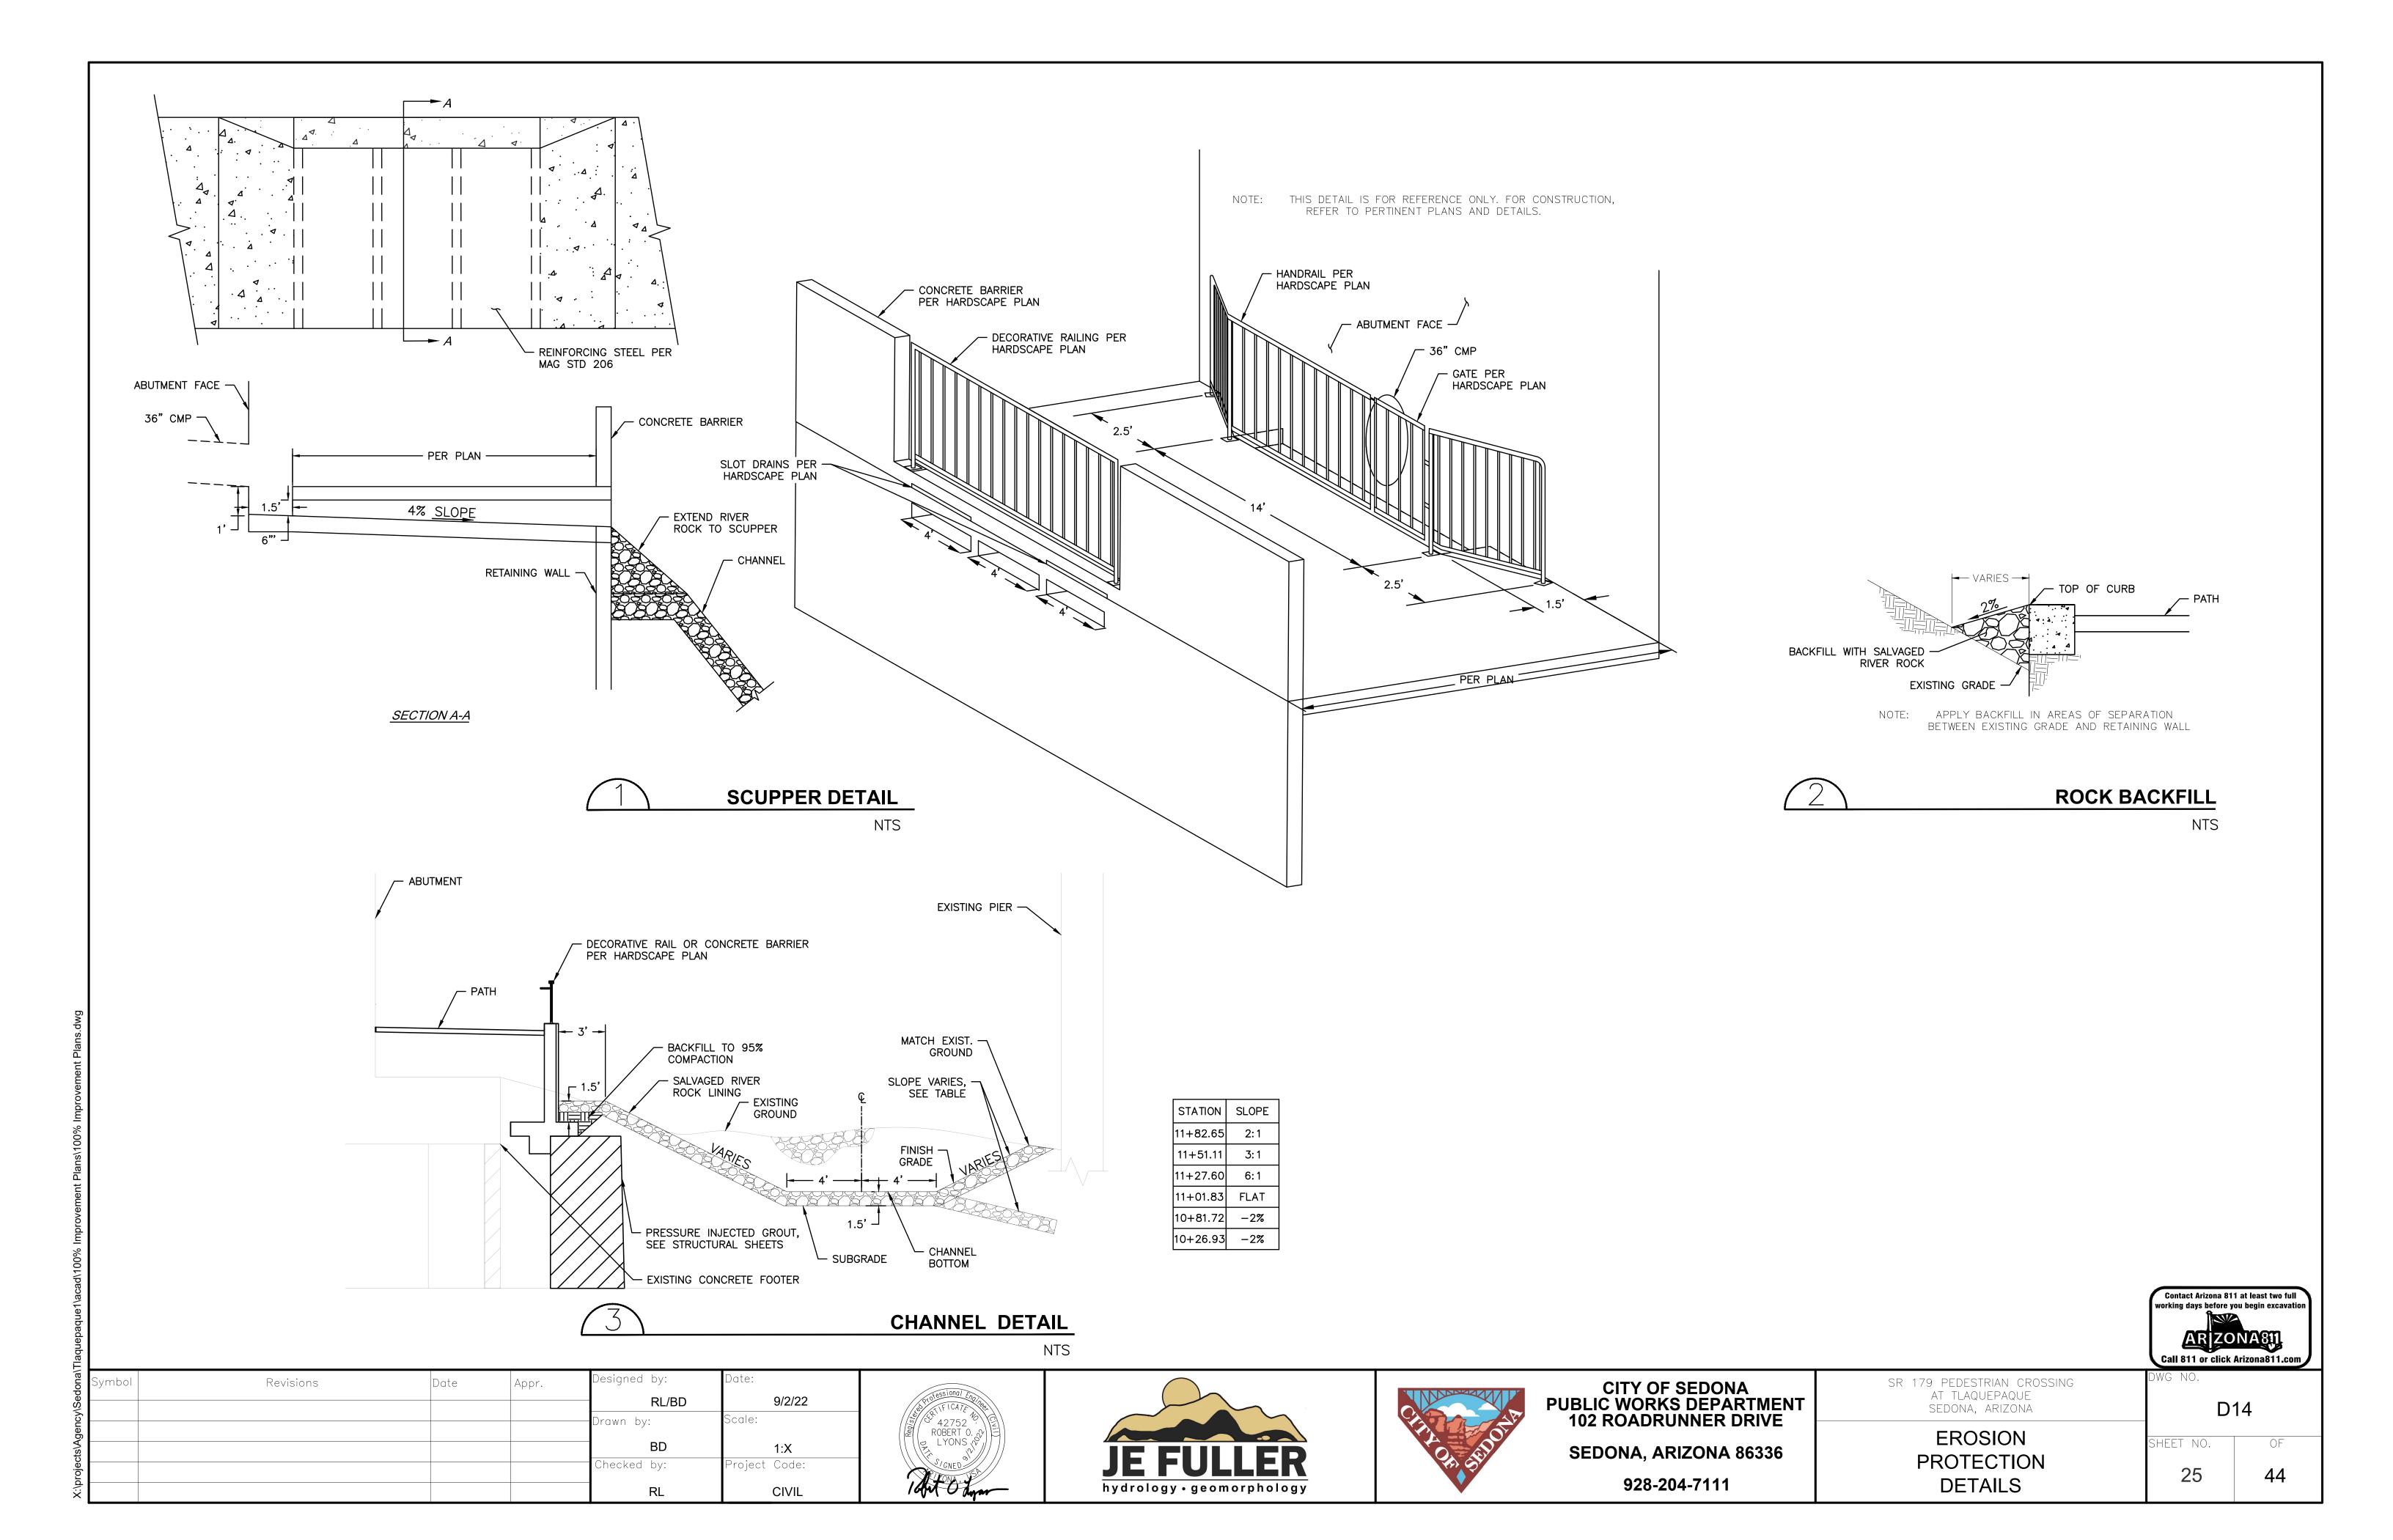



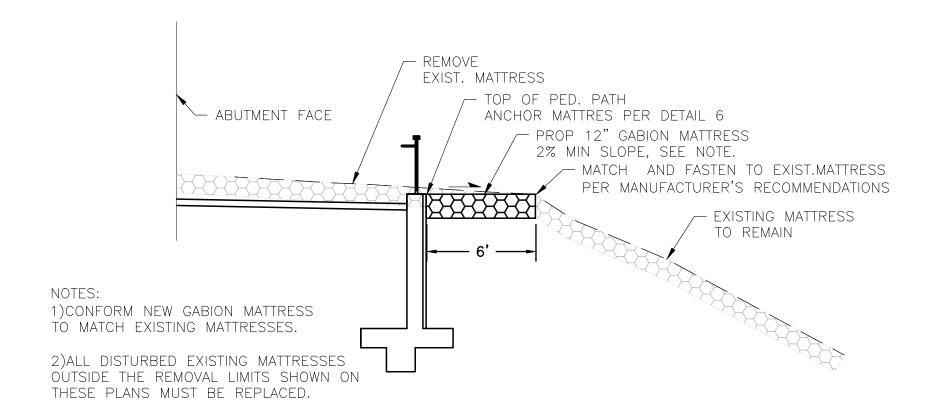




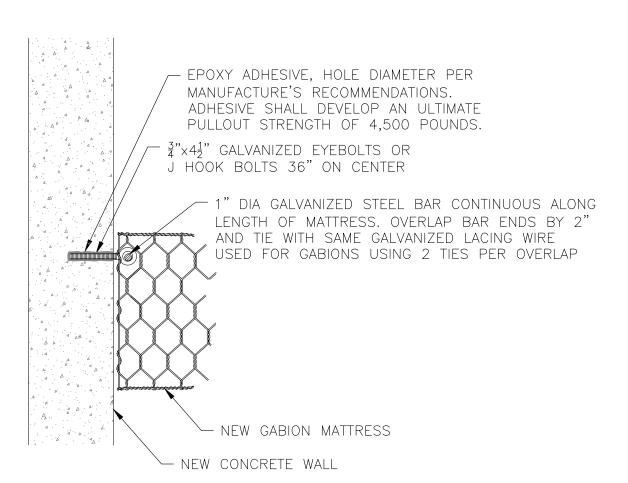

6

MATTRESS ANCHOR TO CONCRETE

NTS

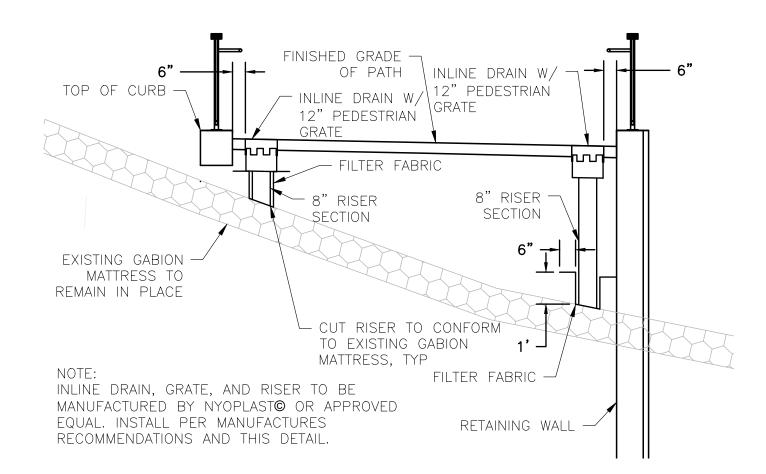






DRAIN INLET

NTS

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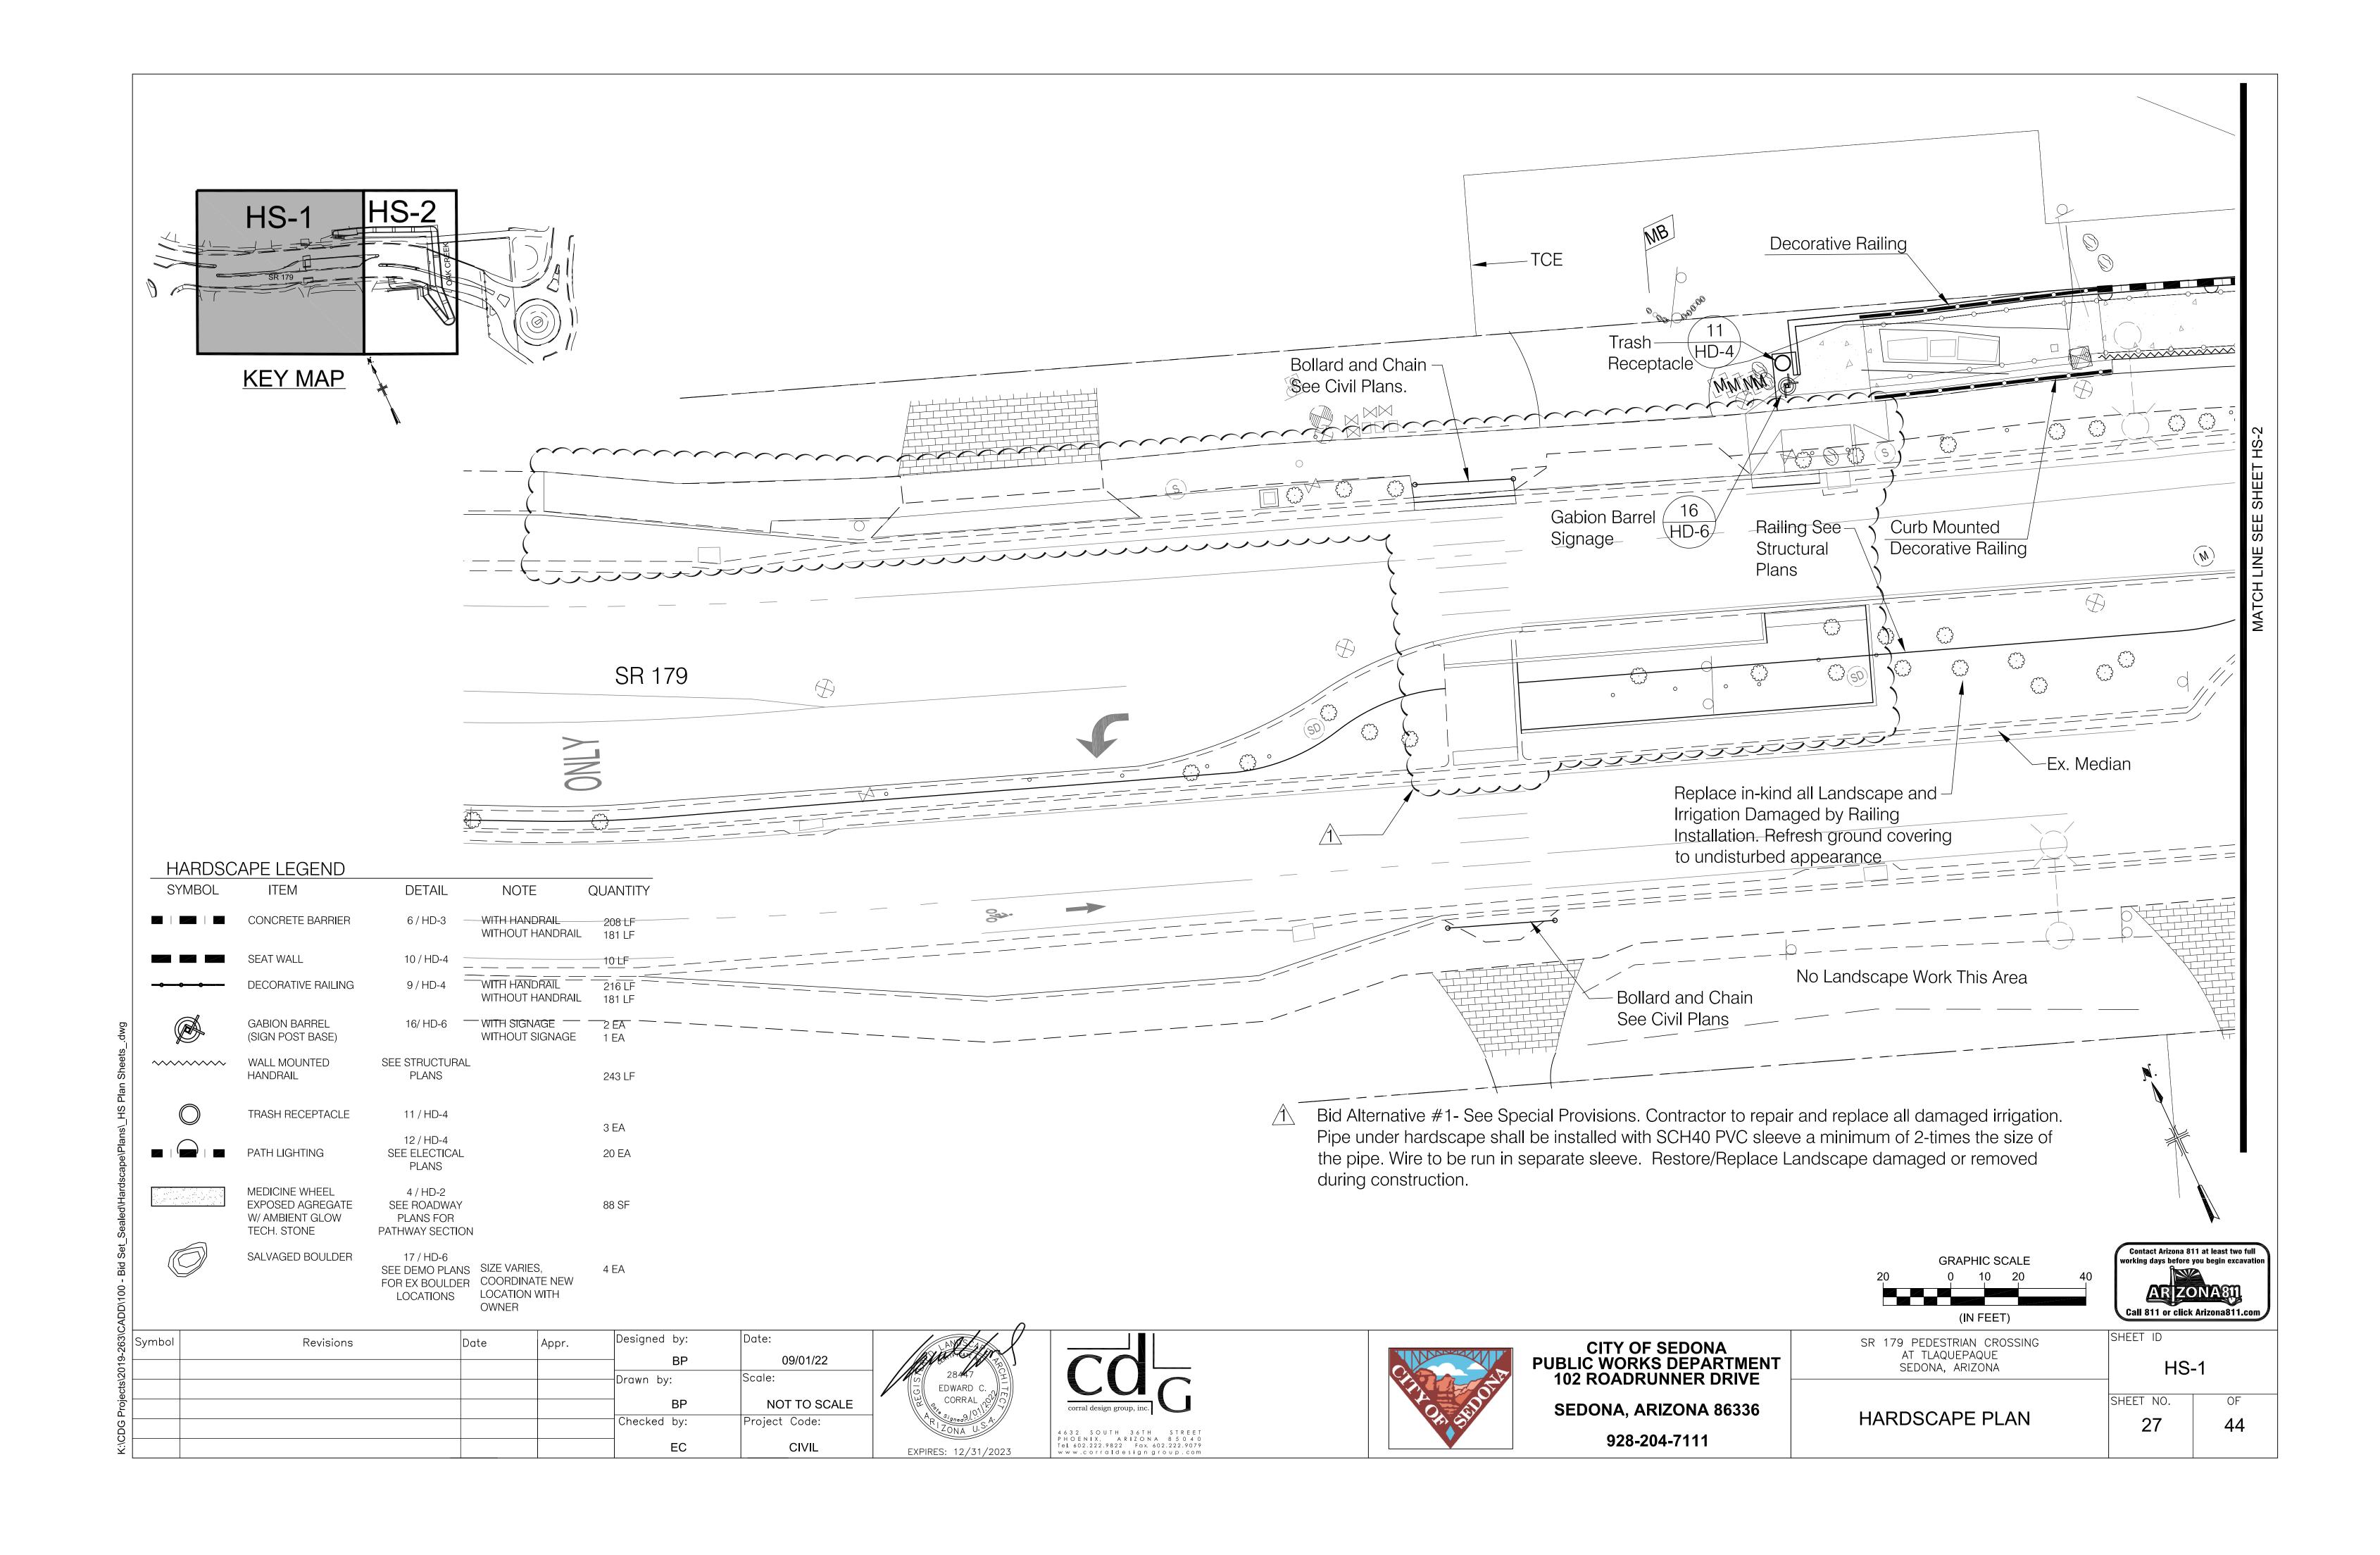


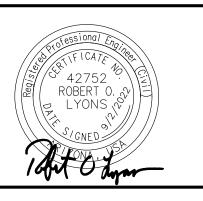
CITY OF SEDONA PUBLIC WORKS DEPARTMENT 102 ROADRUNNER DRIVE	
SEDONA, ARIZONA 86336	
928-204-7111	

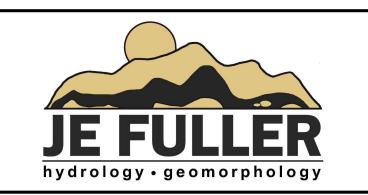
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SR 179 PEDESTRIAN CROSSING AT TLAQUEPAQUE SEDONA, ARIZONA	SHEET ID D	15
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PROTECTION DETAILS	26	44

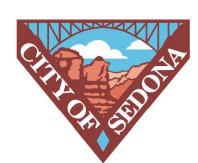Contact Arizona 811 at least two full


ad\100% Improvement Plans\100% Improvement Plans dw




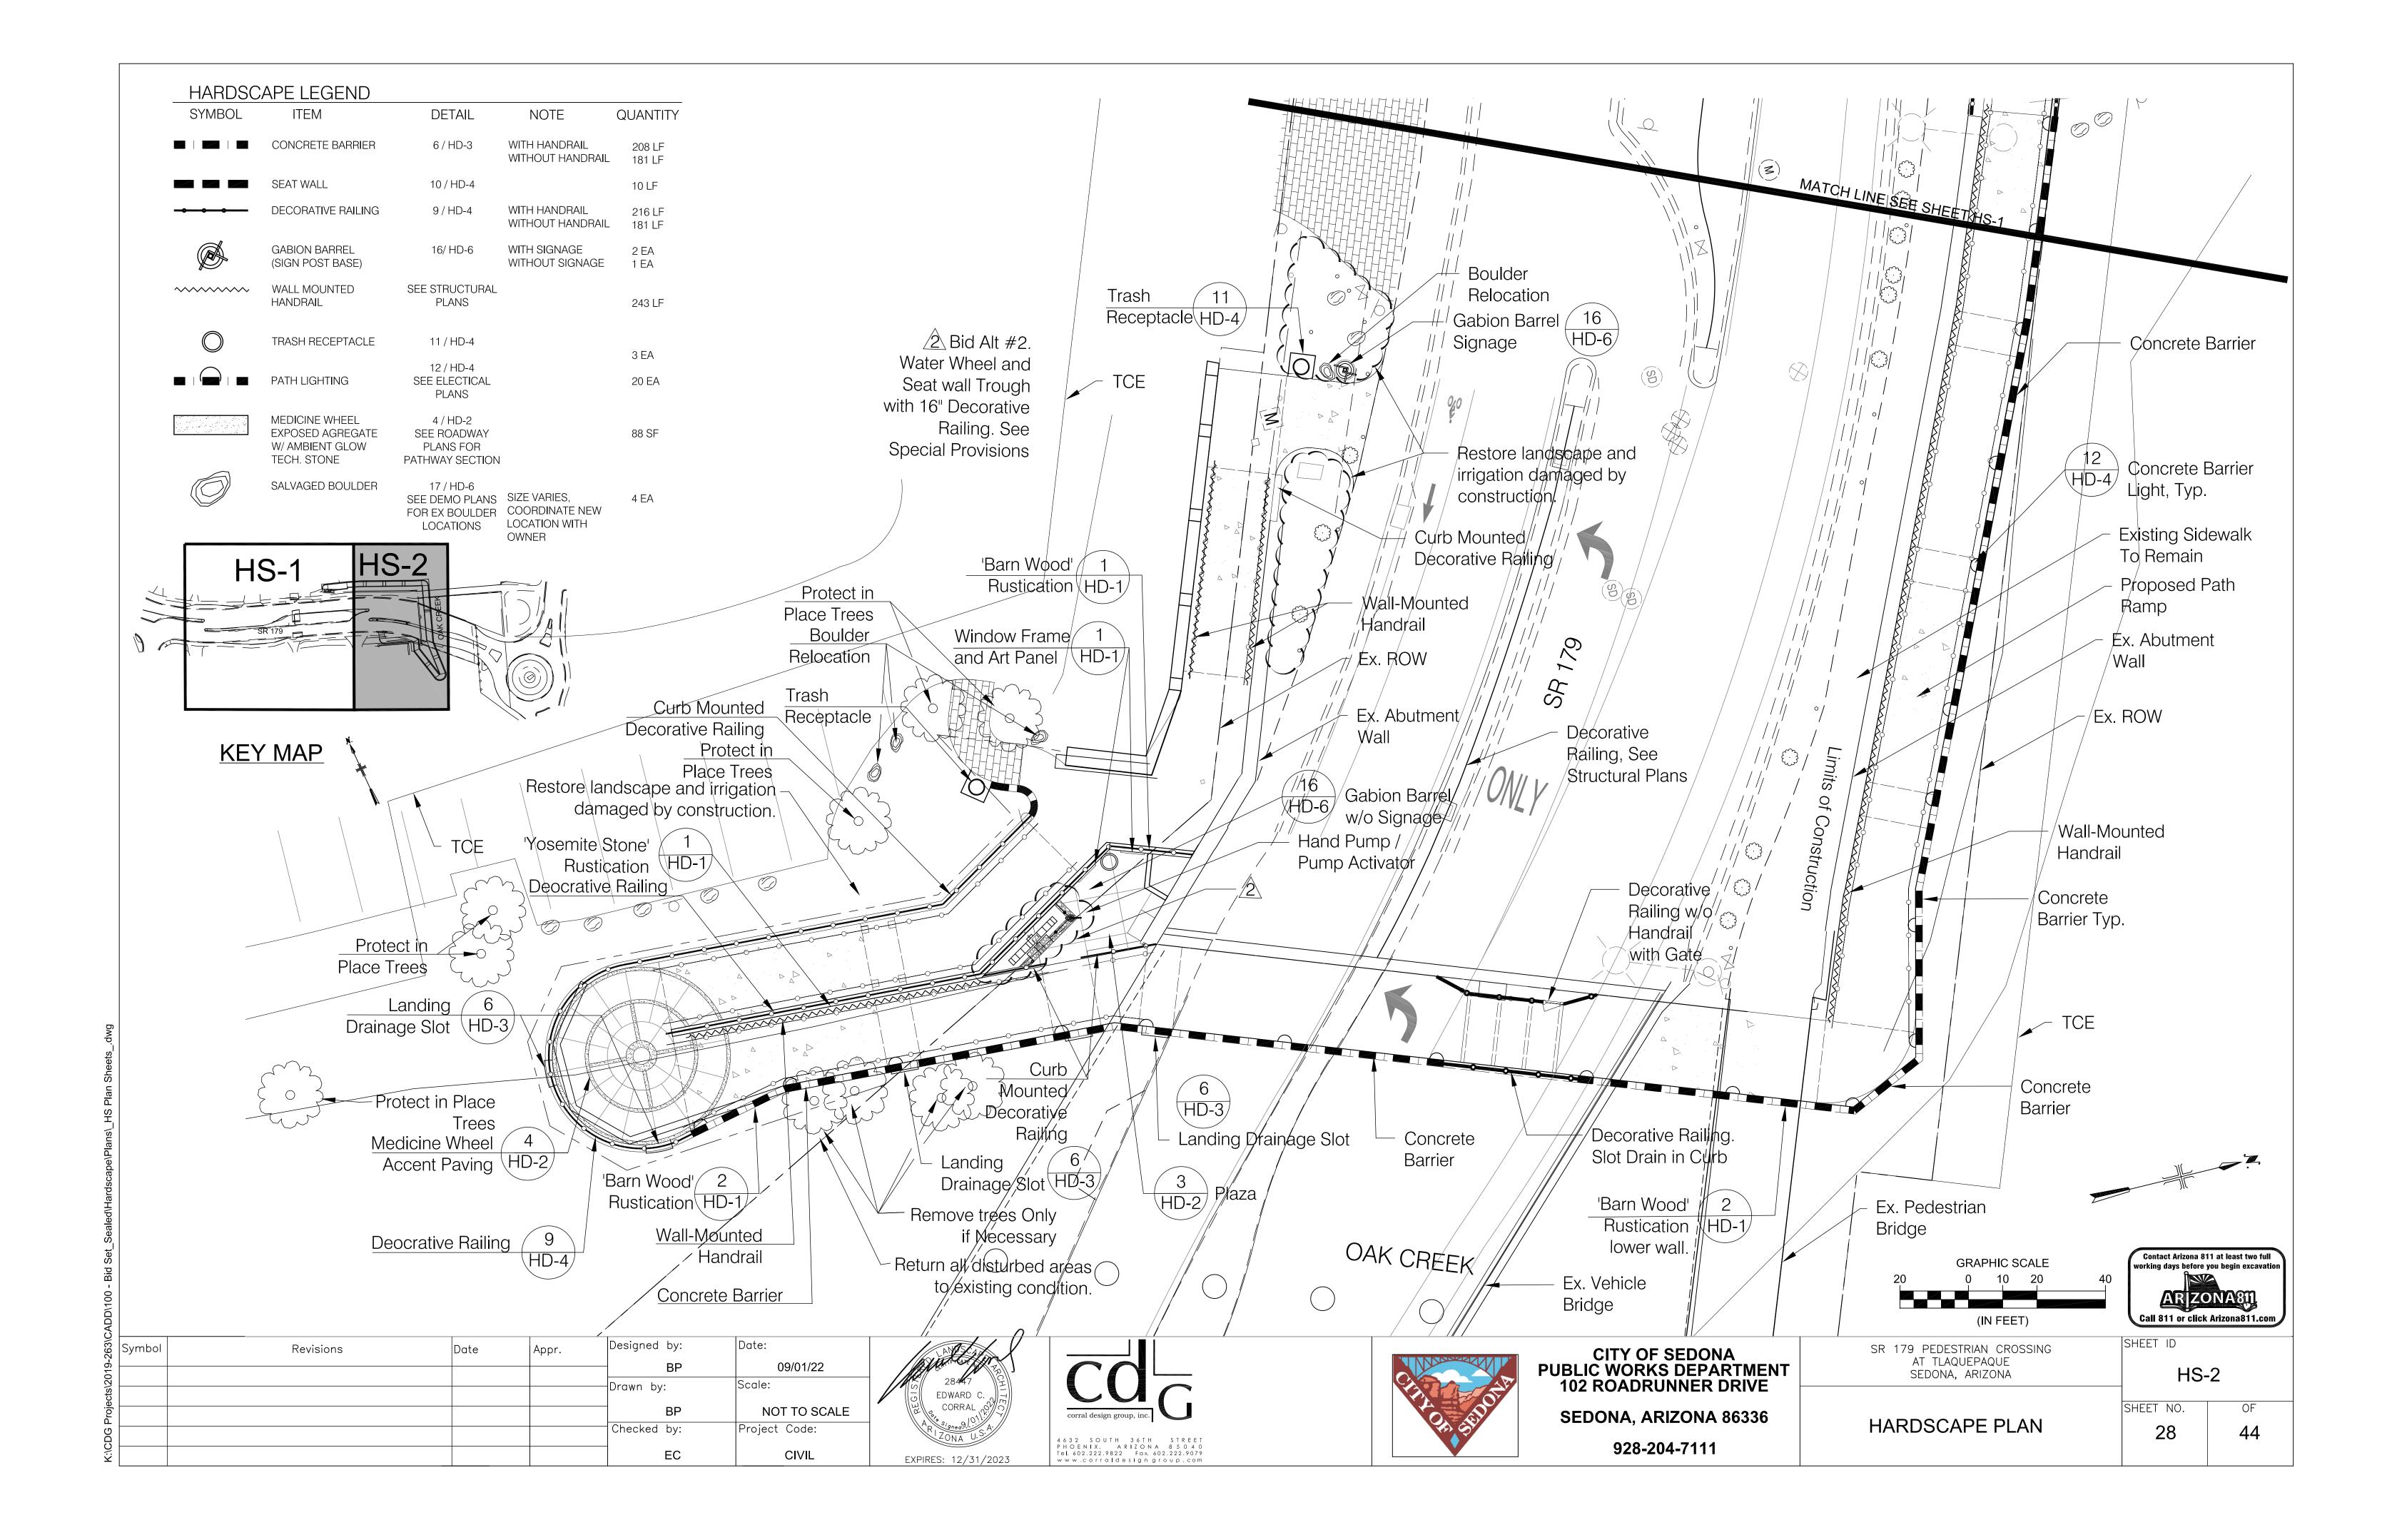


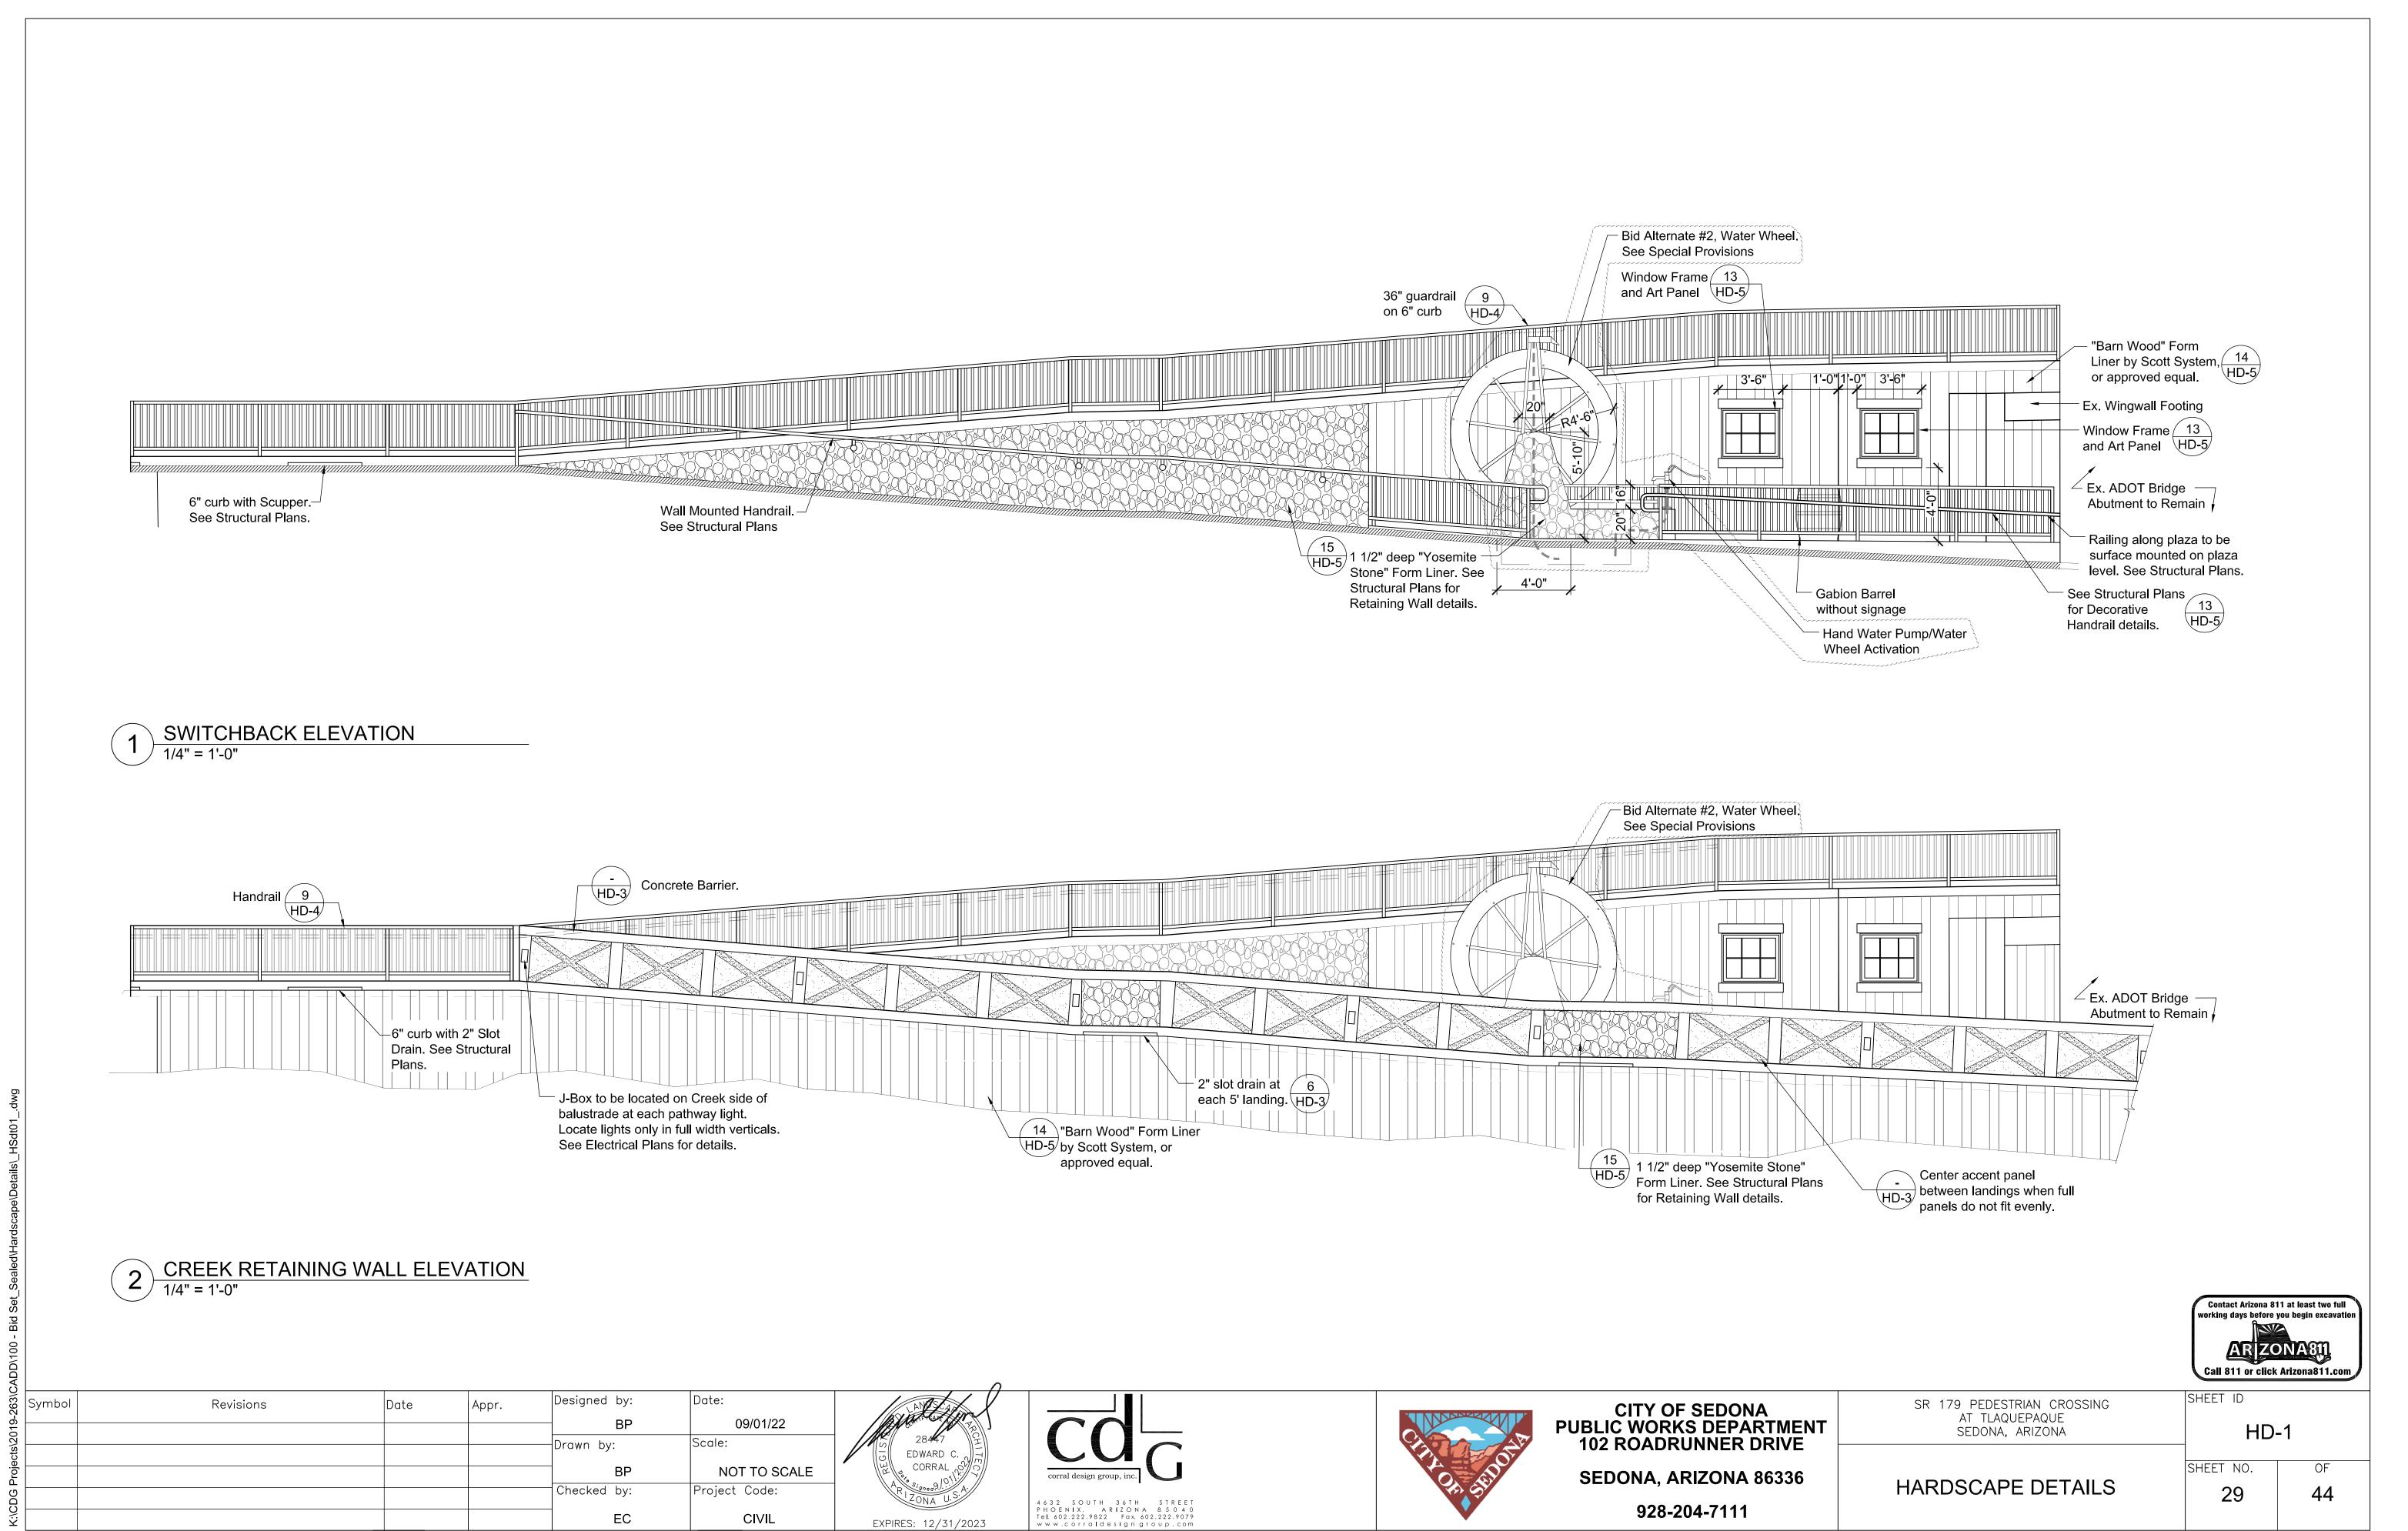

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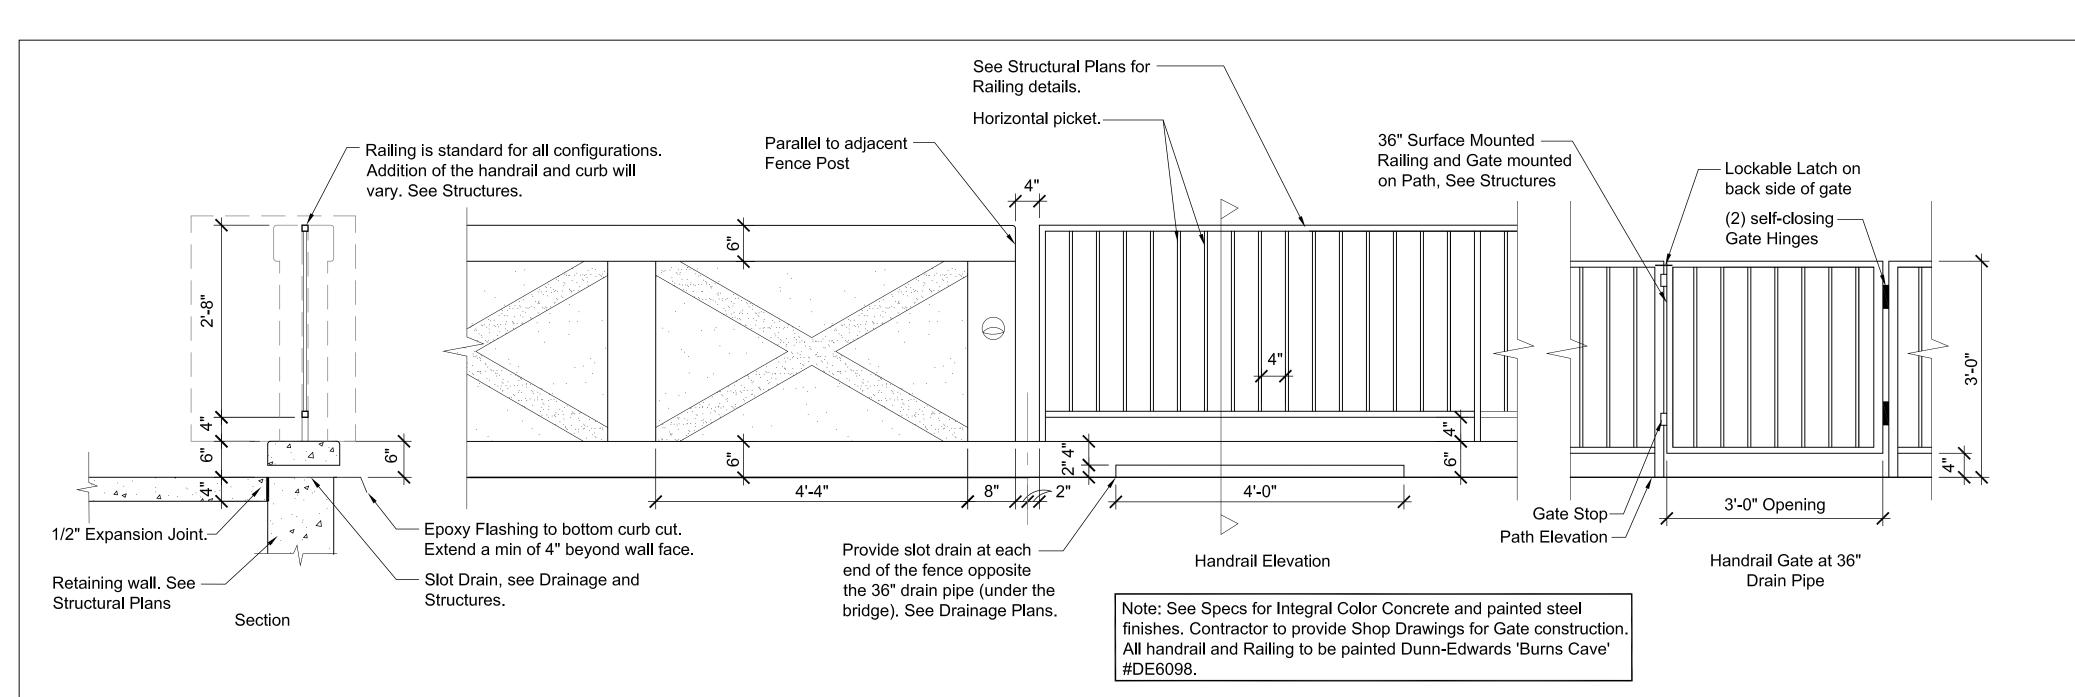
8 CONCRETE BARRIER - PATH SIDE ELEVATION
3/4" = 1'-0"

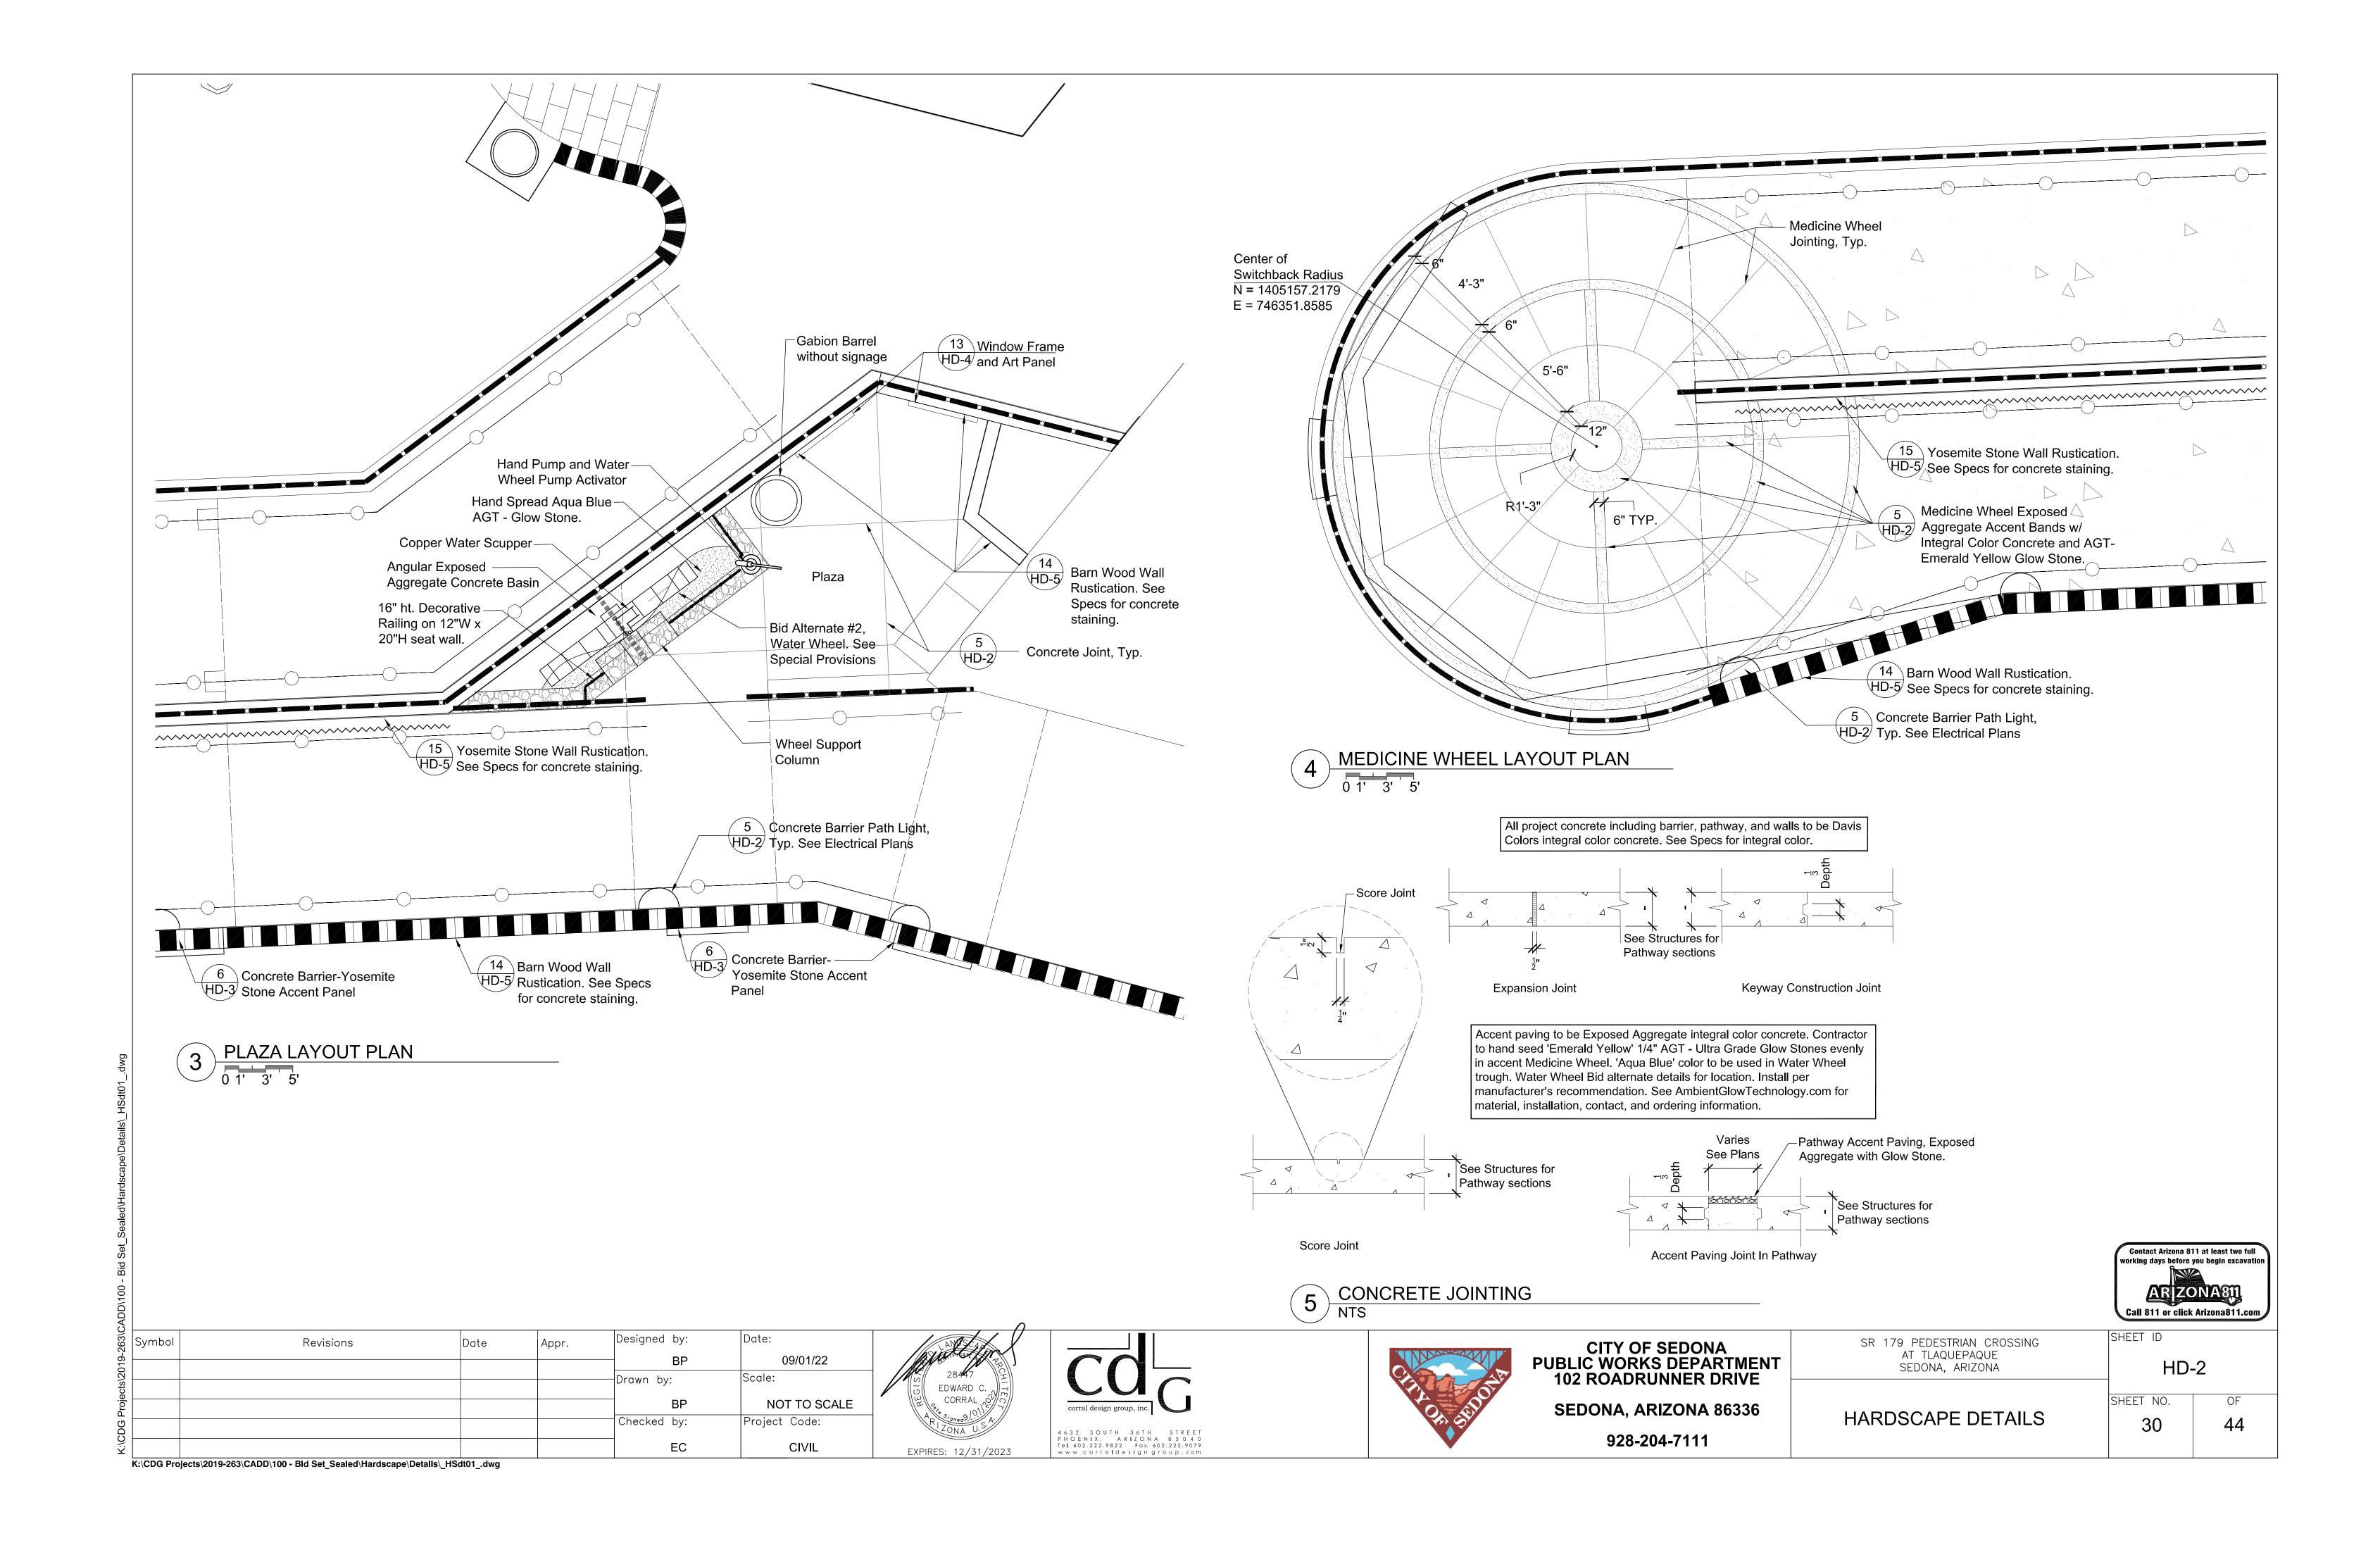
Contact Arizona 811 at least two full working days before you begin excavation

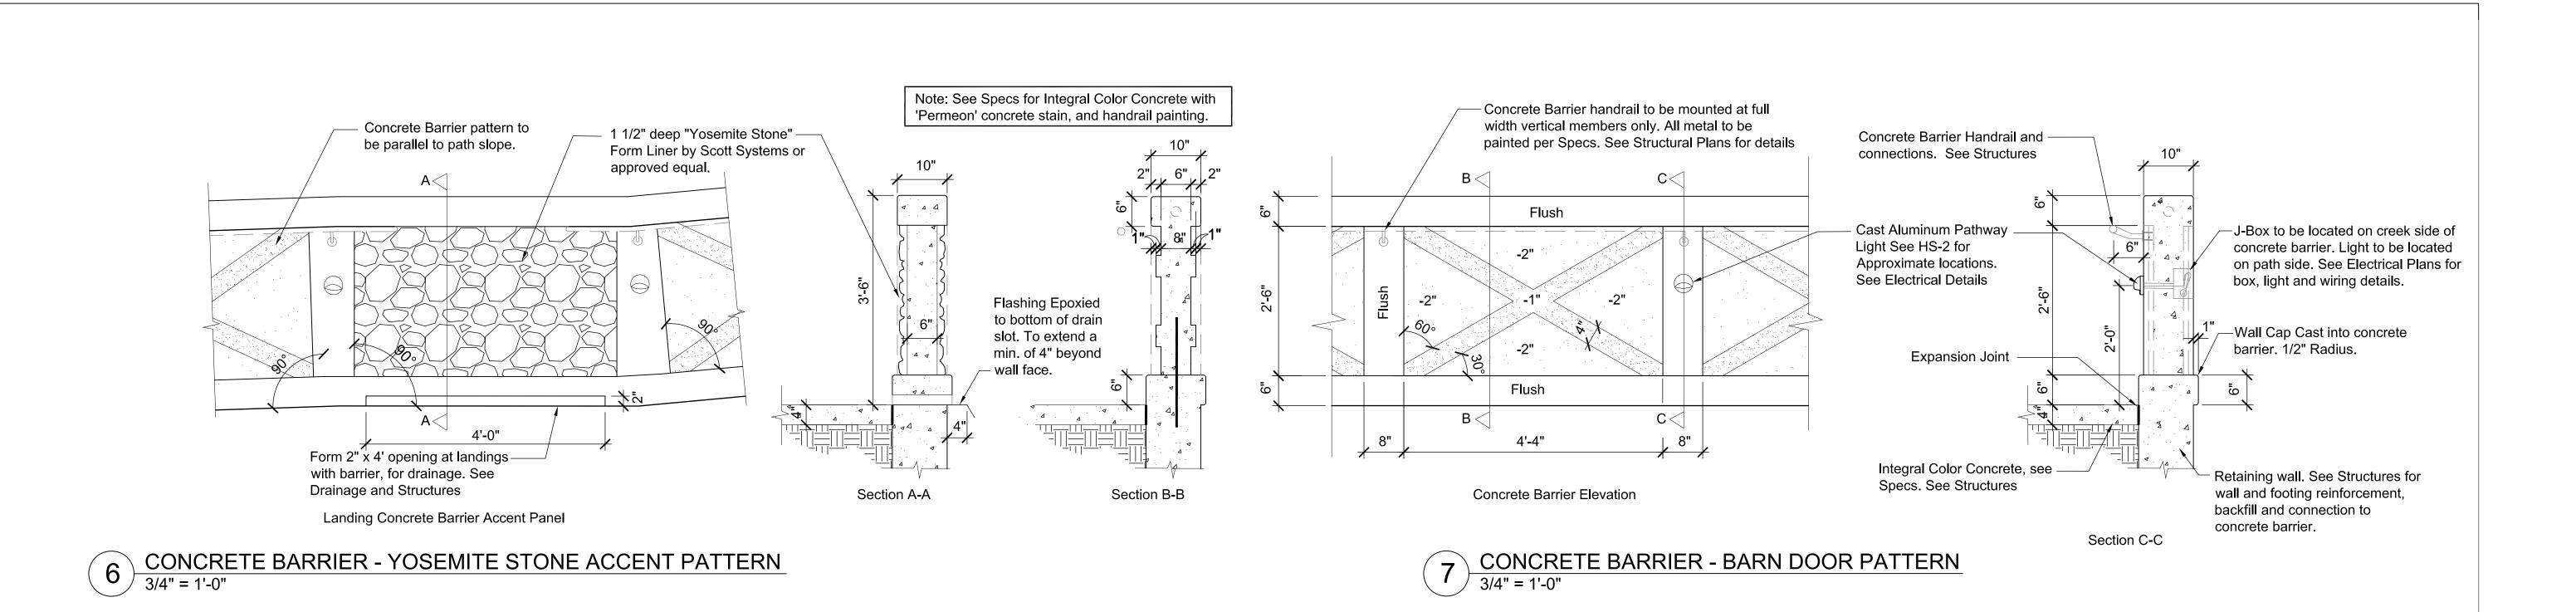ARZONA811.

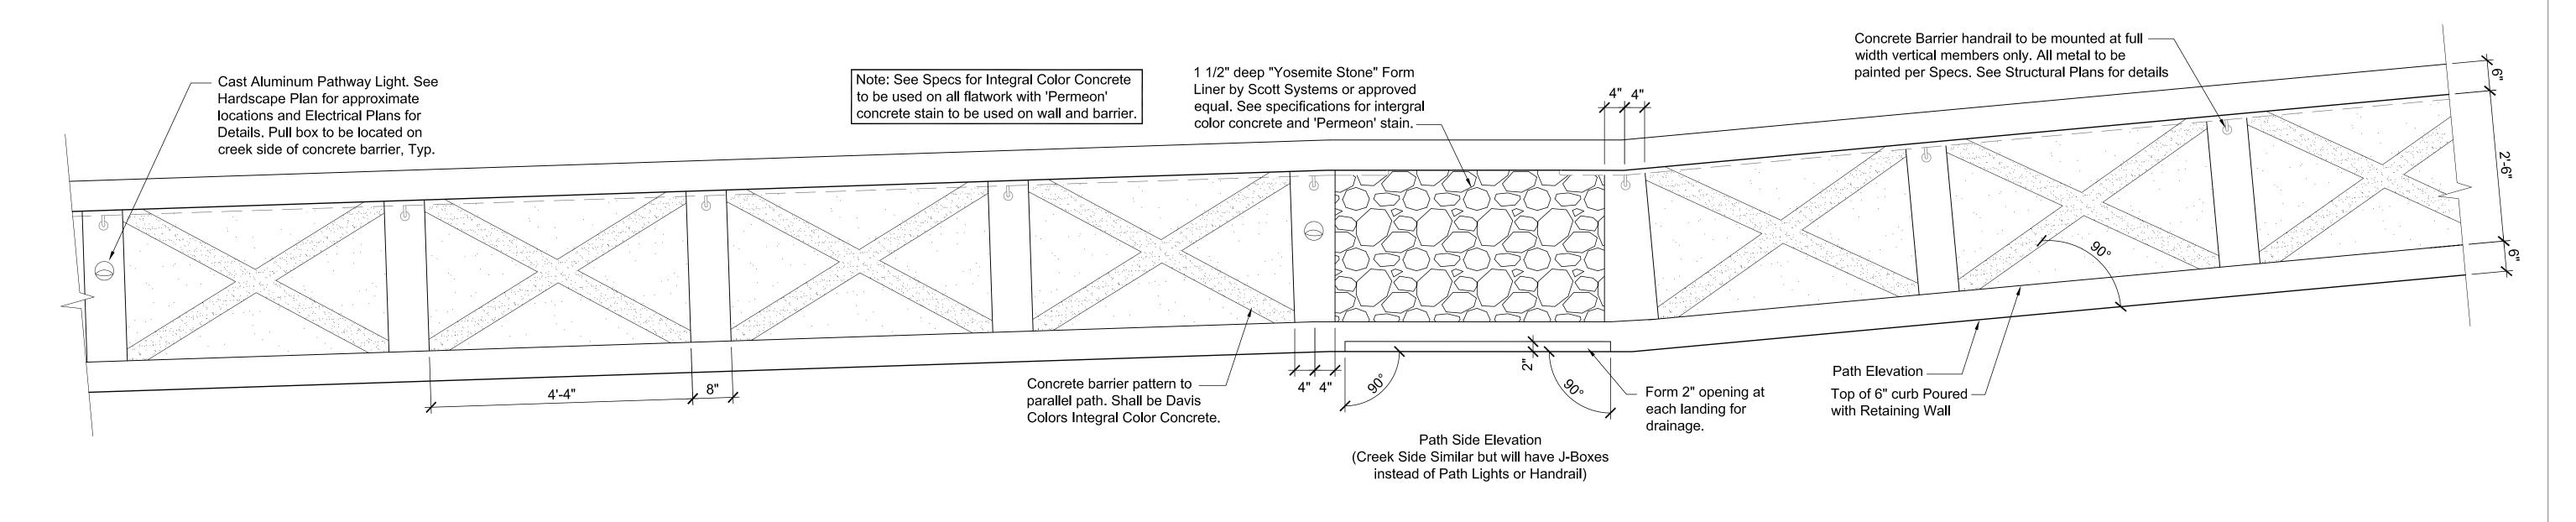Call 811 or click Arizona811.com


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Symbol Symbol	Revisions	Date	Appr.	Designed by: BP	Date: 09/01/22	28447			CITY OF SEDONA PUBLIC WORKS DEPARTMENT 102 ROADRUNNER DRIVE	SR 179 PEDESTRIAN CROSSING AT TLAQUEPAQUE SEDONA, ARIZONA	SHEET ID HD-3	
9 Projects/				Drawn by: BP Checked by:	NOT TO SCALE Project Code:	EDWARD C. CORRAL OF OR ARCON OF ARCON O	corral design group, inc.	OF CENT	SEDONA, ARIZONA 86336	HARDSCAPE DETAILS	SHEET NO.	OF
Ä K ODG B Si sal Sada 200 G	NDD/400 B14 0 - 1 - 1 - 1 - 1 - 1 - 1 - 1 - 1 - 1 -	Data Habitation		EC	CIVIL	EXPIRES: 12/31/2023	4632 SOUTH 36TH STREET PHOENIX, ARIZONA 85040 Tel. 602.222.9822 Fax. 602.222.9079 www.corraldesigngroup.com		928-204-7111		31	<u> </u>
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10 SEAT WALL
NTS

9 HANDRAIL ACROSS FROM DRAIN PIPE AND GATE NTS

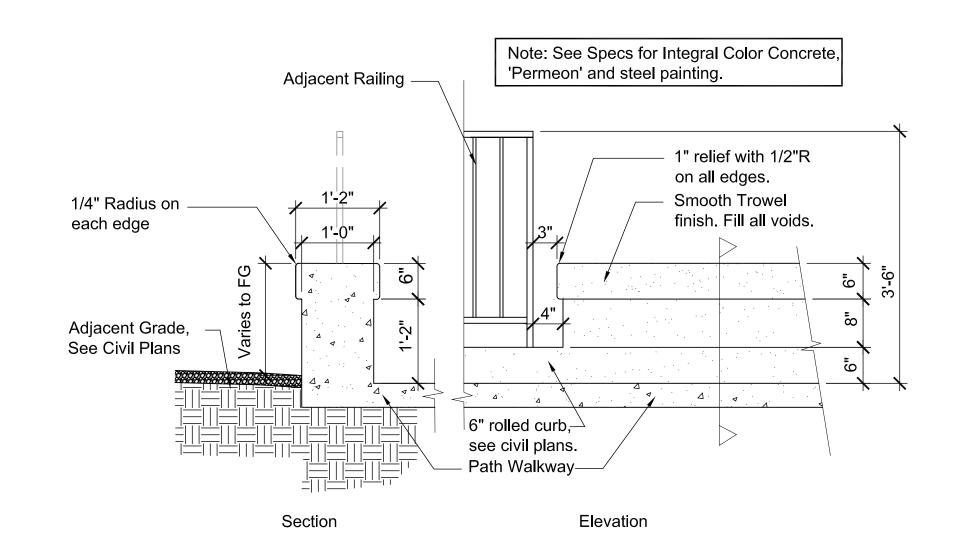



Manufacturer: Focus Industries Model: SL-07 BLT Material: Cast Aluminum Lamp: 18W S8 #1141

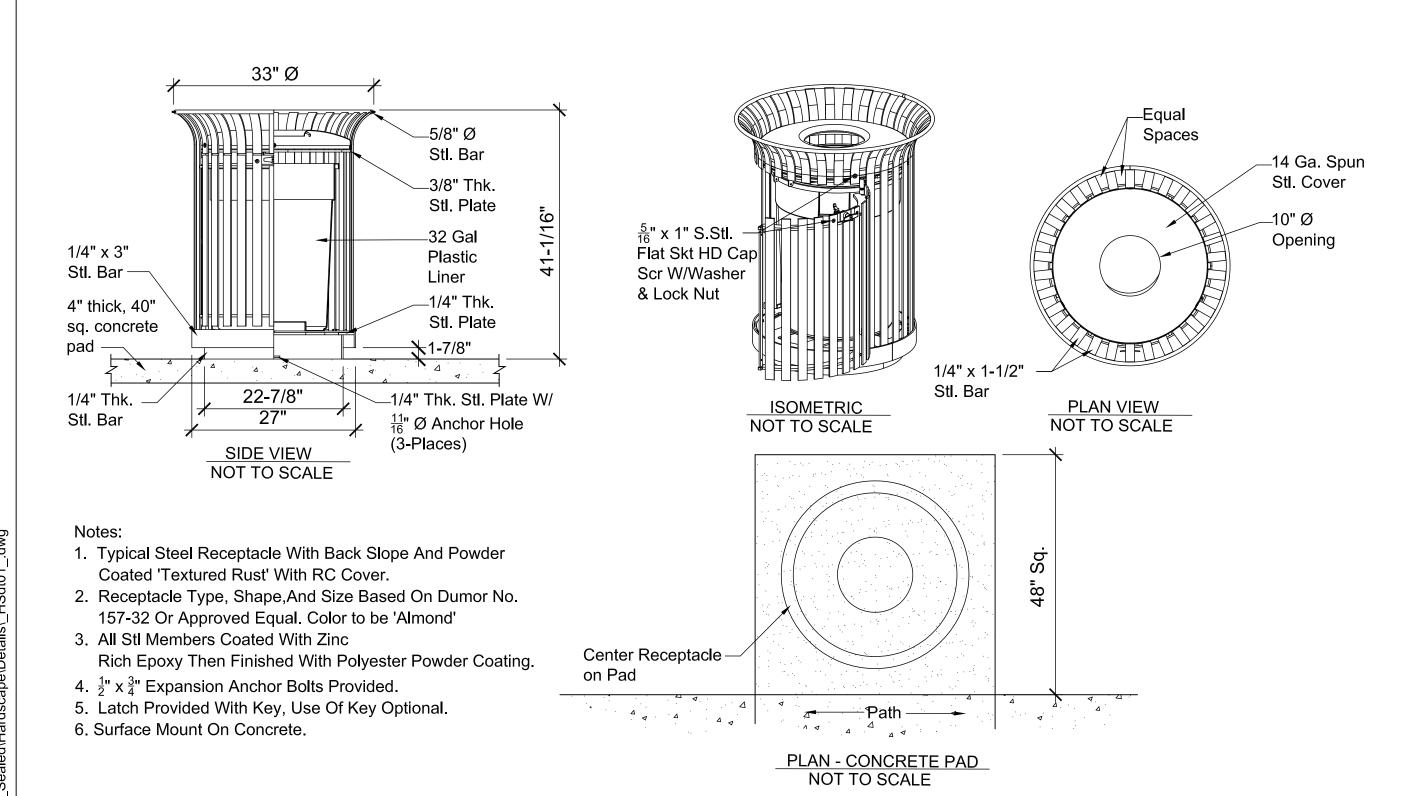See HD-1 for approximate light locations. See Electrical Plans for power, electrical and installation details.

11 TRASH RECEPTACLE


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12 BALUSTRADE LIGHT FIXTURE NTS



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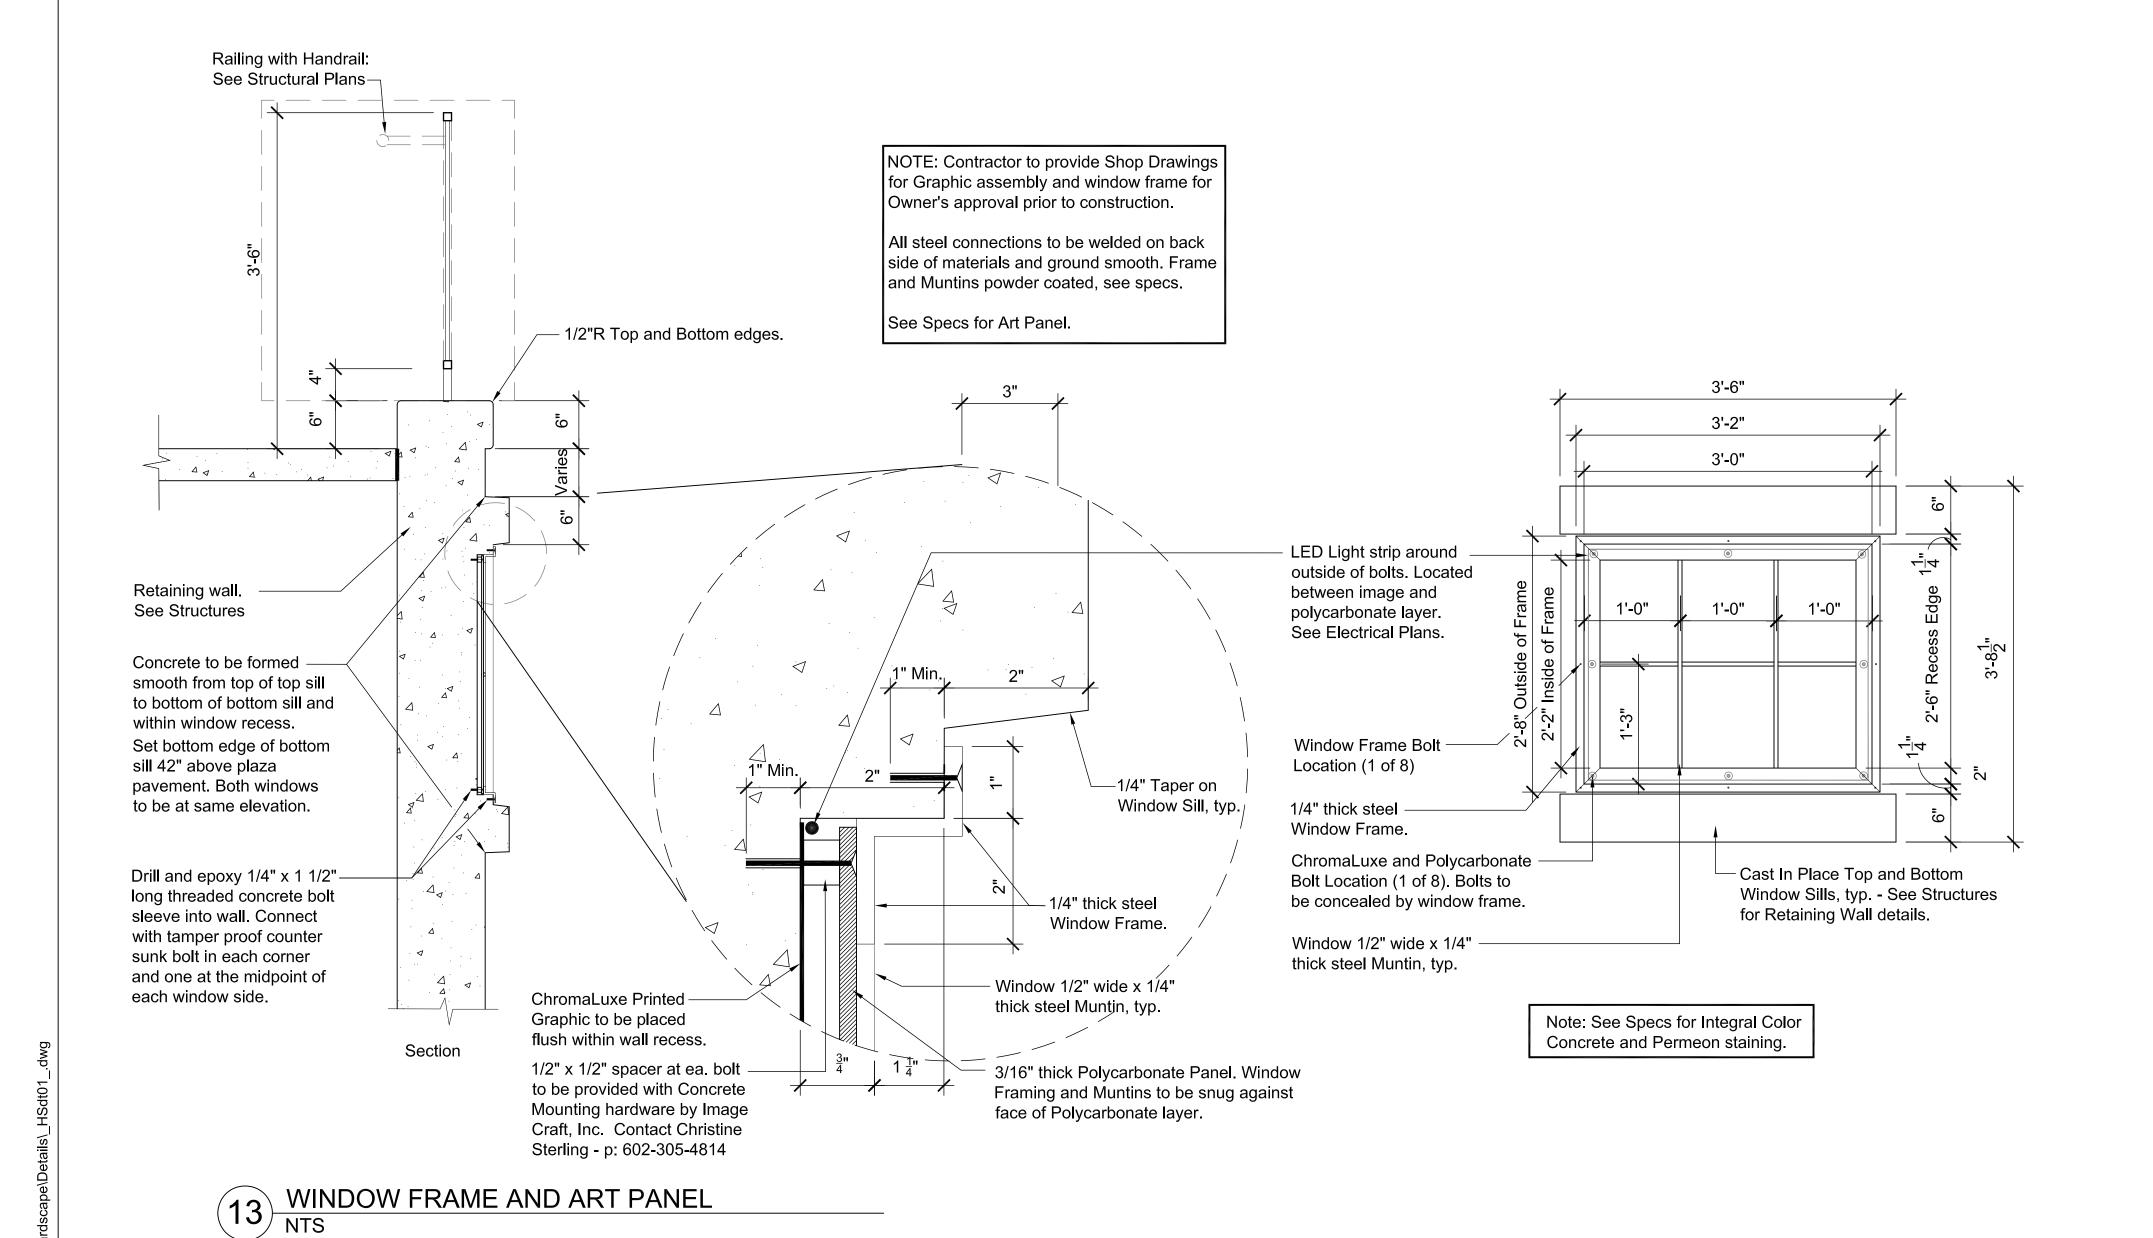




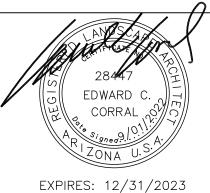

CITY OF SEDONA PUBLIC WORKS DEPARTMENT 102 ROADRUNNER DRIVE	
SEDONA, ARIZONA 86336	
928-204-7111	

SR 179 PEDESTRIAN CROSSING AT TLAQUEPAQUE SEDONA, ARIZONA	SHEET ID HD-	-4
HARDSCAPE DETAILS	SHEET NO.	





Manufacturer: Scott System
Pattern: #116 Barn Wood
Material: Elastomeric Formliner or
Approved Equal

Davis Colors Integral Color Concrete to receive 'Natina' staining. See Specs.

14 BARN WOOD RUSTICATION NTS



Manufacturer: Customrock
Pattern: #2302 Yosemite Stone (1-1/2" Relief)
Material: Elastomeric Formliner or Approved Equal

Davis Colors Integral Color Concrete to receive 'Natina' staining. See Specs.

15 RIVER ROCK RUSTICATION NTS

Contact Arizona 811 at least two full working days before you begin excavation

AR ZONA811

Call 811 or click Arizona811.com

Symbol Revisions Date Appr.


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CITY OF SEDONA
PUBLIC WORKS DEPARTMENT
102 ROADRUNNER DRIVE
SEDONA, ARIZONA 86336
928-204-7111

SR 179 PEDESTRIAN CROSSING AT TLAQUEPAQUE SEDONA, ARIZONA

SHEET ID

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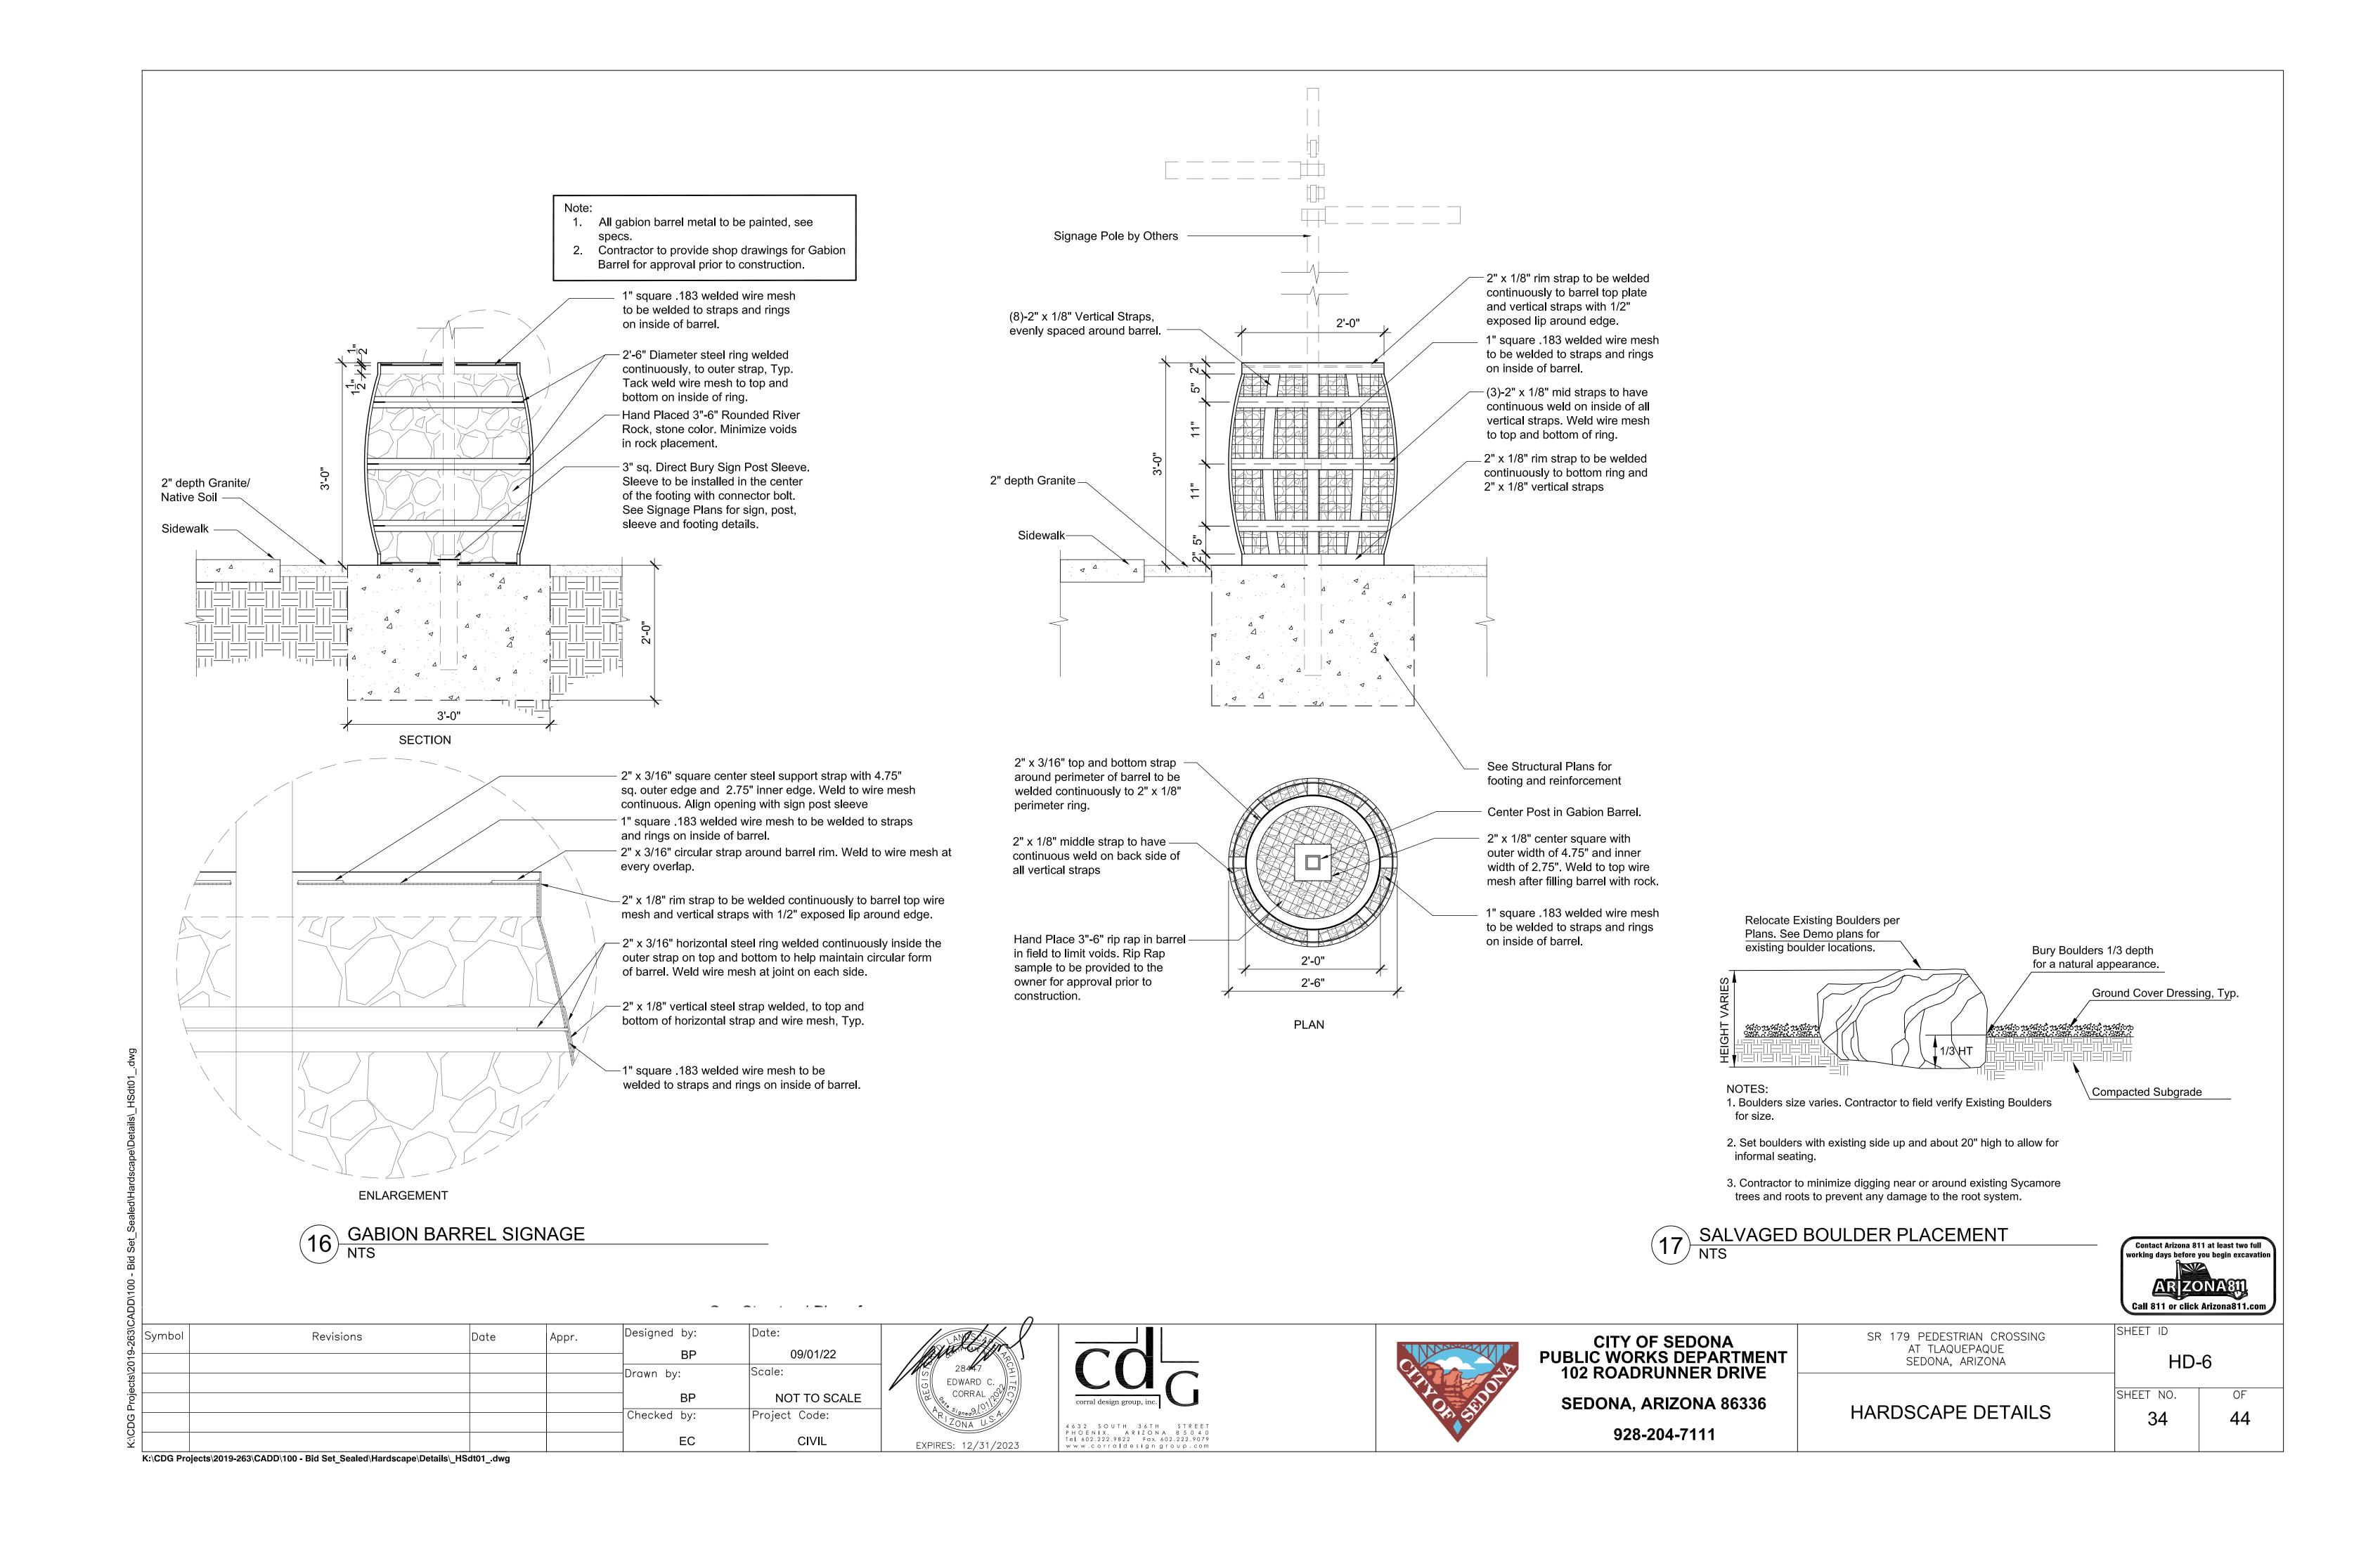
HD-5

HARDSCAPE DETAILS

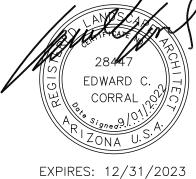SHEET NO. **33**

0F **44**

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GENERAL SIGNING NOTES:

- 1. ALL SIGNS SHALL BE IN COMPLIANCE WITH THE MANUAL ON UNIFORM TRAFFIC CONTROL DEVICES (MUTCD), THE ADOT SIGNING AND MARKING STANDARD DRAWINGS, THE ADOT TRAFFIC ENGINEERING MANUAL OF APPROVED SIGNS, THESE PLANS, AND THE SPECIAL PROVISIONS.
- 2. SIGNING MAY BE MODIFIED AS DIRECTED BY THE ENGINEER. THE ENGINEER MAY SHIFT THE LOCATION OF A SIGN TO A MORE FAVORABLE LOCATION.
- 3. NORMAL OFFSET FOR ALL SIGNS SHALL BE 12 FEET FROM THE NEAR EDGE OF THE SIGN TO THE EDGE OF THE PAVEMENT OR SIDEWALK UNLESS OTHERWISE NOTED ON THE SIGNING SUMMARY SHEET, ON THE PLANS, OR AS DIRECTED BY THE ENGINEER.
- 4. ALL SIGN LOCATIONS AND POST LENGTHS ARE APPROXIMATE. THE CONTRACTOR SHALL VERIFY ACTUAL SIGN LOCATIONS WITH THE ENGINEER PRIOR TO CONSTRUCTING THE FOUNDATIONS FOR THE SIGN SUPPORTS. THE CONTRACTOR SHALL VERIFY ACTUAL POST LENGTHS AFTER FINAL GRADING.
- 5. NORMAL MOUNTING HEIGHT FOR THE BOTTOM OF THE LOWEST SIGN ON THE POST SHALL BE SEVEN FEET ABOVE THE NEAREST ROADWAY EDGE. FOR PATHWAY SIGNS, THE BOTTOM OF THE SIGN SHALL BE AT LEAST 4 FEET ABOVE THE GROUND UNDER THE SIGN.
- 6. THE CONTRACTOR SHALL REMOVE EXISTING SIGNING WHERE INDICATED IN THE SIGN SUMMARY. FOUNDATIONS OF EXISTING SIGNS THAT ARE TO BE REMOVED OR RELOCATED SHALL BE REMOVED A MINIMUM OF 2 FEET BELOW FINISHED GRADE.
- 7. THE CONTRACTOR SHALL INVENTORY ALL SIGNS TO REMAIN OR BE RELOCATED, AND NOTE DAMAGED SIGNS TO THE ENGINEER BEFORE CONSTRUCTION BEGINS. ALL SIGNS SUBSEQUENTLY DAMAGED SHALL BE REPLACED BY THE CONTRACTOR AT NO COST TO THE DEPARTMENT.
- 8. ALL NEW SIGNS SHALL BE INSTALLED ON NEW SQUARE TUBE POSTS WITH FOUNDATIONS AS INDICATED IN ADOT STD DWGS S-1 AND S-3.
- 9. ALL METAL HARDWARE SHALL BE STAINLESS STEEL, GALVANIZED CADMIUM PLATED OR ALUMINUM TO PREVENT RUST.
- 10. ALL SIGNS SHALL BE FABRICATED OF FLAT SHEET ALUMINUM PANELS WITH COPY MEETING THE REQUIREMENTS OF THE SPECIFICATIONS. ALL SIGNS SHALL MEET THE CRITERIA ESTABLISHED FOR SHEETING IN THE SPECIFICATIONS.
- 11. ALL SIGNS IN CONFLICT WITH THE PROJECT CONSTRUCTION SHALL BE REMOVED. ALL SIGN PANELS AND OTHER MATERIAL SHALL BECOME THE PROPERTY OF THE CONTRACTOR.
- 12. QUANTITIES ARE APPROXIMATE AND FOR THE CONTRACTOR'S INFORMATION ONLY.
- 13. ALL DIMENSIONS ARE IN FEET, UNLESS OTHERWISE NOTED.

SIGNING LEGEND:

NEW SIGN (ON POST)

EXISTING SIGN (ON POST)

NEW SIGN PANEL

EXISTING SIGN PANEL TO REMAIN

EXISTING SIGN PANEL TO BE REMOVED

APPROXIMATE SIGNII	NG QUANTITI	ES		
ITEM DESCRIPTION		UNIT	QUANTITY	
REGULATORY, WARNING, MARKER SIGN PANEL	TYPE 9, 11	SQ FT	14	1
PERFORATED SIGN POST	2 S	LF (32	
	2 1/2 S	LF \	30	
PERFORATED SIGN POST FOUNDATION	CONCRETE	EACH	5	
FLAT SHEET ALUMINUM SIGN PANEL		SQ FT((36.6	7
				/
			/2\	

BID ALTERNATIVE #1. SEE SPECIAL PROVISIONS.


BID ALTERNATIVE #2. SEE SPECIAL PROVISIONS.

Symbol	Revisions	Date	Appr.	Designed by:	Date:	
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				CPG	1:20	
				Checked by:	Project Code:	
				SD	TRAFFIC	







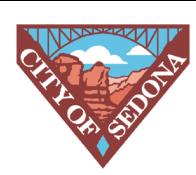

CITY OF SEDONA
PUBLIC WORKS DEPARTMENT
102 ROADRUNNER DRIVE
SEDONA, ARIZONA 86336

928-204-7111

SR 179 PEDESTRIAN CROSSING AT TLAQUEPAQUE SEDONA ARIZONA

SIGNING GENERAL NOTES

T1

SHEET NO. OF

35 46

ATE SAVED: 9/20/22 T:\SEDONA 179\SIGN & PVMRK\SIGNING GENERAL NOTES.DWG

	Number of Lights pp	Overl e Lype	Stringer		Slipbase no un	Ground Posts		ons	Bid Item Number	ft.)	enel (.		Background Color	Mounting Height (ft)				Vork Existing						
Remarks	Number	Structure Type	Total Length (ft)	Туре	New Slip	Total Length (ft)	Туре	Foundations	3id Item	Area (sq. ft.)	Width (in.) Height (in.)	Legend	Sackgrou	Mountin	Offset (ft)	To Remain	Remove	Modify Legend	Relocate Panel	Replace Panel	New	MOAS Sign Code	Sign Number	DWG No.
Nemarks		0,	<u></u>	'			•			`		Pedestrian Traffic		_		X			ш.			W11-2	SB-01	T5
												Diagonal Arrow				Х						W16-7P	+	
												Schnebly Hill Rd				X						D1-3D	SB-02	T5
												Roundabout 15 MPH				X						W2-6 W13-1P	SB-03 +	T5
Barrel Gabion (See						10	2 1/25	1		2.5	30 12	SR179 Underpass	GR	5							X		SB-04	T5
											12 18	Accessible Route	BL								Х		+	
											30 12	SR179 Underpass	GR								X		+	
										1.5	12 18	Accessible Route	BL		+			+			Х		+	
												Pedestrian Traffic Diagonal Arrow				X						W11-2 W16-7P	SB-05 +	T5
												Yield				X						R1-2	SB-06	T5
												Yield				X						R1-2	SB-07	T5
												Pedestrian Traffic				X						W11-2	SB-08	T5
						12	2 1/25	1		6	24 36	200 Feet Stop Here On Red	WH	7	+	X					X	W16-2aP R10-6	+ SB-09	T8
						12	2 1/25				24 36	Stop Here On Red	WH	7							X	R10-6	SB-10	Т8
Mount on Signal F										16	48 48	Pedestrian Traffic	VI	10	+						X	W/11 2	SB-11	то
												Downward Diagonal		10				+				W11-2		T8
Mount Below W1										4	30 18	Left	YL		+			+			Х	W16-7PL	+	
Mount on Signal F										5	24 30	Crosswalk Stop on Red	WH	7							X	R10-23	SB-12	T8
												Pedestrian Traffic Diagonal Arrow				X X						W11-2 W16-7P	NB-01 +	T5
												Pedestrian Traffic				X						W11-2	NB-02	T5
												150 Feet				X						W16-2aP	+	13
												U-Turn Prohibited			+	X						R3-4	NB-03	T5
Barrel Gabion (Se							24/22					CD170 Harden			+								.,	
4)						10	2 1/2S	1		1.5	30 12 12 18	SR179 Underpass Accessible Route	GR BL	5							X		NB-04 +	T5
									1		30 12	1	GR								X		+	
										1.5	12 18	Accessible Route	BL								Х		+	
												Pedestrian Traffic Diagonal Arrow				X						W11-2 W16-7P	NB-05	T5
												Portal Lane				X						D1-1	+ NB-06	T5
	<u></u>																	+						

NOTES:

1. THE ENGINEER SHALL VERIFY POST LENGTHS AND ELEVATIONS.

2. THE ENGINEER MAY SHIFT A SIGN IN ORDER TO ACHIEVE A MORE DESIRABLE LOCATION.

3. QUANTITIES ARE APPROXIMATE AND FOR THE CONTRACTOR'S INFORMATION ONLY.

4. INCREASE FOUNDATION DIAMETER TO 36" TO SUPPORT GABION BARREL. SEE HARDSCAPE PLANS FOR PAINT COLOR AND BARREL DETAILS.

PANEL TYPES: RWM: REGULATORY, WARNING OR MARKER
F-DA: FLAT-SHEET ALUMINUM WITH DIRECT APPLIED OR
SILK-SCREENED CHARACTERS
F-DEM: FLAT-SHEET ALUMINUM WITH DEMOUNTABLE
CHARACTERS

EXT: ALUMINUM EXTRUSIONS

RD = RED BK = BLACK BL = BLUE GR = GREEN YL = FLUORESCENT YELLOW WH = WHITE

BACKGROUND COLORS:

POST TYPES:
2S-2" SINGLE
2T-2" TELESCOPING
2 1/2S-2½" SINGLE
2 1/2T-2½" TELESCOPING

BID ALTERNATIVE #1. SEE SPECIAL PROVISIONS.

COLO	R AND BARREL DETAILS.				
Symbol	Revisions	Date	Appr.	Designed by:	Date:
				НАО	08/31/22
				Drawn by:	Scale:
				CPG	1:20
				Checked by:	Project Code:
				SD	TRAFFIC







CITY OF SEDONA
PUBLIC WORKS DEPARTMENT
102 ROADRUNNER DRIVE SEDONA, ARIZONA 86336 928-204-7111

SR 179 PEDESTRIAN CROSSING AT TLAQUEPAQUE SEDONA ARIZONA	SHEET ID T2	
SIGN SUMMARY SHEET	SHEET NO.	

T:\SEDONA 179\SIGN & PVMRK\SIGN SUMMARY SHEET 1.DWG

					,	Work							P	Panel			1		(Ground N	/lounted	l		Overhead		
				lət		Exist	ting			_	Height (ft)	d Color				(i)	umber	SI	Pos		Se	Str	inger	e Type		
DWG No.	Sign Number	MOAS Sign Code	New	Replace Panel	Relocate Panel	Modify	Remove	0000	To Remain	Offset (ft)	Mounting Height (ft)	Background	Legend	Width (in.)	Height (in.)	Area (sq. ft.)	Bid Item Number	Foundations	Туре	Total Length (ft)	New Slipbase	Type	Total Length (ft)	Structure T	Remarks	
T5	NB-07	D1-1e							Х				SR 179 North													
T5	NB-08	D1-1							Х				Ranger Rd													
Т8	NB-09	R10-6	X								7	WH	Stop Here On Red	24	36	6		1	2 1/25	12						
18	ND-03	K10-0	^								,	VVII	Stop Here Office	24	30	0		1	2 1/23	12						
Т8	NB-10	W11-2	Х								10	YL	Pedestrian Traffic	48	48	16									Mount on Signal Pole	
Т8	+	W16-7PL	х									YL	Downward Diagonal Left	30	18	4									Mount Below W11-2	
Т8	NB-11	R10-23	X								7	WH	Crosswalk Stop on Red	24	30	5									Mount on Signal Pole	
T5	C-01		X									WH	Use SR179 Underpass	36	24	6.0									Hang On Chain Between	
13												VVII	Ose skir/s omderpuss	30	24	0.0									Bollards	
T5	C-02		X									WH	Use SR179 Underpass	36	24	6.0									Hang On Chain Between Bollards	
T5	C-03								Х				No Left Turn													
T5	C-04		X								7	GR	SR179 Underpass	30	12	2.5		1	2S	10						
T5	C-05		Х									WH	Path Closed	30	18	3.8									On Barricades During Flooding	
T5	C-06		X									WH	Path Closed	30	18	3.8									On Barricades During Flooding	
T5	C-07		Х									RD	Danger	23	10	1.6									Mount On Decorative Handrail	
T5	C-08		Х									RD	Danger	23	10	1.6									Mount On Seat Wall Trough	
T5 \	C-09		Х									RD	Caution	18	11	1.4									Mount On Seat Wall Trough	
T5	C-10		X									WH	No Motor Vehicles	24	24	4.0		1	2S	11						
T5	C-11		Х									WH	No Motor Vehicles	24	24	4.0		1	2S	11						

1. THE ENGINEER SHALL VERIFY POST LENGTHS AND

ELEVATIONS. 2. THE ENGINEER MAY SHIFT A SIGN IN ORDER TO ACHIEVE A MORE DESIREABLE LOCATION.

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RWM:REGULATORY, WARNING OR MARKER F-DA: FLAT-SHEET ALUMINUM WITH DIRECT APPLIED OR SILK-SCREENED CHARACTERS
F-DEM: FLAT-SHEET ALUMINUM WITH DEMOUNTABLE CHARACTERS

EXT: ALUMINUM EXTRUSIONS

BACKGROUND COLORS: RD = RED BK = BLACK BL = BLUE GR = GREEN YL = FLUORESCENT YELLOW WH = WHITE POST TYPES:
2S-2" SINGLE
2T-2" TELESCOPING
2 1/2S-2½" SINGLE
2 1/2T-2½" TELESCOPING

BID ALTERNATIVE #1. SEE SPECIAL PROVISIONS. BID ALTERNATIVE #2. SEE SPECIAL PROVISIONS.

Symbol	Revisions	Date	Appr.	Designed by:	Date:	
				HAO	08/31/22	
				Drawn by:	Scale:	
				CPG	1:20	
				Checked by:	Project Code:	
				SD	TRAFFIC	








CITY OF SEDONA PUBLIC WORKS DEPARTMENT 102 ROADRUNNER DRIVE
SEDONA, ARIZONA 86336
928-204-7111


SR 179 PEDESTRIAN CROSSING	SHEET ID	
AT TLAQUEPAQUE SEDONA ARIZONA	Т3	
	SHEET NO.	Of
SIGN SUMMARY SHEET	37	46

DATE SAVED: 9/20/22 T:\SEDONA 179\SIGN & PVMRK\SIGN SUMMARY SHEET 2.DWG

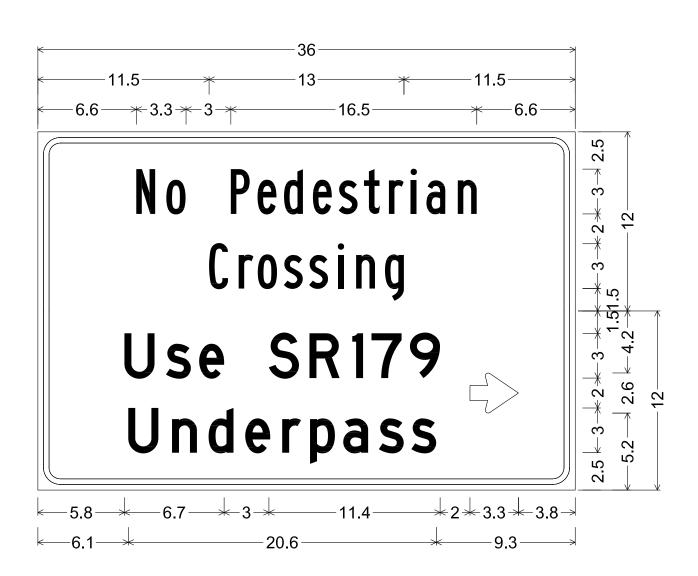


1.5" Radius, 0.4" Border, 0.4" Indent, Black on, White; "No Pedestrian", B; "Crossing", B;

1.5" Radius, 0.4" Border, 0.4" Indent, Black on, White; "Use SR179", D; "Underpass", D; Arrow 2" Type D1 - 0';

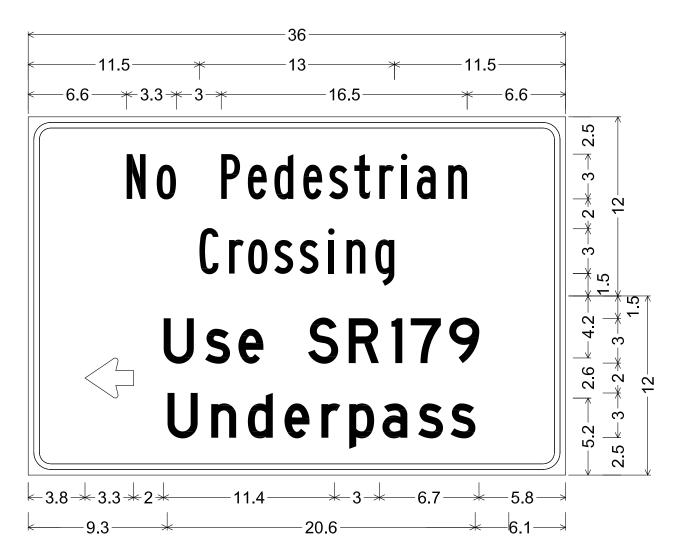


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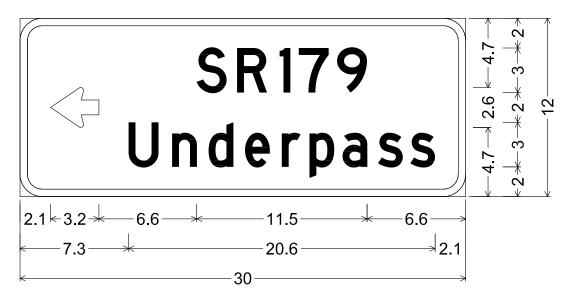
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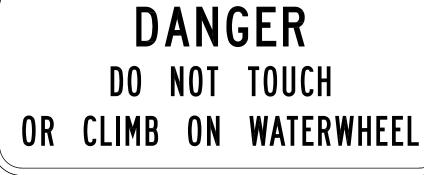
2.3" Radius, 0.9" Border, 0.6" Indent, Black on, White; "PATH", D: "CLOSED", D:

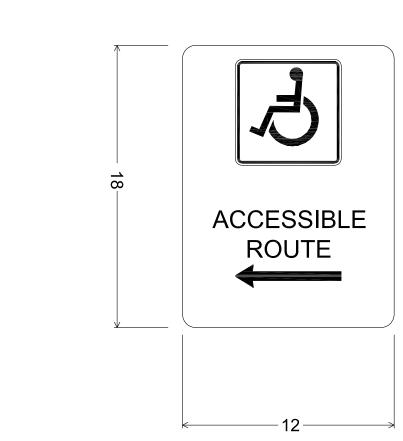

1.5" Radius, 0.5" Border, White on, Green; "SR179", D; "Underpass", D; Arrow 2" Type D1 - 0';

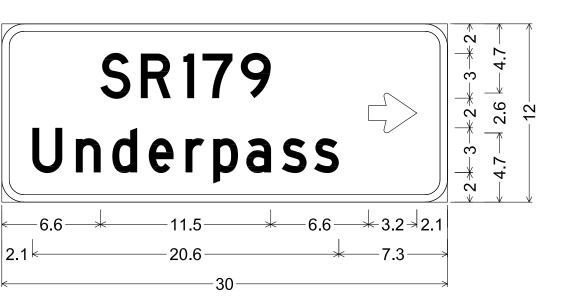


1.5" Radius, 0.5" Border, White on, Green; Arrow 2" Type D1 - 180'; "SR179", D; "Underpass", D;




ACCESSIBLE


ROUTE

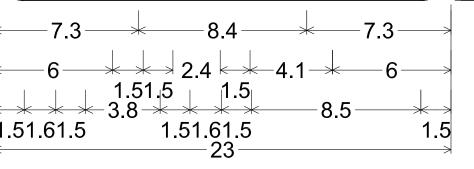


1.5" Radius, 0.4" Border, White on, Red; "DANGER", C; "DO NOT TOUCH", B; "OR CLIMB ON WATERWHEEL", B;

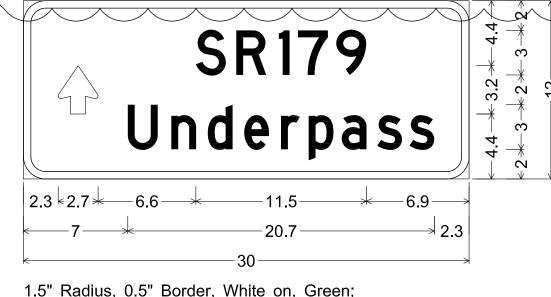

1.5" Radius, 0.5" Border, White on, Green; Arrow 2" Type D1 - 90'; "SR179", D; "Underpass", D;

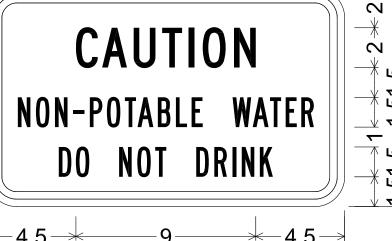

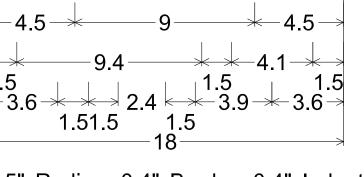

,"DO NOT DRINK", B;

1.5" Radius, 0.4" Border, 0.4" Indent, Black on, White; "CAUTION", C; "NON-POTABLE WATER", B;

BID ALTERNATIVE #2. SEE SPECIAL PROVISIONS.

Symbol Revisions Date Appr. Designed by: Date:


HAO 08/31/22

Drawn by: Scale:

CPG 1:20


Checked by: Project Code:

SD TRAFFIC

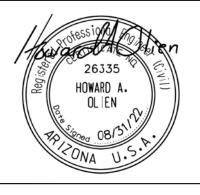



WSP USA Inc. 1230 W. Washington St. Suite 405 Tempe, AZ 85281

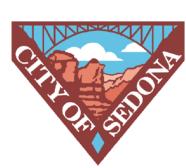

CITY OF SEDONA
PUBLIC WORKS DEPARTMENT
102 ROADRUNNER DRIVE

SEDONA, ARIZONA 86336 928-204-7111 SR 179 PEDESTRIAN CROSSING
AT TLAQUEPAQUE
SEDONA ARIZONA


SIGN FORMAT SHEET

T4

SHEET NO. OF

38 46

E SAVED: 9/20/22 T:\SEDONA 179\SIGN & PVMRK\SIGN FORMAT SHEET.DWG

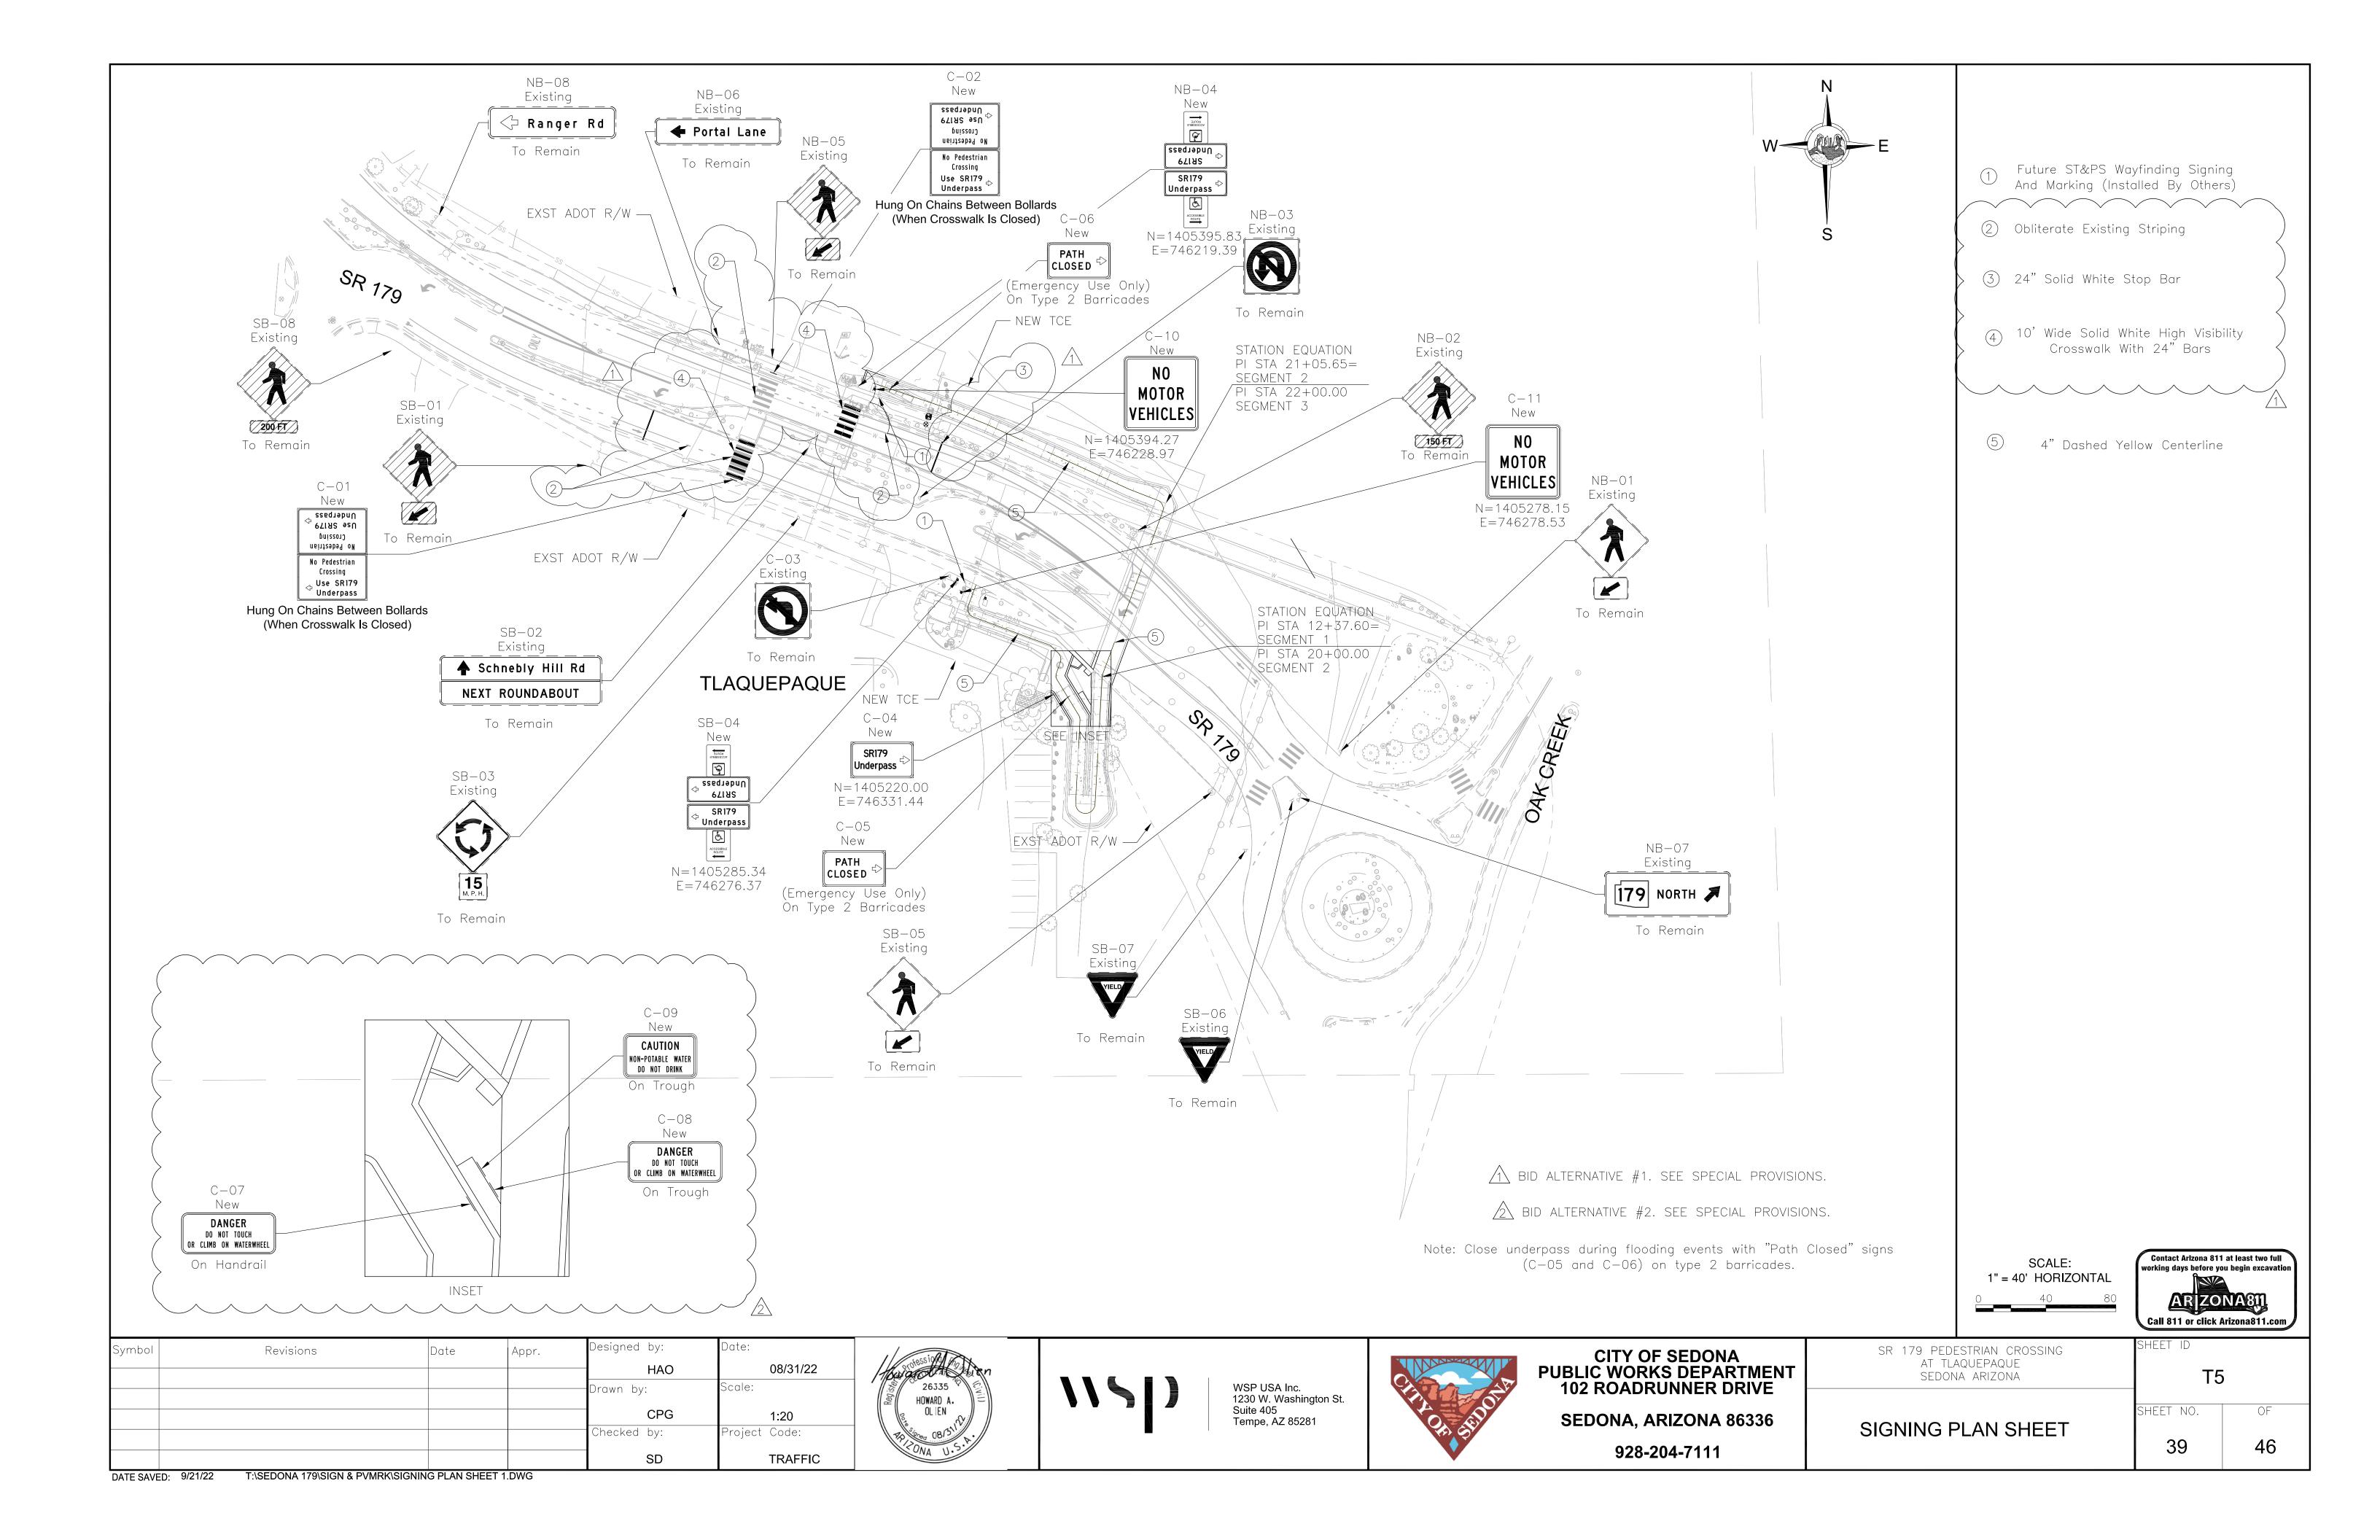

GENERAL NOTES

- 1. ALL MATERIALS AND INSTALLATION SHALL CONFORM TO THE MOST RECENT ADOT TRAFFIC SIGNAL AND LIGHTING STANDARD DRAWINGS.
- 2. FOR INSTALLATION PROCEDURES, SEE ADOT'S TRAFFIC SIGNAL AND LIGHTING STANDARD DRAWINGS.
- 3. THE LOCATION OF UTILITIES SHOWN ON THE PLANS ARE APPROXIMATE. ALL INVOLVED UTILITIES MAY NOT BE SHOWN ON THE PLAN. THE CONTRACTOR SHALL BE RESPONSIBLE FOR CONTACTING ALL UTILITIES FOR THE EXACT LOCATION PRIOR TO ANY CONSTRUCTION ACTIVITY.
- 4. THE CONTRACTOR SHALL BE RESPONSIBLE FOR MAINTAINING PROPER OFFSETS FROM ALL OVERHEAD AND UNDERGROUND UTILITIES. THE CONTRACTOR SHALL CONTACT EACH UTILITY FOR SPECIFIC REQUIREMENTS.
- 5. FOR ELECTRICAL SERVICE REQUIREMENTS, CONTACT ARIZONA PUBLIC SERVICE.
- 6. THE CONTRACTOR SHALL VERIFY THE ACTUAL LOCATION OF THE ELECTRICAL SERVICE POLE WITH THE UTILITY COMPANY PRIOR TO TRENCHING AND INSTALLING THE SERVICE PULL BOX (MAXIMUM 2 FEET FROM SERVICE POINT). THE CONTRACTOR SHALL PROVIDE A MINIMUM OF 5 FEET OF SLACK FOR EACH CONDUCTOR IN THE SERVICE PULL BOX. THE UTILITY COMPANY SHALL MAKE THIS CONNECTION AND THE CONTRACTOR COORDINATE THE WORK.
- 7. EXACT LOCATIONS OF LOAD CENTER CABINETS AND TRANSFORMERS SHALL BE DETERMINED BY THE ENGINEER IN THE FIELD.
- 8. ONCE INSTALLED, ALL LUMINAIRES SHALL PASS A 100 HOUR CONTINUOUSLY ENERGIZED TEST BEFORE FINAL ACCEPTANCE. THE CONTRACTOR WILL BE RESPONSIBLE FOR CORRECTING ANY PROBLEMS.
- 9. ALL LIGHTING UNITS SHALL BE INSTALLED WITH THE MAST ARM PERPENDICULAR TO THE LANE OR PATH ON WHICH THEY ARE LOCATED.
- 10. THE CONTRACTOR SHALL PROVIDE AN ELECTRICAL EXPANSION COUPLING OF THE SIZE AND TYPE REQUIRED AT STRUCTURAL EXPANSION JOINTS.
- 11. ALL OFFSETS ARE FROM CENTERLINE, UNLESS OTHERWISE NOTED.
- 12. CONDUIT AND PULLBOXES ARE SHOWN DIAGRAMMATICALLY. EXACT LOCATIONS TO BE DETERMINED IN THE FIELD. CONDUIT ALIGNMENTS SHOULD BE REVIEWED WITH THE ELECTRICAL INSPECTOR PRIOR TO LAYOUT BY THE SURVEY CREW. SPACING OF PULLBOXES SHALL BE 350 FEET OR LESS. SEE STRUCTURAL PLANS FOR MORE INFORMATION ON LOCATING CONDUIT IN WALLS.
- 13. ALL PULL BOXES SHALL BE LEFT IN A CLEAN CONDITION, FREE OF DIRT AND DEBRIS, UPON COMPLETION OF THE WORK.
- 14. THE CONTRACTOR SHALL OBTAIN ALL PERMITS REQUIRED BY ALL GOVERNMENTAL AGENCIES.
- 15. THE CONTRACTOR SHALL CONTACT BLUE STAKE AT 1-800-782-5348, A MINIMUM OF 2 WORKING DAYS PRIOR TO ANY EXCAVATION.
- 16. ANY EQUIPMENT AND/OR UTILITIES WITHIN THE PROJECT LIMITS THAT ARE DAMAGED OR DESTROYED BY THE CONTRACTOR SHALL BE REPAIRED OR REPLACED AT THE SOLE EXPENSE OF THE CONTRACTOR.
- 17. THE CONTRACTOR SHALL SUPPLY AND INSTALL ALL EQUIPMENT AND MATERIALS SPECIFIED ON THE APPROVED PLANS AND IN THE PROJECT SPECIFICATIONS.
- 18. UNLESS SPECIFICALLY IDENTIFIED FOR REMOVAL AS PART OF THIS PROJECT, IT IS THE CONTRACTOR'S RESPONSIBILITY TO REPAIR/RESTORE ANY LANDSCAPING, IRRIGATION, OR HARDSCAPE THAT MAY HAVE BEEN DAMAGED OR DISTURBED BY THE CONSTRUCTION ACTIVITIES.

DATE SAVED: 9/21/22 T:\SEDONA 179\LIGHTING\LN01.DWG

LEGEND

A = POLE / LUMINAIRE NUMBER
C = CIRCUIT NUMBER

D D= CONDUIT AND CONDUCTOR IDENTIFICATION/RUN NUMBER

METER PEDESTAL (SEE ADOT STD DWGS T.S. 2-6 AND T.S. 3-5)

 \square #5 PULLBOX (SEE ADOT STD DWG T.S. 1-1)

---- CONDUIT RUN


o—¤ POLE WITH LUMINAIRE

	Panel Designation: New Panel									Main: 100 AMP									
Mounting: Pad Mounted									Volts: 120/240: Single Phase, 3 Wire										
CVT	DDI	\A/ino	Photocell	Description	ν	/atts	CVT	DDK	Wire	Photocell			atts						
CKI	CKT BRK \	wire	Control	Description	Description		CKI	DKK	wire	Control	Description		L2						
1	15	12	Yes	Underpass Path Light Poles	122	4	2	20	8	No	Path Light Pole Outlets	873.6							
		12	Yes	-		122.4	1 4	15	10		Wall Sconces	600							
5	15	12	Yes	LED Rope For Windows		132	2 6	15	8	No {	Waterwheel Pump And Water Monitoring Panel		720						
:										1	2								
				Feeder:	122	4 254.4	ı			•		1474	720						
							L1	=	1596	Watts		12.79	AMPS						
							L2	=	974	Watts		7.61	AMPS						

BID ALTERNATIVE #2. SEE SPECIAL PROVISIONS




Symbol	Revisions	Date	Appr.	Designed by:	Date:
				НАО	8/31/2022
				Drawn by:	Scale:
				CPG	1:20
				Checked by:	Project Code:
				SD	TRAFFIC

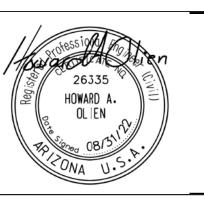





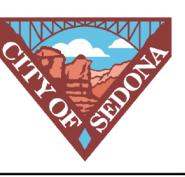


CITY OF SEDONA PUBLIC WORKS DEPARTMENT 102 ROADRUNNER DRIVE
SEDONA, ARIZONA 86336


928-204-7111

SR 179 PEDESTRIAN CROSSING AT TLAQUEPAQUE SEDONA ARIZONA	
LIGHTING GENERAL	

NOTES SHEET

SHEET ID	
Т6	;
SHEET NO.	OF
40	46

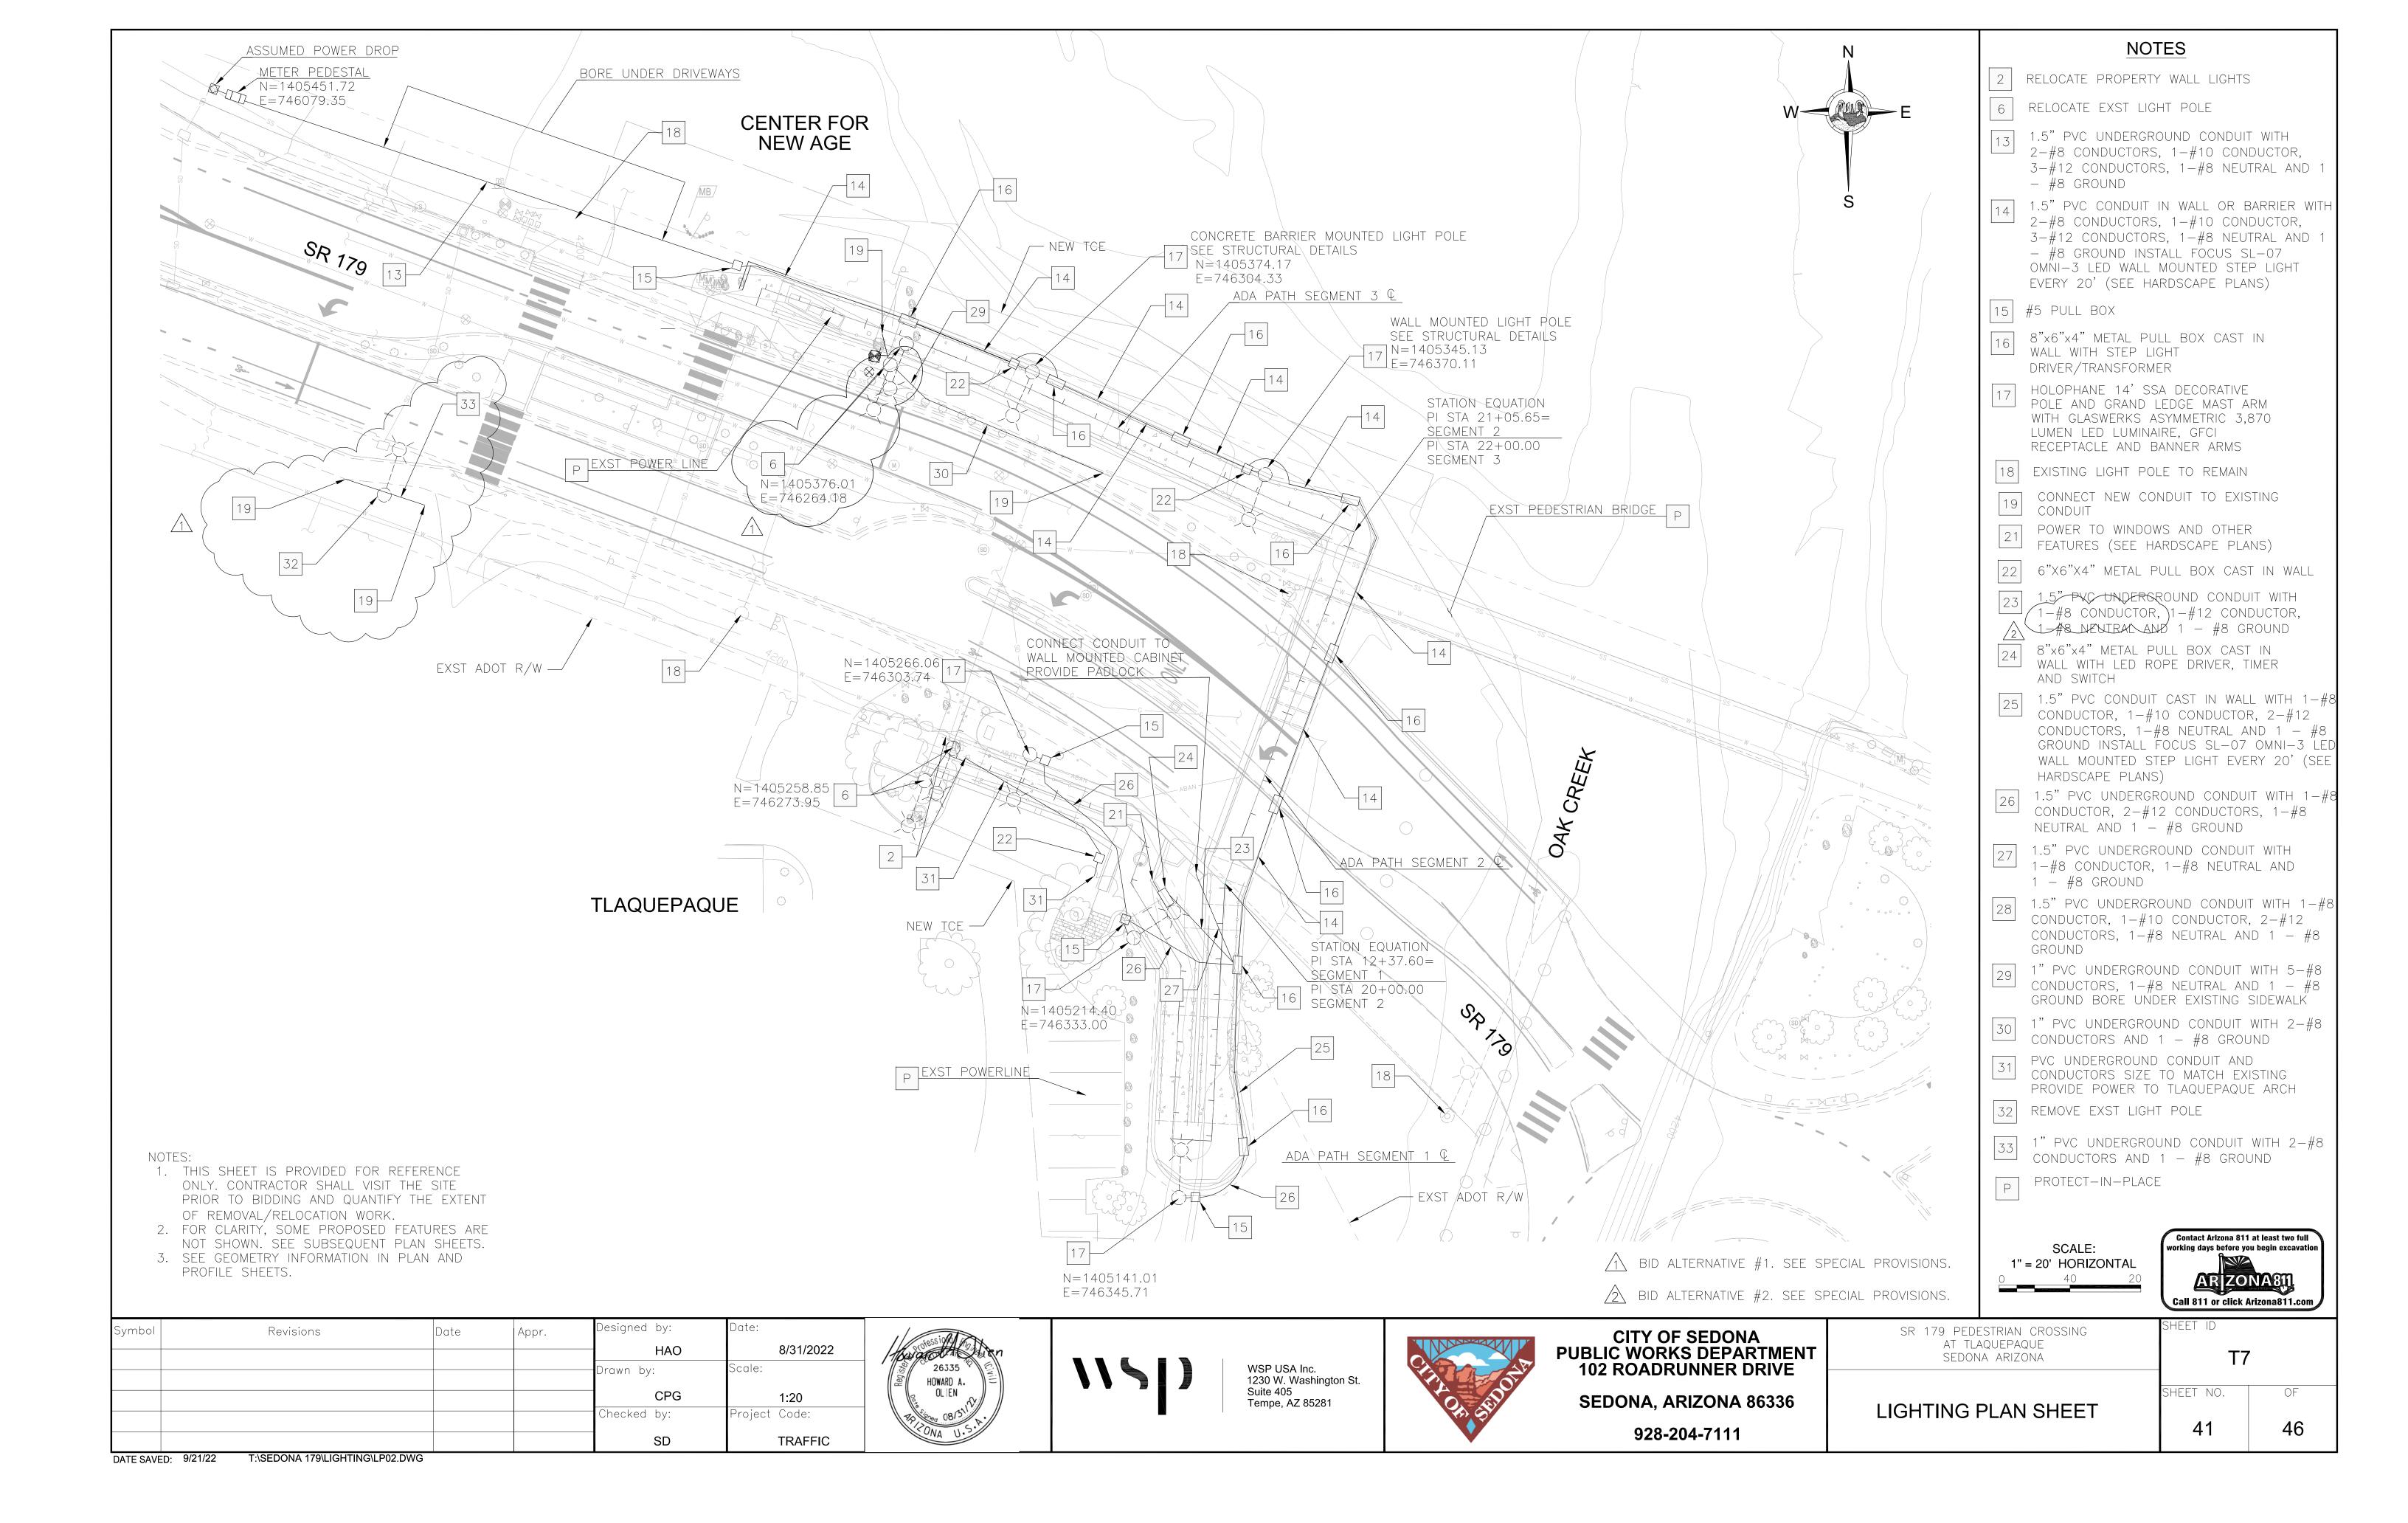

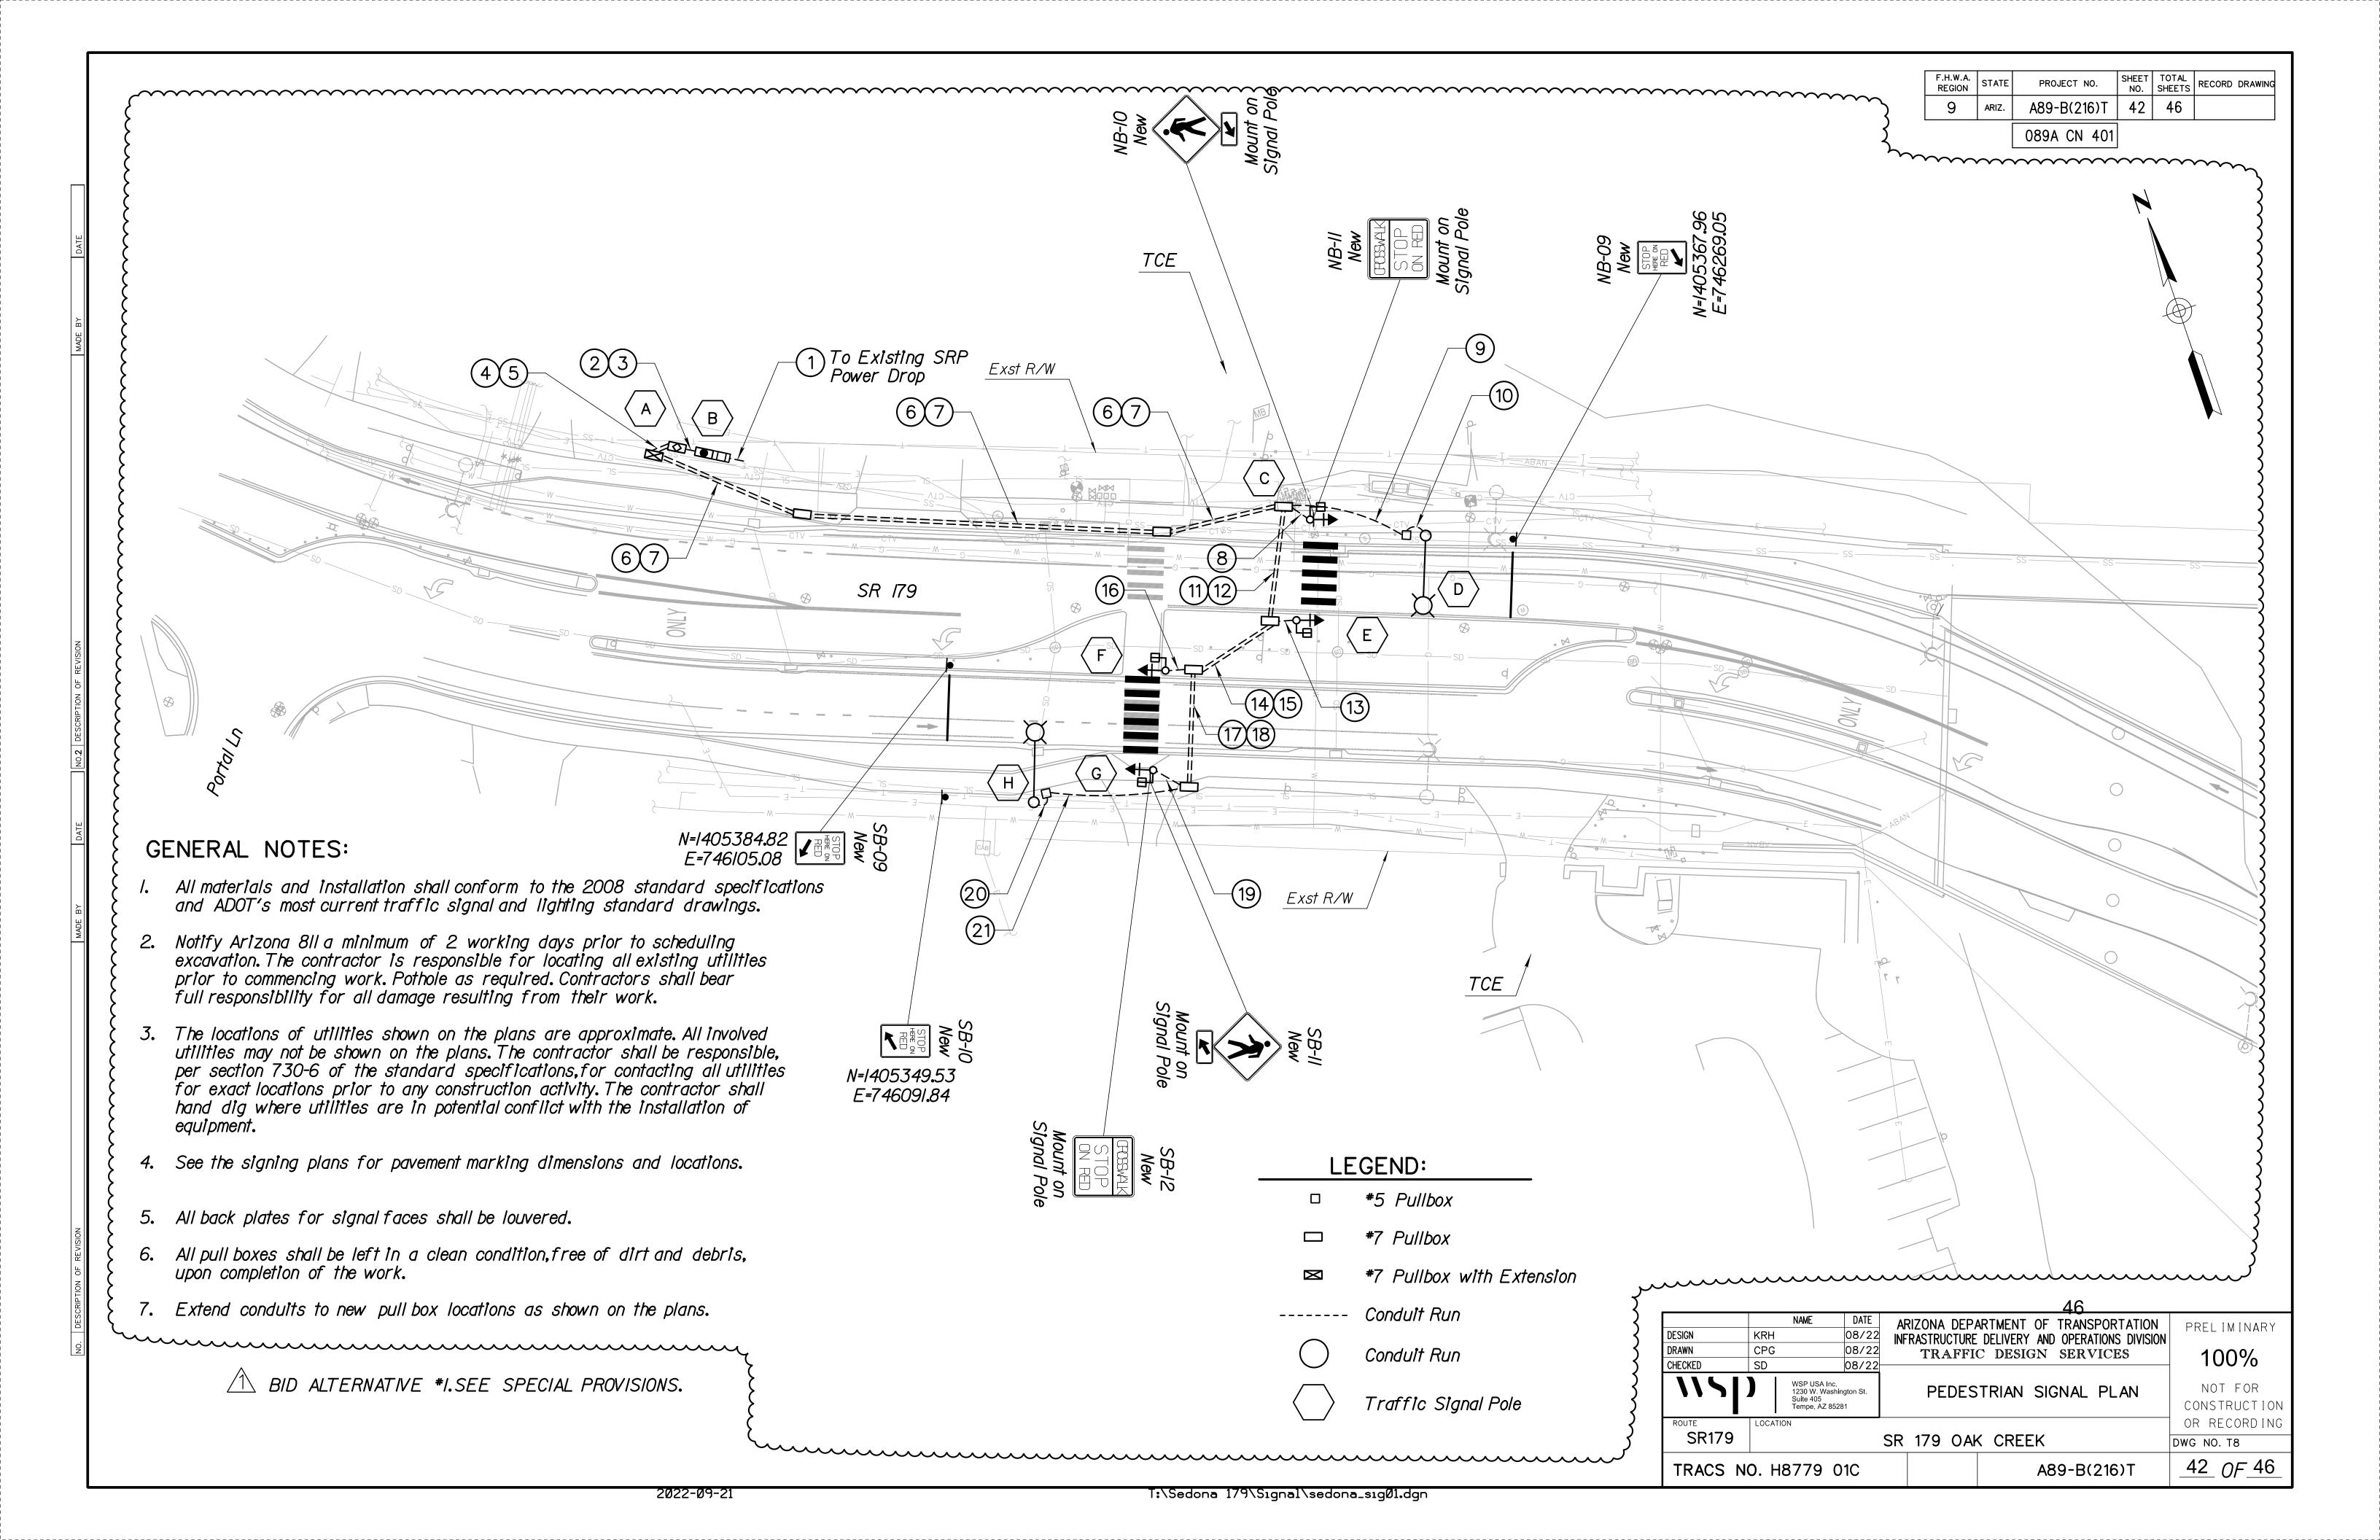

\						~POLE~SCHL	EDULE			
	CABINET	TYPE	CON	TROLLER	R & SERVIC	E AUX	(ILIARY CONTROL	REMARKS	LOCATION	
A		V		Econolite Cobalt			-	See Note I	N 1405468.69 E 746050.91	GENERAL NOTES: 1. A raised PCC pad 48" x 4" x 48" shall be place
(B)	UPS PEC	Meter Pedestal Cabinet/ UPS Cabinet		-		Batter Hou	y Back Up System used in Cabinet	Electrical Service Address: XX	N 1405463.67 E 746059.75	foundation. Pad shall be set 2" below the foundation and away from cabinet (2% min.). Foundation and included as part of controller cabinet (Type V). Dwg T.S.2-4. 2. Audible ADA pedestrian push buttons shall be
	POLE		MAST	T ARM	SIGNA	ALS	P.B.	REMARKS		provisions.
	NUMBER	TYPE	SIG.	LUM.	MTG.	FACE	SIGN			3. The contractor shall field verify all pole location activity.
		A (xx') *	-	-	I-IV I-XI	I-F (Mod-H) I-M/H I-PB	RIO-3b (Right)		N 1405391.65 E 746215.86	4. Top of pole foundation shall be the same eleval sidewalk ramp, or the adjacent finished roadw Construct compacted fill around foundations f
D	\ \\ \\ \\ \\ \\ \\ \\ \\ \\ \\ \\ \\ \	*	-	30" GLD	-	-	_	173 Watt LED Decorative Luminaire	N 1405376.83 E 746245.74	poles. 5. All exposed conduit and fittings installed above per the Standard Specifications.
$\overline{\mathcal{E}}$		A (xx') *	-	-	I-IV I-XI	I-F (Mod-H) I-M/H I-PB	RIO-3b (Left)		N 1405365.60 E 746203.03	6. All traffic signal indications shall be Light Emi 7. All pedestrian signals shall be modular "man/h 8. The contractor shall check for possible conflic
F	←	A (xx') *	-	-	I-IV I-XI	I-F (Mod-H) I-M/H I-PB	RIO-3b (Right)		N 1405363.84 E 746162.99	back plates and shall check for proper visibili The contractor shall provide nipples of suffici mounting arrangement. 9. As-built plans shall be complete before the sign
	★ ↑ •□	A (xx') *	-	-	I-IV I-XI	I-F (Mod-H) I-M/H I-PB	RIO-3b (Left)		N 1405337.99 E 746150.60	Engineer.
H	<u> </u>	*	-	30" GLD	-	-	_	151 Watt LED Decorative Luminaire	N 1405340.13 E 746115.36	SIGNAL HE

* Molophane 30' SSA Decorative Pole.

F.H.W.A. REGION STATE SHEET TOTAL RECORD DRAWING PROJECT NO. A89-B(216)T 43 46 9 ARIZ. 089A CN 401

GENERAL NOTES:

- I. A raised PCC pad 48" x 4" x 48" shall be placed in front of cabinet foundation. Pad shall be set 2" below the foundation elevation. Slope pad away from cabinet (2% min.). Foundation and raised PCC pad shall be included as part of controller cabinet (Type V). See ADOT Std Dwg T.S. 2-4.
- 2. Audible ADA pedestrian push buttons shall be installed. See special provisions.
- 3. The contractor shall field verify all pole locations with the Engineer, prior to any construction activity.
- 4. Top of pole foundation shall be the same elevation as the top of the finished sidewalk ramp, or the adjacent finished roadway surface, in sloped areas. Construct compacted fill around foundations for full structural support at poles.
- 5. All exposed conduit and fittings installed above ground shall be rigid metal per the Standard Specifications.
- 6. All traffic signal indications shall be Light Emitting Diode (LED) modules.
- 7. All pedestrian signals shall be modular "man/hand" style.
- 8. The contractor shall check for possible conflicts between signal mountings and back plates and shall check for proper visibility and alignment of signal heads. The contractor shall provide nipples of sufficient length to accomplish the intended mounting arrangement.
- 9. As-built plans shall be complete before the signal will be accepted by the Engineer.

SIGNAL HEAD

ARIZONA DEPARTMENT OF TRANSPORTATION PRELIMINARY INFRASTRUCTURE DELIVERY AND OPERATIONS DIVISION TRAFFIC DESIGN SERVICES 100% 08/22 WSP USA Inc. 1230 W. Washington St. Suite 405 Tempe, AZ 85281 TRAFFIC SIGNAL NOT FOR POLE SCHEDULE CONSTRUCTION OR RECORDING SR179 SR 179 OAK CREEK DWG NO. T9 43 OF 46 TRACS NO. H8779 01C A89-B(216)T

A BID ALTERNATIVE #1.SEE SPECIAL PROVISIONS.

>				C	ONL)UC	CTC	R	SCI	HEL	DUL	E.										
>	CONDUIT RUN NUMBER	1	2	3	4	5	6	7	8	9	10		12	13	14	<i>15</i>	16	17	18	19	20	21
AWG	CONDUIT SIZE IN INCHES CIRCUIT PHASE	2.5	2	2	3	2	3	3	3	<u>2</u> N(<u> 2</u> JMBL	<u>3</u> ER (<u>2</u> DF V	<u>3</u> VIRE	3 S	2	3	3	3	3	2	2
#14 MSA 19-1 *	IMSA CABLE NO.OF CABLES NO.CONDUCTORS 20 Conductor Cable	CONDUCTORS BY XX			(4) 20CC - C,E,F,G		(4) 20CC - C,E,F,G		(1) 20CC - C			(3) 20CC - E,F,G		(1) 20CC - E	(2) 20CC - F,G		(I) 20CC - F	(1) 20CC - G		(1) 20CC - G		
#10	Lighting 240V Signal 120V (Black)		2	2		2				2	2		2			2					2	2
> >	Common White (Stranded)		/	/	/		/		/			/	/		/		/	/	/	/	/	
* ************************************	Insulated Bond (Green) ⊖		1	1	1	1	1	1	1	1	1	1	1	1	1	1	1	1	1	/	1	1

LEGEND:

- * The IMSA 20-conductor cable shall be #14 AWG IMSA 19-1. The IMSA 2-conductor and 7-conductor cable shall be #14 AWG IMSA 19-1.
- A crimp connection shall be used for splicing in pullbox.

IMSA CA	ABLE 19-1	, * 14 A	WG, 20	CONDUCTOR
CABLE	CABLE	CONDU COL		SIGNAL
* 1	* 2	BASIC COLOR	TRACER STRIPE	INTERVAL
	:5	Red	White	Red
:1	0R	Black	White	Yellow
	Overlap A	Green	White	Green
	:6	Red		Red
:2	OR	Orange		Yellow
	Overlap B	Green		Green
	:7	Black	Red	Red
:3	OR	Orange	Red	Yellow
	Overlap C	Blue	Red	Green
	:8	Red	Black	Red
:4	OR	Orange	Black	Yellow
	Overlap D	Green	Black	Green
		blue		Walk
:2 PEDS.	:6 PEDS.	Black		Dont Walk
		White	Black	Push Button
		Blue	White	Walk
:4 PEDS.	:8 PEDS.	Red	Green	Dont Walk
		White	Red	Push Button
ALL :'S	ALL :'S	White		P.B. Common
		Blue	Black	Spare

Cable #2 shall be marked with 2 individual 0.4 inch wide stainless steel bands, side by side with a 0.5 inch gap between wraps, at each pull box location. Individual conductors in the cable shall be tagged as to assigned

GENERAL NOTES:

- I. Use crimp connections on both *IO signal common and *8 green bond in pull boxes.
- 2. The 20-conductor IMSA cable shall be continuous (no splices) from the controller cabinet to the side mounted signal terminal block on the pole. The mast arm's 4-conductor and 7-conductor cables shall then run from each signal head to the terminal block. All pole signal head splicing shall occur solely at the terminal block.

SIGNAL	SIGNAL HEADS								
OUTBOARD & FAR LEFT									
7 CONDUCTOR CABLE									
BASIC COLOR	SIGNAL INTERVAL								
Red	Red								
Black	Yellow								
Green	Green								
Orange	Yellow Arrow								
Blue	Green Arrow								
White	Veh. Com.								

White/Blk Tr Veh. Com.

SIGNAL INBOARD &	HEADS SIDEMOUNT	PEDESTR	RIAN HEADS
4 CONDUC	TOR CABLE	4 CONDU	CTOR CABLE
BASIC COLOR	SIGNAL INTERVAL	BASIC COLOR	SIGNAL INTERVAL
Red	Red	Red	Don't Walk
Black	Yellow	Green	Walk
Green	Green	White	Ped. Com.
White	Veh. Com.	Black	Spare

4 CONDUCTOR CABLE						
BASIC COLOR	PUSH BUTTON STATION					
Red	Push Button					
White	P.B. Com.					
Green	Spare					
Black	Spare					

PUSH BUTTON

THE CABLE SHALL BE TAGGED AS TO ASSIGNED PHASE.

ARIZONA DEPARTMENT OF TRANSPORTATION PREL IMINARY INFRASTRUCTURE DELIVERY AND OPERATIONS DIVISION
TRAFFIC DESIGN SERVICES 100% 08/22 TRAFFIC SIGNAL WSP USA Inc. 1230 W. Washington St. Suite 405 Tempe, AZ 85281 NOT FOR CONDUCTOR SCHEDULE CONSTRUCTION OR RECORDING SR179 SR 179 OAK CREEK DWG NO. T10 <u>44</u> *OF* <u>46</u> TRACS NO. H8779 01C A89-B(216)T

F.H.W.A. REGION STATE

9 ARIZ.


PROJECT NO.

089A CN 401

A89-B(216)T 44 46

SHEET TOTAL RECORD DRAWING

BID ALTERNATIVE *I.SEE SPECIAL PROVISIONS.

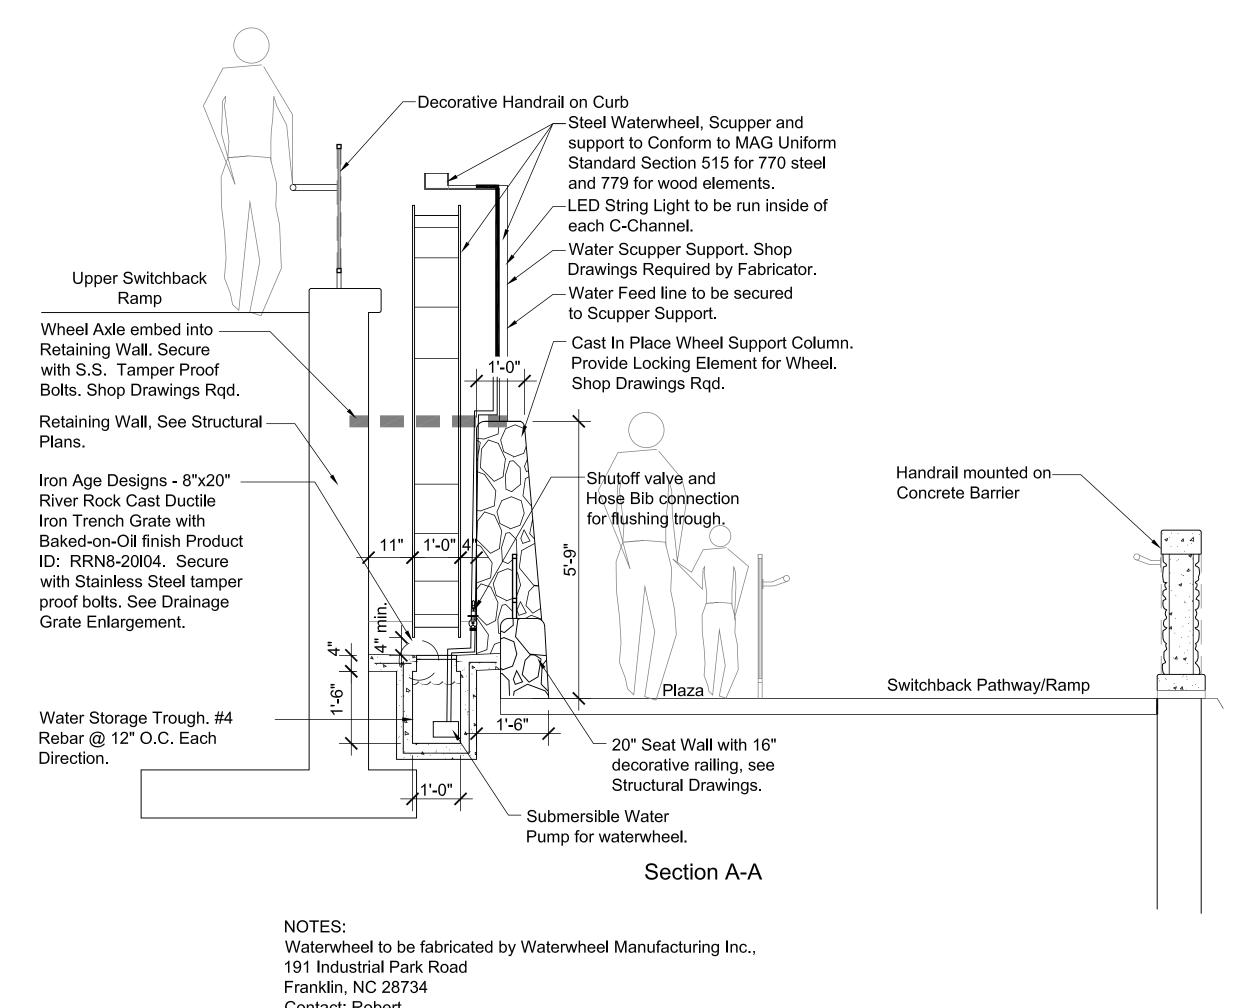

Contact: Robert Phone: 828-369-5928 email - Waterwheel@dnet.net

- or - Approved Equal Qualified Fabricator.


Contractor to provide all shop drawings for construction and all required governmental permitting for all waterwheel appurtenances including but not limited to, supports, axle, water pump, hand pump activation switch, water level float, scupper, foundation, wall support columns, wheel lock, etc. for review and approval prior to fabrication of water wheel. Color and finishes of the waterwheel and equipment to be coordinated with the Owner's Representative.


The Contractor shall submit shop drawings for wheel axle embedment into retaining wall. Contractor has the option to install with independent support (CIP or Steel) as approved by the City's Representative. Service load into retaining wall shall not exceed 700 vertical pounds.

Contractor to Coordinate Wheel Fabrication and mounting requirements with the fabricator prior to installing Retaining Wall. Waterwheel to be fabricated from steel with wood facing.

Concrete seat wall and support column to have "Yosemite Stone" Form Liner by Scott Systems. Top of support column to remain smooth for embed weld plates. All wall and support column surfaces to receive 'Permeon' stain, see Specifications.

All Work shall conform to the most recent edition of MAG Uniform Standards. Metal and Wood work shall have a natural finish with sealant to protect from weathering. Permitting per City of Sedona and Coconino County requirements.

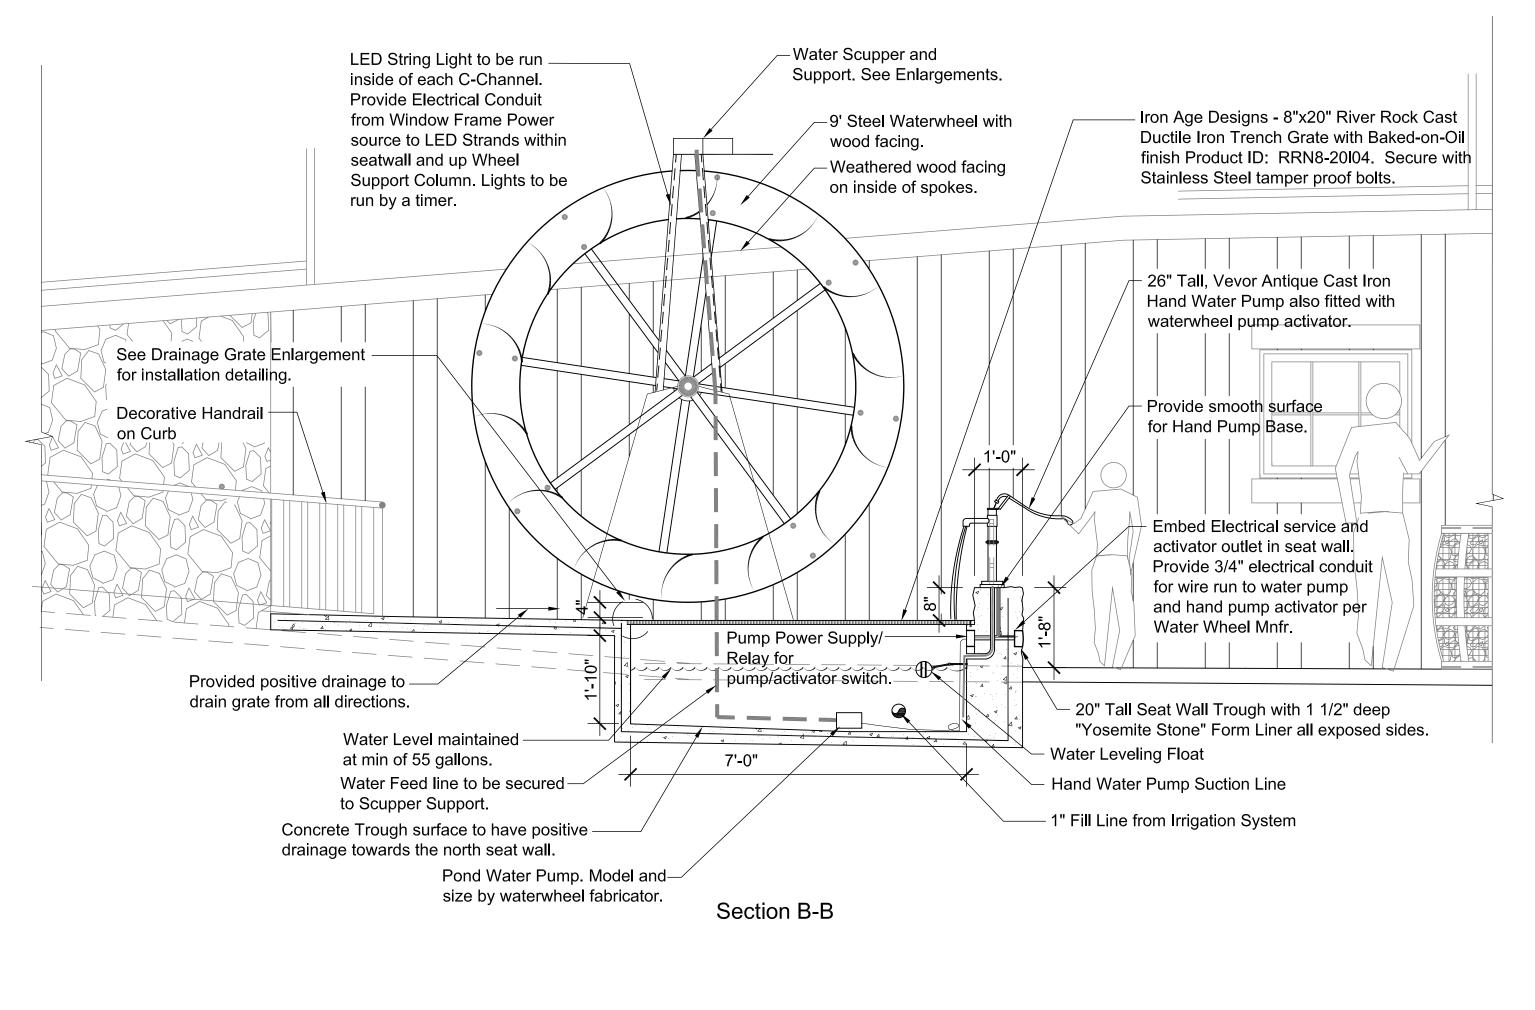


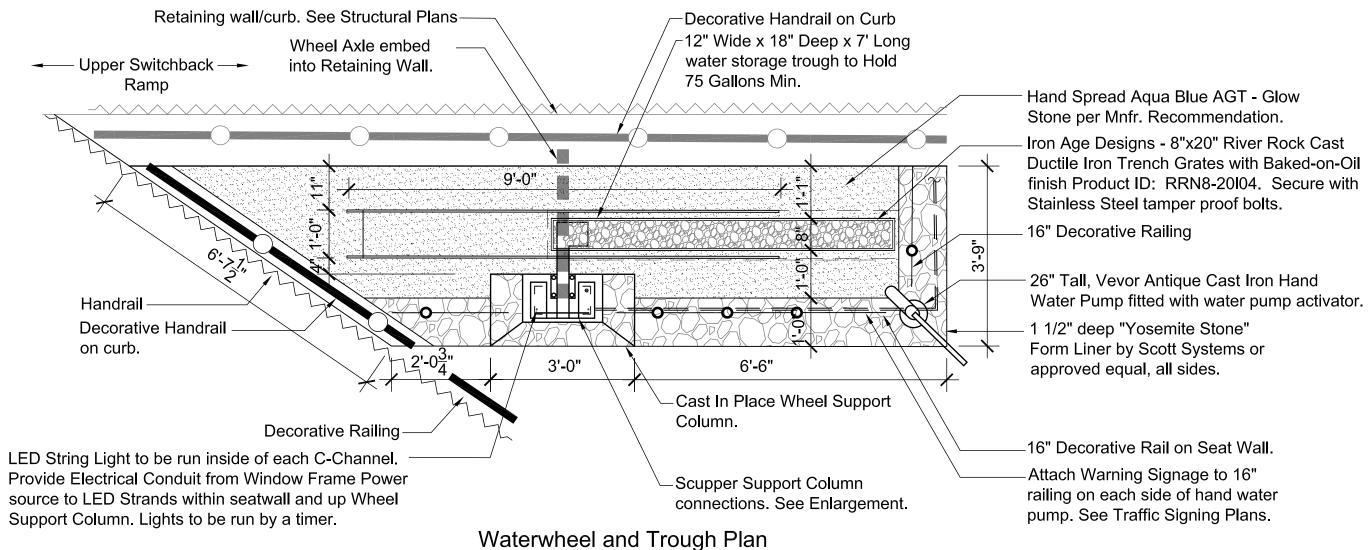

WATERWHEEL 1/2" = 1'-0"



Designed by: Symbol Revisions Appr. 09/01/22 BP Bid Alternate - Waterwheel and Associated Elements | 01/24/2022 Scale: Drawn by: NOT TO SCALE Checked by: Project Code: EC CIVIL

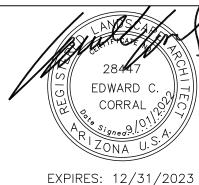

WSP USA Inc. 1230 W. Washington St. Suite 400 Tempe, AZ 85281





CITY OF SEDONA **PUBLIC WORKS DEPARTMENT 102 ROADRUNNER DRIVE**

SEDONA, ARIZONA 86336 928-204-7111

SR 179 PEDESTRIAN CROSSING AT TLAQUEPAQUE SEDONA, ARIZONA

BA 2.01

SHEET ID

BID ALTERNATE #2 **WATERWHEEL DETAILS** SHEET NO. OF

K:\CDG Projects\2019-263\CADD\100 - Bid Set_Sealed\Water Wheel Sheets_WW DTL Sheets_.dwg

