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# RICHARD HUBBELL & ASSOCIATES

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Oak Creek Heritage Lodge

COMPREHENSIVE DESIGN SUBMITTAL MARCH 147H, 2023

Herrice Cover Sheet

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# **OWNER / CLIENT**

R.D. OLSON DEVELOPMENT 520 NEWPORT CENTER DRIVE, SUITE 600 NEWPORT BEACH, CA 92660 (949) 271-1109 CONTACT: ANTHONY WRZOSEK ANTHONY.WRZOSEK@RDODEVELOPMENT.COM

# ARCHITECT

WATG 300 SPECTRUM CENTER DRIVE, SUITE 500 IRVINE, CA 92618 (949) 574-8500 CONTACT: GREG VILLEGAS GVILLEGAS@WATG.COM

# CONSULTING ARCHITECT

ERIC BRANDT ARCHITECT 2890 THUNDERMOUNTAIN ROAD SEDONA, AZ 86336 (928) 821-3617 CONTACT: ERIC BRANDT ERIC@BRANDTARCHITECT.COM

# LANDSCAPE ARCHITECTS

BRIGHTVIEW DESIGN GROUP 8 HUGHES IRVINE, CA 92618 (949) 241-5391 CONTACT: SANDEEP WALIA SANDEEP.WALIA@BRIGHTVIEW.COM

# CONSULTING LANDSCAPE ARCHITECT

RICHARD HUBBELL & ASSOCIATES 80 SOLIDERS PASS ROAD SEDONA, AZ 86336 (928) 282-9477 CONTACT: RICHARD HUBBELL RICHARDHUBBELLINC@GMAIL.COM

# **CIVIL ENGINEER & SURVEYOR**

SEFTON ENGINEERING CONSULTANTS 40 STUTZ BEARCAT DRIVE SEDONA, AZ 86336 (928) 202-3999 CONTACT: LUKE SEFTON LS@SEFENGCO.COM

HAMMES SURVEY 2100 VIA SILVERA CAMP VERDE, AZ 86322 CONTACT: TIM HAMMES T.HAM@LIVE.COM

# PROJECT NARRATIVE

COMPREHENSIVE DESIGN SUBMITTAL FOR A NEW VISITOR SERVING LODGE TO INCLUDE 70 GUESTROOMS AND ASSOCIATED AMENITIES: I.E. OPEN SPACE, MEETING SPACE, RESTAURANT, WELLNESS CENTER, AND WORK-FORCE HOUSING. THE PROPOSED BOUTIQUE LODGE IS DESIGNED TO ENSURE CONFORMITY WITH THE SCHNEBLY COMMUNITY FOCUS AREA (CFA) AND BE CONSISTENT WITH THE CFA VISION FORA PEDESTRIAN-FRIENDLY, MIXED-USE AREA THAT PRESERVES THE OAK CREEK RIPARIAN CORRIDOR, NATURAL HILLSIDES, AND OPEN FIELDS, WITH A VARIETY OF MODESTLY SCALED BUILDINGS THAT SUSTAIN THE HISTORIC CONTEXT, TYPOLOGY, AND CHARACTER DISTINCTIVE TO THIS LOCATION.

# VICINITY MAP



# PROJECT LOCATION

LOCATION: SCHNEBLY COMMUNITY FOCUS ARE, WEST SIDE OF SCHNEBLY HILL ROAD BETWEEN THE SCHNEBLY ROUDABOUT AND BEAR WALLOW DRIVE. 65-195 SCHNEBLY HILL ROAD: 20 BEAR WALLOW

PARCEL NUMBERS: 401-11-001C, -002F; 401-12-016C; 401-18-001A, -002C, -031B, D, & G

# TRAFFIC / PARKING ENGINEER

KIMLEY-HORN 333 E. WETMORE ROAD, SUITE 280 TUCSON, AZ 85705 (385) 420-0941 CONTACT: BRENT CROWTHER BRENT.CROWTHER@KIMLEY-HORN.COM

	OAR CREEK HERI	TAGE LODGE - SEDONA	AL. PRO	JECT DATA			
PROJECT LOCATION:	Schnebly Community Focus Area 65-195 Schnebly Hill Road; 20 Be		tween the Schnebly	Roundabout and Bear Wallow Drive			
PARCEL DESIGNATIONS:	401-11-001C, -002F; 401-12-016C	; 401-18-001A, -002C, -031B, D & G					
ZONING DISTRICT: COMMUNITY FOCUS AREA:	OAK CREEK HERITAGE AREA (C SCHNEBLY COMMUNITY FOCU	SAGE					
COMMUNITY FOCUS AREA:	Pedestrian-friendly, mixed-use area that preserves the Oak Creek riparian corridor, natural hillsides, and open fields, with a variety of modestly scaled buildings that sustain the historic context and character distinctive to this area.						
	And the second state of the second state of the second sec		o this area.				
SITE AREA: DENSITY:	11.58 ACRES (504,424.80 SQUA Allowed: Lodging Density of (8)	RE FEET) Units per acre; or 11.58 x 8 = 92.64	units allowed				
	Proposed: 70 Lodging Units with	Accessory Use Structures (4 will b	e provided as Access				
		ing Apartments (1 will be provided	as an Accessible Unit	<u> </u>			
SETBACKS: BUILDING COVERAGE:	FRONT: 40 FEET, SIDE: 20 FEE Allowed: Maximum Building Cov	T, REAR: 20 FEET erage = 25% (126,106.2 sf = 504,424	.8 x 25%)				
		verage = 8.85% (44,634 sf = 504,42 vious Coverage) = 30% (151,327.44		A			
	Proposed: Total Coverage (Impe	31 전 경기에 가게 되었다. (하지 않아 프라이트) 사람이 되었다면 가게 되었다. (하는데 그렇게 되었다.)		28.105 %)_(Building Components = 65,512.33 sf + Landscape			
	Components = 76,673.98 sf)						
	Allowed: Maximum Building Foo			5 000 d - IId			
	(Range is 256 sf to 4,163 s	otprints. Of the (28) building struct f)	ires, are all under the	5,000 st allowed			
BUILDING HEIGHT:	E. BUILDING HEIGHT - PER 2.24.	E.(1)d.2 Parallel Plane Measuremen	Utilized				
				IG MEASURED FROM THE REGULATORY FLOOD ELEVATION - RFE)			
		4 E.(3)Table 2.7: Chimneys +10°; Eleva 24 E.(4)a.1.Table 2.8 MORE THAN 12 BLI					
	(HI-3) HEIGHT INCREASE $-3 = 2.2$	4 E.(4)b.1.2.Table 2.9 FOR WALL PLANE	RELIEF AND REDUCED				
	### 1 ################################						
FLOOR AREA Definition:				BUILDING THAT HAVE AT LEAST 5 FT OF CLEARANCE FACE OF STRUCTURAL MEMBERS OF THE WALL. ROOFED			
	ARCHITECTURAL RECESSES AN	D OPEN COVERED PORCHES ARE I	IOT CONSIDERED IN	TERIOR TO THE BUILDING. A BUILDING WITH AT LEAST 50			
	Secretaria de la companya del la companya de la com	E OUTSIDE SHALL NOT BE CONSID	MANUAL STREET STATISTS BAY				
PARKING: MEDIUM DENSITY LODGING		es per room within each lodging un athrooms, closets, or sim. Rooms as	기계 아이지 아니아 아이 아이는 얼마나 아이를 했다.				
	Additionally, for projects with ur	nder 100 units, an additional 10 perc					
	spaces shall be provided.  Provided: 90 total spaces. Refe	r to the Parking Demand Study (of t	he 90 spaces 4 are 4	accessible per IBC 20181			
	Note: Guest Parking	is Valet Only	spasso, 4 are A				
	Summary: 86 Stand	dard Spaces cessible Parking Spaces					
	50 000						
JILDING GROSS AREA: nclosed space)	CENTRAL CLUSTER - GROSS FI Lobby / BOH Bldg.	LOOR AREAS (enclosed space)  Basement Level	2,568 sf				
		Level 1 (Entry Level)	3,809 sf				
	Spa & Fitness Bldg.	Total Level 1 (Entry Level)	6,377 sf 3,314 sf				
		Level 2	2,460 sf				
	Restaurant Bldg.	Total Level 1 (Entry Level)	5,774 sf 4,163 sf				
	Nostalian Diag.	Level 2	2,675 sf				
	Private Dining Bldg.	Total Level 1 (Entry Level)	6,838 sf 301 sf				
	Private Dining Diag.	Total	301 sf				
	Lodge Units Bldg.	Level 1 (Entry Level) Level 2	3,539 sf 3,010 sf				
		Total	6,549 sf				
	Sub Total Central Cluster		25,839 sf				
	SOUTH CLUSTER - GROSS FLO	OR AREAS (enclosed space)					
	Meeting Room Bldg.	Level 1 (Entry Level)	2,747 sf				
	Green House (Board Rm.)	Total Level 1 (Entry Level)	2,747 sf 518 sf				
	100 th the transfer of the tra	Total	518 sf				
	вон	Basement Level Level 1 (Entry Level)	2,250 sf 2,250 sf				
	Workforce Apartments	Level 2	1,985 sf				
	Lodging Unit Bldgs.	Total Level 1 (Entry Level)	6,485 sf 7,070 sf				
		Level 2	5,817 sf				
	Sub Total South Cluster	Total	12,887 sf 22,637 sf				
	WEST CLUSTER - GROSS FLOO Lodging Unit Bldgs.	R AREAS (enclosed space) Level 1 (Entry Level)	8,931 sf				
	Loughing Onk Blugs.	Level 2	8,174 sf				
	MEP / Storage Bldg.	Total Level 1 (Entry Level)	17,105 sf 256 sf				
	mer / storage bidg.	Total	256 sf				
	Sub Total West Cluster		17,361 sf				
	NORTH CLUSTER - GROSS FLO	OR AREAS (enclosed space)	6,331 sf				
	NORTH CLUSTER - GROSS FLO Lodging Unit Bldgs.	Level 1 (Entry Level)					
		Level 1 (Entry Level) Level 2	1,785 sf 8,116 sf				
		Level 1 (Entry Level) Level 2 Total Level 1 (Entry Level)	8,116 sf 256 sf				
	Lodging Unit Bldgs.  MEP / Storage Bldgs.	Level 1 (Entry Level) Level 2 Total	8,116 sf 256 sf 256 sf				
	Lodging Unit Bidgs.  MEP / Storage Bidgs.  Sub Total North Cluster	Level 1 (Entry Level) Level 2 Total Level 1 (Entry Level) Total	8,116 sf 256 sf				
	Lodging Unit Bldgs.  MEP / Storage Bldgs.  Sub Total North Cluster  POOL BUILDINGS - GROSS FLO	Level 1 (Entry Level) Level 2 Total Level 1 (Entry Level) Total OR AREAS (enclosed space)	8,116 sf 256 sf 256 sf 8,372 sf				
	Lodging Unit Bidgs.  MEP / Storage Bidgs.  Sub Total North Cluster  POOL BUILDINGS - GROSS FLO Bar Building	Level 1 (Entry Level) Level 2 Total Level 1 (Entry Level) Total  FOR AREAS (enclosed space) Level 1 (Entry Level) Total	8,116 sf 256 sf 256 sf 8,372 sf 371 sf 371 sf				
	Lodging Unit Bldgs.  MEP / Storage Bldgs.  Sub Total North Cluster  POOL BUILDINGS - GROSS FLO	Level 1 (Entry Level) Level 2 Total Level 1 (Entry Level) Total  OR AREAS (enclosed space) Level 1 (Entry Level) Total Level 1 (Entry Level) Total Level 1 (Entry Level)	8,116 sf 256 sf 256 sf 8,372 sf 371 sf 371 sf 477 sf				
	Lodging Unit Bidgs.  MEP / Storage Bidgs.  Sub Total North Cluster  POOL BUILDINGS - GROSS FLO Bar Building	Level 1 (Entry Level) Level 2 Total Level 1 (Entry Level) Total  FOR AREAS (enclosed space) Level 1 (Entry Level) Total	8,116 sf 256 sf 256 sf 8,372 sf 371 sf 371 sf				
	Lodging Unit Bldgs.  MEP / Storage Bldgs.  Sub Total North Cluster  POOL BUILDINGS - GROSS FLO Bar Building  Pool Restrooms / Pump Rm.	Level 1 (Entry Level) Level 2 Total Level 1 (Entry Level) Total  OR AREAS (enclosed space) Level 1 (Entry Level) Total Level 1 (Entry Level) Total Level 1 (Entry Level)	8,116 sf 256 sf 256 sf 8,372 sf 371 sf 371 sf 477 sf 477 sf				

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# RICHARD HUBBELL & ASSOCIATES

# HAMMES SURVEYING LCC

2100 VIA SILVERADO CAMP VERDE, AZ 86322 (928) 282-5686 CONTACT: TIM HAMMES T. HAM@LIVE.COM

PROJECT TEAM

## Oak Creek Heritage Lodge

COMPREHENSIVE DESIGN SUBMITTAL MARCH 14TH, 2023

Project sheet title Information


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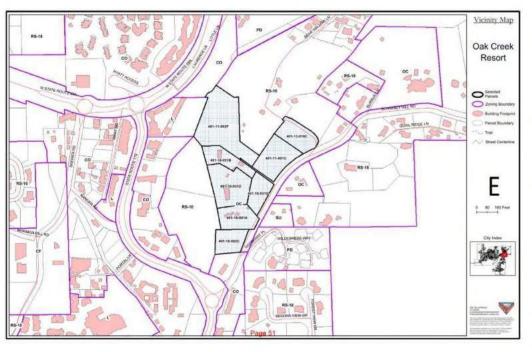
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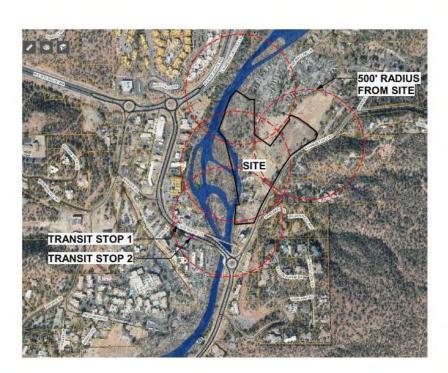
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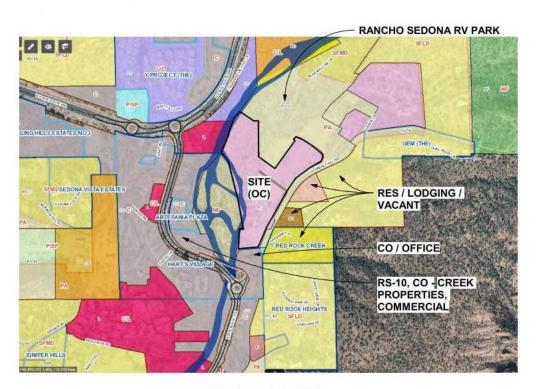






**EXISTING ADJACENT BUILDING ENVELOPES** MAJOR BIKE WAYS NEAR PROPERTY



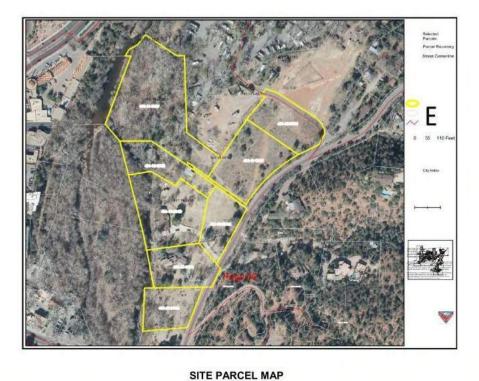



TRANSIT STOPS NEAR SITE LAND USE PER CITY GIS VICINITY MAP

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# RICHARD HUBBELL & ASSOCIATES

HAMMES SURVEYING LCC 2000 VIA SILVERADO CAMP VERDE, AZ 66322 (903) 262-5689 CONTACT, TON HAMMES TARMENTECON

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Oak Creek Heritage Lodge


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## HAMMES SURVEYING LCC



## Oak Creek Heritage Lodge

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### RICHARD HUBBELL & ASSOCIATES

HAMMES SURVEYING LCC 2000 VAN SEVERADO CAMP VERDE, AZ 66332 (VIEZ) 262-5686 CONTRACT: TON HAMMES TAMMELIYE.COM
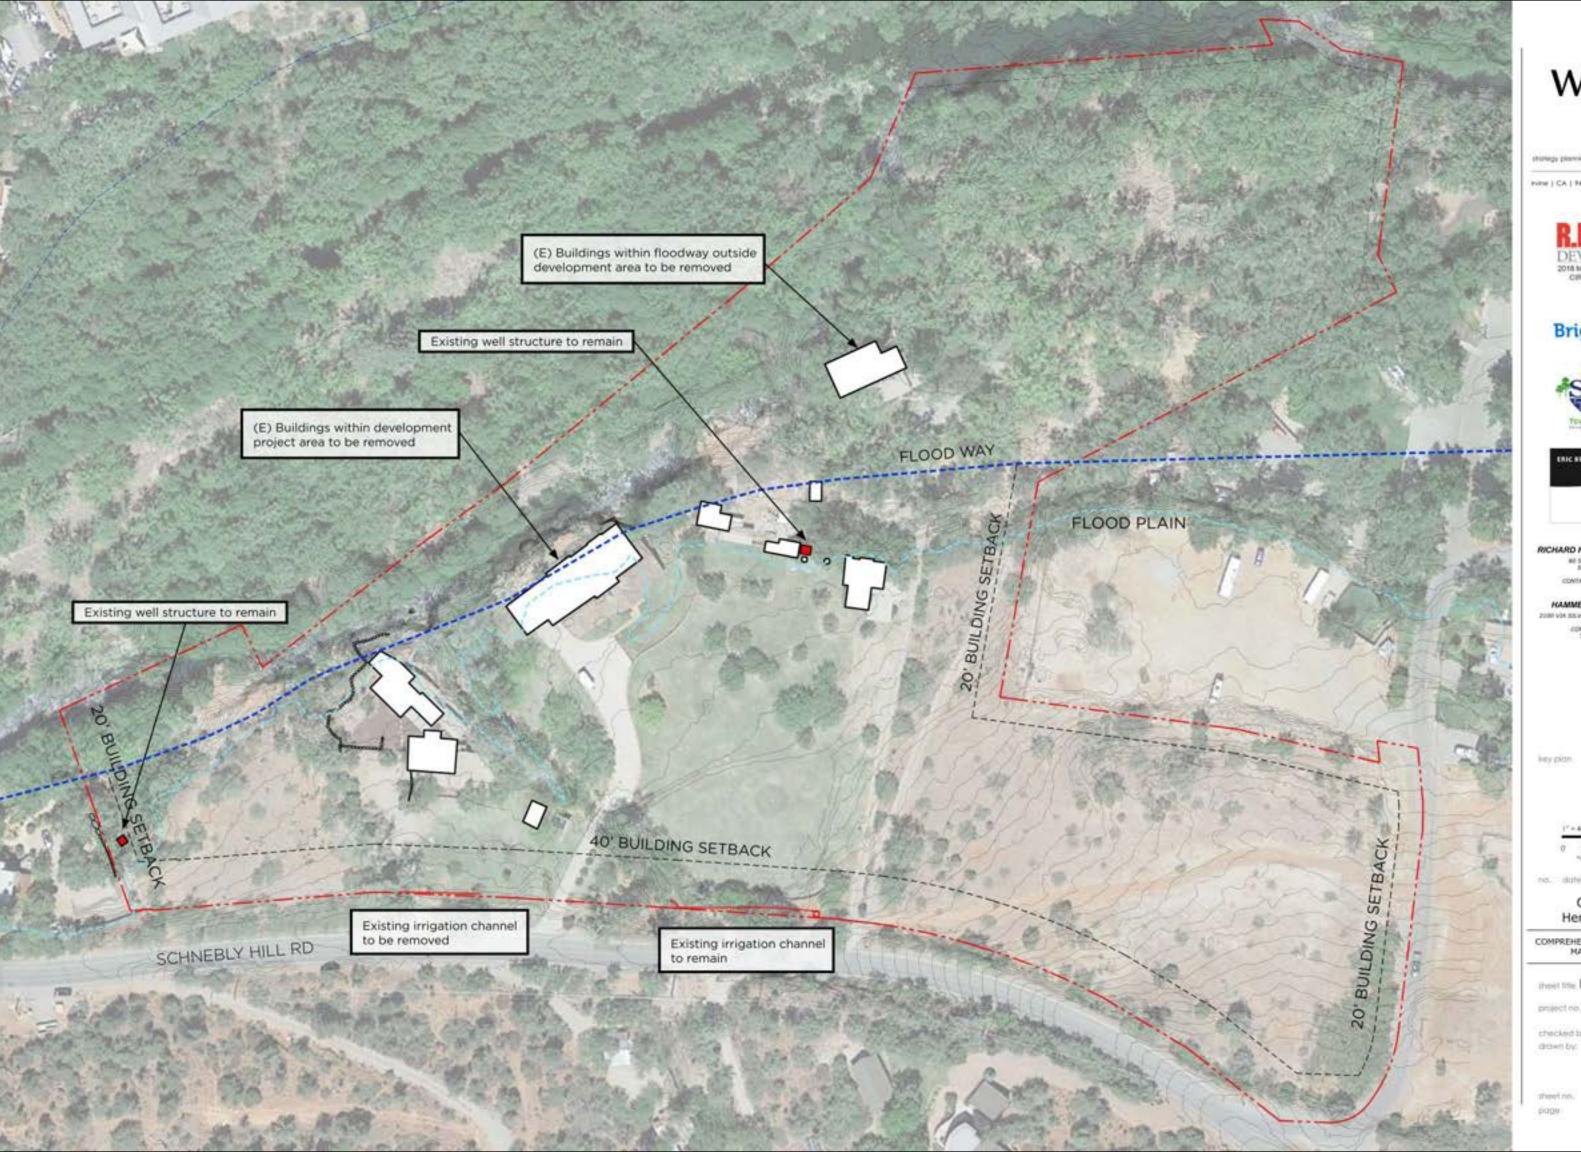
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# Oak Creek Heritage Lodge

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# RICHARD HUBBELL & ASSOCIATES

HAMMES SURVEYING LCC 2100 VIA SILVERADO CHAR VERDE, AZ 86322 2503 263-5686 CONTACT: TIM MAMMES 7.HARRILAYE.COM

key plan

Residence

Oak Creek Heritage Lodge

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Site Adjacent

sheet little Structure


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# THE SUN



# THE MOON



# THE WIND

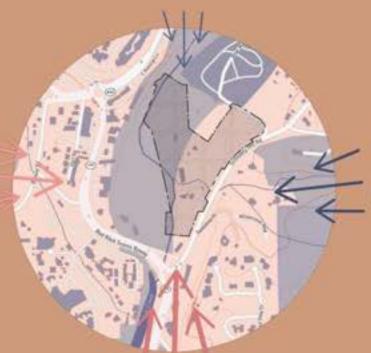

# HISTORICAL BUILDINGS

# THE



THE VIEWS



WILSON MOUNTAIN



**SNOOPY ROCK** 



OAK CREEK

# **WATG**

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PROJECT TEAM

Oak Creek Heritage Lodge

COMPREHENSIVE DESIGN SUBMITTAL MARCH 14TH, 2023

sheet title SITE INFLUENCES

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# THERITAGE

Sedona has always been a place of rejuvenation and growth. The energy of this place is unique with its striking geology, fauna and flora. Whether it was the indigenous people hunting and gathering, the early settlers growing their crops here or modern day locales creating art, people thrive here because of the richness of the earth and what can grow from it. We seek to create a space that returns people to nature as it has been done for centuries.

# THE SCHNEBLY CFA PLAN

The project site, located within the heart of Sedona, seeks to preserve the Oak Creek riparian corridor and sustain the distinct historic context and character of the area. A series of site development strategies including maintaining existing trees, minimizing grading, preserving and celebrating the historical remnants or site, and clustering modestly scaled buildings help accomplish this critical goal.

# THE ENVIRONMENT

Taking inspiration from the Oak Creek draws out the dynamic energy of nature throughout the site. Gathering spaces and respite nodes weave in an out within the open areas to provide spaces with varying levels of activity while preserving the Oak Creek floodway and viewsheds towards the rock formations and Oak Creek.

# THE LAND USE

Design intent is in reverence to the agricultural roots of Sedona. The indigenous people and the early settlers had strong connections to their adjacent natural environment. The proposed site plan extends that aspect through clustering of buildings, integrating them while utilizing context sensitive materials and colors, promoting ground permeability and celebrating existing site remnants.

# THE CIRCULATION

Site circulation takes into account access to the adjacent natural environment and access through/along the site in order to further integrate the site to Oak Creek, existing trail network, and external natural icons.

# THE COMMUNITY

## Energy

The swirling energy fields of Sedona's vortexes inspired the design of the preserved areas to create avenues for spiritual healing and rejuvenation. The site is designed to encourage deeper connection to one's self, creating a sense of inner peace and truly immersing the body into nature.


### Ari

Sedona takes pride in their skilled artisans and the rich craftsmanship they possess. Landscape components pay homage to the different art forms Sedonian artists offer, making them significant points of interests throughout the site.







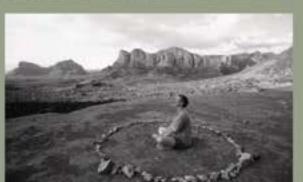





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R.D.OLSON DEVELOPMENT 2018 MARRIOTT PARTNERSHED







### RICHARD HUBBELL & ASSOCIATE MI SOLDERS MISS ROAD SECONA, AZ MAJON

SEDORIA, AZ ARION /SZB1 282-9477 CONTACT: ASCHARGO HUMBELL

HAMMES SURVEYING LCC 100 VIA SEMBADO CAMP VEXDE, AZ MIZZZ (NOSE JAIZ 1608)

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Oak Creek Heritage Lodge

COMPREHENSIVE DESIGN SUBMITTA

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# THE SCHNEBLY CFAPLICATION

The goals, objectives, and strategies recommended within the Schnebly Community Focus Area Plan guide the development of Oak Creek Heritage Lodge. The following images and text illustrate application of these principles within the proposed landscape and site design.

# THE ENVIRONMENT

# 1. SITE PRESERVATION:


- The existing site conditions are being preserved to retain its unique, pastoral, agricultural and historic characteristics.
- Proposed circulation and spaces celebrate the spiritual environment and unique locations naturally existing on site: light and shade; prospect and refuge; sculptural installations create points of interest to explore; and destination spaces that honor site ecology.
- Proposed plant materials are native to the area with low water usage, are drought tolerant and freeze resistant. These promote environmental stewardship and will help maintain the natural character of the site.

# OAK CREEK FLOODWAY PRESERVATION:

- The floodway is preserved as Open Space and includes only temporary improvements to protect natural riparian habitat along the creek/tributary washes, to accommodate flooding, and to provide wildlife habitat.
- The proposed drainage approach seeks to leave natural creek drainage unaltered by maximizing local site percolation.

# 3. VIEWSHED PRESERVATION:

 Existing viewsheds are protected through appropriate placement of buildings, trees, and outdoor spaces.

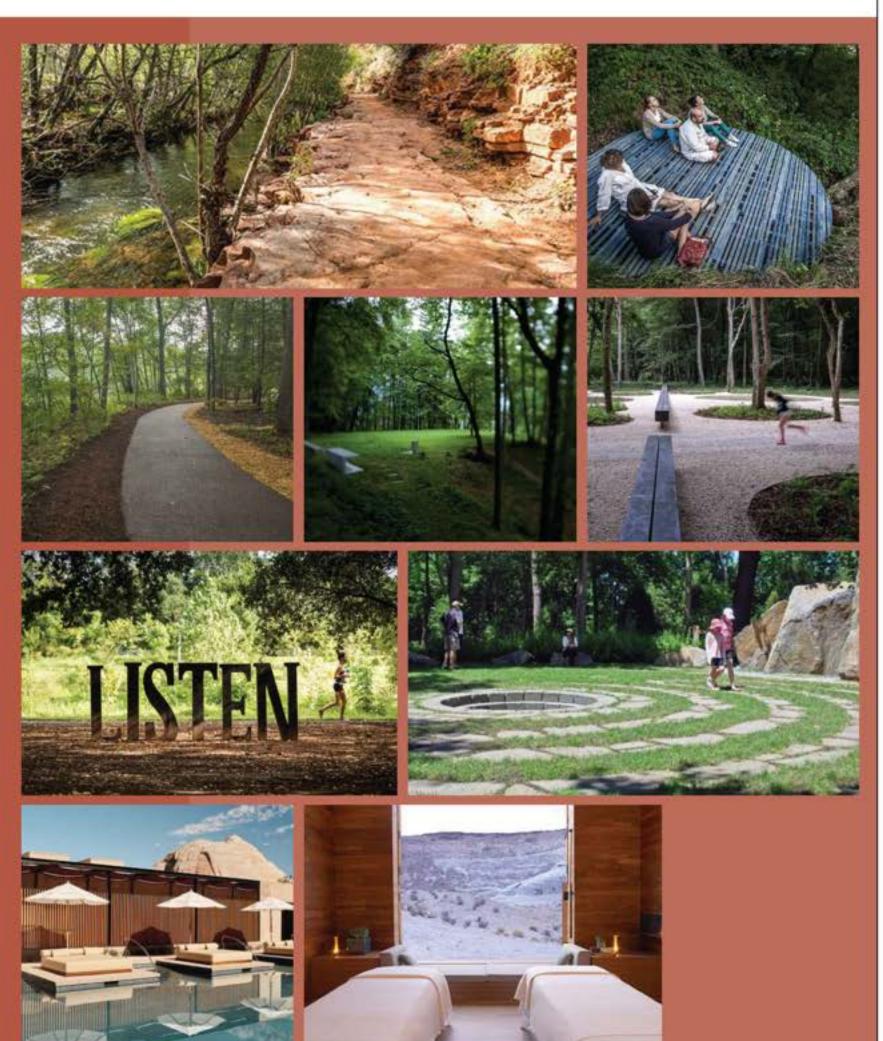

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COMPREHENSIVE DESIGN SUBMITTA

SCHNEBLY CFA PLAN: ENVIRONMENT

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# ENVIRONMENT

OPEN SPACE PRESERVATION VIEWSHED PRESERVATION FLOODWAY PRESERVATION









# LEGEND

PROPOSED OPEN SPACE

OPEN AREA - VIEWSHEDS

OPEN AREA - LANDSCAPE

PRESERVED TREES

FLOODWAY DG PATHWAYS

FLOODWAY DG RESPITES

FLOODWAY LAWN



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Oak Creek Heritage Lodge

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MARCH 14TH, 2023

OPEN SPACE, teet title VIEWSHED AND FLOODWAY PRESERVATION

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# THE SCHNEBLY CFAPLICATION

The project site, located within the heart of Sedona, seeks to preserve the Oak Creek riparian corridor and sustain the distinct historic context and character of the area. A series of site development strategies including maintaining existing trees, minimizing grading, preserving and celebrating the historical remnants on site, and clustering modestly scaled buildings help accomplish this critical goal

# THE LAND USE

# 1. CLUSTERING OF BUILDINGS:

 Multiple small building form organic clusters to ensure harmony with the surroundings, reduce impervious footprint and preserve larger area of connected open space.

# 2. SITE INTEGRATION:


- · Buildings will be integrated with the site through use of understated architectural styles, complementary colors and rustic materials to create a unique sense of place.
- Proposed planting palette will respond to the distance from the riparian zone and create moments of orchard planting in respect to the agrarian history.
- Flexible and open space oriented programmed spaces are proposed with minimal treatment and natural materials.


# 3. CELEBRATION OF EXISTING SITE REMNANTS:

 Protect on-site historical components and create interpretive site elements that celebrate agricultural remnants such as water channel and wells.

# 4. GROUND PERMEABILITY:

· All paving materials are proposed to be permeable in order to allow maximum water infiltration and maintain a natural feel of the site.

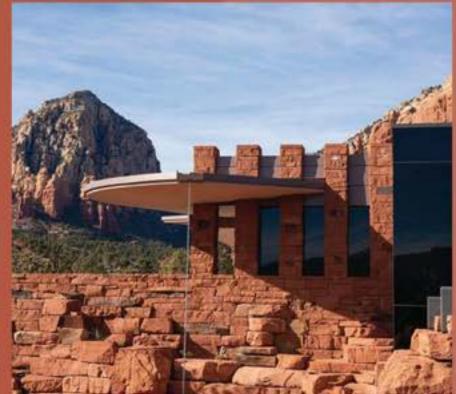

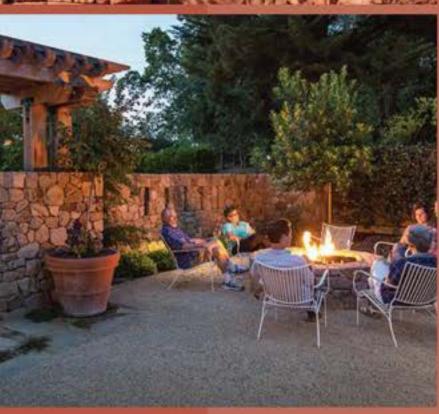







strategy planning architecture landscape









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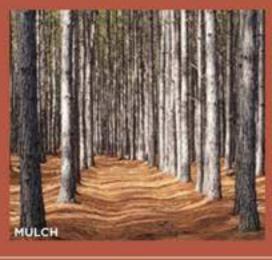
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LAND USE (Cont.) //GROUND PERMEABILITY

WITHIN OPEN SPACE

























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### RICHARD HUBBELL & ASSOCIATES

HAMMES SURVEYING LCC 2000 YOA SELVERADO CAMP VERDE, AZ HISTO (902 382 0698 CONTACT: ESM NAMINES 7 NAMIQUINE, COM

PROJECT TEAM

Oak Creek Heritage Lodge

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SCHNEBLY CFA PLAN SITE PERMEABILITY

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# LUSE I

BUILDING CLUSTERING GATHERING COURTYARDS

# LEGEND

PROPOSED OPEN SPACE

OPEN AREA - LANDSCAPE

OAK CREEK

BUILDING CLUSTERS

GATHERING COURTYARDS

EXISTING IRRIGATION CHANNEL

EXISTING WELL

# NOTES:

- SMALL BUILDINGS ARE CLUSTERED TO MAINTAIN THE EXISTING AGRARIAN APPEARANCE OF THE SITE, THIS ALLOWS A LARGE AND CONTIGUOUS OPEN SPACE AREA ALONG SCHNEBLY HILL ROAD.
- INSTEAD OF ONE LARGE BUILDING, SEVERAL SMALLER BUILDINGS ARE CLUSTERED TO FORM THE SOUTH CLUSTER, CENTRAL CLUSTER, NORTH CLUSTER AND WEST CLUSTER.
- THE FOUR BUILDING CLUSTERS PROPOSED .
   FORM FLEXIBLE COURTYARD SPACES WITH LIGHT PROGRAMMING FOR COMMON USE.



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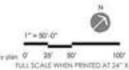
# RICHARD HUBBELL & ASSOCIATES

ME SOLDERS PASS ROAD SECONA, AZ MUSIE /9081-282-9477 CONTACT: ASCHARD HUMBELL

### HAMMES SURVEYING LCC

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PROJECT TEAM



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Oak Creek Heritage Lodge

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SCHNEBLY CFA PLAN LANDUSE OVERLAY

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Page 13 of 80

Education of the beauty and history of this land is important to grow local and tourist stewardship of the land. This private space will provide public


# THE CIRCULATION

# 1. TRAIL CONNECTIVITY:

- · A meandering trail is proposed along Schnebly Hill Road and the future access easement along the western edge connects residents and visitors to destinations within the neighborhood and to Uptown.
- Along Schnebly Hill Road, an 8'-0" wide trail allows for safe pedestrian and bike circulation and connects it with the rest of CFA. The trail is reduced to 6' to maneuver around existing trees that are protected in place. Trail splits in to two 4' wide section around steep terrain that may need excessive grade manipulation.
- A 12' wide access easement along the western edge provides future accessibility.
- · Bike racks are provided at public buildings to promote bike circulation.

# 2. ENVIRONMENTAL STEWARDSHIP:

- Signage will be proposed along the trail to educate the public on Oak Creek and overall environmental stewardship.
- Signage will be utilized to signal entry into sensitive site areas and to bring awareness to Oak Creek, preserved site elements and the cultural history of the site.

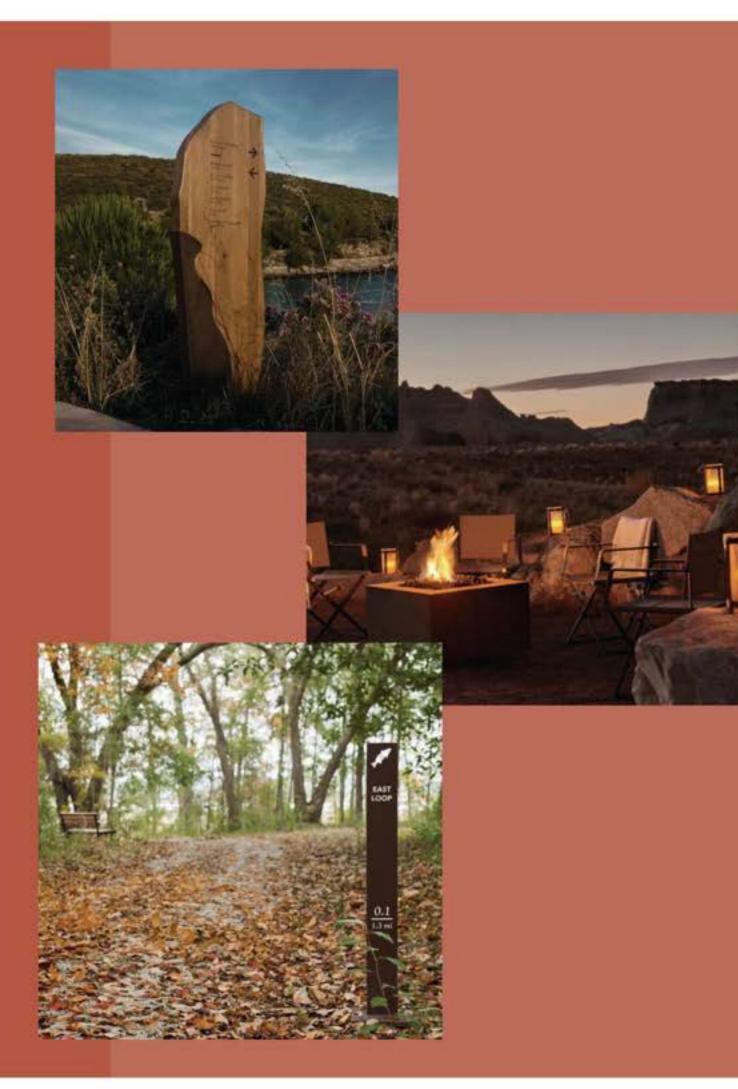

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## RICHARD HUBBELL & ASSOCIATES

### HAMMES SURVEYING LCC

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SCHNEBLY CFA PLAN: CIRCULATION

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# CIRCULA TION

PUBLIC TRAILS

# LEGEND

PROPOSED OPEN SPACE

OPEN AREA - LANDSCAPE


----- EXISTING IRRIGATION CHANNEL

EXISTING WELL

PROPOSED TRAIL

### NOTES:

- 1. A CONNECTED TRAIL SYSTEM IS PROVIDED ALONG SCHNEBLY HILL ROAD AND BEAR WALLOW LANE THAT CONNECTS THROUGH THE NEIGHBORHOOD TO A PROPOSED 12' WIDE EASEMENT ALONG THE WESTERN EDGE.
- 2. THE SCHNEBLY HILL TRAIL WILL CONNECT SOUTHWARDS WITH SR 179 ROUNDABOUT AND TRAVEL NORTHWARDS TOWARDS THE HUCKABY TRAILHEAD.
- 3. THE TRAIL ALONG SCHNEBLY HILL ROAD IS PROPOSED TO BE SET BACK FROM THE ROAD EXCEPT IN AREAS WHERE EXISTING TREES, SLOPES AND IRRIGATION DITCHES ARE PRESERVED.
- 4. INTERPRETIVE SIGNAGE WILL BE PROVIDED ALONG THE TRAIL WITH INFORMATION TO PROMOTE HISTORICAL AND CULTURAL AWARENESS ABOUT THE AREA AND OAK CREEK.

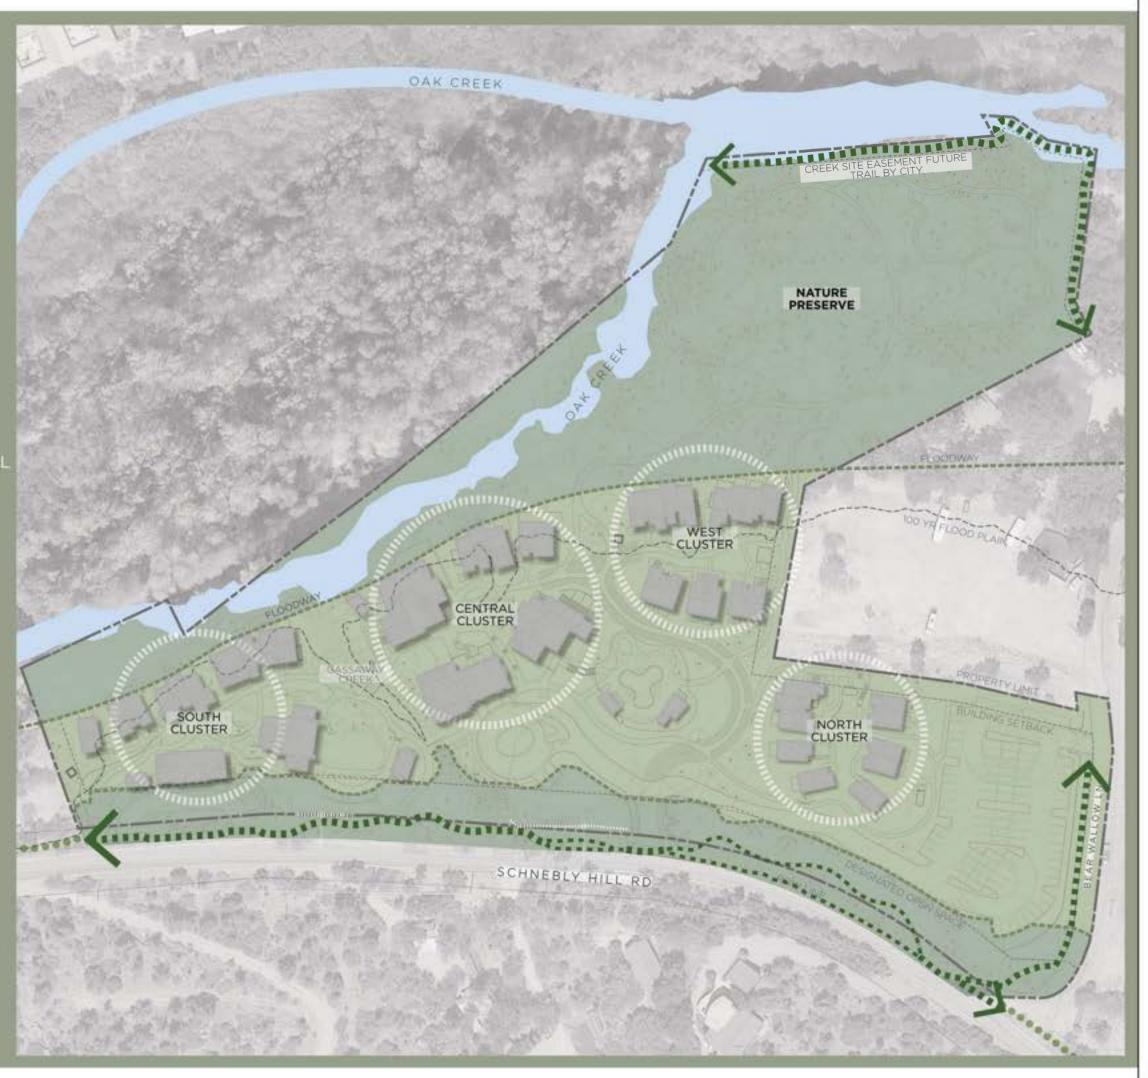

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### RICHARD HUBBELL & ASSOCIATES

BE SOLDIERS PASS ROAD SECONA, AZ BILINE /SZEI 282-9477 CONTACT: ALCHARD HUBBELL

### HAMMES SURVEYING LCC

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Oak Creek Heritage Lodge

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SCHNEBLY CFA

CIRCULATION OVERLAY

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Page 15 of 9

Page 15 of 80

# THE SCHNEBLY CEAPPLICATION

Education of the beauty and history of this land is important to grow local and tourist stewardship of the land. This private space will provide public utility in order to serve its local community and Sedona as a whole.

# THE COMMUNITY

# 1. SITE AWARENESS:

- Interpretive signage will be provided to signal entry into historically important and sensitive site areas such as the lawn area over Brown Residence.
- · Interpretive signage will be used to educate the public.

# 2. HERITAGE CELEBRATION:

- Trails run along and towards the irrigation channel for public use to highlight this historical remnant. Small orchard are added in proximity to highlight the location.
- The historical well and irrigation ditches are being preserved in place with trails/overlook proposed for visual access and appreciation.



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R.D.OLSON DEVELOPMENT







### RICHARD HUBBELL & ASSOCIATES

ME SOLDERS MISS BOAD SECONAL AZ 88338 (928) 282-9477 CONTACT - RICHARD HUMBELL

# HAMMES SURVEYING LCC

00 VIA EE HERADO CAMP VERDE. AZ RESZ. (VIDEL 202-5698 EDWITACT: ERW WANNES

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Oak Creek Heritage Lodge

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SCHNEBLY CFA PLAN: COMMUNITY

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design narrative

# THE SCHNEBLY CFA PLAN STRATEGIES SUMMARY

# **ENVIRONMENT**

### A. PROTECTION OF OAK CREEK

- Only minor improvements are proposed within floodway.
- 2 Gassaway Creek drainageway is preserved

### B. PRESERVATION OF OPEN SPACE

- Designated Open Space along Schnebly Hill Roal includes a meandering DG trail.
- Proposed site design retains a large majority of existing native trees on site. Undisturbed open areas at several locations are left to maintain existing vegetation in its native state. See Plantir Plan.
- Single story buildings are located on higher ground and nestled in landscape to preserve scenic views from Uptown/Highway 89.
- 4. Floodway is preserved as Open Space
- The trail meandering along Schnebly Hill Road is a wide or splits in 2-4' sections to preserve existing trees. Walks are reduced to 4' around preserved trees and slopes.

# LAND USE

# C. SENSE OF PLACE

- Small buildings are clustered to preserve open space to be contiguous with adjacent parcels.
- Multiple smaller buildings are structured to save existing trees and form common courtvard spaces.
- 3. Buildings are setback from the road and nestled in
- Walls and buildings utilize natural materials such as stone, wood and metal and designed to have a residential appearance.
- The site utilizes permeable materials such pavers, dg, and gravel for infiltration and a agrarian look.

# COMMUNITY

## D. HISTORIC PRESERVATION

- The existing irrigation ditches and wells are preserved with open areas provided on all sides. Trails and walks are provided for visual access to these remnants.
- Interpretive signs will be provided to pay homage to and learn about the area's history.

# CIRCULATION

## E. BICYCLE AND PEDESTRIAN NETWORK

- The meandering trail proposed along the road is setback for safety and links SR 179 roundabout towards Huckaby Trailhead.
- Bike racks are proposed by public buildings to promote bike circulation. A 12' wide creek site easement with interpretive signage and a potential footbridge is proposed along the western edge.



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# RICHARD HUBBELL & ASSOCIATES

BE SOLDIERS PASS ROAD SECONA, AZ BILINE /SZEI 282-9477 CONTACT: ALCHARD HUBBELL

### HAMMES SURVEYING LCC

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> Oak Creek Heritage Lodge

COMPREHENSIVE DESIGN SUBMITTAL MARCH 14TH, 2023

SCHNEBLY CFA PLAN STRATEGIES SUMMARY

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Page 17 of 80



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# RICHARD HUBBELL & ASSOCIATES

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Oak Creek Heritage Lodge

COMPREHENSIVE DESIGN SUBMITTAL MARCH 14TH, 2023

sheet title LANDSCAPE PLAN OVERALL

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# SCREENING

Per Sedona Land Development Code Section 5.6 Landscaping, Buffering, and Screening, the following screening elements are being provided at the proposed parking lot along Bear Wallow Lane:



SECTION A



# **WATG**

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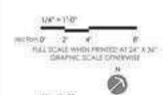




# RICHARD HUBBELL & ASSOCIATES

### HAMMES SURVEYING LCC

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LANDSCAPE PLAN BEAR WALLOW LANE SCREENING

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Page 19 of 80

# THE PLANT PALETTE

The proposed planting palettes are composed of native and adaptive plant species and derived from Section 5.6.C(1)b.1 of the Administrative Manual to blend with the site's surroundings and provide a naturalized experience to visitors.



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# RICHARD HUBBELL & ASSOCIATES

RESOLDERS PASS BOAD SEDORA, AZ 88338 (928) 282-9477 CONTACT: AJCHARD HUBBELL

HAMMES SURVEYING LCC

100 VIA SELVERADO CAMP VERDE. AZ BEJUJ (VURI JEZ-1606 EDISTACT: ESI HAARMES T.HAMBELYE.COM

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CONCEPT PLANTING

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As described within the Schnebly CFA Plan and the land development code, the proposed planting approach is structured around preservation of Oak Creek, the existing site terrain and trees. Blending the built and natural environments is a key goal for the city and the following design guidelines help accomplish those goals.

- Extend the existing riparian ecosystem into the site to integrate with the area's existing planting ecosystems while retaining undisturbed areas in their natural state. This helps promote optimum plant growth and maintain species diversity.
- Provide enhanced native planting palettes around gathering areas to allow a natural transition from planting oriented immersive spaces to functional zone.
- Incorporate orchards around the preserved irrigation channels to celebrate the agrarian lifestyle of the area.
- Compose proposed planting palettes of native and adaptive plant species are derived from Section 5.6.C(1)b.1 of the Design, Review, Engineering and Administrative Manual.
- Minimize lawn areas on site and provide specific programming functions for people gathering and events only.
- Propose new trees to maintain viewsheds through the site and towards the red rocks while preserving the existing to the greatest extent possible.

# PROPOSED TREE MATRIX

BOTANICAL NAME	COMMON NAME	WATER	MIN. SIZE	O.C. SPACING	FOLIAGE	AGE ZONES			
						RIPARIAN		NON-RIPARIAN TRANSITIONAL	ENHANCED
ACACIA CONSTRICTA	WHITETHORN ACACIA	L	8' TALL	PER PLAN	EVERGREEN				
ACER GRANDIDENTATUM	BIGTOOTH MAPLE	М	2" CALIPER	PER PLAN	DECIDUOUS			4	
BACCHARIS SALICIFOLIA	SEEPWILLOW	L	2" CALIPER	PER PLAN	DECIDUOUS				
CELTIS RETICULATA	NEATLEAF HACKBERRY	L	2" CALIPER	PER PLAN	DECIDUOUS				
CERCIS OCCIDENTALIS	WESTERN REDBUD	M	2" CALIPER	PER PLAN	DECIDUOUS		5		
CHILOPSIS LINEARIS	DESERT WILLOW		2" CALIPER	PER PLAN	DECIDUOUS				
CORNUS SERICEA .	RED OSIER DOGWOOD	M	2" CALIPER	PER PLAN	DECIDUOUS				
CUPRESSUS GLABRA	SMOOTHBARK ARIZONA CYPRESS	L	8 TALL	PER PLAN	EVERGREEN				
RAXINUS VELUTINA	ARIZONA ASH	M	2" CALIPER	PER PLAN	DECIDUOUS				
IUGLANS MAJOR	ARIZONA WALNUT	M	2" CALIPER	PER PLAN	DECIDUOUS				
JUNIPERUS DEPPEANA =	ALLIGATOR JUNIPER	L	8' TALL	PER PLAN	EVERGREEN				
JUNIPERUS OSTEOSPERMA ■	UTAH JUNIPER	L	8' TALL	PER PLAN	EVERGREEN				
EUCAENA RETUSA	GOLDEN LEADBALL TREE	L	2" CALIPER	PER PLAN	DECIDUOUS	-			
ALUS DOMESTICA	APPLE TREE	M	2" CALIPER	PER PLAN	DECIDUOUS				-
PINUS EDULIS =	PINYON PINE	L	8 TALL	PER PLAN	EVERGREEN				
PLATANUS WRIGHTII	ARIZONA SYCAMORE	L	2" CALIPER	PER PLAN	DECIDUOUS				
OPULUS FREMENTII	FREMONT COTTONWOOD	M	2" CALIPER	PER PLAN	DECIDUOUS				
PRUNUS PERSICA	PEACH TREE	M	2" CALIPER	PER PLAN	DECIDUOUS				
PRUNUS DULCIS	ALMOND TREE	M	2" CALIPER	PER PLAN	DECIDUOUS				
PROSOPIS VELUTINA	VELVET MESQUITE		2" CALIPER	PER PLAN	DECIDUOUS				
QUERCUS ARIZONICA .	ARIZONA WHITE OAK		8 TALL	PER PLAN	EVERGREEN				
QUERCUS CHRYSOLEPIS	CANYON LIVE OAK	L	8' TALL	PER PLAN	EVERGREEN				
QUERCUS EMORYI	EMORY OAK	L, M	2" CALIPER	PER PLAN	DECIDUOUS				
QUERCUS GAMBELII =	GLAMBEL OAK	L	2" CALIPER	PER PLAN	DECIDUOUS				
ALIX GOODDINGII	GOODINGS WILLOW	M	2º CALIPER	PER PLAN	DECIDUOUS				
ALIX LAEVIGATA	RED WILLOW	H	2" CALIPER	PER PLAN	DECIDUOUS				
APINDUS SAPONARIA VAR. DRUMMONDII	WESTERN SOAPBERRY	L	2" CALIPER	PER PLAN	DECIDUOUS				
OPHORA SECUNDIFOLIA	TEXAS MOUNTAIN LAUREL	L. M	8' TALL	PER PLAN	EVERGREEN				

# PROPOSED SHRUB MATRIX

BOTANICAL NAME	COMMON NAME	WATER	MIN. SIZE	O.C. SPACING	ZONES				
					RIPARIAN		NON-RIPARIAN TRANSITIONAL	ENHANCED	
MELANCHIER UTAHENSIS =	UTAH SERVICE BERRY	M	2' TALL	12"					
NISACANTHUS QUADRIFIDUS 📮	DESERT HONEYSUCKLE	- 1 TO 1	2" TALL						
RCTOSTAPHYLOS PRINGLEI	PRINGLES MANZANITA	VL.	2' TALL	1.5'					
RTEMISIA POWIS CASTLE	POWIS CASTLE SAGE	L, M	2'TALL						
FRIPLEX CANESCENS	FOUR-WING SALTBUSH								
ACCHARIS PILULARIS 🔼	COYOTE BRUSH	L	2' TALL	6'					
ACCHARIS SAROTHRIODES =	DESERT BROOM	VL, L	2' TALL						
RBERIS FREMONTII	FREMONT BARBERRY	VL	2° TALL						
AESALPINIA GILLIESII 📒	YELLOW BIRD-OF-PARADISE	L, M	2' TALL	101					
ALLIANDRA ERIOPHYLLA 📮	FAIRY DUSTER	L	2' TALL	3'					
EANOTHUS INTEGERRIMUS	BUCKBRUSH	VL	2' TALL	5"					
ERCOCARPUS BREVIFLORUS	MOUNTAIN MAHOGANY	VL, L	2' TALL	15'					
HAMAEBATIARIA MILLEFOLIUM =	FERNBUSH	L	2' TALL	5'					
RYSACTINIA MEXICANA	DAMIANITA	L	2' TALL	2'					
ALEA FORMOSA	FEATHER DALEA	M	2' TALL	2.5'					
ALEA FRUTESCENS	BLACK DALEA	L	2' TALL	5'					
PHEDRA VIRIDIS	MORMON TEA	L, M	2 TALL						
RICAMERIA LARICIFOLIA	TURPENTINE BUSH		2' TALL	3'					
ALLUGIA PARADOXIA	APACHE PLUME	VL, L	2º TALL	5'					
DRESTIERA NEOMEXICANA	NEW MEXICO OLIVE	L, M	2'TALL	12'					
RANGULA CALIFORNICA .	CALIFORNIA BUCKHORN	VL. L	2' TALL	8'					
ARRYA WRIGHTII	WRIGHT'S SILKTASSEL	L.	2' TALL						
JTIERREZIA SAROTHRAE	SNAKEWEED	L.	2' TALL	1.5'					
RREA TRIDENTATA	CREOSOTE	L L	2' TALL	6'					
UCOPHYLLUM FRUTESCENS	TEXAS RANGER	L, M	2' TALL	6'					
CIUM PALLIDUM	THREE LEAF SUMAC	M	2' TALL	6'					
ELEA TRIFOLIATA	HOP TREE	VL, L, M	2' TALL	10'					
JRSHIA STANSBURIANA	CLIFF ROSE	L	2' TALL						
JERCUS TURBINELLA	SCRUB OAK		2' TALL	10'					
IUS TRILOBATA	SPANISH LAVENDER	L	2' TALL	2.5'					
BES AUREUM .	GOLDEN CURRANT	L, M, H	2 TALL						
DSMARINUS OFFICINALIS	ROSEMARY	L, M	2' TALL						
LVIA GREGGII	AUTUMN SAGE	L	2' TALL						
ANTOLINA CHAMAECYPARISSUS	GRAY SANTOLINA	L	2' TALL						
MPHORICARPUS ROTUNDIFOLIUS	ROUNDLEAF SNOWBERRY	L, M	2' TALL	2.5'					

CACTI AND SUCCULENTS								
BOTANICAL NAME	COMMON NAME	WATER	TER MIN. SIZE	O.C. SPACING	ZONES			
					RIPARIAN		NON-RIPARIAN TRANSITIONAL	ENHANCED
AGAVE PARRYII .	PARRY'S AGAVE		2' TALL	3.5'				
AGAVE WEBERI	WEBER'S AGAVE	L	2' TALL	8'				
CYLINDROPUNTIA LEPTOCAULIS	DESERT CHRISTMAS CACTUS		2' TALL	3'				
CYLINDROPUNTIA WHIPPLE	WHIPPLE CHOLLA	L	2' TALL	3.5'				
FOUQUIERIA SPLENDENS	OCOTILLO		2' TALL	2.5'				
HESPERALOE PARVIFLORA	RED YUCCA	- 1 L	2' TALL	5'				
NOLINA MICROCARPA	BEARGRASS	L	2' TALL	5'				
OPUNTIA ENGELMANNII	ENGELMANNS PRICKLY PEAR	L	2' TALL	4.5'	2			
OPUNTIA PHAEACANTHUS	BROWNSPINE PRICKLY PEAR	L L	2' TALL	3'			Ţ:	
OPUNTIA SANTA-RITA	SANTA RITA PRICKLY PEAR	L	2' TALL	10'				
YUCCA BACCATA	BANANA YUCCA		2' TALL	5'				
YUCCA ELATA .	SOAPTREE YUCCA	L	2' TALL	5'				

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2018 MARRIOTT PARTMERSH CIRCLE ANARD WINNER







# RICHARD HUBBELL & ASSOCIATES

HAMMES SURVEYING LCC

JT00 VPA SELVERADO CAMP VERDE, AZ BILSTJ (808) JRJ-5686 CONSACT: TIN HAMBES T. HAMBLEYE COM

PROJECT TEAM

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Oak Creek Heritage Lodge

COMPREHENSIVE DESIGN SUBMITTAL MARCH 14TH, 2023

CONCEPT sheet title PLANTING MATRIX

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Page 21 of 80

# EXISTING TREE INVENTORY PLAN

In compliance to Section 5.6 (Landscaping, Buffering, and Screening) of the Land Development Code, a large number of existing trees are being saved on the project site. The buildings and site circulation are designed to maximize on-site tree preservation. A few existing trees considered invasive are suggested for removal to make sure they do not continue to propagate.

# Considerations

- Being that most trees on site are deciduous, exact tree species identification on some trees was difficult without leaves, and species should be considered approximate.
- GPS accuracy is affected when under tree stands and locations are approximate.

# Tree Characteristics and Site Conditions

 The trees within the riparian zones lie mostly untouched in their natural setting. The area contains large amounts of volunteers from

SCHNEBLY HILL RD

natural tree reproduction habits over the years

Streets and open fields contain many native trees that have largely remained untouched aside from clearance pruning from streets, utilities, driveways, etc.

### Around the structures, many deliberately planted trees exist and appear to have been maintained

over the years.
Overall, the health of the entire stand of trees throughout the property is well above average when taking the setting into consideration.

### **Development Impact**

- As with all construction projects, construction that takes place in areas where trees are currently standing will require relocation or removal of select trees. There are many trees on site which would not reasonably be recommended to be boxed up and relocated due to health, structure, and species; although this is likely subject to local ordinance.
- Trees that stand near future structure or hardscape construction should have tree protection zones (TPZ) established to manage impact to the trees both above (canopy), and below ground (root system).

# **LEGEND**

# TREES TO BE PROTECTED IN PLACE - 525

192 • EXCELLENT CONDITION 37%

9 GOOD CONDITION 13%

258 FAIR CONDITION 50%

NOT

QUANTITIES OF TREES TO BE PROTECTED IN PLACE ARE SUBJECT TO FINAL DEVELOPMENT PLANS / UTILITY DESIGN.

# NON-SALVAGEABLE TREES - 291

87 POOR CONDITION

204 DEAD, DISEASED DYING OR FALLING
SUGGESTED FOR REMOVAL BASED ON CITY QUIDELINE

# **SALVAGEABLE TREES - 128**

128 REMOVE OR POTENTIAL FOR RELOCATION
29 IN EXCELLENT CONDITION
33 IN GOOD CONDITION
66 IN FAIR CONDITION

# **TOTAL ON-SITE TREE COUNT - 944**

# LANDSCAPE TREE CREDIT CALCULATION

### REQUIRED:

FLOOD WAY

865 AT ONE TREE PER EVERY 400 SQ. FT. OF 345,900 SQ. FT. LANDSCAPE AREA

269 SALVAGEABLE TREE REMOVED BE CREDITED PER TABLE 5.5

1,134 TOTAL TREE CREDIT REQUIRED

### PROVIDED:

1,714 TOTAL EARNED CREDIT FOR PRESERVING TREES

90 ESTIMATED NEW PROPOSED TREE

10 RELOCATED EXISTING TREE

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### RICHARD HUBBELL & ASSOCIATES AN SOLUMEN MEN AGAD

SEDONA, AZ BILTAL (908) 282-6477 CONTACT: RICHARD HUMBELI

# HAMMES SURVEYING LCC

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PROJECT TEAM



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> Oak Creek Heritage Lodge

COMPREHENSIVE DESIGN SUBMITTAL MARCH 14TH, 2023

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Page 22 of 80

# SITE TREE PLAN SCALE: 17-507 0 297 507 1907 1907 FULL SCALE WHEN PRINTED AT 24" X 36" GRAPHIC SCALE OTHERWISE

# **CODE COMPLIANCE CHARTS**

PLANT MATERIAL QUANTITY COMPLIANCE

(1 TREE AND 3 SHRUBS PER 400SF OF LANDSCAPE AREA)

NET LANDSCAPE AREA: 345,900 SF

TREES REQUIRED: 865

TREES PROPOSED 100 (PRESERVED CREDIT 1714)

V 40 4 14

SCHNEBLY HILL RD

SHRUBS REQUIRED: 2,595 SHRUBS PROPOSED 2,870

NATIVE AND NON-NATIVE COMPLIANCE

(REQUIRED: 75% OF ALL PLANTS MUST BE NATIVE)

NATIVE NON NATIVE TOTAL TREES 82 18 100 SHRUBS 2,471 2,870 TOTAL TREES AND SHRUBS 2,970

PERCENTAGE OF NATIVE PLANTS PROVIDED 86%

LAWN % COMPLIANCE

% ALLOWED: 10% MAXIMUM

% PROVIDED: 1.68% (5,800 SF OF A TOTAL 345,900 SF NET LANDSCAPE AREA)

# PARKING LOT LANDSCAPE COMPLIANCE

PARKING SPACES AND ADJACENT LOT AREA	REQUIRED LANDSCAPING	LANDSCAPE PROVIDED
27,815 SF	10% (2,781 SF)	11% (3,162 SF)
PROVIDE MINIMUM ONE TREE PER 400 SQ. FT	PARKING LOT TREE REQUIRED	PARKING LOT TREE PROVIDED
		1

3,162 SF OF PARKING LOT LANDSCAPE

CUPRESSUS ARIZONICA GLABRA ARIZONA CYPRESS NATURE PRESERVE • NATURE PRESERVE . AREA WILL RECEIVE

FLOOD WAY

100 YEAR FLOOD PLAIN

TREE LEGEND

RUBS	BOTANICAL / COMMON NAME	QTY	REMARKS
9	AGAVE PARRYI PARRY'S AGAVE	36	NATIVE
0	AGAVE WEBERI WEBER AGAVE	3	ADAPTIVE
•	AMELANCHIER UTAHENSIS UTAH SERVICEBERRY	11	NATIVE
0	ANISACANTHUS QUADRIFIDUS DESERT HONEYSUCKLE	64	ADAPTIVE
0	ARCTOSTAPHYLOS PRINGLEI PRINGLE MANZANITA	62	NATIVE
0	ARTEMISIA X 'POWIS CASTLE' POWIS CASTLE ARTEMISIA	39	ADAPTIVE
0	ATRIPLEX CANESCENS FOURWING SALTBUSH	27	NATIVE
0	BACCHARIS PILULARIS COYOTE BRUSH	52	ADAPTIVE
<b>(A)</b>	BACCHARIS SAROTHROIDES DESERTBROOM BACCHARIS	13	NATIVE
0	CAESALPINIA GILLIESII YELLOW BIRD OF PARADISE	4	ADAPTIVE
<b>(4)</b>	CALLIANDRA ERIOPHYLLA FAIRY DUSTER	16	ADAPTIVE
₩	CEANOTHUS INTEGERRIMUS DEER BRUSH	66	NATIVE
	CYLINDROPUNTIA WHIPPLEI WHIPPLE CHOLLA	3	NATIVE
•	DALEA GREGGII TRAILING INDIGO BUSH	99	ADAPTIVE
$\oplus$	EPHEDRA VIRIDIS MORMON TEA	46	NATIVE
0	ERICAMERIA LARICIFOLIA TURPENTINE BUSH	98	NATIVE
0	FALLUGIA PARADOXA APACHE PLUME	27	NATIVE
1	FORESTIERA NEOMEXICANA NEW MEXICO PRIVET	8	NATIVE
0	FOUQUIERIA SPLENDENS OCOTILLO	11	NATIVE
<b>(</b>	LARREA TRIDENTATA CREOSOTE BUSH	11	NATIVE
8	LEUCOPHYLLUM FRUTESCENS TEXAS SAGE	39	ADAPTIVE
<b>6</b>	NOLINA MICROCARPA SACAHUISTA	100	NATIVE
8	OPUNTIA ENGELMANNII ENGELMANN'S PRICKLY PEAR	23	NATIVE
<b>(</b>	PURSHIA STANSBURIANA STANSBURY CLIFFROSE	20	NATIVE
( <del>+</del> )	QUERCUS TURBINELLA SONORAN SCRUB OAK	7	NATIVE
<b>®</b>	YUCCA BACCATA BANANA YUCCA	9	NATIVE
•	YUCCA ELATA SOAPTREE YUCCA	10	NATIVE
	ARCTOSTAPHYLOS UVA-URSI	25%	NATIVE
	BERBERIS FREMONTII	10%	NATIVE
	FREMONT BARBERRY  CHRYSACTINIA MEXICANA	2%	ADAPTIVE
	DAMIANITA  GARRYA WRIGHTII  WRITGHT'S SILKTASSEL	20%	NATIVE
	JUNIPERUS HORIZONTALIS CREEPING JUNIPER	25%	NATIVE

RHUS TRILOBATA THREE LEAF SUMAC

RIBES AUREUM GOLDEN CURRANT

41,400 SF OF ENHANCED SHRUB AREA

7,760 SF OF RIPARIAN SHRUB AREA

5,800 SF

1. THE HATCHED AREAS WILL BE INSTALLED AT A RATE OF 10 SHRUBS/ GROUNDCOVERS PER 250 SF

- UPON FINAL SITE HARDSCAPE CONSTRUCTION AND GRADING, THE LANDSCAPE ARCHITECT SHALL EVALUATE THE REMAINING UNDISTURBED SHRUB/GROUND COVER DENSITY AND LOCATIONS TO DETERMINE AREAS TO RECEIVE NEW PLANTINGS.
- 75% OF TREES IN PARKING LOT ARE DECIDUOUS CANOPY TREES.
- IN-ORGANIC TOP-DRESSING 3/4" MINUS 1/2" DEEP CRUSHED RED ROCK OVER ALL LANDSCAPE AND/OR DISTURBED AREAS.
- 5. ALL LANDSCAPE AREAS SHALL RECEIVE PERMANENT UNDERGROUND IRRIGATION SYSTEM.









# RICHARD HUBBELL & ASSOCIATES

# HAMMES SURVEYING LCC

2000 VAN ER HERADIO CAMP VERDIC, AZ BESTZ (9282 362-5686 EDBITACT: ERH HAMMES 7 JAMMELIYE COM

PROJECT TEAM



FULL SCALE WHEN PRINTED AT 34" X 36" GRAPHIC SCALE OTHERWISE no. date issue

> Oak Creek Heritage Lodge

COMPREHENSIVE DESIGN SUBMITTAL MARCH 14TH, 2023

sheet title PLANTING PLAN OVERALL

shecked by: KY drawn by: AC





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CIRCLE AMARD WINNER







# RICHARD HUBBELL & ASSOCIATES

### HAMMES SURVEYING LCC

2000 VOA ERIHERADIO CAMP VERDIC AZ BESTZ (VOSES DIZ-1686 ECONTACT: ERH WAMMES 7.74AMBELIVE.COM

PROJECT TEAM

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CLUSTER

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Page 24 of 80

# SOUTH CLUSTER PLANTING PLAN

TREE LEGEND

(1)

+

ACACIA CONSTRICTA WHITETHORN ACACIA

RAXINUS VELUTINA VELVET ASH

PROSOPIS VELUTINA VELVET MESQUITE





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2018 MARRIOTT PARTNERSI-CIRCLE AWARD WINNER







# RICHARD HUBBELL & ASSOCIATES

### HAMMES SURVEYING LCC

2000 VIA ERIMERADO CAMP VERDE, AZ MISTZ (VISE 382-5698 EDISTACT: ESH HAMMES 7 JAAMBUSYE,COM

PROJECT TEAM

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> Oak Creek Heritage Lodge

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**PLANTING** sheet title ENLARGEMENT SOUTH CLUSTER

project no. shecked by: KY

drawn by:

Page 25 of 80

# WEST CLUSTER PLANTING PLAN

ACACIA CONSTRICTA WHITETHORN ACACIA

CHILOPSIS LINEARIS DESERT WILLOW

RAXINUS VELUTINA VELVET ASH

PROSOPIS VELUTINA VELVET MESOUITE

UERCUS GAMBELII IAMBEL OAK

UNIPERUS OSTEOSPERM TAH JUNIPER

UPRESSUS ARIZONICA GLABRA RIZONA CYPRESS

SHRUB S	SCHEDULE BOTANICAL / COMMON NAME	TREE LE	GEND
•	AGAVE PARRYI PARRY'S AGAVE	74}	ACACIA C
<b>⊕</b>	AGAVE WEBERI WEBER AGAVE	mar	CERCIS O
•	AMELANCHIER UTAHENSIS UTAH SERVICEBERRY	1+1	WESTERN
0	ANISACANTHUS QUADRIFIDUS DESERT HONEYSUCKLE	(+)	CHILOPSI DESERT V
$\Diamond$	ARCTOSTAPHYLOS PRINGLEI PRINGLE MANZANITA	(+)	CUPRESS
0	ARTEMISIA X 'POWIS CASTLE' POWIS CASTLE ARTEMISIA		FRAXINUS
$\oplus$	ATRIPLEX CANESCENS FOURWING SALTBUSH	<b>(</b>	VELVET A
0	BACCHARIS PILULARIS COYOTE BRUSH		JUNIPERU UTAH JUN
<b>(a)</b>	BACCHARIS SAROTHROIDES DESERTBROOM BACCHARIS	(+)	PLATANU ARIZONA
0	CAESALPINIA GILLIESII YELLOW BIRD OF PARADISE		POPULUS
0	CALLIANDRA ERIOPHYLLA FAIRY DUSTER	<b>*</b>	FREMONT
*	CEANOTHUS INTEGERRIMUS DEER BRUSH	(+)	PROSOPI: VELVET N
$\Theta$	CYLINDROPUNTIA WHIPPLEI WHIPPLE CHOLLA	{+}	PRUNUS I
•	DALEA GREGGII TRAILING INDIGO BUSH	5+3	QUERCUS
$\Theta$	EPHEDRA VIRIDIS MORMON TEA	43	ARIZONA
0	ERICAMERIA LARICIFOLIA TURPENTINE BUSH	$\odot$	GAMBEL O
0	FALLUGIA PARADOXA APACHE PLUME	(2)	SALIX GO GOODDIN
$\bigcirc$	FORESTIERA NEOMEXICANA NEW MEXICO PRIVET	$\tilde{\bigcirc}$	SALVAGE
0	FOUQUIERIA SPLENDENS OCOTILLO		100000

**(III)** 

0

(#) •

LARREA TRIDENTATA CREOSOTE BUSH

NOLINA MICROCARPA SACAHUISTA

PURSHIA STANSBURIANA STANSBURY CLIFFROSE

YUCCA BACCATA BANANA YUCCA

YUCCA ELATA SOAPTREE YUCCA

ARCTOSTAPHYLOS UVA-URSI KINNIKNNICK BERBERIS FREMONTII FREMONT BARBERRY

CHRYSACTINIA MEXICANA DAMIANITA GARRYA WRIGHTII WRITGHT'S SILKTASSEL

JUNIPERUS HORIZONTALIS CREEPING JUNIPER

RHUS TRILOBATA THREE LEAF SUMAC

SALVIA GREGGII AUTUMN SAGE

DALEA FORMOSA FEATHER DALEA

RIBES AUREUM GOLDEN CURRANT

SYMPHORICARPUS R. ROUNDLEAF SNOWBEI

GARRYA WRIGHTII WRITGHT'S SILKTASSEL

LEUCOPHYLLUM FRUTESCENS TEXAS SAGE

THE HATCHED AREAS WILL BE INSTALLED AT A RATE OF 10 SHRUBS/GROUNDCOVERS PER 250 SF

UPON FINAL SITE HARDSCAPE CONSTRUCTION AND GRADING. THE LANDSCAPE ARCHITECT SHALL EVALUATE THE REMAINING UNDISTURBED SHRUB/GROUND COVER DENSITY AND LOCATIONS TO DETERMINE AREAS TO RECEIVE NEW PLANTINGS.

OPHORA SECUNDIFLORA EXAS MOUNTAIN LAUREL

75% OF TREES IN PARKING LOT ARE DECIDUOUS CANOPY TREES.

IN-ORGANIC TOP-DRESSING - 3/4" MINUS 1/2" DEEP CRUSHED RED ROCK OVER ALL LANDSCAPE AND/ OR DISTURBED AREAS.

ALL LANDSCAPE AREAS SHALL RECEIVE PERMANENT UNDERGROUND IRRIGATION SYSTEM.



# WATG

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### RICHARD HUBBELL & ASSOCIATES

### HAMMES SURVEYING LCC

2100 VIA SELERADO CAMP VERDE, AZ 86323 (VIAS JAZ-1688 CONTACT: THE NAMINES 7 JAMBELIVE, COM

PROJECT TEAM

1" = 20'-0"

key plan 0' 10' 20' FULL SCALE WHEN PRINTED AT 24" X 36" GRAPHIC SCALE OTHERWISE

no. date issue

# Oak Creek Heritage Lodge

COMPREHENSIVE DESIGN SUBMITTAL MARCH 14TH, 2023

**PLANTING** sheet title ENLARGEMENT WEST CLUSTER

project no

shecked by: KY drawn by:

# NORTH CLUSTER PLANTING PLAN

HRUBS	BOTANICAL / COMMON NAME
•	AGAVE PARRYI PARRY'S AGAVE
<b>(</b>	AGAVE WEBERI WEBER AGAVE
•	AMELANCHIER UTAHENSIS UTAH SERVICEBERRY
0	ANISACANTHUS QUADRIFIDUS DESERT HONEYSUCKLE
0	ARCTOSTAPHYLOS PRINGLEI PRINGLE MANZANITA
0	ARTEMISIA X 'POWIS CASTLE' POWIS CASTLE ARTEMISIA
$\oplus$	ATRIPLEX CANESCENS FOURWING SALTBUSH
0	BACCHARIS PILULARIS COYOTE BRUSH
<b>(a)</b>	BACCHARIS SAROTHROIDES DESERTBROOM BACCHARIS
0	CAESALPINIA GILLIESII YELLOW BIRD OF PARADISE
<b>⊕</b>	CALLIANDRA ERIOPHYLLA FAIRY DUSTER
₩	CEANOTHUS INTEGERRIMUS DEER BRUSH
$\Theta$	CYLINDROPUNTIA WHIPPLEI WHIPPLE CHOLLA
•	DALEA GREGGII TRAILING INDIGO BUSH
$\Theta$	EPHEDRA VIRIDIS MORMON TEA
0	ERICAMERIA LARICIFOLIA TURPENTINE BUSH
0	FALLUGIA PARADOXA APACHE PLUME
$\bigcirc$	FORESTIERA NEOMEXICANA NEW MEXICO PRIVET
0	FOUQUIERIA SPLENDENS OCOTILLO
<b>(III)</b>	LARREA TRIDENTATA CREOSOTE BUSH
8	LEUCOPHYLLUM FRUTESCENS TEXAS SAGE
0	NOLINA MICROCARPA SACAHUISTA
$\otimes$	OPUNTIA ENGELMANNII ENGELMANN'S PRICKLY PEAR
•	PURSHIA STANSBURIANA STANSBURY CLIFFROSE
(#)	QUERCUS TURBINELLA SONORAN SCRUB OAK
•	YUCCA BACCATA BANANA YUCCA
•	YUCCA ELATA SOAPTREE YUCCA
	ARCTOSTAPHYLOS UVA-URSI KINNIKNNICK

JUNIPERUS HORIZONTALIS CREEPING JUNIPER

RHUS TRILOBATA THREE LEAF SUMAC

SALVIA GREGGII AUTUMN SAGE DALEA FORMOSA FEATHER DALEA

RIBES AUREUM GOLDEN CURRANT

SYMPHORICARPUS R. ROUNDLEAF SNOWBERRY

REE LE	GEND BOTANICAL / COMMON NAME
	ACAGIA CONSTRICTA WHITETHORN ACACIA
(+)	ČERCIS OCCIDENTALIS WESTERN REDBUD
+>	CHILOPSIS LINEARIS DESERT WILLOW
(+)	CUPRESSUS ARIZONICA GLABRA ARIZONA CYPRESS
+	FRAXINUS VELUTINA VELVET ASH
8	JUNIPERUS OSTEOSPERMA UTAH JUNIPER
+)	PLATANUS WRIGHTII ARIZONA SYCAMORE
<del>(</del> +	POPULUS FREMONTII FREMONT COTTONWOOD
( <del>+</del> )	PROSOPIS VELUTINA VELVET MESQUITE
+	PRUNUS PERSICA PEACH
(+)	QUERCUS ARIZONICA ARIZONA WHITE OAK
$\odot$	QUERCUS GAMBELII GAMBEL OAK
D	SALIX GOODDINGII GOODDING'S WILLOW
$\overline{\odot}$	SALVAGE/TRANSPLANTED TREE
(0)	SOPHORA SECUNDIFLORA TEXAS MOUNTAIN LAUREL



# WATG

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2018 MARRIOTT PARTNERSI-CIRCLE ANARD WINNER







# RICHARD HUBBELL & ASSOCIATES

### HAMMES SURVEYING LCC

2300 VA SE-VERADO CARP VERDE. AZ BEXZZ (VORT 382-0606 CONTACT: TON HAMPIES T. JHAMBELIVE. COM

PROJECT TEAM



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# Oak Creek Heritage Lodge

COMPREHENSIVE DESIGN SUBMITTAL MARCH 14TH, 2023

PLANTING ENLARGEMENT NORTH CLUSTER


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# ILLUMINATION APPROACH

The lighting system is designed to maintain the elegance of the natural environment while providing a slightly elevated illumination for wayfinding and safety. Curated locations for fixtures allows for wide spacing while still making the site easy to move about safely by identifying key features of the paths. Focus is placed on intersections, grade changes, stairs and other significant features for ease of visibility.

- Lighting sources utilize warm colored led's to provide calming, inviting, and complimentary tones to the sedona desert and design palette. Sedona land development code (sldc) section 5.8.E(1)
- General area fixtures are fully cutoff to the sky keeping all illumination focused on the ground to preserve the darkness of the night without light pollution. sldc section 5.8.E(3)
- Lighting for pedestrian circulation throughout the site is proposed to be small landscape bollards to create a safe and navigable walking surface while not exceeding the lighting level output for the site. Sldc section 5.8.H. Fixtures are spaced at regular intervals but at a wide spacing such that the ground plane is not uniformly illuminated.
- The entry drive and drop off circle are illuminated with a low performance bollard which illuminates the driveway with a soft graze of light. These fixtures help to identify the edge of the drive while casting very low lighting level on the drive surface for ease of navigation.
- In the central court between reception, restaurant, and spa, string lighting is introduced to create a central focus and activate the space at night. Fixtures are partially shielded with cone shades while still creating the ambiance for the space. Sldc section 5.8.E(2)b.
- In select areas, subtle landscape lighting is used to accentuate feature landscape or art installations from ground mounted fixtures providing ambiance and accenting in a natural way. Sldc section 5.8.F(1)a



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R.D.OLSON DEVELOPMENT

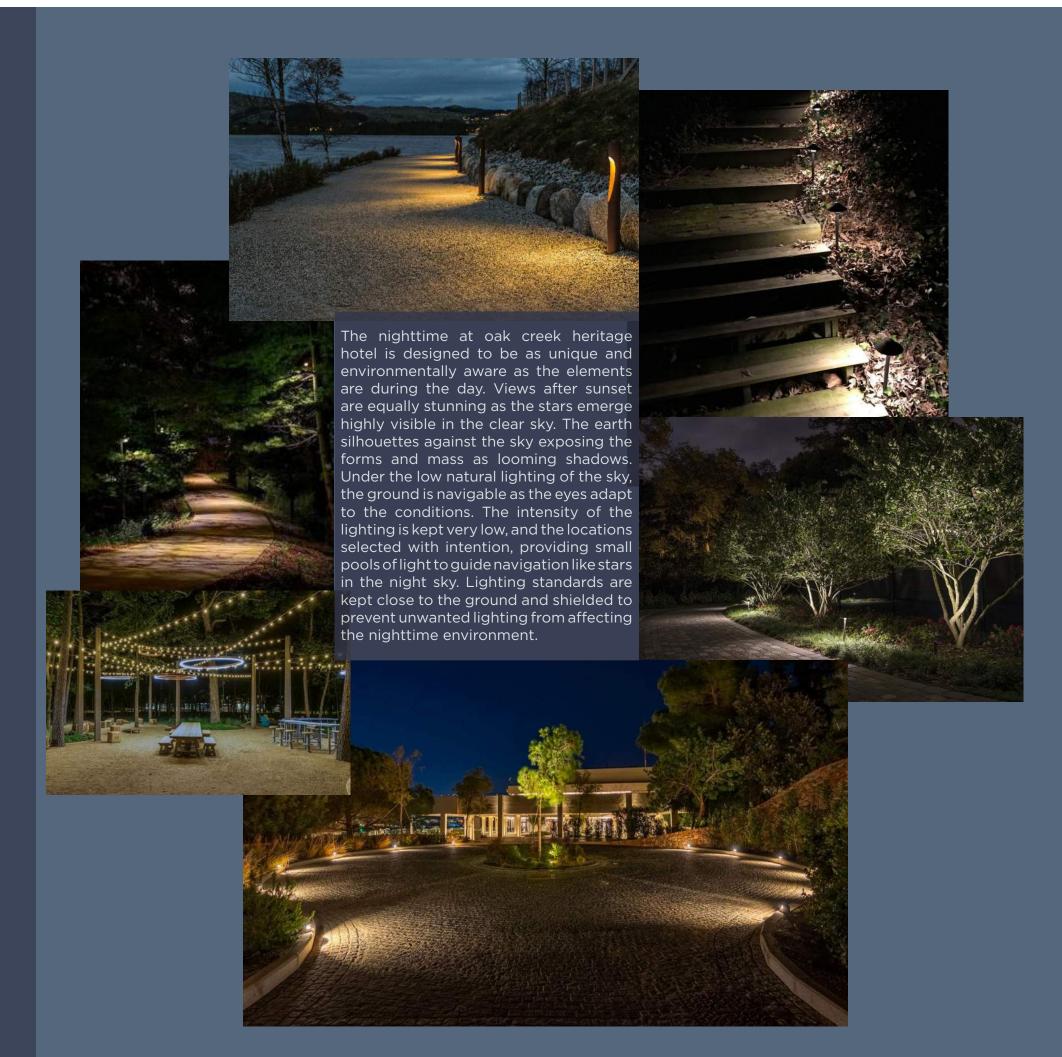





# RICHARD HUBBELL & ASSOCIATES

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HAMMES SURVEYING LCC July on Silverado Compresso. Al Mila



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Oak Creek Heritage Lodge

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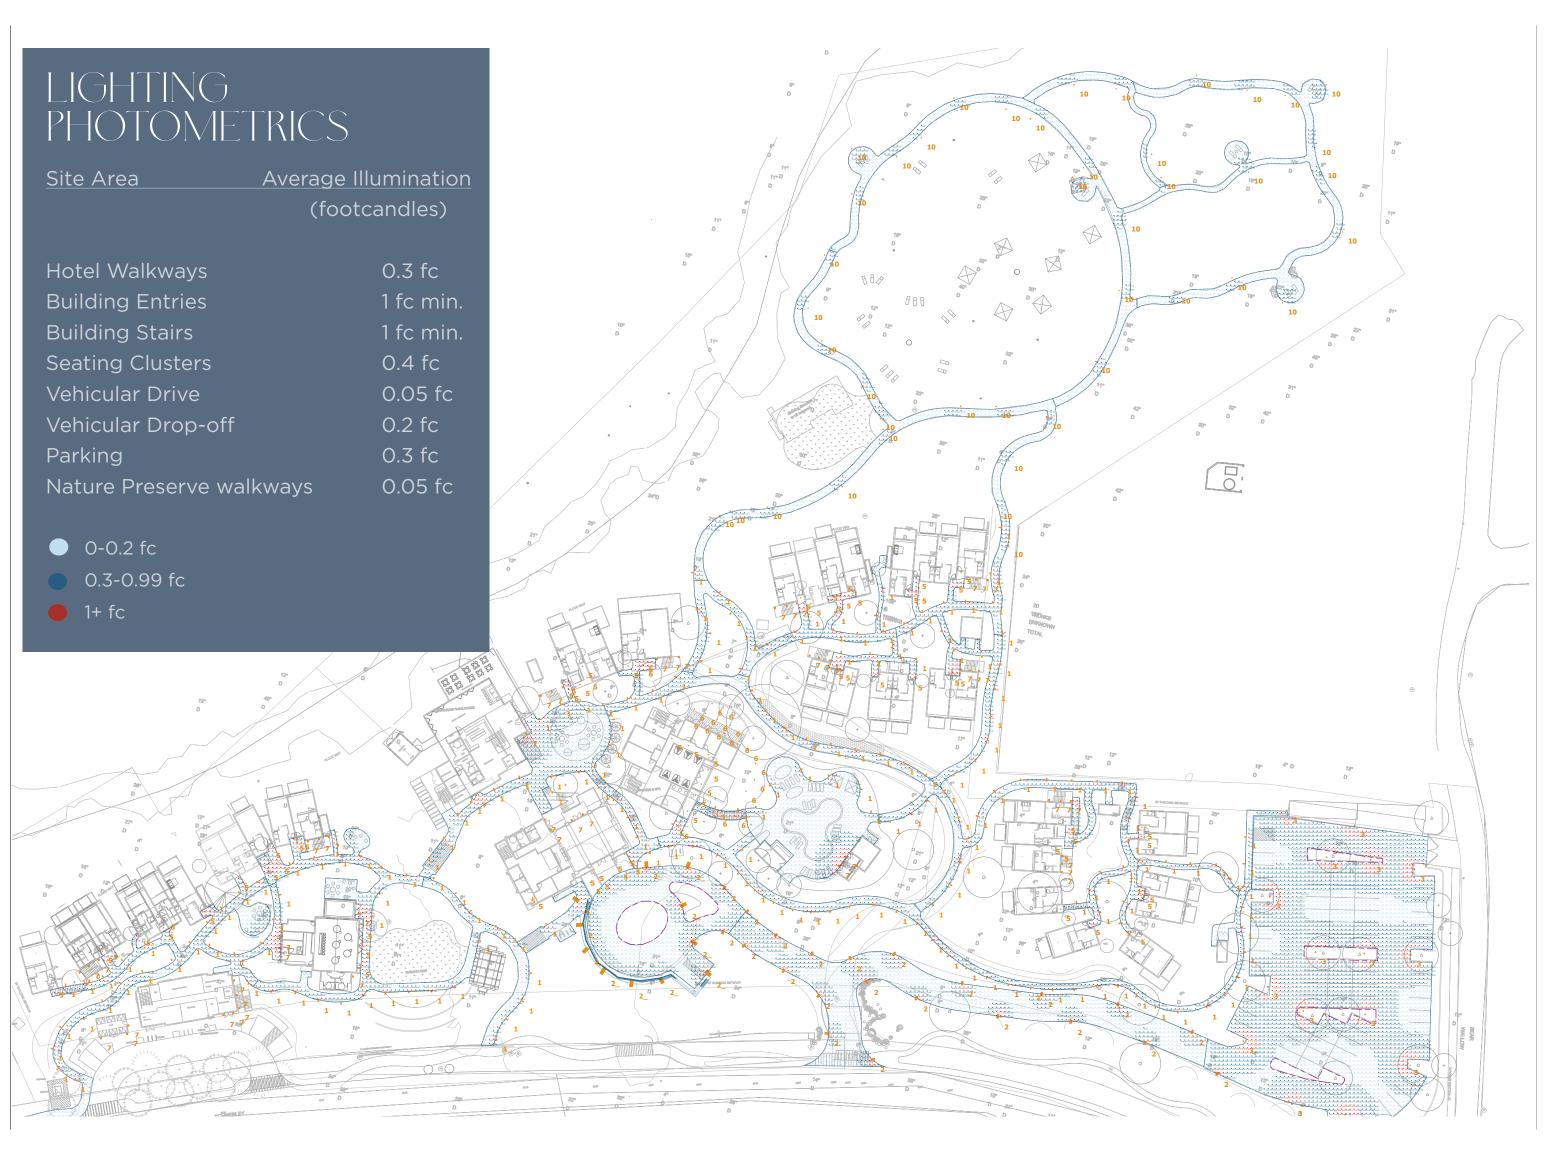
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Page 34 of 80



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# RICHARD HUBBELL & ASSOCIATES

80 SOLDIERS PASS ROAD SEDONA, AZ 86336 (928) 282-9477 CONTACT: RICHARD HUBBELL

## HAMMES SURVEYING LCC

100 VIA SILVERADO CAMP VERDE, AZ 86322 (928) 282-5686 CONTACT: TIM HAMMES



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Oak Creek Heritage Lodge

COMPREHENSIVE DESIGN SUBMITTA MARCH 14TH, 2023

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Page 36 of 80





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# RICHARD HUBBELL & ASSOCIATES

# HAMMES SURVEYING LCC

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# Oak Creek Heritage Lodge

COMPREHENSIVE DESIGN SUBMITTAL MARCH 14TH, 2023

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Page 37 of 80









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# RICHARD HUBBELL & ASSOCIATES

HAMMES SURVEYING LCC 2000 VAN SILVERIOD CAMP VERDE, AZ 68332 (NEW) JAZ-SARE CONTACT: THE HAMMES TAMMESTIC COM

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# Oak Creek Heritage Lodge

COMPREHENSIVE DESIGN SUBMITTAL MARCH 14TH, 2023

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project no. 222002

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# CAP - SEDONA CLIMATE ACTION PLAN GUIDING PRINCIPALS



# **BUILDINGS & ENERGY**

GOAL: Ensure long-term access to clean energy while reducing the fiscal and environmental impacts of consumption



# TRANSPORTATION AND LAND USE

**GOAL:** Reduce transportation emissions and enhance community mobility



# MATERIALS AND CONSUMPTION

GOAL: Increase the diversion of waste from the landfill and reduce GHG emissions associated with the consumption of goods and services



# WATER AND NATURAL SYSTEMS

GOAL: Conserve community water resources by maximizing water efficiency technologies while ensuring a secure and sustainable water supply in the face of climate change impacts. Manage, restore, and foster resilient ecosystems, landscapes, and resources



# **CLIMATE RESILIENCE**

GOAL: Ensure Sedona and its residents, businesses, visitors, facilities, and services are prepared for climate impacts, especially those at the highest risk

# PROJECT SUSTAINABILITY GOALS & SYNERGIES



Community & Site



Water Use & Efficiency



Energy Use & Efficiency



Materials & Resource Use



Indoor Environmental Quality



Aesthetics, Education & Innovation

# "LEED CERTIFIED"

LOBBY, RESTAURANT & SPA

# **Coconino County**



BRONZE LEVEL CERTIFICATION



VVREO
Verde Valley Regional Economic Organization
BRONZE LEVEL CERTIFICATION

**Project Specific** 

Water Conservation & Sustainability Study



Schnebly Community Focus Area Plan



Keep Sedona Beautiful

aps

**Arizona Public Service** 

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Hey plan

Oak Creek Heritage Lodge

COMPREHENSIVE DESIGN SUBMITTAL

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