

Stratified Concrete

Red rock gabion walls surround the garage and will be formed from rock excavated from the site.

The use of stratified integral-colored concrete visually connects the structure to Sedona's natural geological history. New sustainable manufacturing practices and little to no maintenance throughout its service life makes concrete a good choice for the garage structure.



**Architectural Masonry** 

Landscape

**Exterior Painted Surfaces** 

**Rock Gabion Walls** 






Integral Color Stratified Concrete




Cable Railing





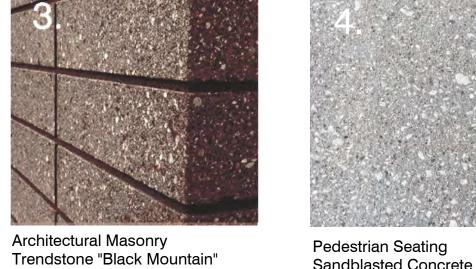


Pedestrian Seating Sandblasted Concrete

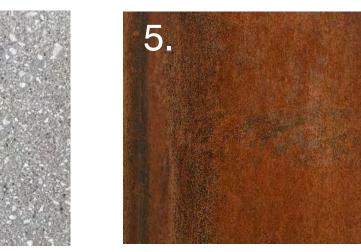







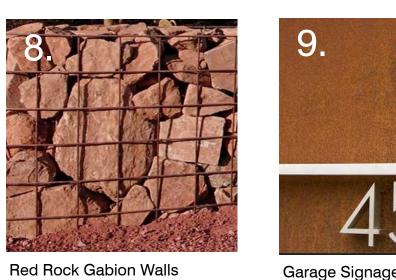



Solar Array


Satellite Police Station

Bike Rental


13. Restrooms





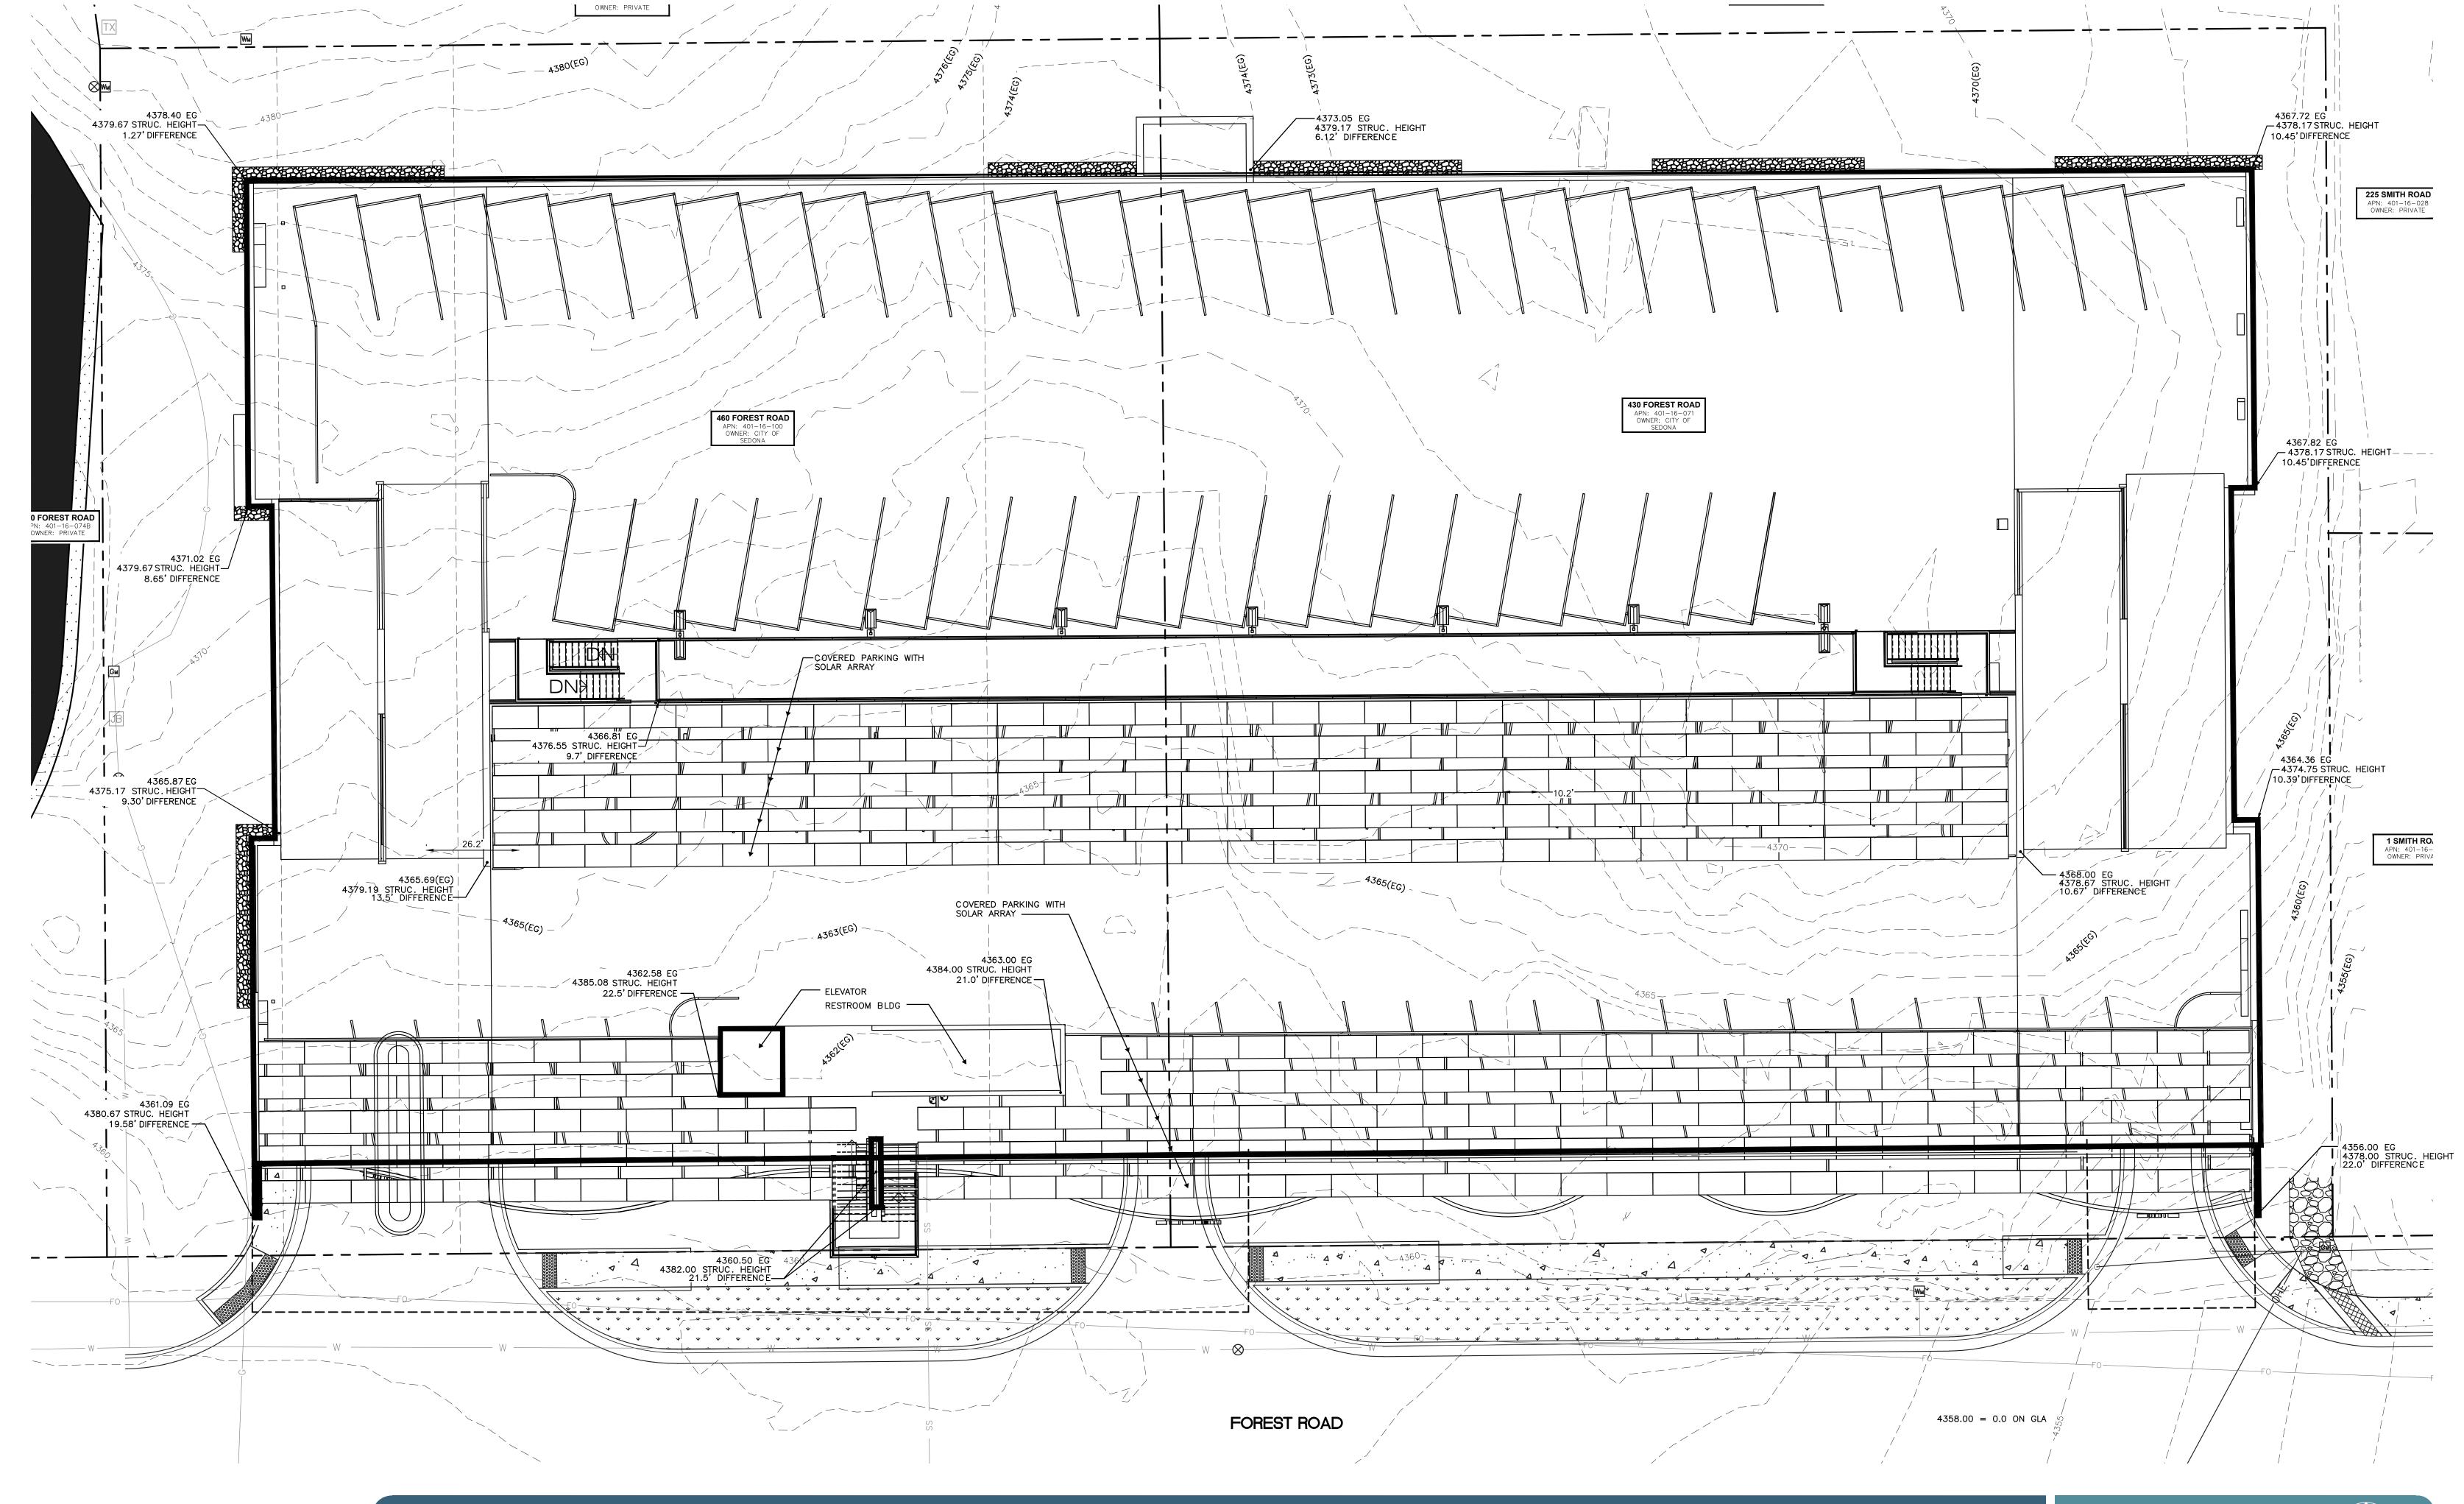

# SYMBOL LEGEND

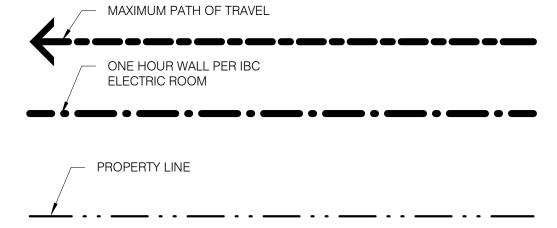

### PARKING COUNTS


BASEMENT LEVEL 97 SPACES **GROUND LEVEL** 74 SPACES 7 ACC. SPACES


<u>UPPER LEVEL</u> 97 SPACES TOTAL SPACES: 275


**PARKING NOTES:** 


EACH ACCESSIBLE PARKING SPACE SHALL COMPRISE RECTANGULAR AREAS NOT LESS THAN 11 FEET WIDE BY 18 FEET LONG WITH A 5-FOOT MINIMUM WIDTH ACCESS AISLE ON ITS RIGHT SIDE (EXCEPT IN LAYOUTS WHEREIN 2 ACCESSIBLE PARKING SPACES SHARE A SINGLE 5-FOOT-WIDE ACCESS AISLE.

EACH ACCESS AISLE SHALL LEAD DIRECTLY TO AN ACCESSIBLE ROUTE OF TRAVEL.

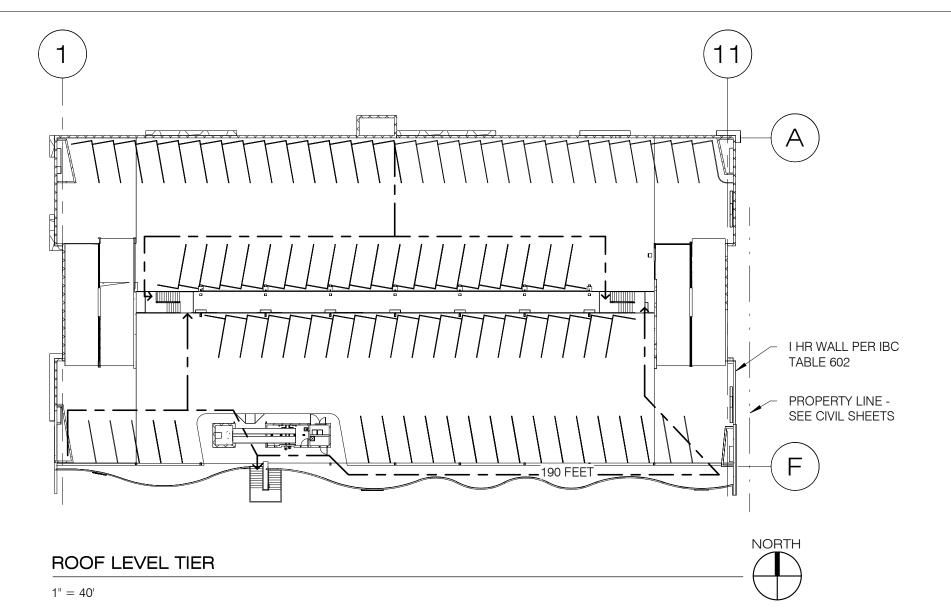

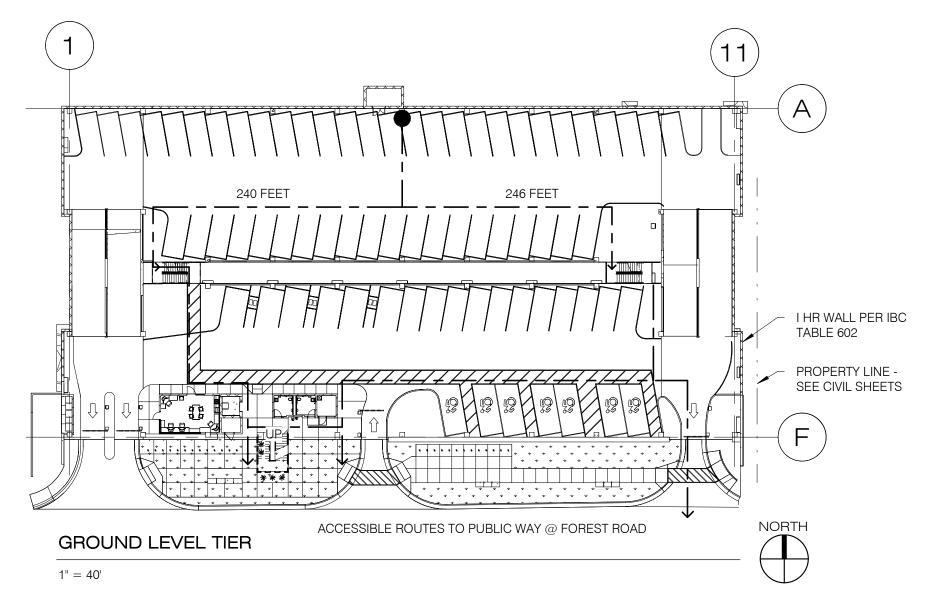

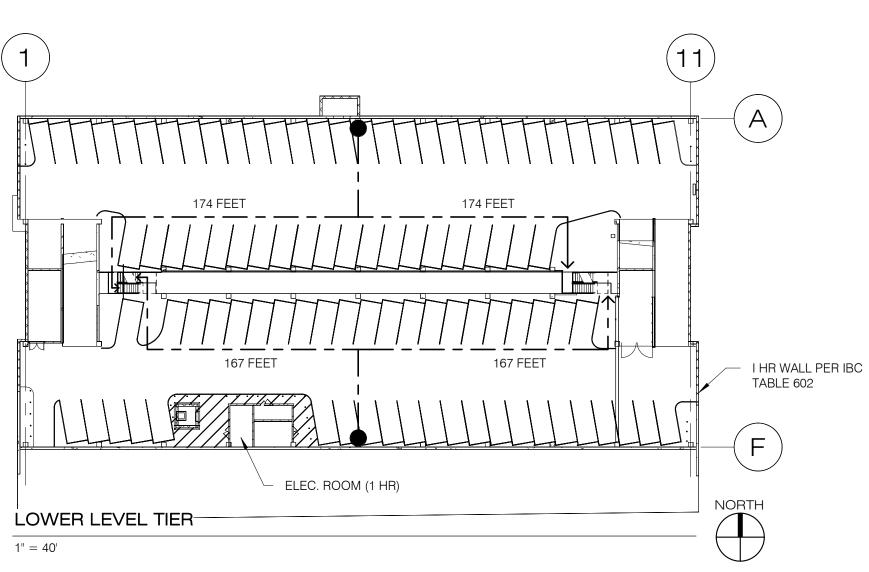

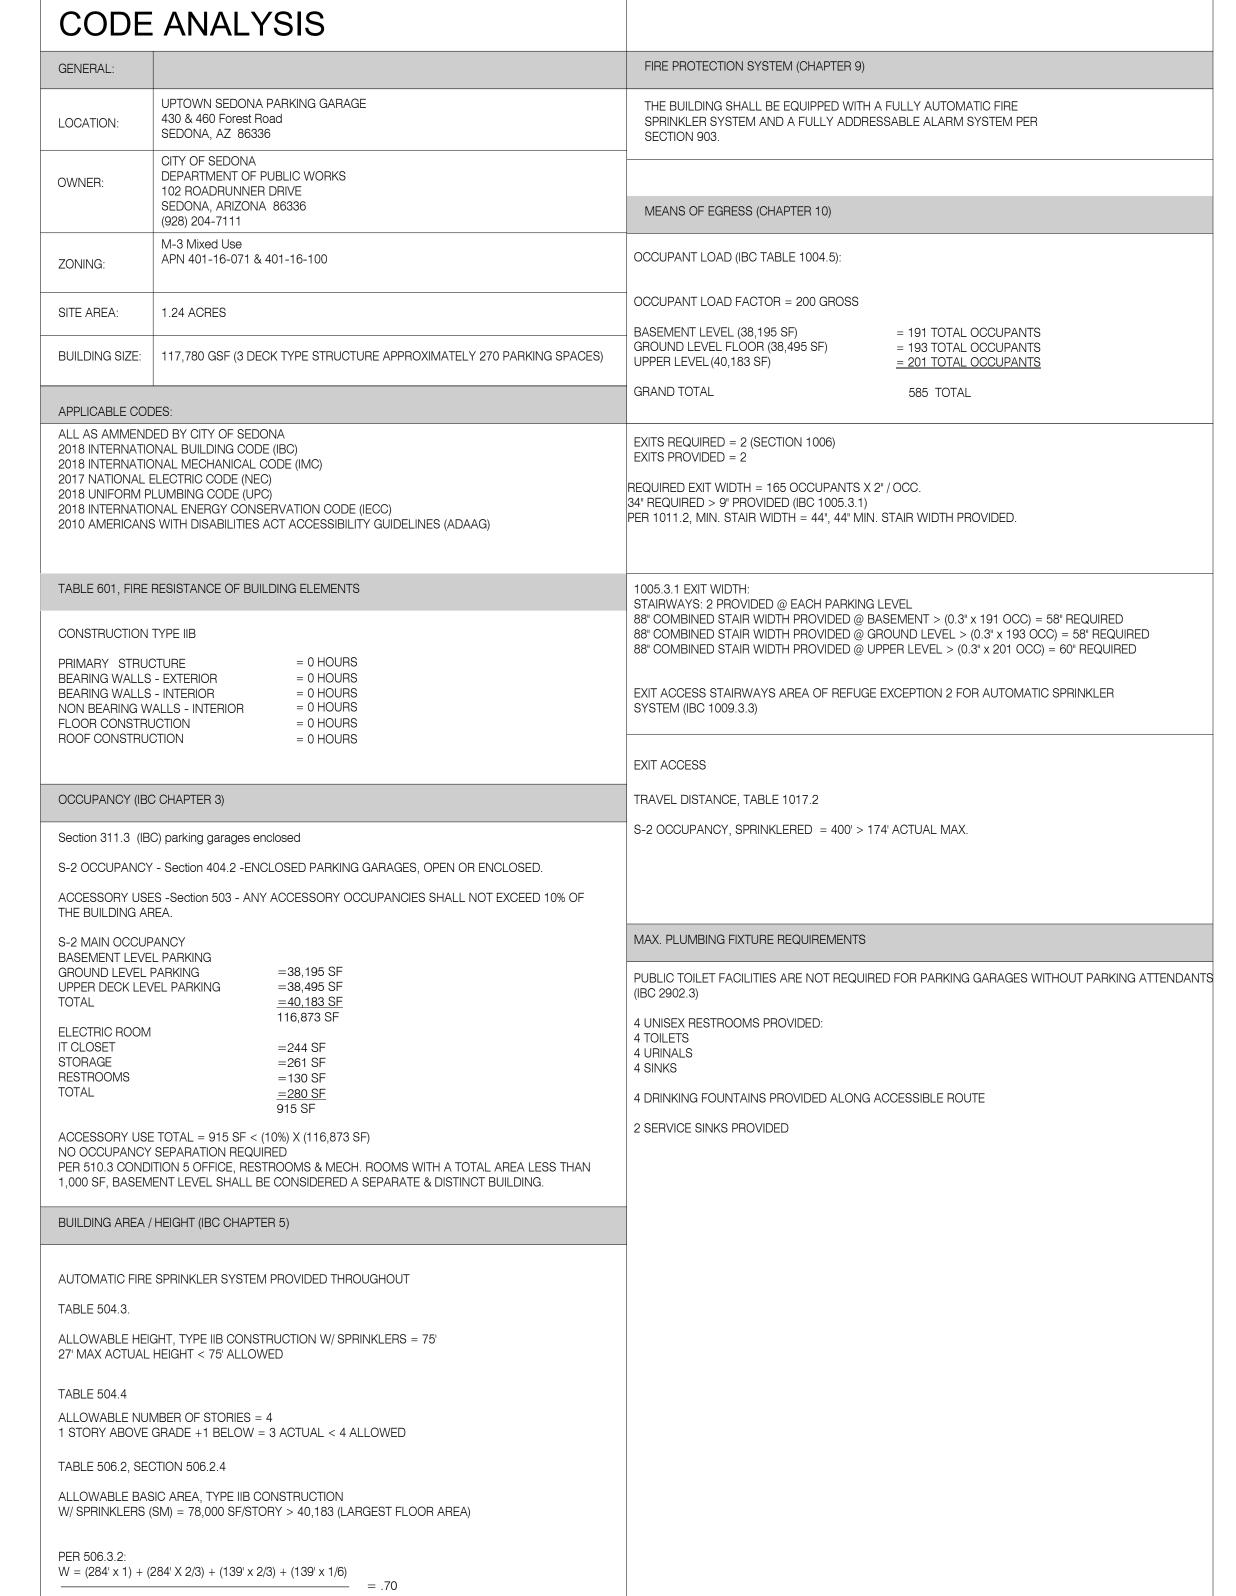

NOTICE OF EXTENDED PAYMENT PROVISION

(PER ARS 32-1129.01) THIS CONTRACT ALLOWS THE OWNER TO MAKE PAYMENT WITHIN 15 DAYS AFTER CERTIFICATION AND APPROVALS OF **BILLINGS AND ESTIMATES FOR PROGRESS** PAYMENTS, WITHIN 15 DAYS AFTER CERTIFICATION AND APPROVALS OF BILLINGS AND ESTIMATES FOR RELEASE OF RETENTION AND WITHIN 15 DAYS AFTER CERTIFICATION AND APPROVAL OF BILLINGS AND ESTIMATES FOR FINAL PAYMENT.





VERIFY SCALES 0 —\_\_\_\_ BAR IS ONE INCH ON ORIGINAL DRAWING

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Symbol	Revisions	Date	Appr.	Designed by:	Date:
				JL	11 March 2024
				Drawn by:	
				RGH	
				Checked by:	Project Code:
				JL/JP	GLA PROJECT NO. 20109

### gabor lorant architects

3326 n. 3rd avenue suite 200 phoenix, arizona 85013 tel: 602.667.9090 fax: 602.667.9133 gaborlorant.com





CITY OF SEDONA
PUBLIC WORKS DEPARTMENT 102 ROADRUNNER DRIVE


**SEDONA, ARIZONA 86336** 

928-204-7111

Uptown Sedona Parking Facility 420 Forest Road, Sedona, AZ Occupancy & Code Analysis

SHEET ID a001

> SHEET NO. OF

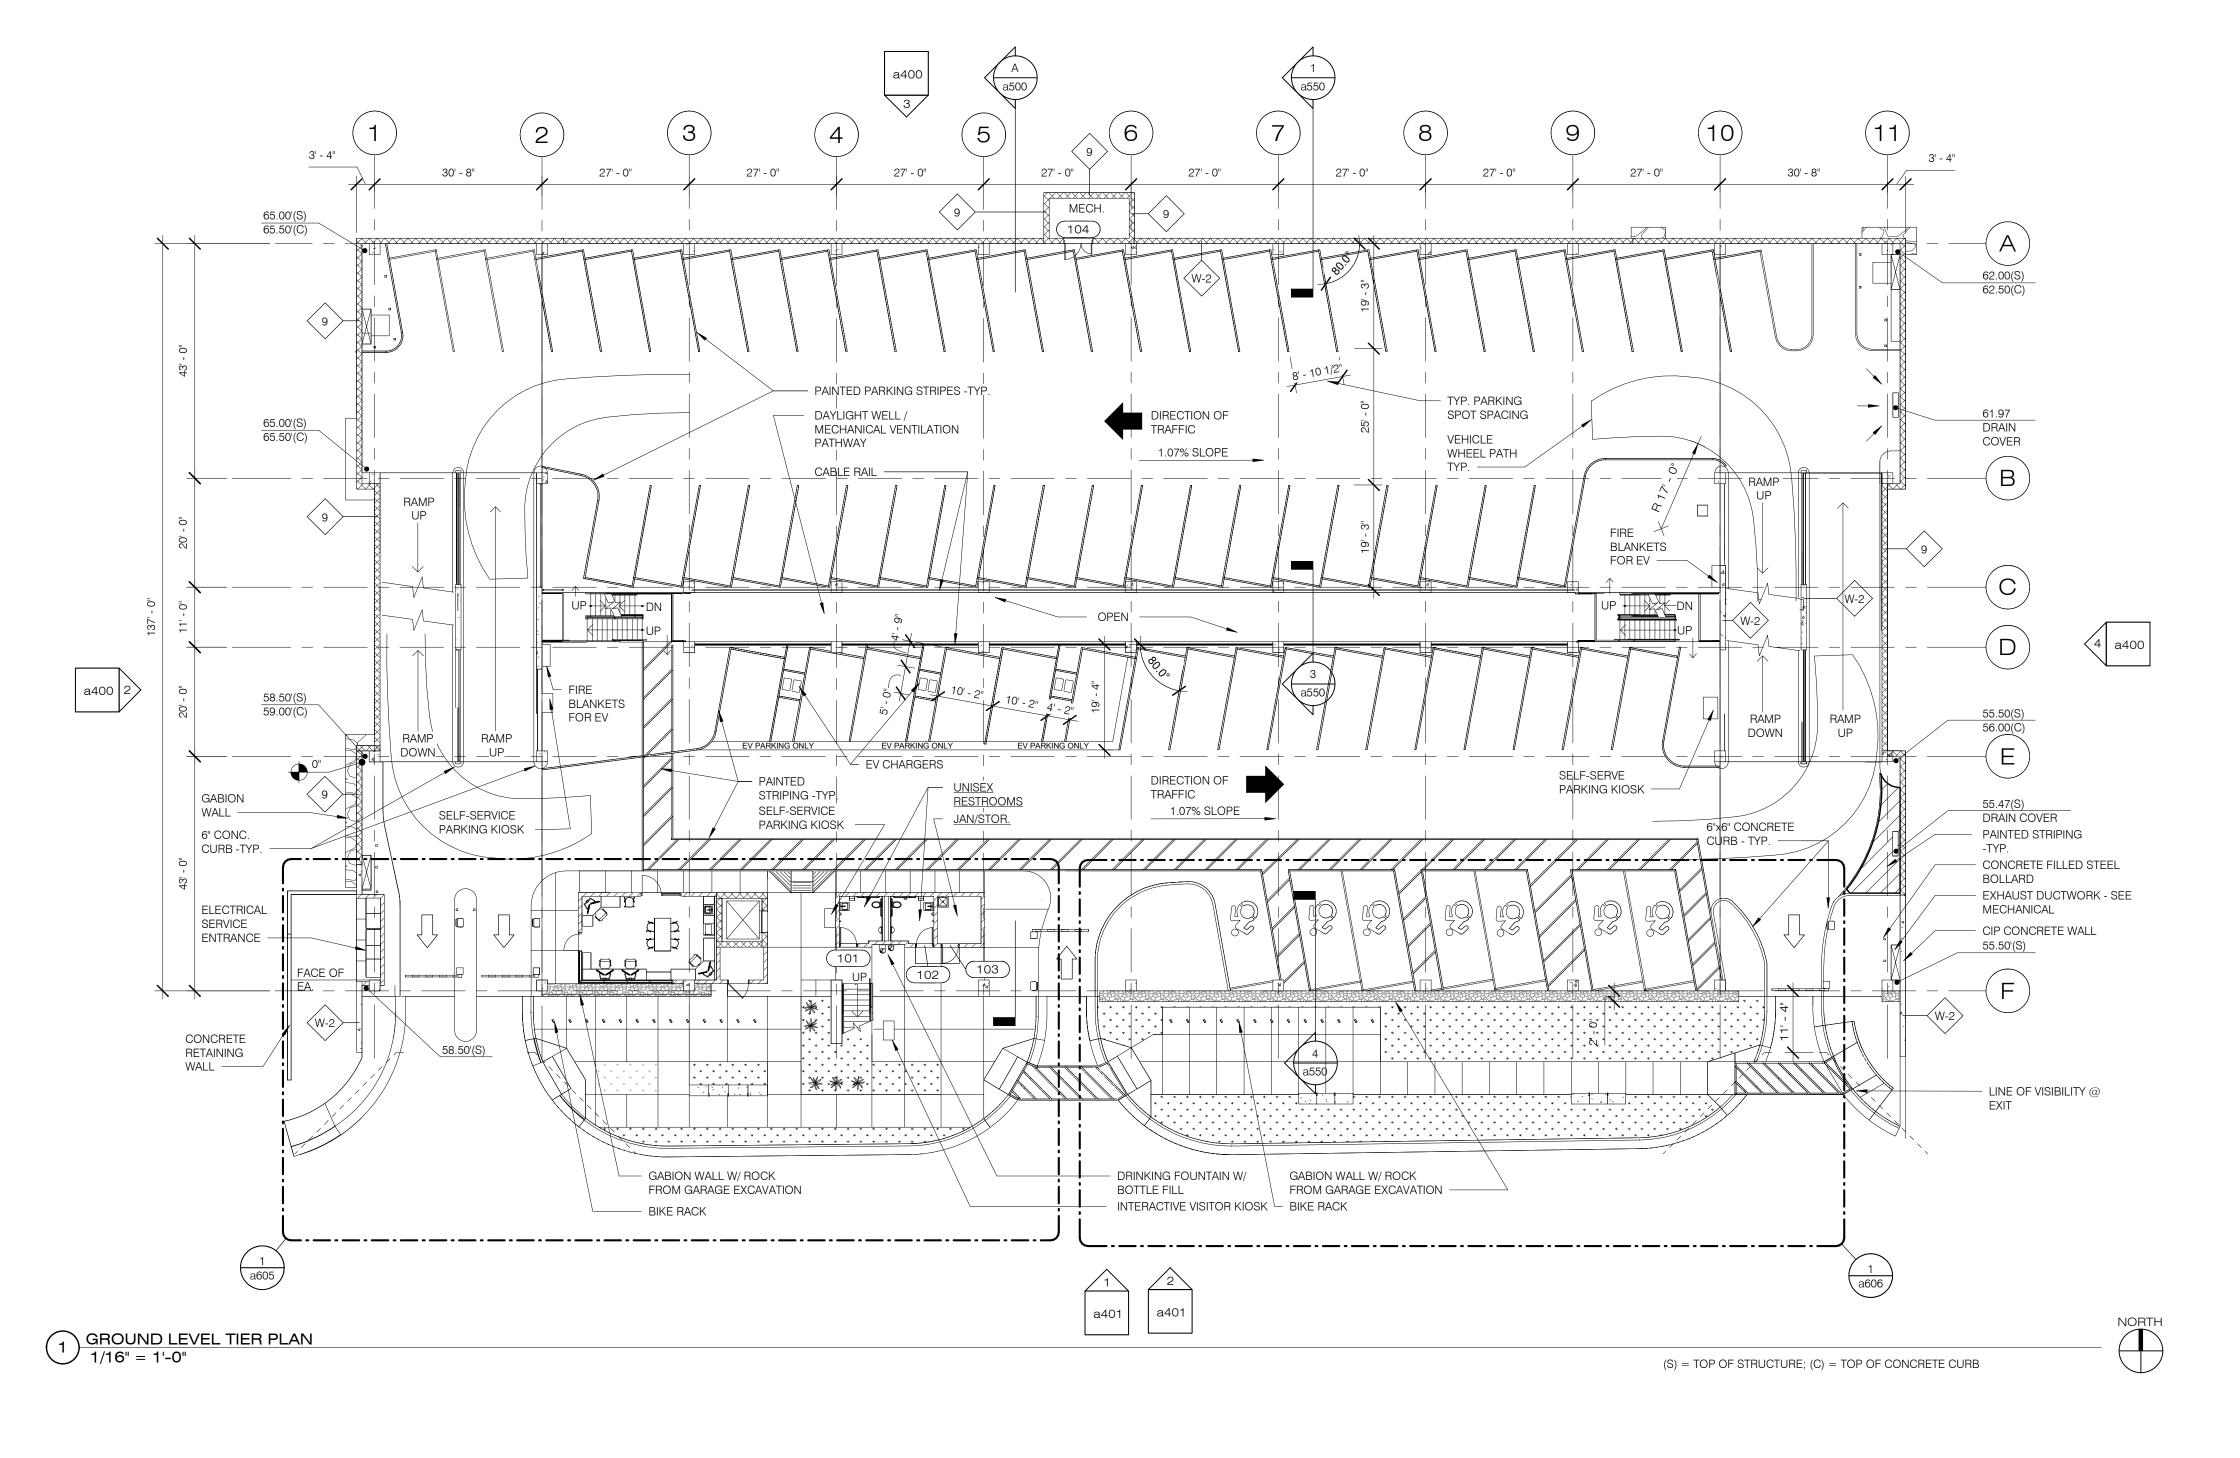

WALL TYPE

8° CONCRETE WALL, REINFORCE PER STRUCTURAL DOCUMENTS

12° CONCRETE WALL, REINFORCE PER STRUCTURAL DOCUMENTS

12° CONCRETE WALL, REINFORCE PER STRUCTURAL DOCUMENTS

12×8×16 CONCRETE MASONRY UNITS, GROUT CELLS W/ REINFORCING PER STRUCTURAL DOCUMENTS.

8×8×16 CONCRETE MASONRY UNITS, GROUT CELLS W/ REINFORCING PER STRUCTURAL DOCUMENTS.

PLUMBING WALL, 5/8° CEMENT BOARD ON 3-5/8° METAL STUDS AT 16° O.C. PROVIDE WALL TILE FINISH.

CORRUGATED CORTEN PANELS OVER STEEL TUBE FRAME.

W-6

WRE MESH FENCING & GATES OVER STEEL TUBE FRAMING.

NOTICE OF EXTENDED PAYMENT PROVISION

(PER ARS 32-1129.01) THIS CONTRACT ALLOWS
THE OWNER TO MAKE PAYMENT WITHIN 15 DAYS
AFTER CERTIFICATION AND APPROVALS OF
BILLINGS AND ESTIMATES FOR PROGRESS
PAYMENTS, WITHIN 15 DAYS AFTER CERTIFICATION
AND APPROVALS OF BILLINGS AND ESTIMATES
FOR RELEASE OF RETENTION AND WITHIN 15
DAYS AFTER CERTIFICATION AND APPROVAL OF
BILLINGS AND ESTIMATES FOR FINAL PAYMENT.



Date Appr. Designed by:	Revisions Date	Date:	
JL		11 March 2024	
Drawn by:			
RGH			
Checked by:		Project Code:	
JL/J		GLA PROJECT NO. 20109	

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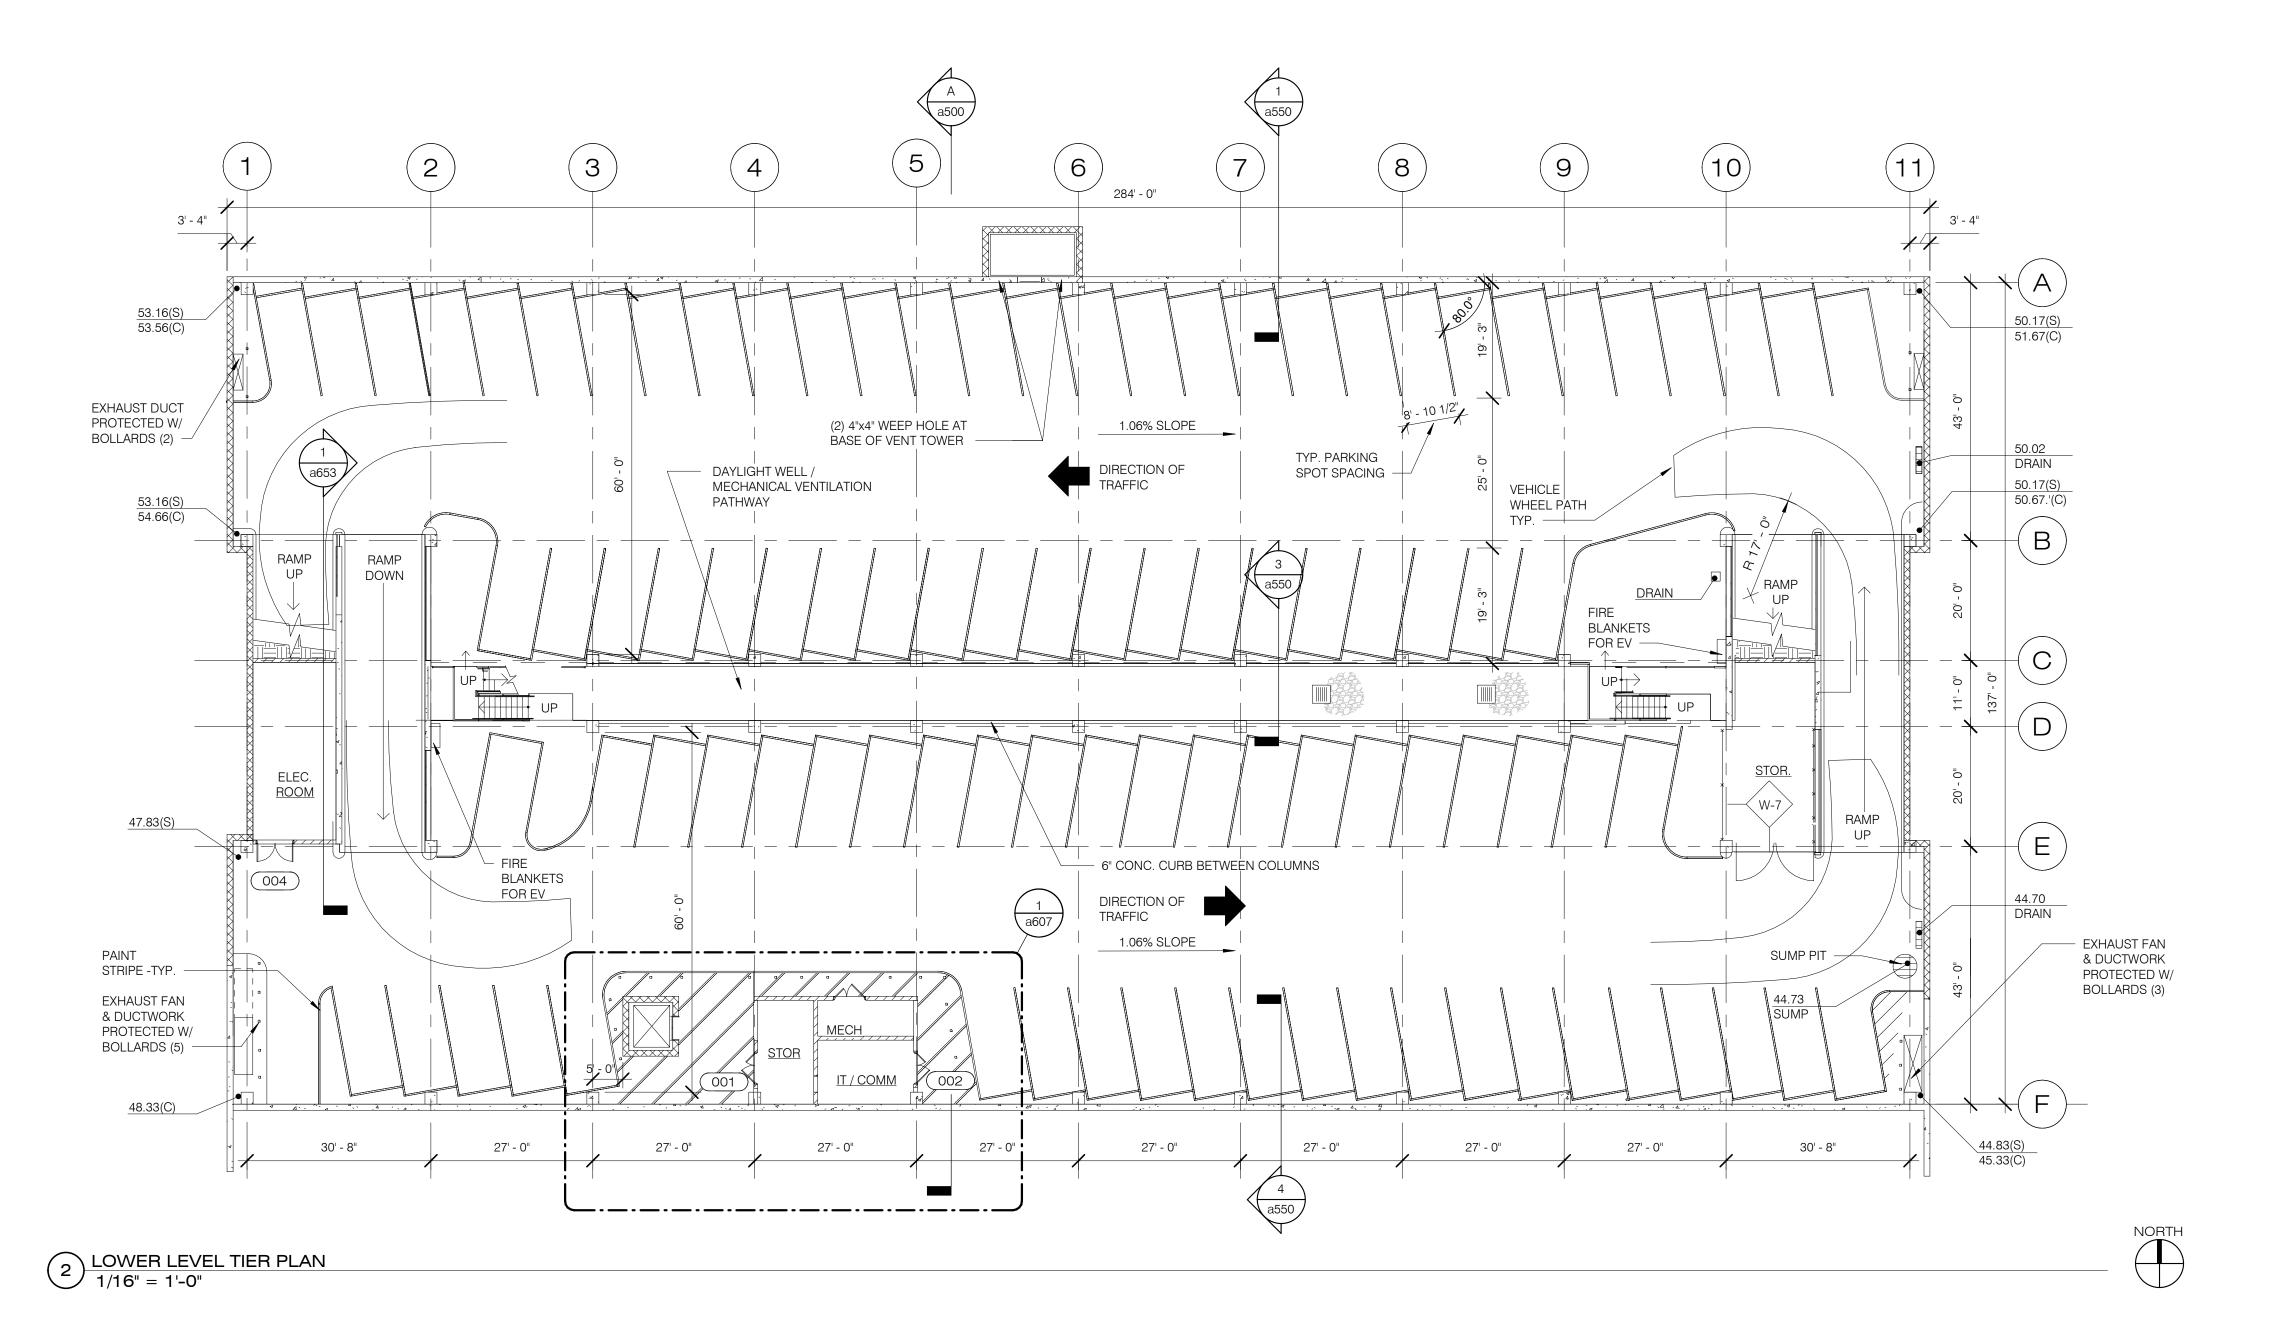
Uptown Sedona Parking Facility 420 Forest Road, Sedona, AZ Ground Level Tier Plan IF NOT ONE INCH ON THIS SHEET, ADJUST SCALES ACCORDINGLY

SHEET ID

a101

SHEET NO.

BAR IS ONE INCH ON



PARKING COUNTS BASEMENT LEVEL 93 SPACES GROUND LEVEL 73 SPACES 7 ACC. SPACES 6 EV SPACES 94 SPACES TOTAL SPACES: 260

WALL DESCRIPTION 8" CONCRETE WALL, REINFORCE PER STRUCTURAL DOCUMENTS W-1 12" CONCRETE WALL, REINFORCE PER STRUCTURAL DOCUMENTS (W-2) 12x8x16 CONCRETE MASONRY UNITS, GROUT CELLS W/ REINFORCING PER STRUCTURAL W-3 DOCUMENTS. 8x8x16 CONCRETE MASONRY UNITS, GROUT CELLS W/ REINFORCING PER STRUCTURAL W-4 DOCUMENTS. PLUMBING WALL, 5/8" CEMENT BOARD ON 3-5/8" METAL STUDS AT 16" O.C. PROVIDE WALL TILE W-5 FINISH. CORRUGATED CORTEN PANELS OVER STEEL TUBE FRAME. W-7 WIRE MESH FENCING & GATES OVER STEEL TUBE FRAMING.

NOTICE OF EXTENDED PAYMENT PROVISION

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FOR RELEASE OF RETENTION AND WITHIN 15
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CITY OF SEDONA
PUBLIC WORKS DEPARTMENT
102 ROADRUNNER DRIVE **SEDONA, ARIZONA 86336** 

928-204-7111

Uptown Sedona Parking Facility 420 Forest Road, Sedona, AZ

SHEET ID a100 SHEET NO.


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				JL	11 March 2024	
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				RGH		
				Checked by:	Project Code:	
				Officered by.		
				11 / 15		

Lower Level Tier Plan



WALL TYPE	DESCRIPTION
W-1>	8" CONCRETE WALL, REINFORCE PER STRUCTURAL DOCUMENTS
W-2>	12" CONCRETE WALL, REINFORCE PER STRUCTURAL DOCUMENTS
W-3>	12x8x16 CONCRETE MASONRY UNITS, GROUT CELLS W/ REINFORCING PER STRUCTURAL DOCUMENTS.
W-4	8x8x16 CONCRETE MASONRY UNITS, GROUT CELLS W/ REINFORCING PER STRUCTURAL DOCUMENTS.
W-5	PLUMBING WALL, 5/8" CEMENT BOARD ON 3-5/8" METAL STUDS AT 16" O.C. PROVIDE WALL TILE FINISH.
W-6	CORRUGATED CORTEN PANELS OVER STEEL TUBE FRAME.
W-7>	WIRE MESH FENCING & GATES OVER STEEL TUBE FRAMING.

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				RGH	
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				JL/JP	GLA PROJECT NO. 20109
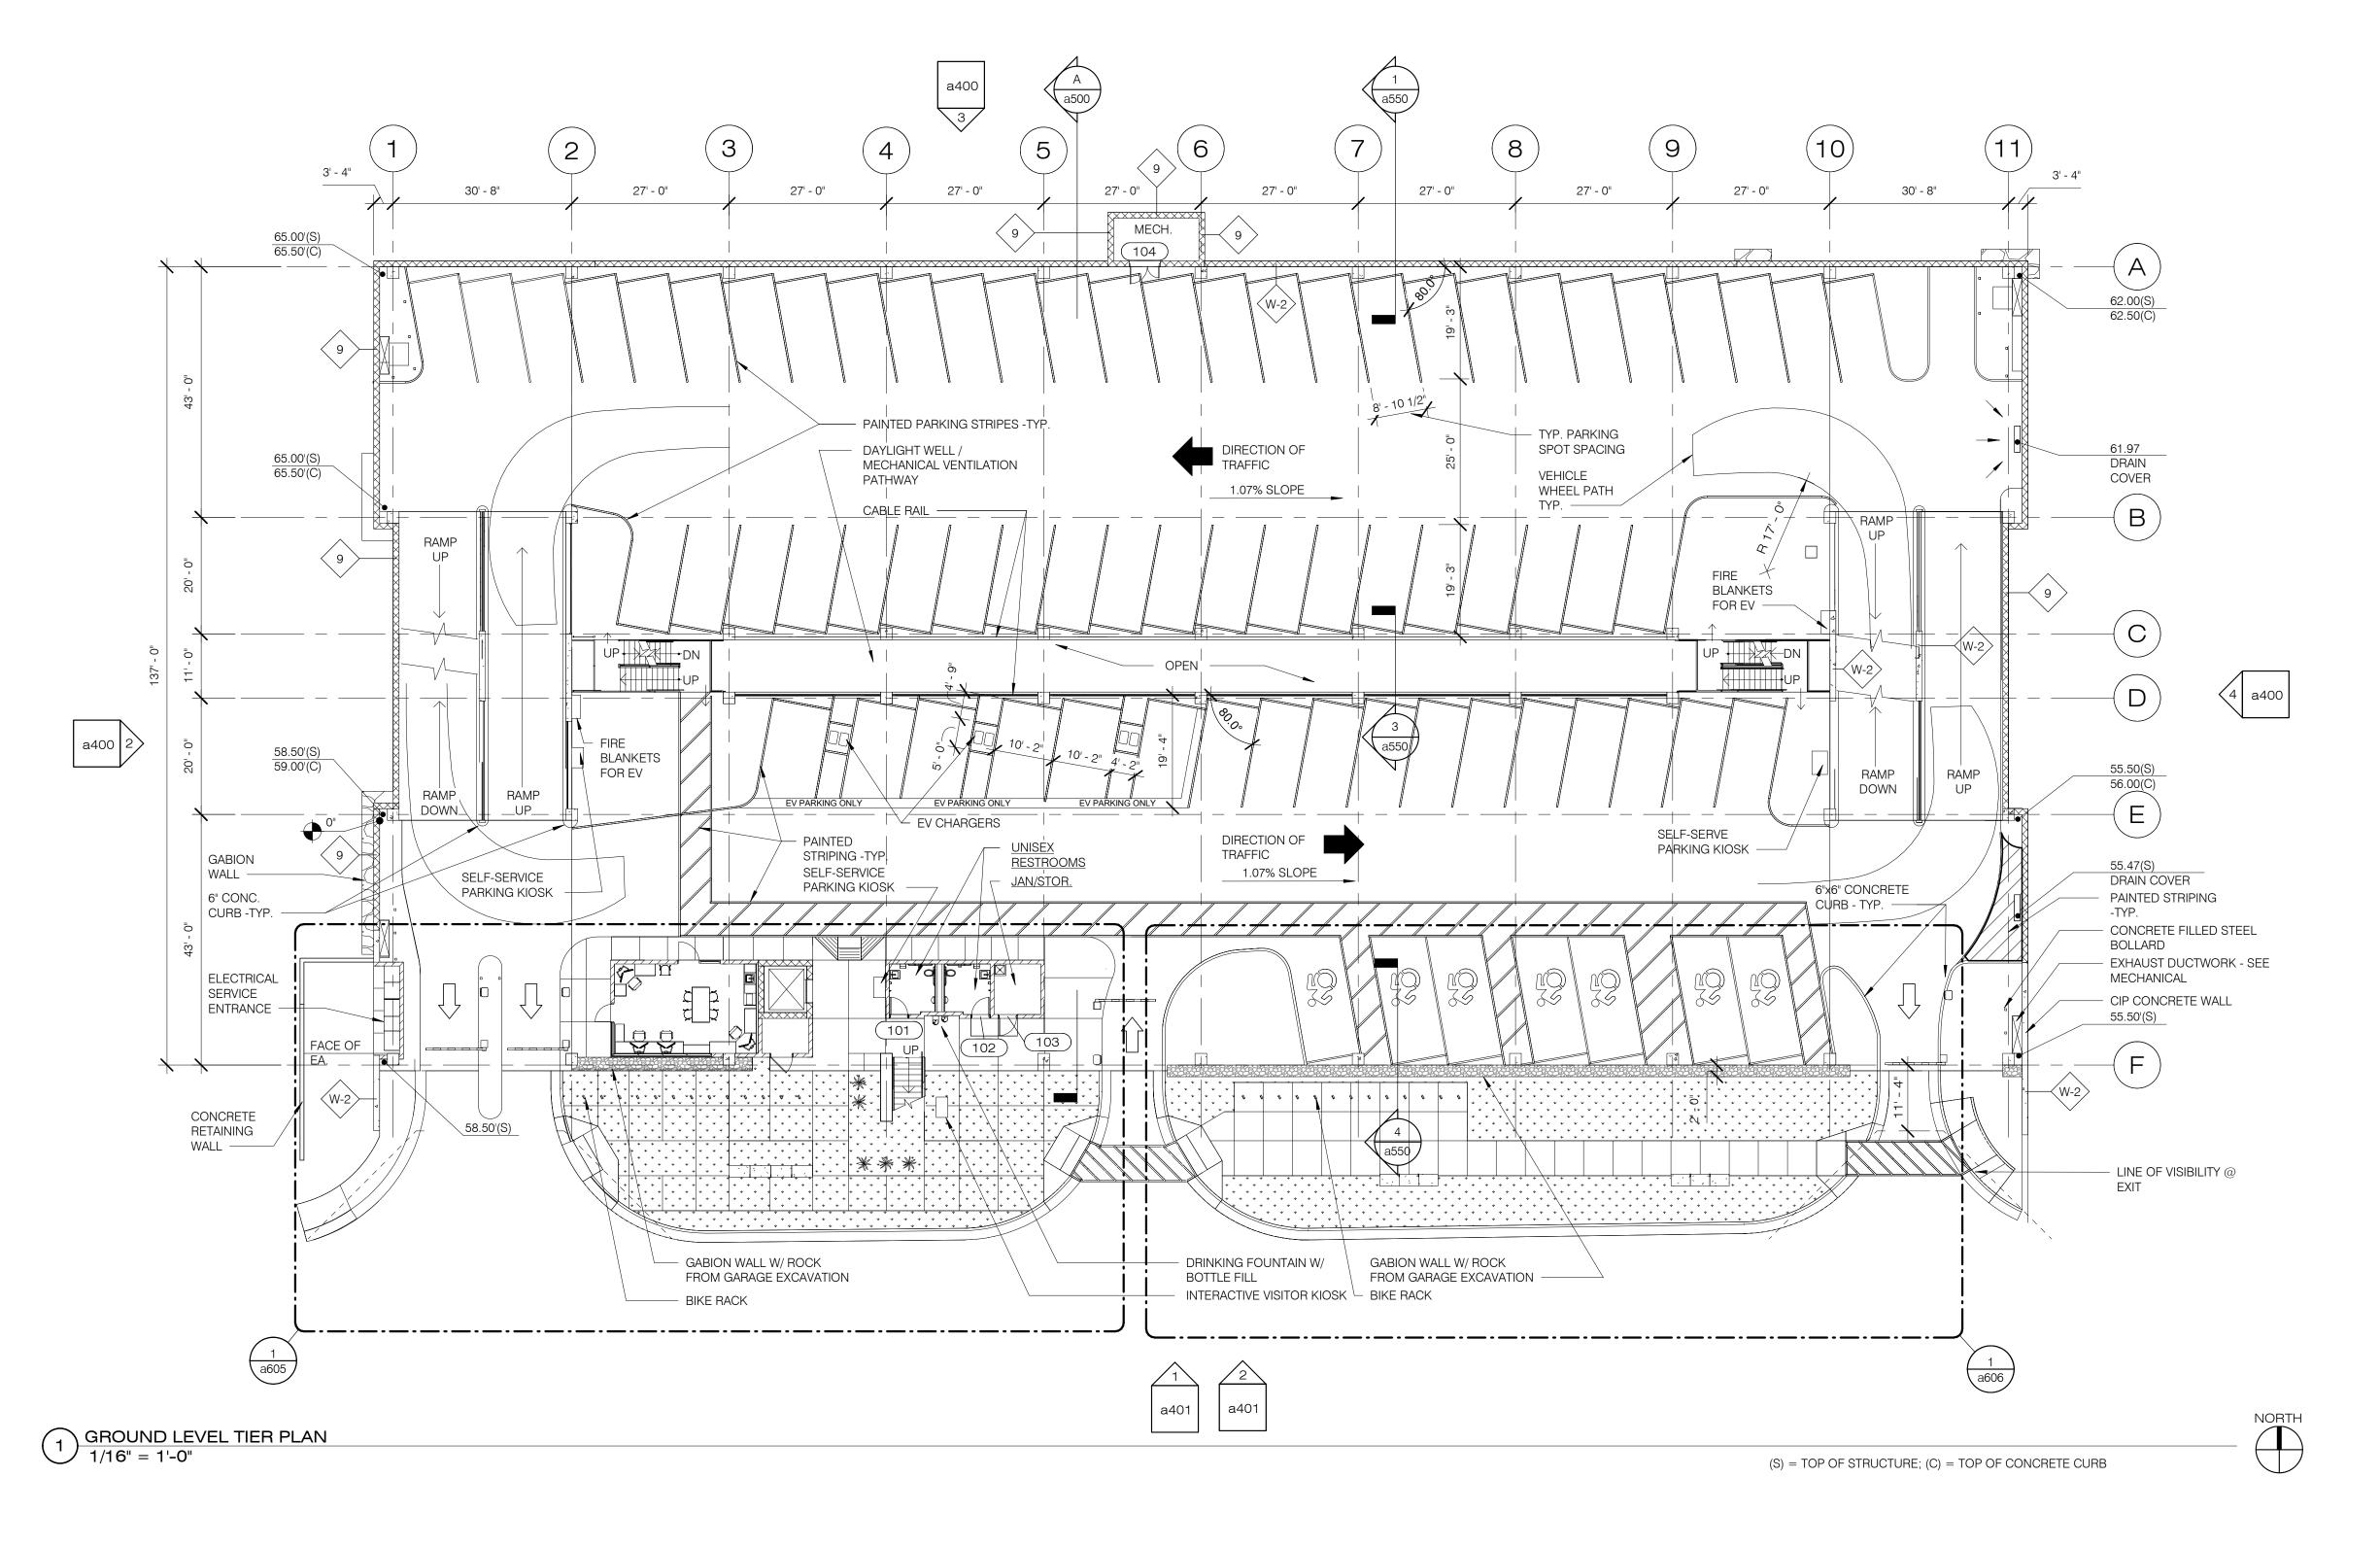
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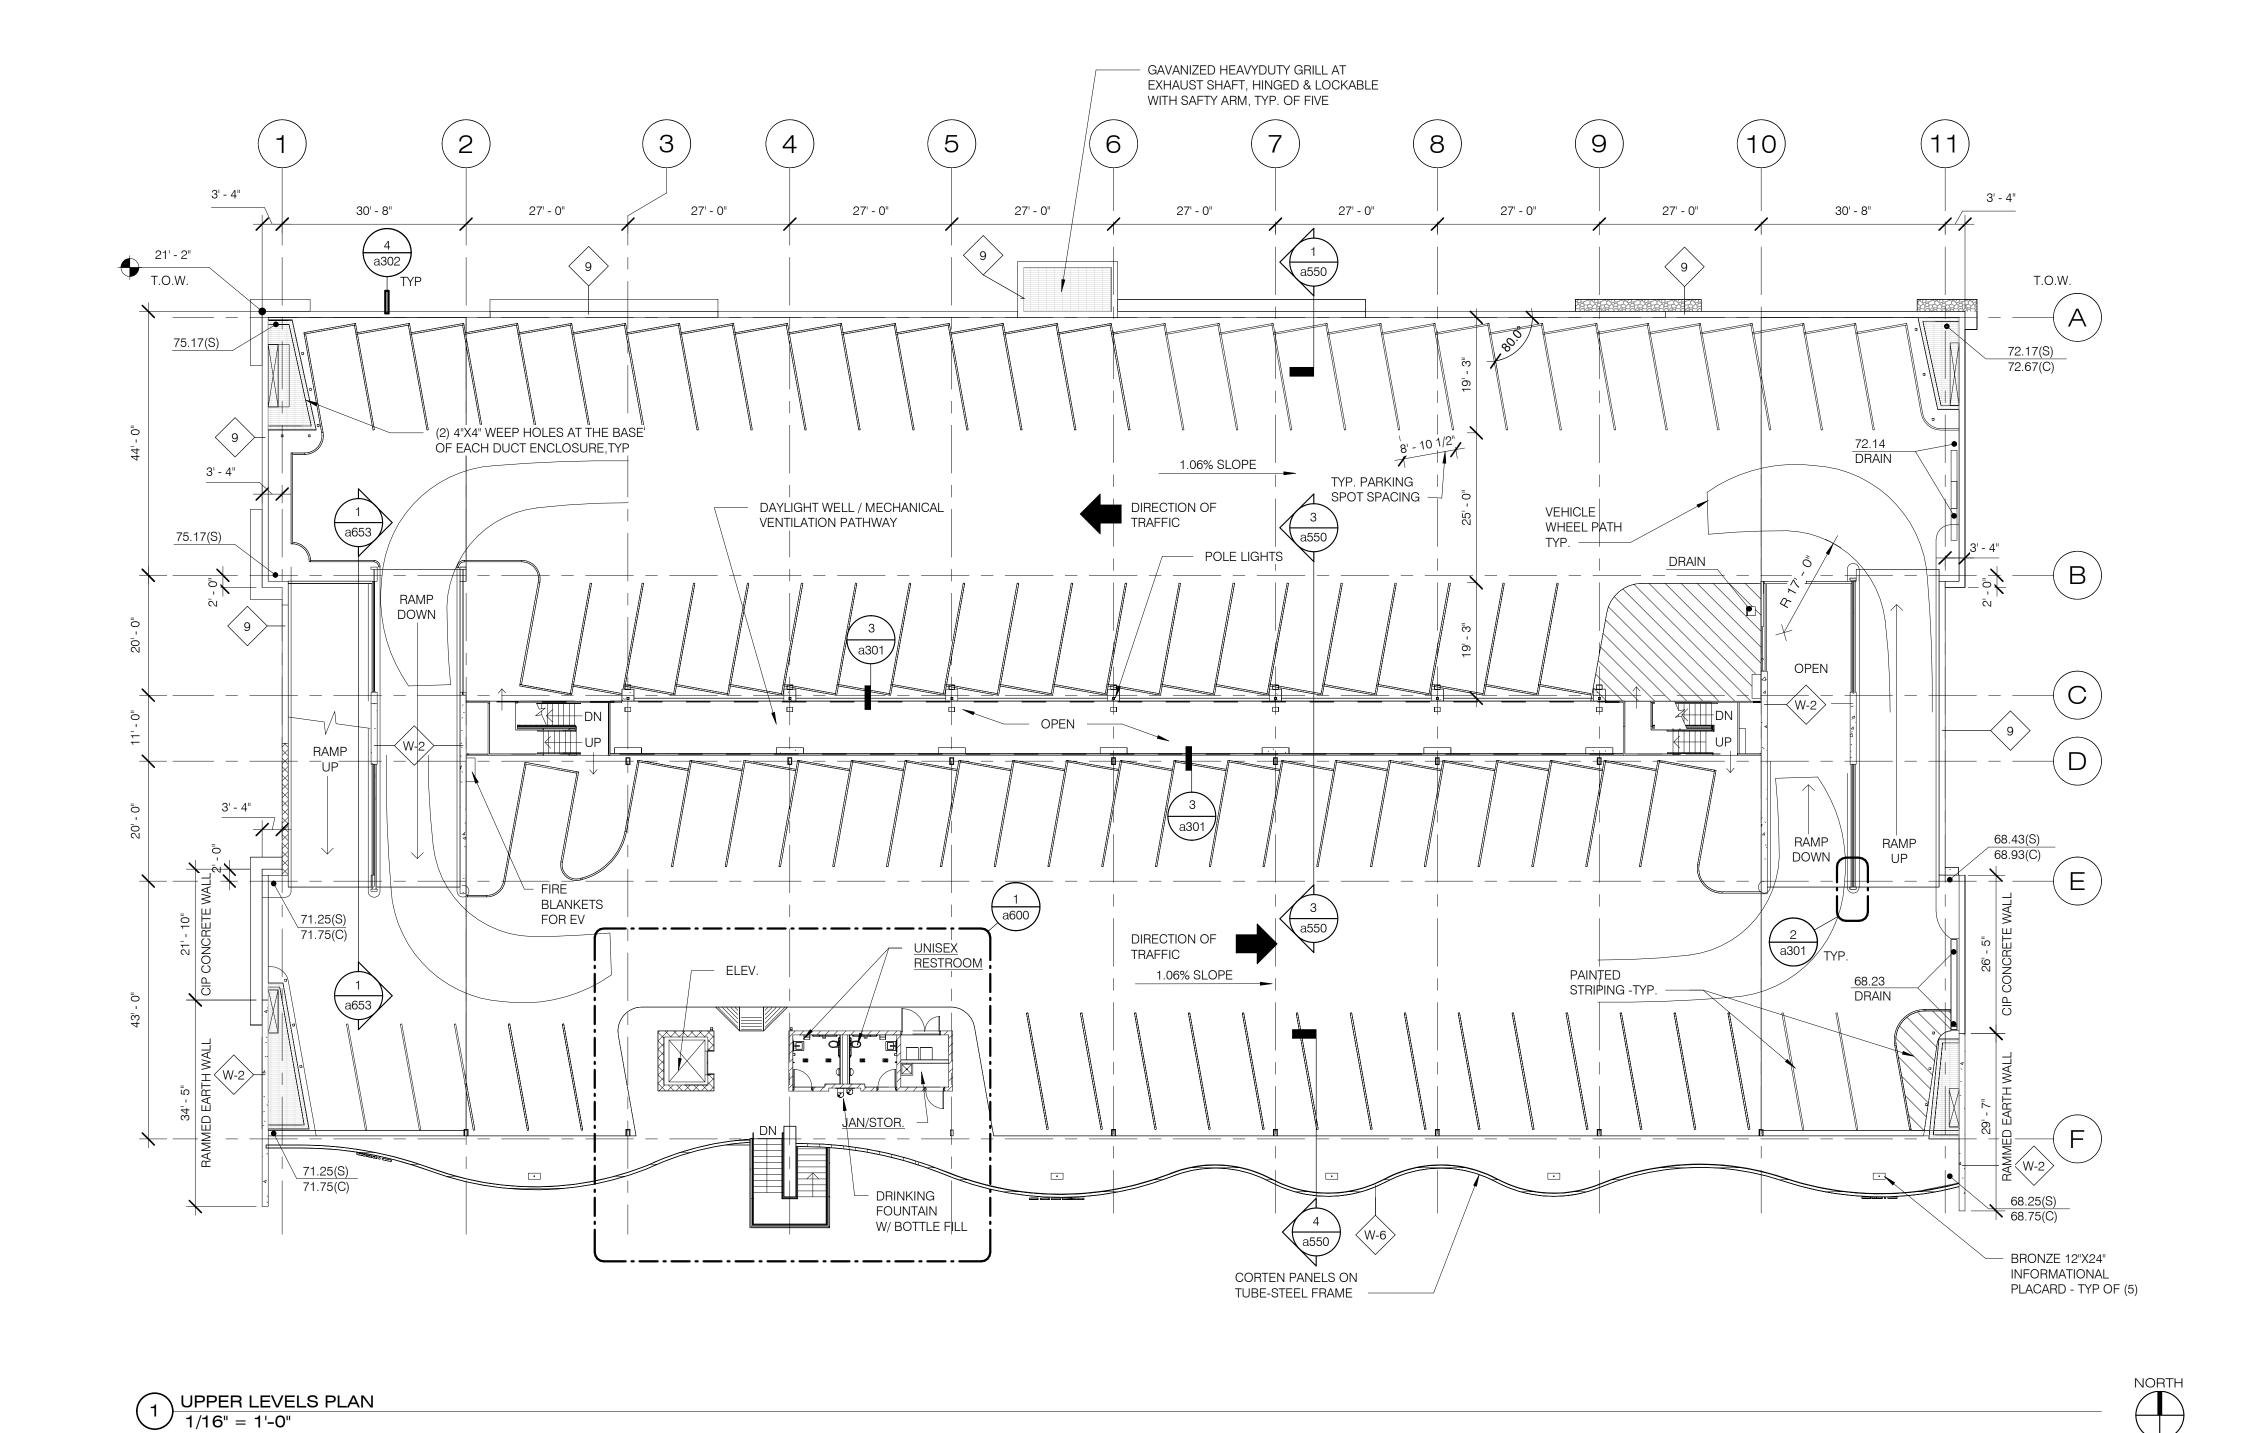
3326 n. 3rd avenue suite 200 phoenix, arizona 85013 tel: 602.667.9090 fax: 602.667.9133 gaborlorant.com



A.P.	CITY OF SEDONA PUBLIC WORKS DEPARTMEN 102 ROADRUNNER DRIVE
	SEDONA, ARIZONA 86336
	928-204-7111

Uptown Sedona Parking Facility 420 Forest Road, Sedona, AZ Ground Level Tier Plan

SHEET ID a101 SHEET NO.



DESCRIPTION 8" CONCRETE WALL, REINFORCE PER STRUCTURAL DOCUMENTS (W-1) 12" CONCRETE WALL, REINFORCE PER STRUCTURAL DOCUMENTS 12x8x16 CONCRETE MASONRY UNITS, GROUT CELLS W/ REINFORCING PER STRUCTURAL 8x8x16 CONCRETE MASONRY UNITS, GROUT CELLS W/ REINFORCING PER STRUCTURAL DOCUMENTS. PLUMBING WALL, 5/8" CEMENT BOARD ON 3-5/8" METAL STUDS AT 16" O.C. PROVIDE WALL TILE CORRUGATED CORTEN PANELS OVER STEEL TUBE FRAME WIRE MESH FENCING & GATES OVER STEEL TUBE FRAMING.

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Revisions

Symbol



Appr.

Designed by:

Drawn by:

Checked by:

11 March 2024


Project Code:

GLA PROJECT NO. 20109

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Uptown Sedona Parking Facility 420 Forest Road, Sedona, AZ

SHEET ID a102 SHEET NO.


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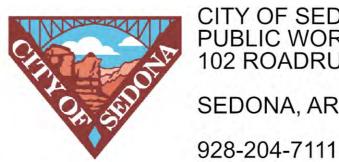
Roof Level Tier Plan 928-204-7111

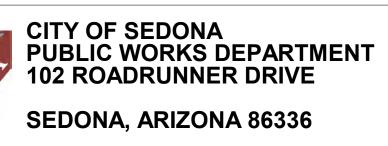

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CITY OF SEDONA PUBLIC WORKS DEPARTMENT 102 ROADRUNNER DRIVE SEDONA, ARIZONA 86336


Uptown Sedona Parking Facility 420 Forest Road, Sedona, AZ **Exterior Elevations** 


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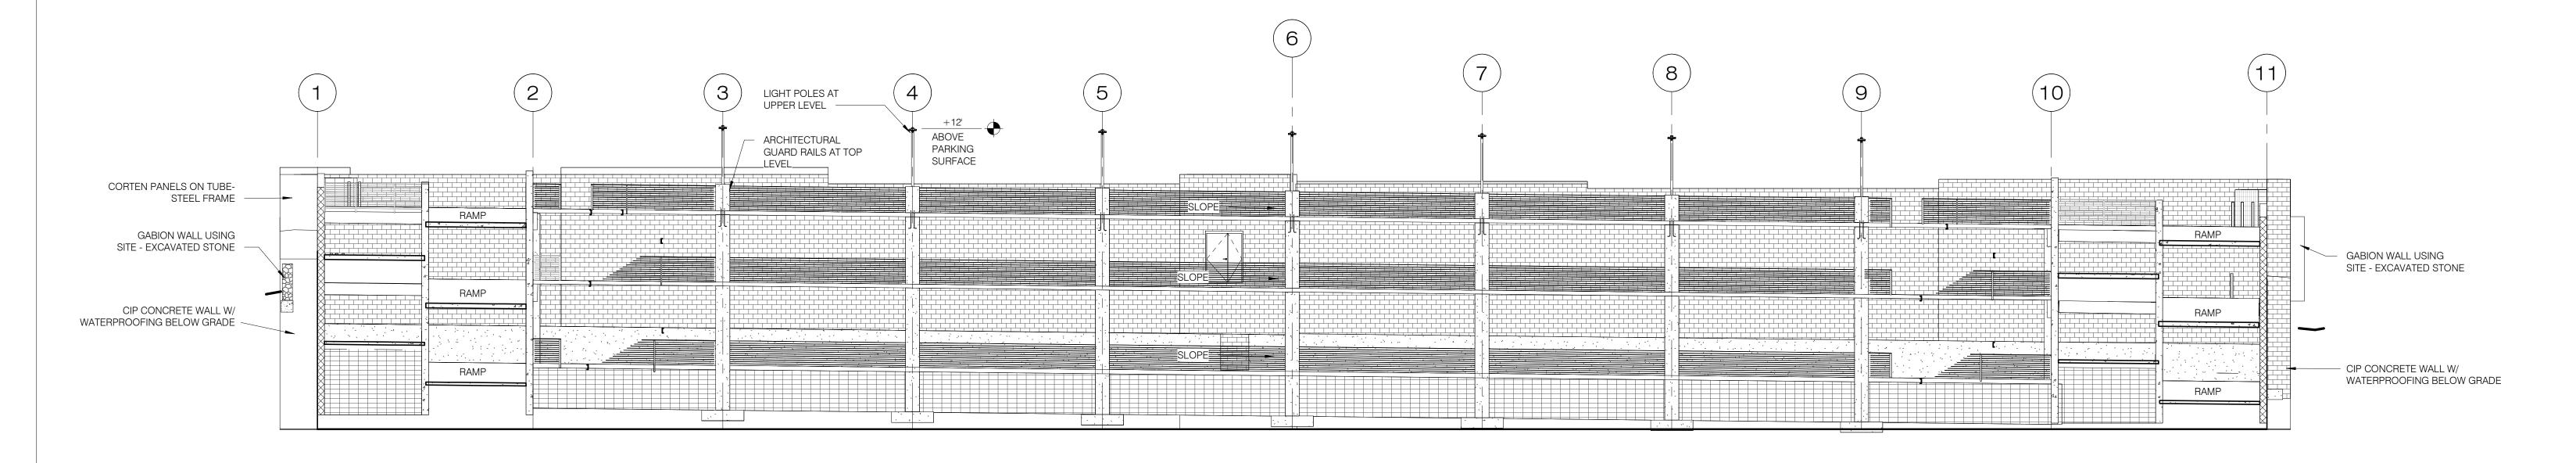
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			Checked by:	Project Code: GLA PROJECT NO. 20109

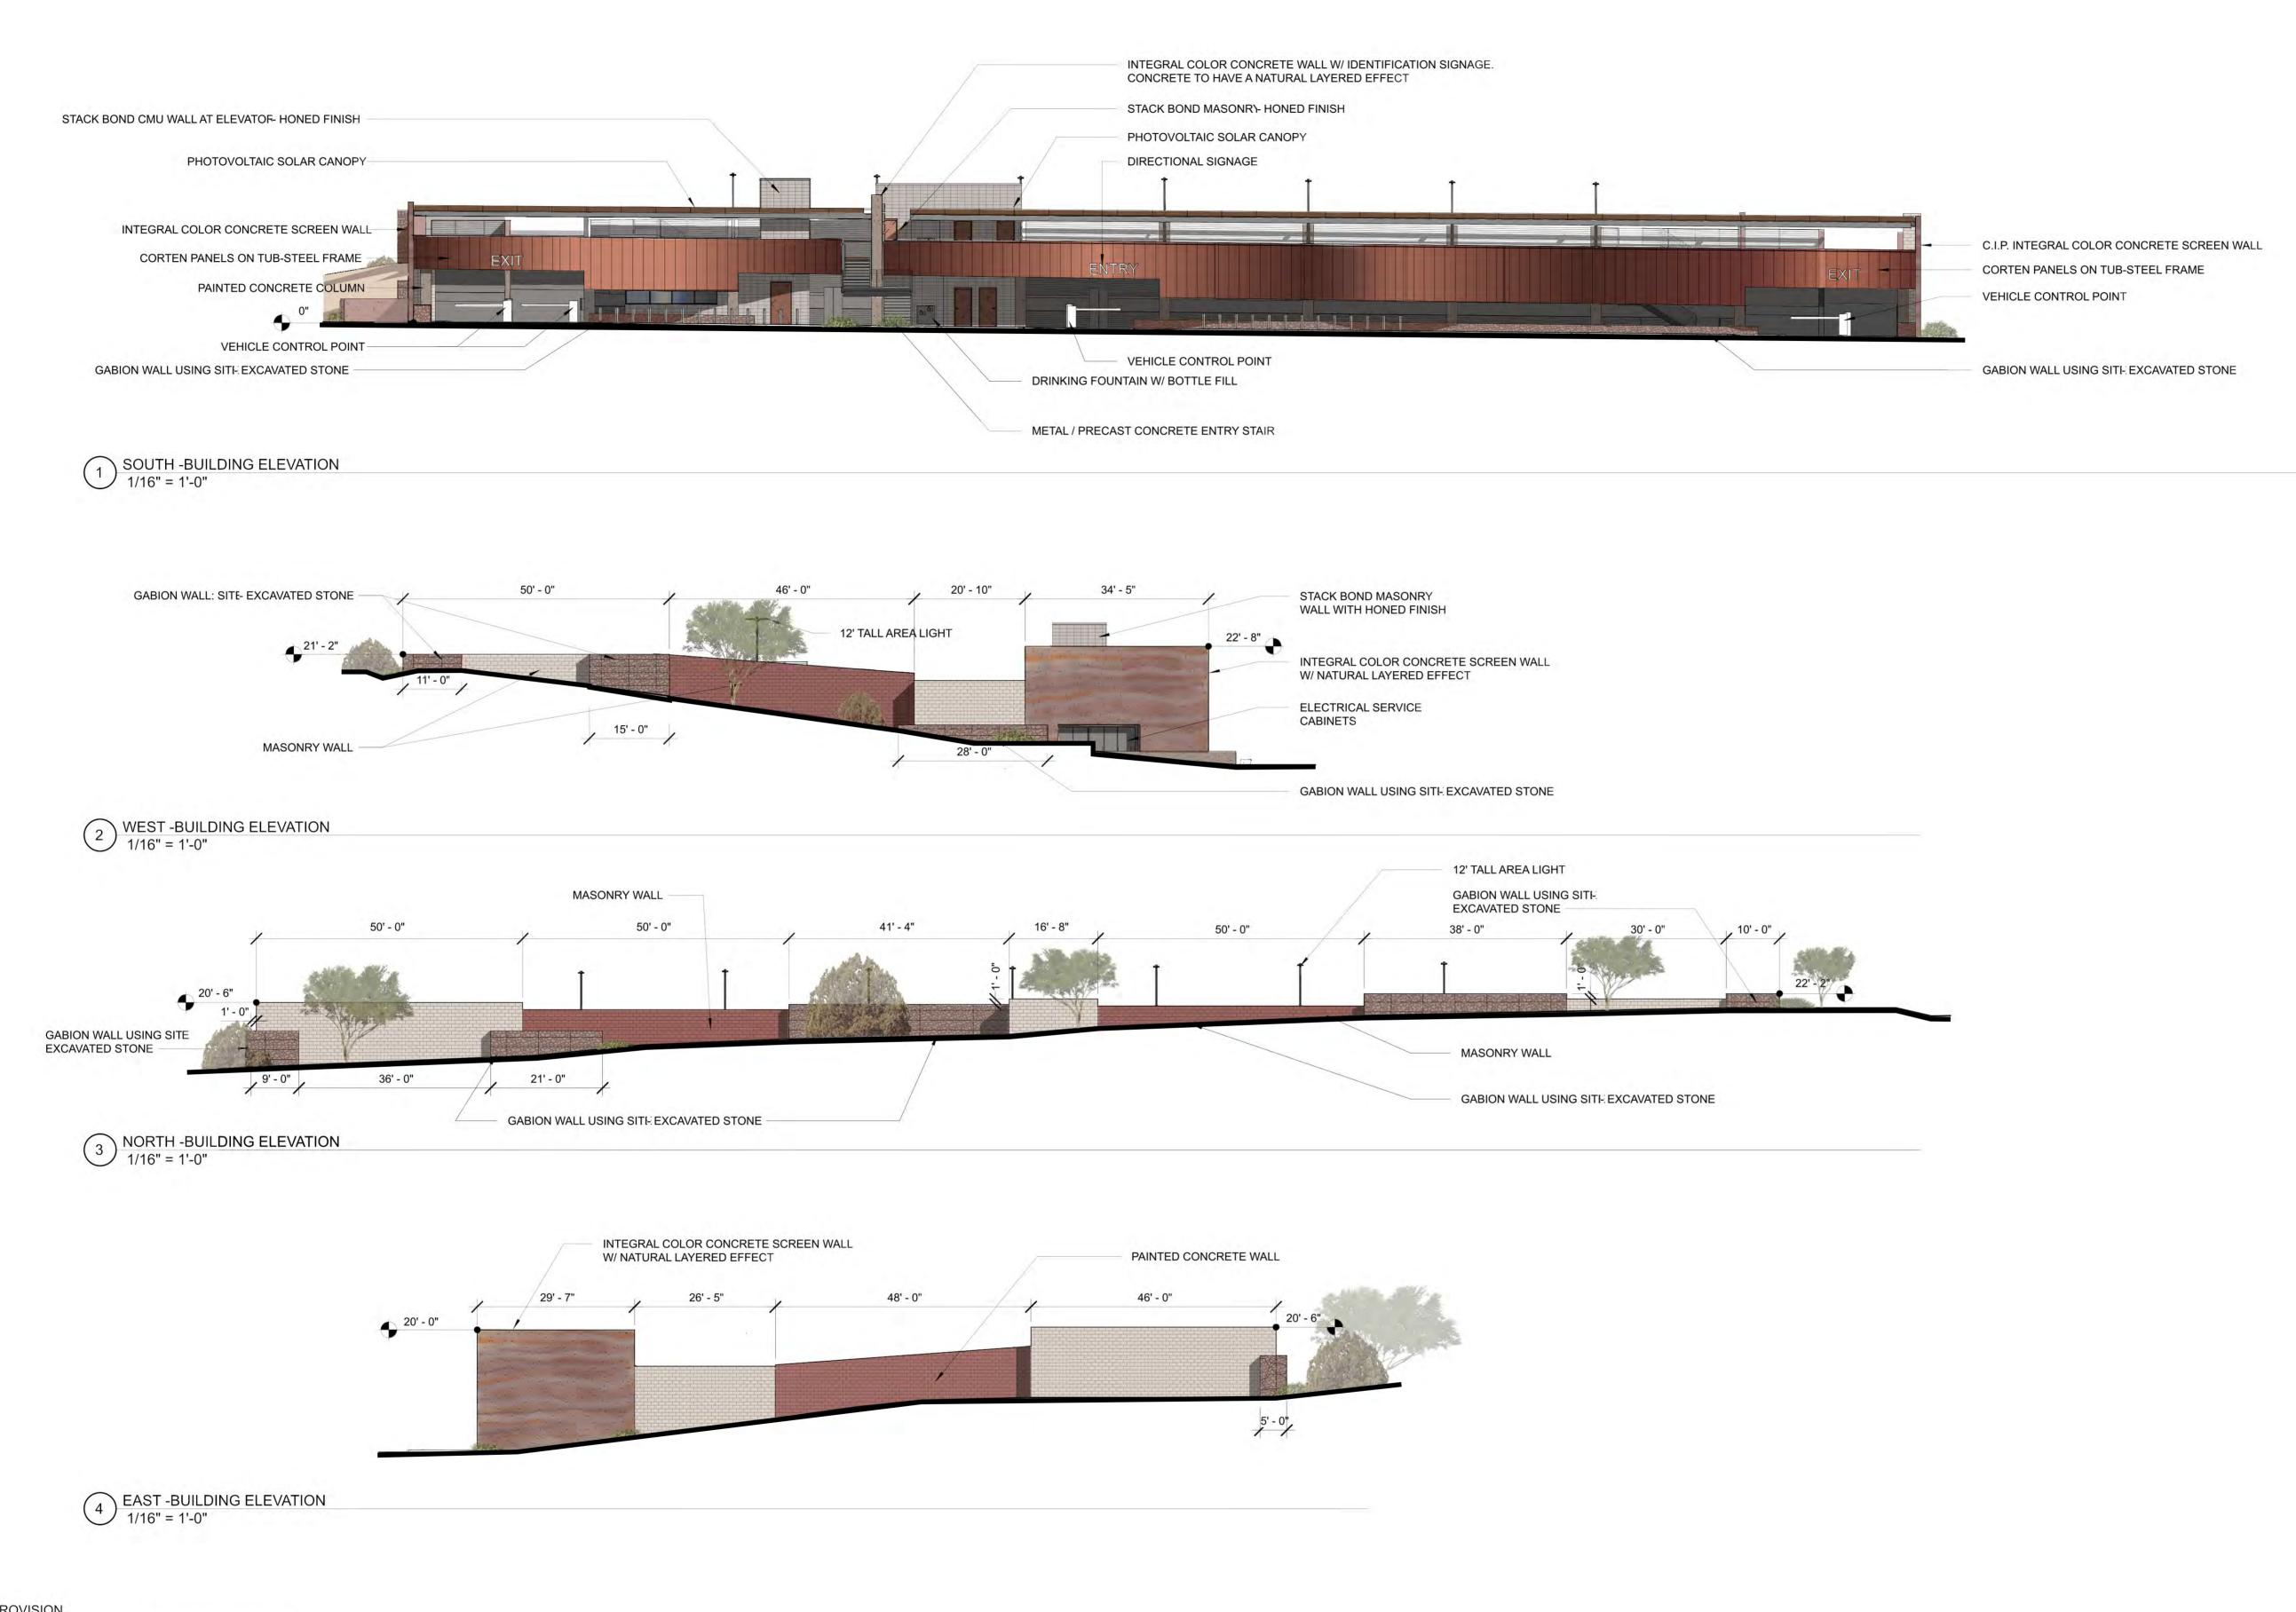



Section - A 3/32" = 1'-0"

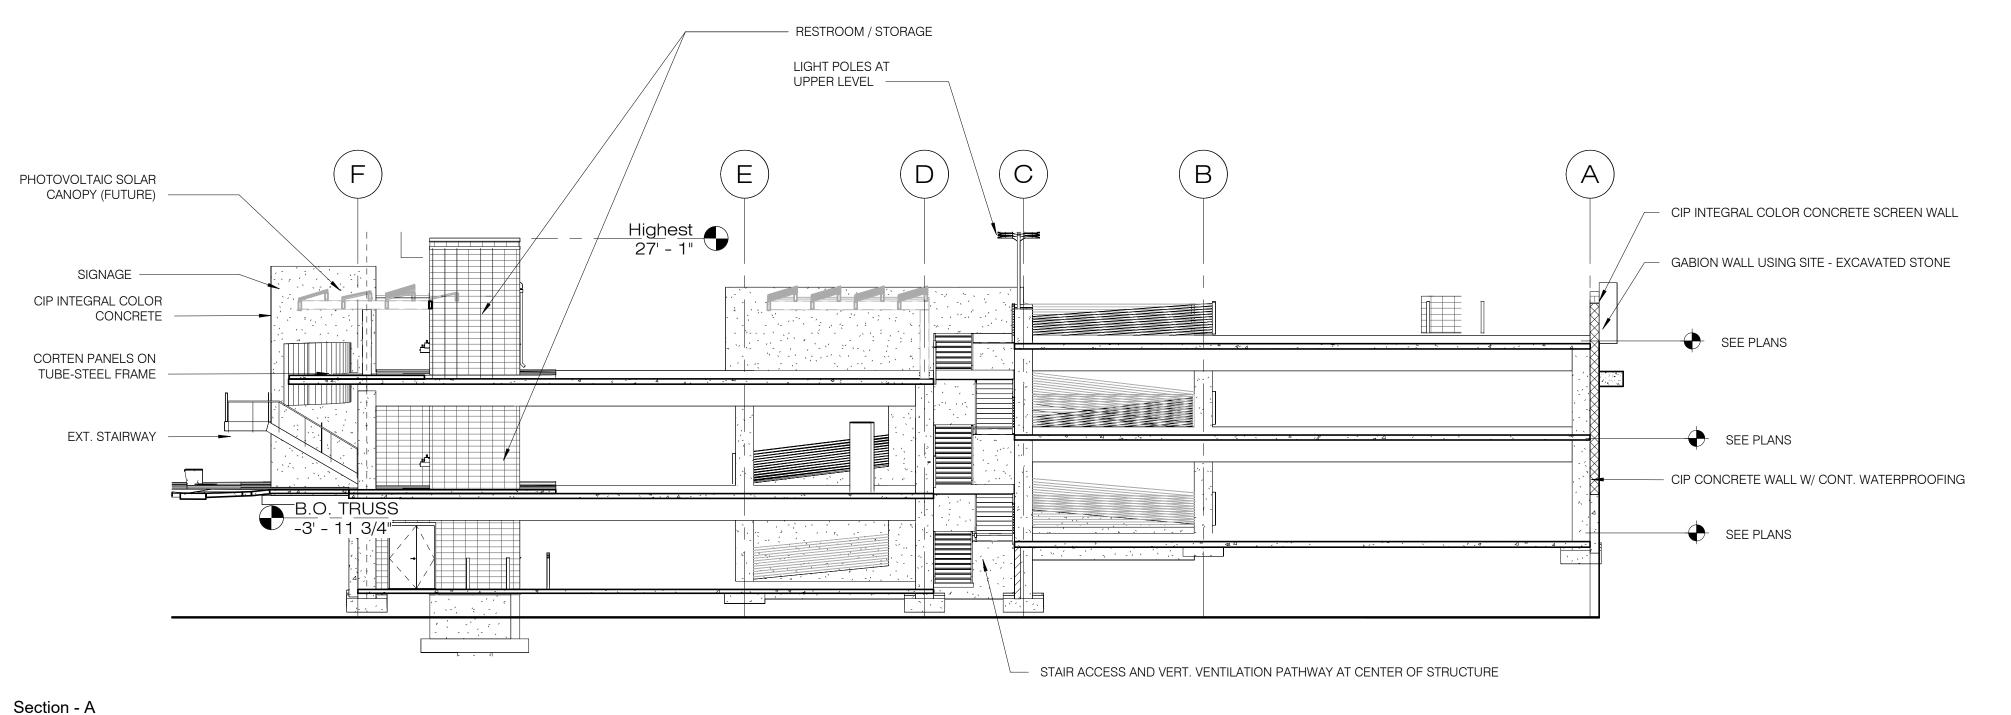

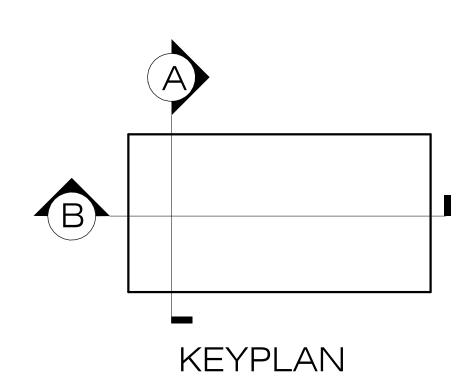Section - B 3/32" = 1'-0"

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CITY OF SEDONA
PUBLIC WORKS DEPARTMENT
102 ROADRUNNER DRIVE 928-204-7111

Uptown Sedona Parking Facility 420 Forest Road, Sedona, AZ Sections

IF NOT ONE INCH ON THIS SHEET, ADJUST SCALES ACCORDINGLY SHEET ID a500


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SHEET NO. OF

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				JL	11 March 2024
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				RGH	
				Checked by:	Project Code:
					GLA PROJECT NO. 20109

**SEDONA, ARIZONA 86336** 



KEYNOTES

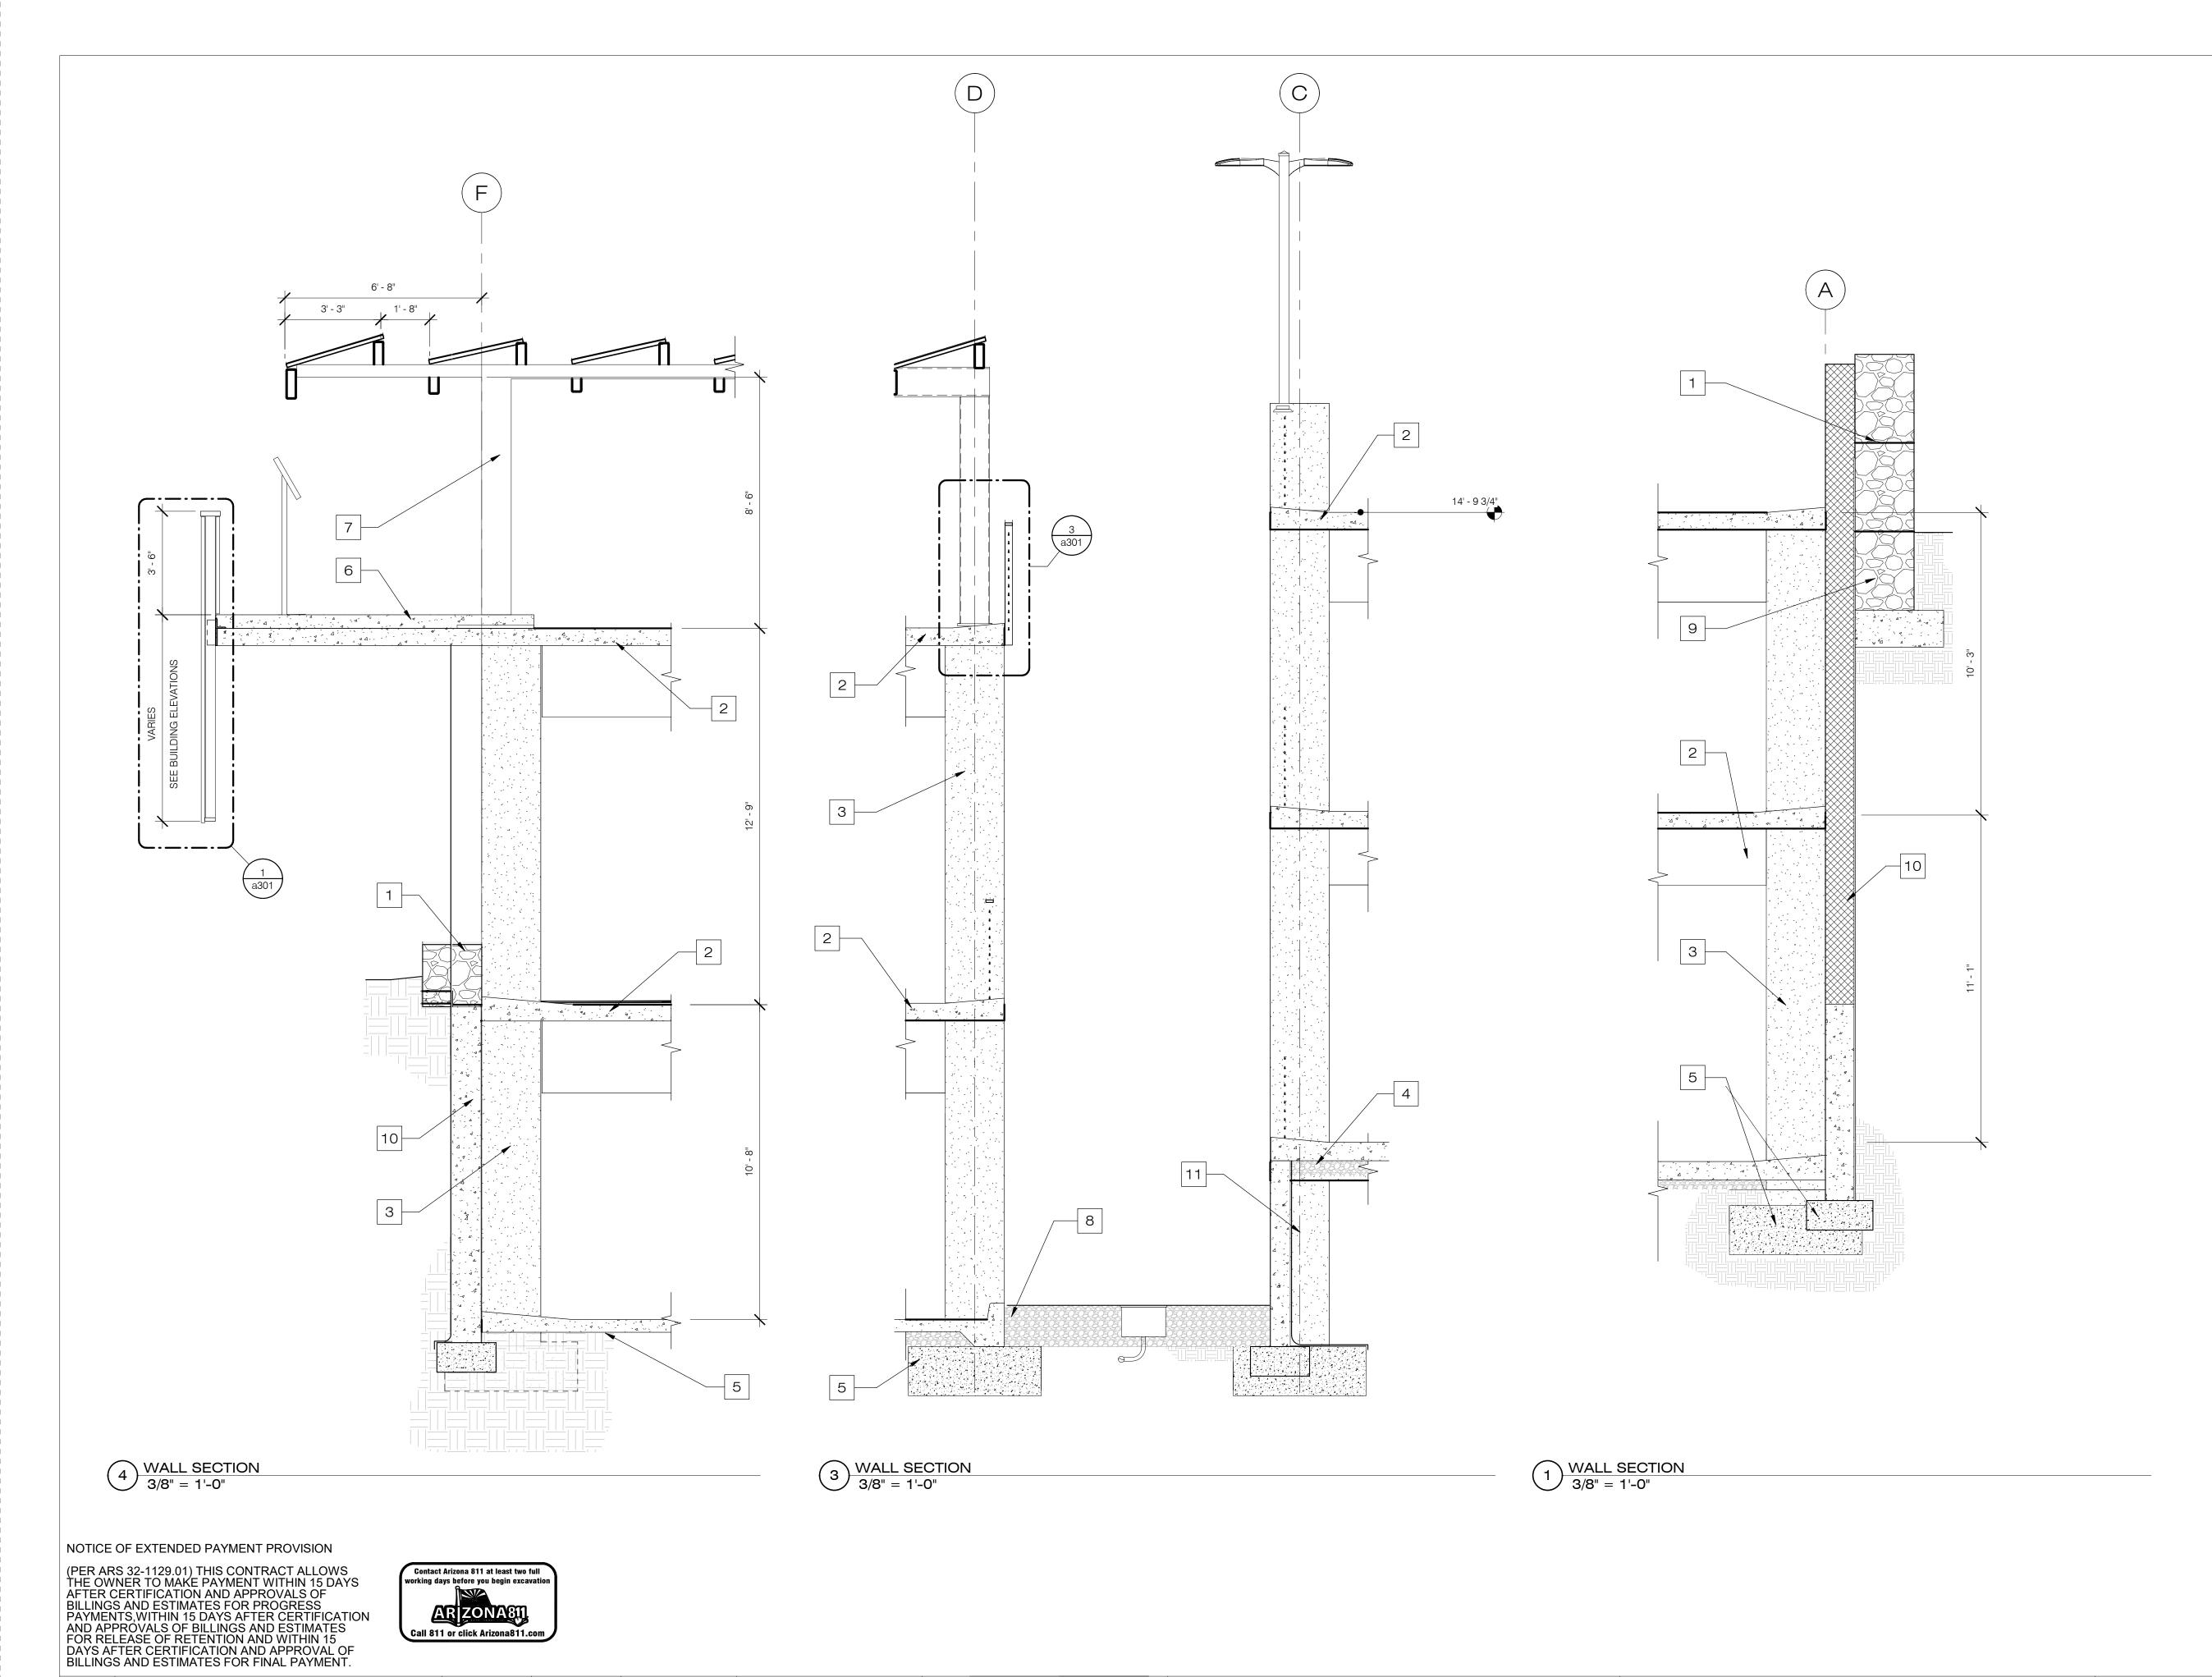1 24" DEEP GABION ROCK WALL

2 ELEVATED CONCRETE SLAB & BEAMS - SEE STRUCTURAL SHEETS

3 CONCRETE COLUMN - SEE STRUCTURAL SHEETS

4 CONCRETE SLAB ON GRADE - SEE STRUCTURAL SHEETS

CONCRETE FOOTING - SEE STRUCTURAL SHEETS

6 CONCRETE TOPPING SLAB, MIN 3-1/2" THICK, SLOPE TO DRAIN

SOLAR CANOPY & SUPPORT
5" TALL CONCRETE CURB

9 12" THICK X 3' WIDE CONCRETE FOOTING

10 12" THICK CONCRETE WALL

11 8" THICK CONCRETE WALL


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				Checked by:	Project Code:
				JL/JP	GLA PROJECT NO. 20109

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CITY OF SEDONA PUBLIC WORKS DEPARTMENT 102 ROADRUNNER DRIVE
SEDONA, ARIZONA 86336

928-204-7111

Uptown Sedona Parking Facility 420 Forest Road, Sedona, AZ Wall Sections

SHEET ID a550

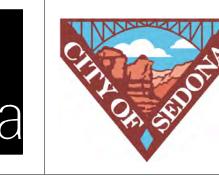SHEET NO. OF

# CITY OF SEDONA

# FOREST ROAD AT UPTOWN SEDONA PARKING GARAGE PROJECT NO. SEDONA IN MOTION (ST-XX)

LOCATED IN A PORTION OF SECTION 07, TOWNSHIP 17 NORTH,
RANGE 6 EAST, GILA AND SALT RIVER MERIDIAN,

	Sheet List Table					
Sheet Number	Sheet Title	Sheet Description				
01	COVERSHEET	CV01				
02	GENERAL NOTES	GN01				
03	TYPICAL SECTIONS	GN02				
04	GEOMETRIC CONTROL	GC01				
05	DEMOLITION PLAN	DM01				
06	GRADING AND DRAINAGE PLAN	GD01				
07	STORM DRAIN PLAN	SD01				
08	ROADWAY PLAN	RD01				
09	ROADWAY PLAN	RD02				
10	EROSION CONTROL PLAN	EC01				
11	EROSION CONTROL PLAN	EC02				

UTILITY COORDINATION BLOCK

KELLIE MCCUNE

JASON QUINLAN

TAYLOR MATHE

KEVIN WAGNER

ROXANNE HOLLAND

CASEY GOFF

COMPANY REPRESENTATIVE CONTACTED

☐ ARIZONA PUBLIC SERVICE

☐ ARIZONA WATER COMPANY

☐ SUDDEN LINK

☐ UNISOURCE

☐ CENTURY LINK

☐ SEDONA SEWER

# CACH HTMR. CACH H

**LOCATION MAP** 

### CONTACT INFORMATION

OWNER

102 ROADRUNNER DRIVE SEDONA, ARIZONA 86336 (928) 204-7111 KURTIS HARRIS, P.E. DIRECTOR OF PUBLIC WORKS/CITY ENGINEER

SR 89A

MAYOR
VICE MAYOR

SCOTT JABLOW HOLLI PLOOG

CITY COUNCIL

MELISSA DUNN BRIAN FULTZ PETE FURMAN KATHY KINSELLA

JESSICA WILLIAMSON
CITY MANAGER KAREN OSBURN

ENGINEER KIMLEY-HORN & ASSOCIATES, INC.

ANDREW BAIRD, P.E. 101 W GOODWIN STREET, SUITE 303 PRESCOTT, AZ 86303

(928) 458-7121 ANDREW.BAIRD@KIMLEY-HORN.COM

### **APPROVALS**

APPROVED:

KURTIS HARRIS, P.E.
DIRECTOR OF PUBLIC WORKS/CITY ENGINEER

RECORD DRAWING STATEMENT

I , HEREBY STATE, BASED ON MY FIELD OBSERVATION AND INFORMATION PROVIDED BY THE GENERAL CONTRACTOR AND OTHERS, THAT THE WORK ON SHEETS 1 THROUGH 17, MARKED AS "RECORD DRAWING" HAS BEEN CONSTRUCTED IN SUBSTANTIAL CONFORMANCE WITH THESE CONSTRUCTION PLANS, SPECIFICATIONS, INCLUDING CHANGES AND REVISIONS.

REGISTERED LAND SURVEYOR/ENGINEER

DATE

REGISTRATION NUMBER

EXPIRATION DATE



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FOR REVIEW ONLY
NOT FOR CONSTRUCTION

Kimley Horn


ENGINEER A. BAIRD
PE NO. 48841 DATE 02/24

Kimley» Horn

. 2024 KIMLEY-HORN AND ASSOCIATES, INC.

101 WEST GOODWIN ST, SUITE 303 PRESCOTT ARIZONA, 86303
PHONE: 928-458-7121

WWW.KIMLEY-HORN.COM

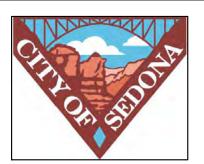

CITY OF SEDONA
PUBLIC WORKS DEPARTMENT
102 ROADRUNNER DRIVE
SEDONA, ARIZONA 86336

928-204-7111

UPTOWN SEDONA PARKING GARAGE SHEET ID CV01

COVERSHEET

SHEET NO.

01 OF 11

PRS\_Roadway\091885001-Uptown Sedona Parking Garage\CAD\PlanSheets\CV

### SEDONA GENERAL NOTES

### A. GENERAL


- 1. ALL STRUCTURES ARE DESIGNED TO ACT AS A STRUCTURAL UNIT UPON COMPLETION. CONTRACTOR SHALL DESIGN AND PROVIDE NECESSARY BRACING, TEMPORARY SUPPORTS, AND SHORING TO RESIST FORCES ON THE STRUCTURE DURING CONSTRUCTION.
- 2. VERIFY ALL DIMENSIONS AND ELEVATIONS PRIOR TO STARTING WORK. NOTIFY THE ENGINEER OF ANY DISCREPANCIES.
- VERIFY LOCATIONS OF ALL EXISTING UTILITIES PRIOR TO STARTING WORK.
- 4. CONTRACTOR SHALL EXERCISE EXTREME CARE DURING THE EXCAVATION AND CONSTRUCTION FOR NEW STRUCTURE TO AVOID DAMAGE TO EXISTING STRUCTURES AND EXISTING UTILITIES. CONTRACTOR IS RESPONSIBLE FOR PROVIDING ALL MEANS AND METHODS REQUIRED TO FACILITATE CONSTRUCTION OF THE WORK AND ENSURING THE SAFETY, STABILITY AND INTEGRITY OF ADJACENT STRUCTURES AND FACILITIES.
- 5. THE ENGINEER SHALL BE NOTIFIED A MINIMUM OF 24 HOURS PRIOR TO BEGINNING ANY CONSTRUCTION
- 6. ANY WORK PERFORMED WITHOUT THE KNOWLEDGE AND APPROVAL BY THE ENGINEER AND/OR ALL WORK MATERIAL NOT IN CONFORMANCE WITH THE PLANS AND SPECIFICATIONS IS SUBJECT TO REMOVAL AND REPLACEMENT AT THE CONTRACTOR'S EXPENSE.
- 7. NO JOB WILL BE CONSIDERED COMPLETE UNTIL ALL CURBS, PAVEMENT AND SIDEWALKS (NEW AND EXISTING) HAVE BEEN SWEPT CLEAN OF ALL DIRT AND DEBRIS.
- 8. ALL QUANTITIES SHOWN ON PLANS ARE APPROXIMATE, ARE NOT VERIFIED BY THE ENGINEER, AND ARE FURNISHED SOLELY FOR THE CONTRACTOR'S CONVENIENCE. THEY DO NOT NECESSARILY CORRESPOND TO BID SCHEDULE ITEMS. PAYMENT WILL BE BASED ON BID SCHEDULE ITEMS. THE CONTRACTOR SHALL NOT BE RELIEVED OF HIS RESPONSIBILITY FOR INDEPENDENTLY ESTIMATING WORK QUANTITIES PRIOR TO BIDDING.
- 9. BACKFILL COMPACTION AND SUBGRADE PREPARATION SHALL BE PER MAG STANDARD SPECIFICATION 301, UNLESS OTHERWISE NOTED.
- 10. REMOVAL OF STRUCTURES AND OBSTRUCTIONS AS NECESSARY TO COMPLETE THE WORK, OTHER THAN SPECIALLY SCHEDULED IN THE BID, IS INCIDENTAL TO THE CONTRACT. NO SEPARATE MEASUREMENT OF PAYMENT FOR UNSCHEDULED REMOVAL ITEMS WILL BE MADE.
- 11. CONSTRUCTION STAKING SHALL BE BY THE CONTRACTOR'S SURVEYOR WITH CONTROL PROVIDED BY THE DESIGN ENGINEER WHO STAMPED THE PLANS.
- 12. THE SEDONA CITY MAY ORDER ANY OR ALL WORKMANSHIP AND MATERIALS TO BE TESTED ACCORDING TO APPLICABLE STANDARDS.
- 13. THE CONTRACTOR WILL BE RESPONSIBLE FOR ALL REWORK AND/OR REMOVAL AND REPLACEMENT OF ALL MATERIALS AND/OR WORKMANSHIP REPRESENTED BY A FAILING TEST.
- 14. THE CONTRACTOR WILL BE RESPONSIBLE FOR ALL COSTS OF TESTING AND QUALITY ASSURANCE/QUALITY CONTROL AS DELINEATED IN THE CITY'S PROJECT SPECIFICATIONS. THE COST OF TESTING IS INCIDENTAL TO EACH ITEM OF WORK. THE CONTRACTOR SHALL ALSO BE RESPONSIBLE FOR THE COST OF ANY CITY INSPECTION AND CITY INSPECTION TIME IF THE CONTRACTOR'S WORK IS BEING PERFORMED IN OVERTIME, AT NIGHT, OR ON WEEKENDS (FRI, SAT, SUN).
- 15. APPROVAL OF A PORTION OF THE WORK IN PROGRESS DOES NOT GUARANTEE ITS FINAL ACCEPTANCE. TESTING AND EVALUATION MAY CONTINUE UNTIL WRITTEN FINAL ACCEPTANCE OF A COMPLETE AND WORKABLE UNIT.
- 16. THE OWNER MAY SUSPEND THE WORK BY WRITTEN NOTICE WHEN, IN ITS JUDGEMENT, PROGRESS IS UNSATISFACTORY, WORK BEING DONE IS UNAUTHORIZED OR DEFECTIVE, WEATHER CONDITIONS ARE UNSUITABLE, OR THERE IS A DANGER TO THE PUBLIC HEALTH OR SAFETY.
- 17. CLEARING AND GRUBBING IS CONSIDERED INCIDENTAL TO THE WORK UNLESS SEPARATELY IDENTIFIED IN THE BID SCHEDULE. NO SEPARATE MEASUREMENT OF OR PAYMENT FOR CLEARING, GRUBBING, AND TREE REMOVAL WILL BE MADE. THE SITE OF ALL EXCAVATION, EMBANKMENTS, AND FILLS SHALL FIRST BE CLÉARED OF STUMPS, TRASH, WEEDS, RUBBISH, AND LOOSE BOULDERS WHICH SHALL BE REMOVED AND DISPOSED OF. THE CONTRACTOR MUST SATISFY HIMSELF REGARDING THE CHARACTER AND AMOUNT OF LOAM, CLAY, SAND, QUICKSAND, HARDPAN, GRAVEL, ROCK, WATER, AND ALL OTHER MATERIAL TO BE ENCOUNTERED AND WORK TO BE PERFORMED.
- 18. THE LOCATIONS OF ALL EXISTING UTILITIES SHOWN ARE APPROXIMATE AND ARE BASED ON FIELD DATA AND MAP RECORDS. THE CONTRACTOR SHALL CONTACT 1-800-STAKE-IT PRIOR TO ANY CONSTRUCTION ACTIVITY TO VERIFY THE ACTUAL LOCATION OF ALL UTILITIES. THE CONTRACTOR SHALL DETERMINE WHICH UTILITIES DO NOT PARTICIPATE IN 1-800-STAKE-IT AND CONTACT THEM DIRECTLY TO VERIFY THE LOCATION OF THOSE UTILITIES. ANY DAMAGE TO EXISTING UTILITIES CAUSED BY CONTRACTOR'S OPERATION SHALL BE REPORTED TO THE UTILITY OWNER IMMEDIATELY AND REPAIRED OR REPLACED AT NO COST TO THE CITY. IN CASES WHEN THE EXISTING UTILITIES ARE NOT AS DEPICTED ON THE PLANS SOME MINOR DEVIATION TO THE PROPOSED ALIGNMENT MAY BE ALLOWED TO MAINTAIN MINIMUM SEPARATION DISTANCES BETWEEN UTILITIES. ANY PROPOSED TO MAINTAIN MINIMUM SEPARATION DISTANCES BETWEEN UTILITIES. ANY PROPOSED TO CHANGES TO THE ALIGNMENT MUST BE SUBMITTED TO THE CITY'S REPRESENTATIVE FOR REVIEW. NO CHANGES WILL BE ALLOWED WITHOUT PRIOR APPROVAL.
- 19. THE CONTRACTOR SHALL LIMIT THE WORK AREA TO PUBLIC RIGHT-OF-WAY AND PERMANENT EASEMENTS AS SHOWN FOR CONSTRUCTION OF THE PROJECT. TEMPORARY CONSTRUCTION EASEMENTS EXIST AS SHOWN AND INDICATED IN THE PLANS.
- 20. CONTRACTOR SHALL OBTAIN ANY ADDITIONAL TEMPORARY EASEMENTS OR USE AGREEMENTS THAT ARE DEEMED NECESSARY FOR CONSTRUCTION AT NO ADDITIONAL COST TO THE CITY. COPIES OF ALL CONTRACTOR OBTAINED EASEMENTS AND USE AGREEMENTS SHALL BE PROVIDED TO THE CITY'S REPRESENTATIVE PRIOR TO THE UTILIZATION OF THE SITE.
- 21. THE CONTRACTOR SHALL GRADE AND RESURFACE ALL AREAS DISTURBED BY CONSTRUCTION, INCLUDING LANDSCAPE ROCK, IN ACCORDANCE WITH THE SPECIFICATIONS AND TO A CONDITION EQUAL TO, OR BETTER THAN, THE PRE-CONSTRUCTION CONDITION.
- 22. THE CONTRACTOR SHALL PROTECT ALL CONCRETE STRUCTURES TO REMAIN. ALL CONCRETE REPLACEMENT SHALL BE FROM JOINT TO JOINT (WALLS, SIDEWALK) AND SHALL BE REPLACED WITH 4000 PSI CONCRETE, ALL DAMAGED CONCRETE PANELS MUST BE REPLACED AND SHALL BE THE RESPONSIBILITY OF THE CONTRACTOR.
- 23. THE CONTRACTOR SHALL PROVIDE PROTECTION TO PREVENT UNDERMINING OR DAMAGING THE STRUCTURAL INTEGRITY OF ALL FENCES, RETAINING WALLS, STREET SIGNS, OTHER UTILITY POLES, OR OTHER PRIVATE OR PUBLIC IMPROVEMENTS WITHIN THE PROJECT AREA. THE CONTRACTOR SHALL MAKE ARRANGEMENTS WITH THE OWNING UTILITY AS NECESSARY TO PROVIDE TEMPORARY SUPPORT, OR PROTECTION DURING CONSTRUCTION WORK, AND SHALL NEATLY REMOVE AND PROMPTLY REPLACE NON UTILITY IMPROVEMENTS WITHOUT UNDUE DISRUPTION. THE COST OF ALL SUCH PROTECTION, REMOVAL, AND REPLACEMENT REQUIRED TO COMPLETE THE PROJECT SHALL BE SUBSIDIARY TO OTHER BID ITEMS.
- 24. THE CONTRACTOR SHALL REMOVE ALL FENCING, ASPHALT AND CONCRETE ROADS AND DRIVEWAYS, CURB AND GUTTER, RIP-RAP. DRAINAGE CULVERTS AND ASSOCIATED APPURTENANCES ÁS REQUIRED FOR CONSTRUCTION PURPOSES. ALL ITEMS DAMAGED OR REMOVED SHALL BE RESTORED IN ACCORDANCE WITH THE SPECIFICATION TO A CONDITION EQUAL TO, OR BETTER THAN, THEIR CONDITION PRIOR TO THE START OF THE PROJECT. ITEMS OF WORK NOT SPECIFICALLY INCLUDED IN THE MEASUREMENTS AND PAYMENT SECTION OF THE SPECIFICATIONS SHALL BE CONSIDERED SUBSIDIARY TO OTHER BID ITEMS AND SHALL NOT BE PAID FOR SEPARATELY.
- 25. IT IS NOT THE INTENTION OF THE SPECIFICATIONS TO SUPERSEDE ANY FEDERAL, STATE OR LOCAL LAWS, REGULATIONS AND/OR ORDINANCES; THEY SHALL GOVERN IN ALL INSTANCES. IT IS THE CONTRACTOR'S RESPONSIBILITY TO SHOW A GOOD FAITH EFFORT AND TO PROTECT ALL EXISTING UTILITY TIES AND STRUCTURES AND TO ABIDE BY ALL FEDERAL, STATE AND LOCAL LAWS AND ORDINANCES IN THIS
- 26. THE CONTRACTOR SHALL PROTECT ALL EXISTING IMPROVEMENTS ON PRIVATE PROPERTY. ALL ITEMS DAMAGED OR REMOVED SHALL BE RESTORED IN ACCORDANCE WITH THE SPECIFICATION TO A CONDITION EQUAL TO, OR BETTER THAN, THEIR CONDITION PRIOR TO THE START
- 27. PROPERTY LINES SHOWN ON DRAWINGS ARE APPROXIMATE.

Revisions

- 28. ALL WORK SHALL BE PERFORMED IN ACCORDANCE WITH THE PROJECT PLANS AND SPECIFICATIONS AS WELL AS THE LATEST ADDITION OF MAG STANDARDS AND DETAILS AND THE LHC ENGINEERING SPECIFICATIONS.
- 29. ALL WORK SHALL BE PREFORMED IN ACCORDANCE WITH THE GEOTECHNICAL REPORT PREPARED BY VANN ENGINEERING INC, DATED MAY 4,
- 30. UNLESS OTHERWISE INDICATED, CURBING, WALKWAY/SUP SHALL UTILIZE "SEDONA RED" COLORED CONCRETE (SEDONA RED COLORATION AS MANUFACTURED BY HANSEN CONCRETE, COTTONWOOD, AZ).
- 31. PRIOR TO CLEARING AND GRUBBING ACTIVITIES, THE CONTRACTOR SHALL STAKE THE LIMITS OF CUT AND FILL SLOPES (I.E. CONSTRUCTION LIMITS) AND COORDINATE A SITE WALK WITH THE CITY TO IDENTIFY TREE AND OTHER VEGETATION WITHIN CUT AND FILL LIMITS THAT CAN BE RÉASONABLY PROTECTED IN PLACE. SUCH VEGETATION SHALL BE FLAGGED FOR PRESERVATION.

Appr.

Date

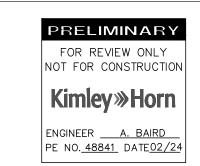

Date:

Scale:

Project Code:

02/05/2024

091885001

Designed by:

Drawn by:

Checked by:

JRW

ACB







### **CITY OF SEDONA** PUBLIC WORKS DEPARTMENT **102 ROADRUNNER DRIVE**

AB

ABC

BP

CONC

CONST

**ELEV** 

**EXIST** 

FT.

AGGREGATE BASE

**BEGIN PROJECT** 

CONSTRUCTION

COMMUNICATION

CENTERLINE

CONCRETE

DRIVE PATH

DETAIL

EASTING

ELECTRIC

**EXISTING** 

FLOWLINE

FEET

ELEVATION

**END PROJECT** 

FACE OF CURB

FIRE HYDRANT

EACH

ASPHALTIC CONCRETE

AGGREGATE BASE COURSE

SEDONA, ARIZONA 86336 928-204-7111

### **UPTOWN SEDONA** PARKING GARAGE

GENERAL NOTES

SHEET ID **GN01** 

LEGEND

	EXISTING WATER METER	ER	EXISTING ELECTRIC RISER	
WR	EXISTING WATER RISER		PROPOSED GUTTER LINE	
$\otimes$	EXISTING WATER VALVE	5520	EXISTING CONTOUR	
	EXISTING FIRE HYDRANT	<del></del> 5520 <del></del>	PROPOSED CONTOUR	
SS	EXISTING SANITARY SEWER MANHOLE		EXISTING STORM DRAIN	
	EXISTING STORM DRAIN INLET		PROPOSED STORM DRAIN	
SD	EXISTING STORM DRAIN MANHOLE		LIMITS OF DISTURBANCE	
Ø	EXISTING ELECTRIC POLE		FLOW LINE	}
*	EXISTING LIGHT POST	s	EXISTING SANITARY SEWER LINE	r
	EVICTING CION	T	EXISTING COMMUNICATION LINE	
-	EXISTING SIGN	G	EXISTING GAS LINE	• • •
TR	EXISTING TELEPHONE RISER	——— FO ———	EXISTING FIBER OPTIC LINE	
	SURVEY BENCHMARK		EXISTING BUILDING OVERHANG	
	EXISTING ELECTRIC METER		PROPERTY LINE, R.O.W.	
EM IV	EXISTING IRRIGATION VALVE	——————————————————————————————————————	EXISTING WATER LINE	

TOTAL THICKNESS = 12" PAVEMENT STRUCTURAL SECTION NO. 01

**ACRONYM / ABBREVIATION** 

LINEAR FEET

LANDSCAPE ISLAND

POINT OF TANGENT

QUAD CITY

HEIGHT

INVERT

LEFT

INV

LT

LF

MH

POB

POE

PT

M.A.G.

PROPOSED CROSSWALK STRIPING PROPOSED SIDEWALK CURB RAMP . . . . . . . . . PROPOSED LANDSCAPE AREA \* \* \* \* \* \* \* \* \* \* PROPOSED PAVEMENT PROPOSED CONCRETE REMOVE CONCRETE SIDEWALK EXISTING CONCRETE

9" ABC IN ACCORDANCE

WITH MAG SPEC.

SECTION 702

### ADOT GENERAL NOTES - ADOT ENCROACHMENT PERMITS

- A. THESE ADOT COMPLIANCE STATEMENTS SHALL BE INCLUDED IN YOUR PROJECT PLANS: "ALL WORK WITHIN THE ARIZONA DEPARTMENT OF TRANSPORTATION RIGHT-OF-WAY, HELD EITHER IN EASEMENT, FEE OR DEDICATED, SHALL DESIGNED AND CONSTRUCTED IN ACCORDANCE WITH ADOT PUBLICATIONS AS CURRENTLY REVISED, INCLUDING BUT NOT LIMITED TO THE FOLLOWING:
  - (1). STANDARD SPECIFICATIONS FOR ROAD AND BRIDGE CONSTRUCTION 2008 EDITION
  - (2). CONSTRUCTION STANDARD DRAWINGS MAY 2012 EDITION INCLUDING REVISIONS
  - (3). TRAFFIC ENGINEERING STANDARDS, GUIDELINES AND REFERENCES (A). GUIDELINES AND PROCESSES - JUNE 2015
    - (B). ARIZONA MANUAL OF APPROVED SIGNS (MOAS) . SIGNING AND MARKING STANDARD DRAWINGS.
    - (D). SIGNALS AND LIGHTING STANDARD DRAWINGS
    - (E). MANUAL OF UNIFORM TRAFFIC CONTROL DEVICES 2009 EDITION
    - (F). ARIZONA SUPPLEMENT TO MANUAL OF UNIFORM TRAFFIC CONTROL DEVICES 2009 EDITION
  - (G). ANY AND ALL OTHER ADOT TRAFFIC ENGINEERING REFERENCES (4). APPROVED PRODUCTS LIST — CURRENT EDITION
  - (5). EROSION AND POLLUTION CONTROL MANUAL FOR HIGHWAY DESIGN AND CONSTRUCTION -DECEMBER 2012
  - (6). EROSION/SEDIMENT AND WATER QUALITY PROTECTION BEST MANAGEMENT PRACTICES (BMP) DETAILS
- B. IN ADDITION ANY AND ALL MATERIALS UTILIZED IN CONSTRUCTION WITHIN THE RIGHTS-OF-WAY OF THE ARIZONA DEPARTMENT OF TRANSPORTATION SHALL MEET THE REQUIREMENTS OF STANDARD SPECIFICATIONS FOR ROAD AND BRIDGE CONSTRUCTION - 2021 EDITION AND/OR BE AN APPROVED MATERIAL LISTED IN THE CURRENT ADOT APPROVED PRODUCTS LIST ALSO KNOWN AS THE APL.
- C. ADOT STANDARD SPECIFICATIONS FOR ROAD AND BRIDGE CONSTRUCTION 2021 EDITION SECTION 106.08 SHALL APPLY WHEN PLANS REQUIRE THE USE OF AN ALTERNATIVE OR A SUBSTITUTION ARTICLE OF EQUIPMENT, MATERIAL OR PROCESS.
- D. ADDITIONALLY, SECTION 106.14 OF THE ADOT STANDARD SPECIFICATIONS FOR ROAD AND BRIDGE CONSTRUCTION - 2021 EDITION SHALL APPLY WHEN A PRODUCT THAT IS NOT LISTED IN THE CURRENT APL PROPOSED FOR USE.
- E. ALL MATERIALS UTILIZED FOR A PERMITTED ACTIVITY SHALL BE SAMPLED AND TESTED IN ACCORDANCE WITH THE REQUIREMENTS OF THE FOLLOWING UNLESS OTHERWISE APPROVED IN WRITING BY THE ADOT
  - SECTION 106.04 OF THE STANDARD SPECIFICATIONS FOR ROAD AND BRIDGE CONSTRUCTION 2008
  - EDITION
  - THE ADOT MATERIALS TESTING MANUAL
  - THE ADOT MATERIALS POLICY AND PROCEDURES DIRECTIVES MANUAL APPLICABLE FEDERAL, AASHTO OR ASTM SPECIFICATION OR TEST DESIGNATIONS.

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- APPLICABLE SPECIFICATION OR TEST DESIGNATIONS OF OTHER RECOGNIZED ORGANIZATIONS.
- F. THE TERM "ENGINEER" AS STATED IN SECTION 106.08 AND SECTION 106.14 OF THE ADOT STANDARD SPECIFICATIONS FOR ROAD AND BRIDGE CONSTRUCTION - 2008 EDITION SHALL REFER TO THE ADOT DISTRICT DEVELOPMENT ENGINEER, THE DISTRICT ASSISTANT DISTRICT ENGINEER OR THE DISTRICT ENGINEER.
- G. CONTRACTOR TO BE RESPONSIBLE FOR OBTAINING PERMIT FOR CONSTRUCTION IN ADOT R.O.W.

### MARICOPA ASSOCIATION $\mathsf{SM}$ OF GOVERNMENTS

STREET **MANHOLE MINIMUM** STATION NORTHING STANDARD STRUCT STRUCTURAL PAVEMENT SW SIDEWALK POINT OF CURVE

TOP BACK OF CURB PORTLAND CEMENT CONCRETE TEL TELEPHONE POINT OF INTERSECTION **TEMPORARY** POINT OF BEGINNING TOP TOP OF PIPE POINT OF ENDING TYP TYPICAL

RDWY

SHT

3" ASPHALI CONCRETE

(1/2" MIX)

SURFACE COURSE

RIGHT

**RADIUS** 

SHEET

ROADWAY

RIGHT-OF-WAY

SURVEY MARKER

SANITARY SEWER

all at least two full working d ial 8-1-1 or 1-800-STAKE-IT (782-53-In Maricopa County: (602) 263-110


NOTICE OF EXTENDED PAYMENT PROVISION


(PER ARS 32-1129.01) THIS CONTRACT ALLOWS THE OWNER TO MAKE PAYMENT WITHIN 15 DAYS AFTER CERTIFICATION AND APPROVALS OF BILLINGS AND ESTIMATES FOR PROGRESS PAYMENTS, WITHIN 15 DAYS AFTER CERTIFICATION AND APPROVALS OF BILLINGS AND ESTIMATES FOR RELEASE OF RETENTION AND WITHIN 15 DAYS AFTER CERTIFICATION AND APPROVAL OF BILLINGS AND ESTIMATES FOR FINAL PAYMENT.


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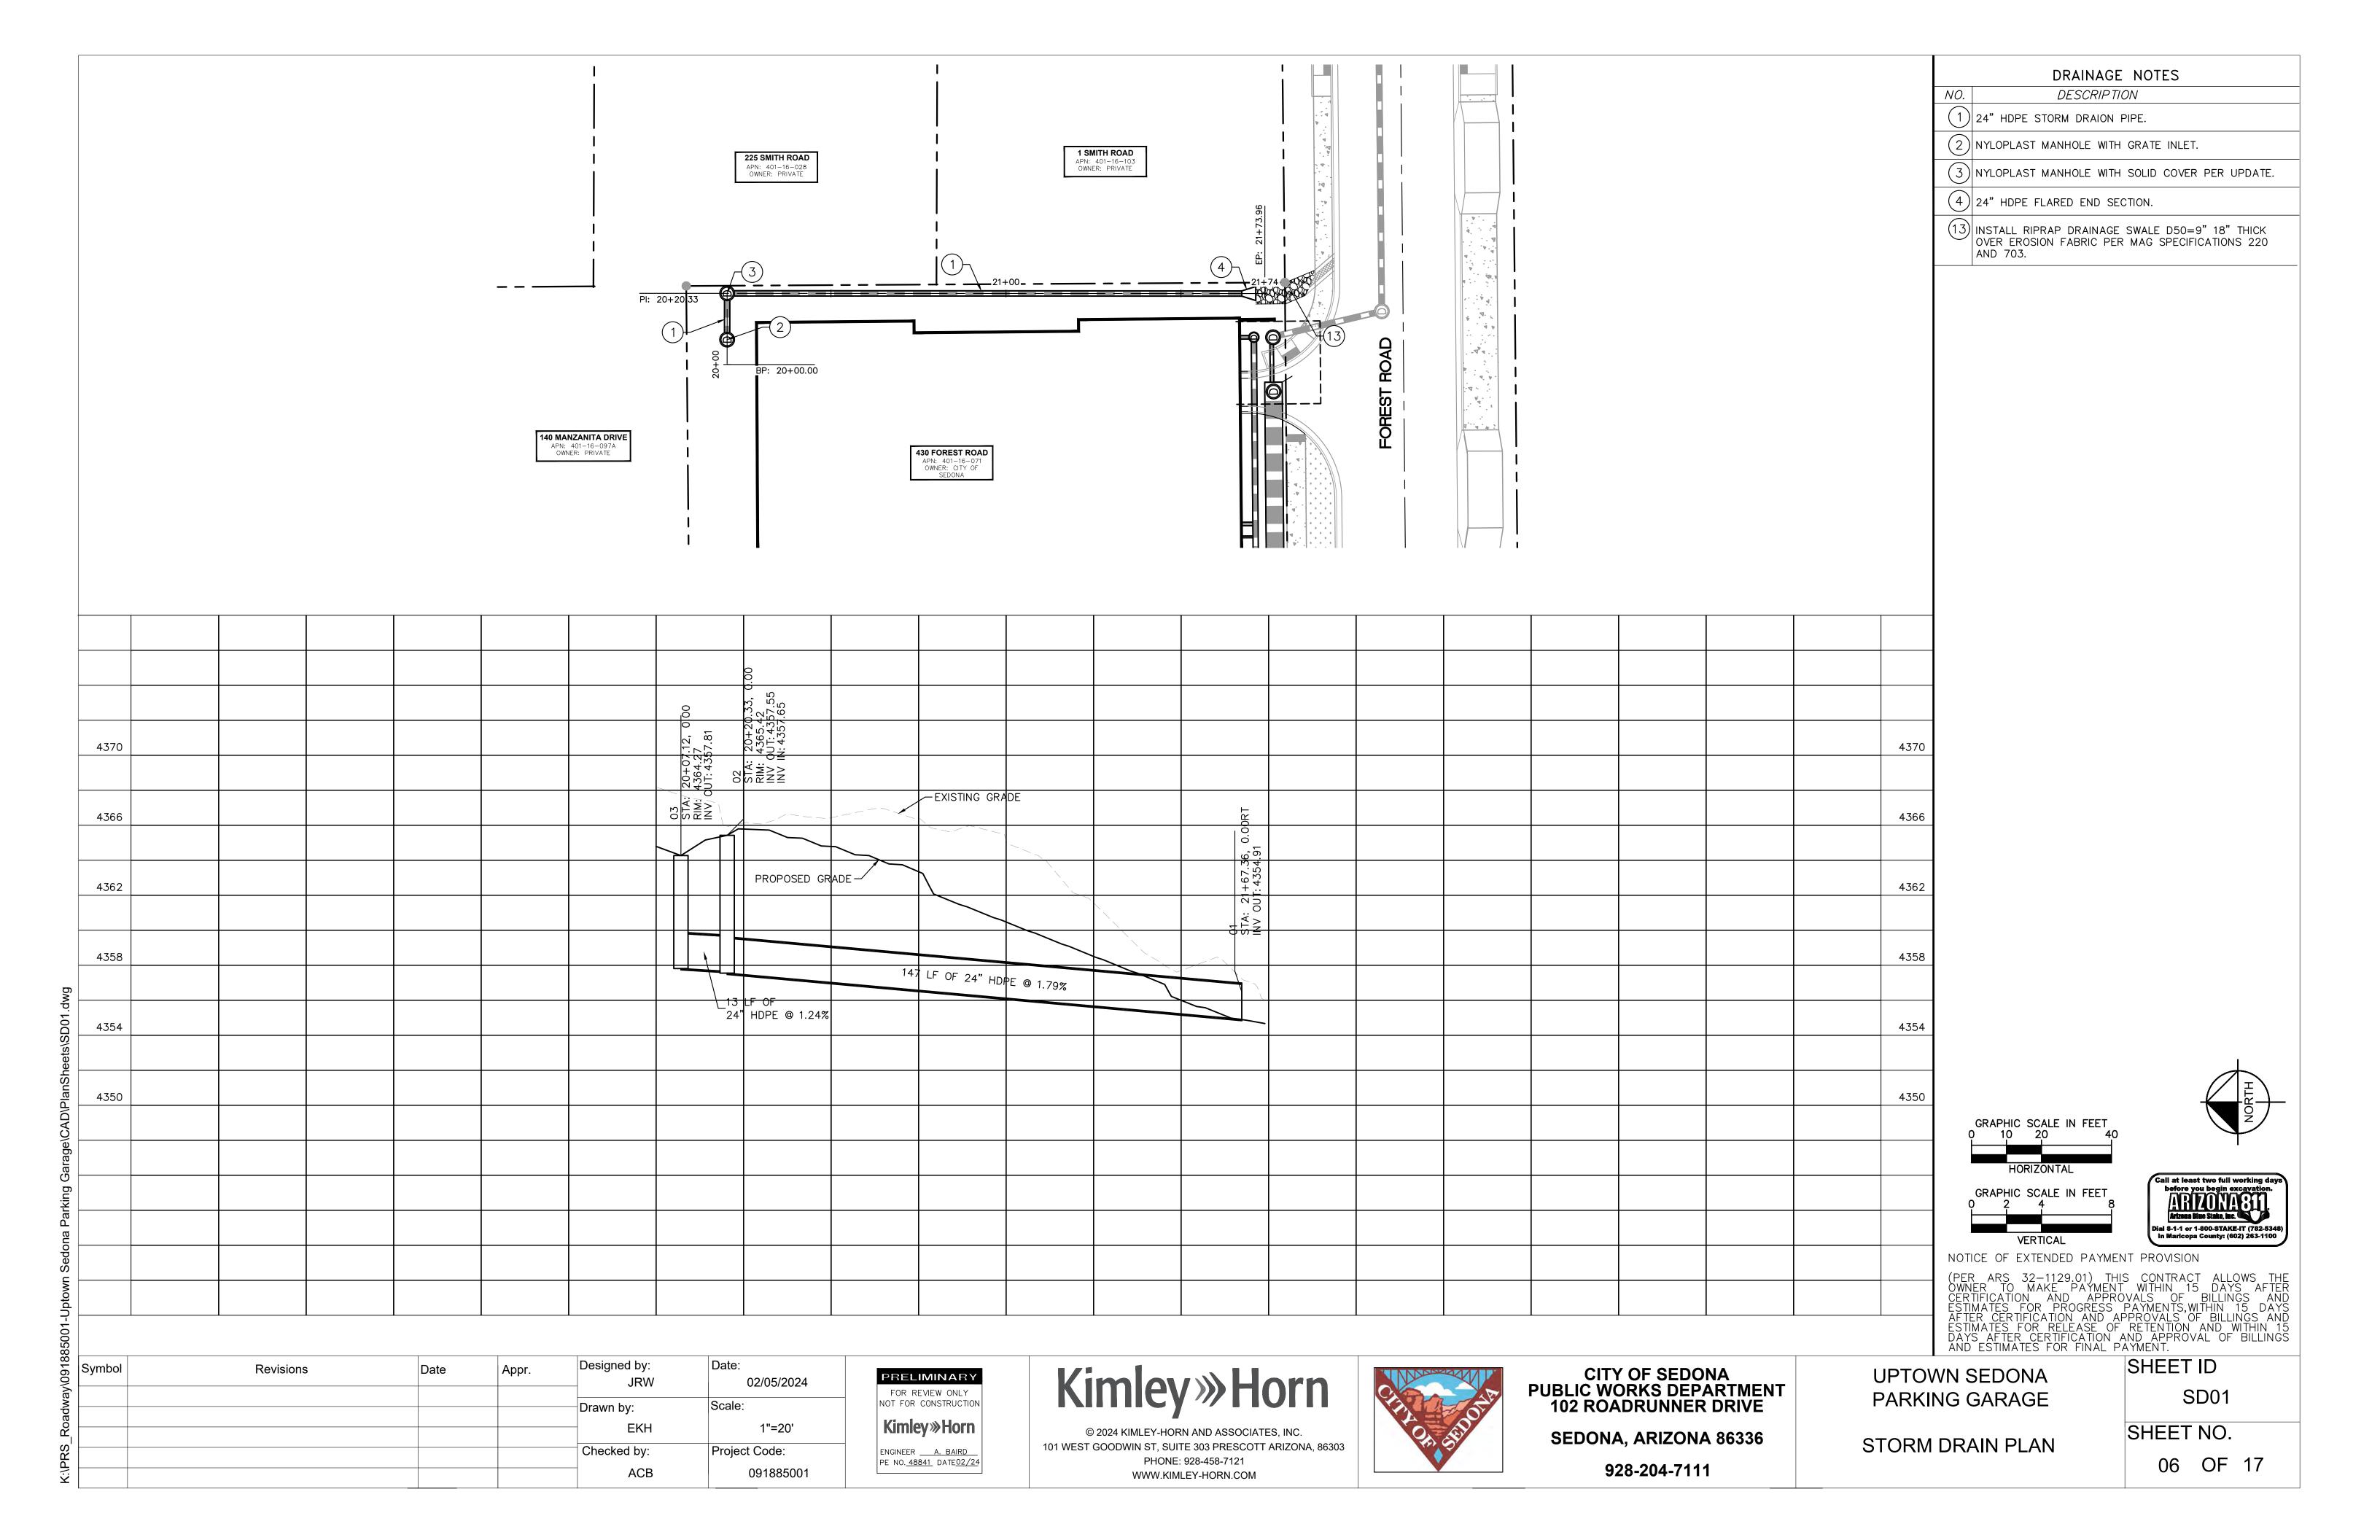
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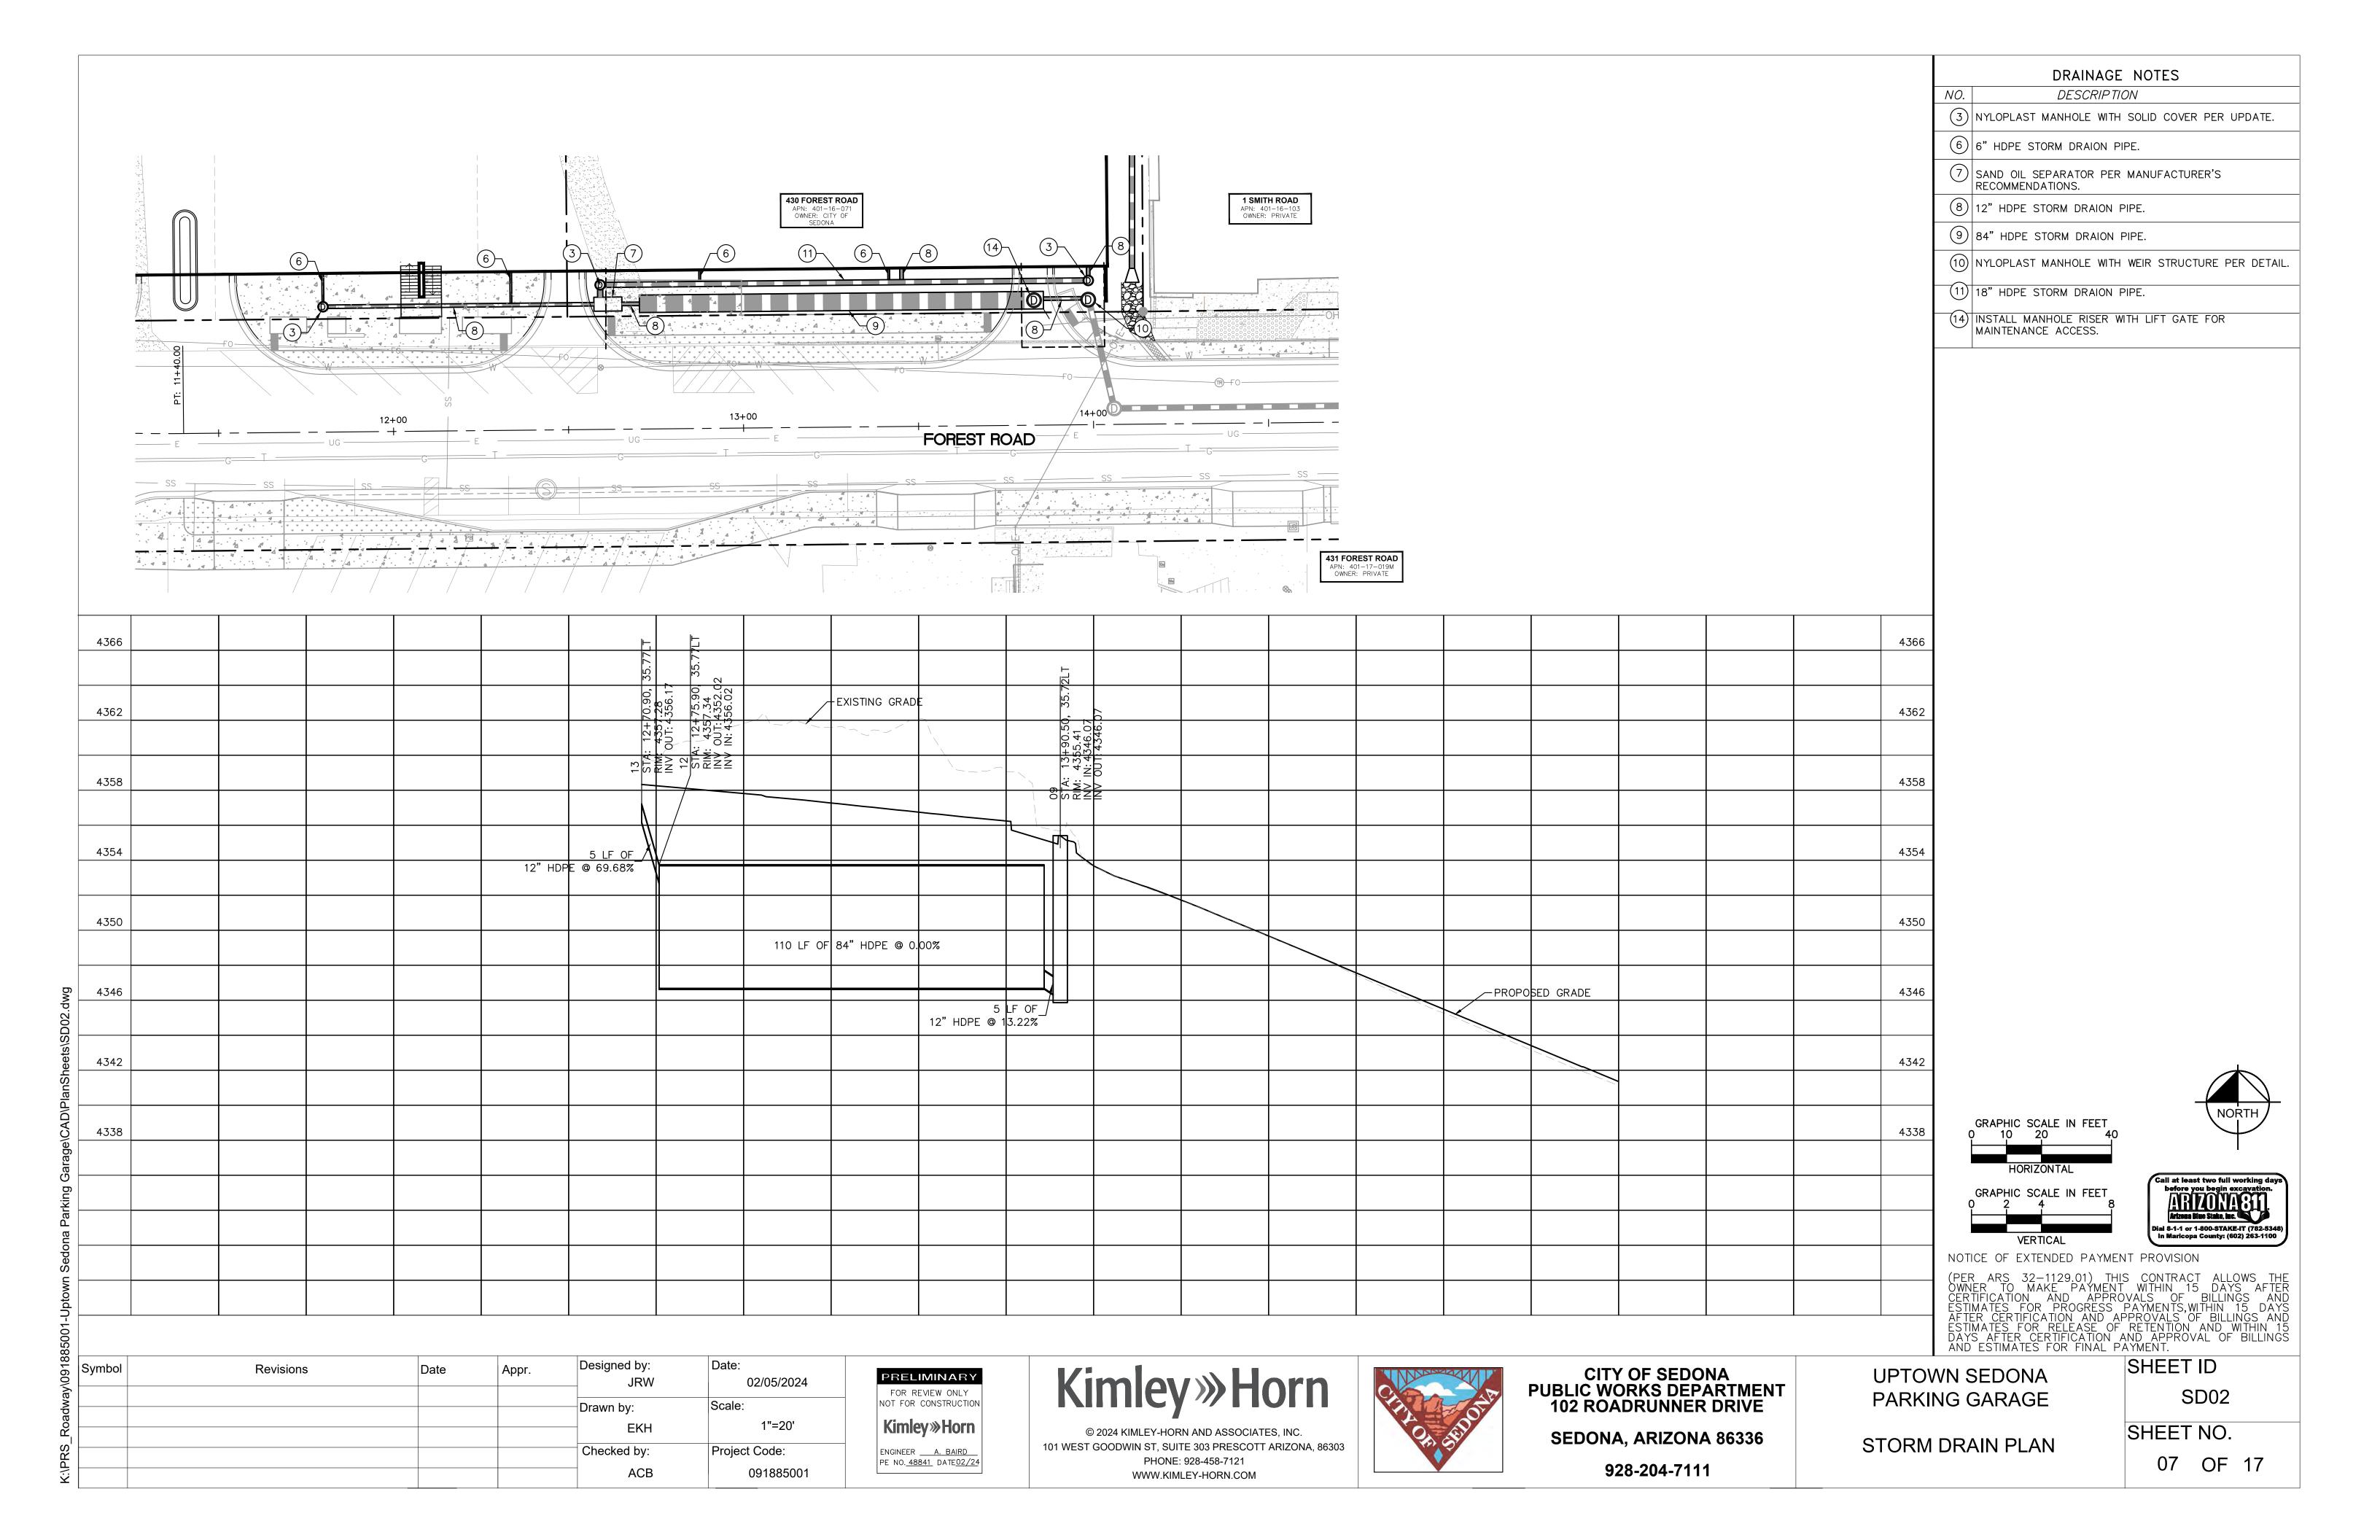
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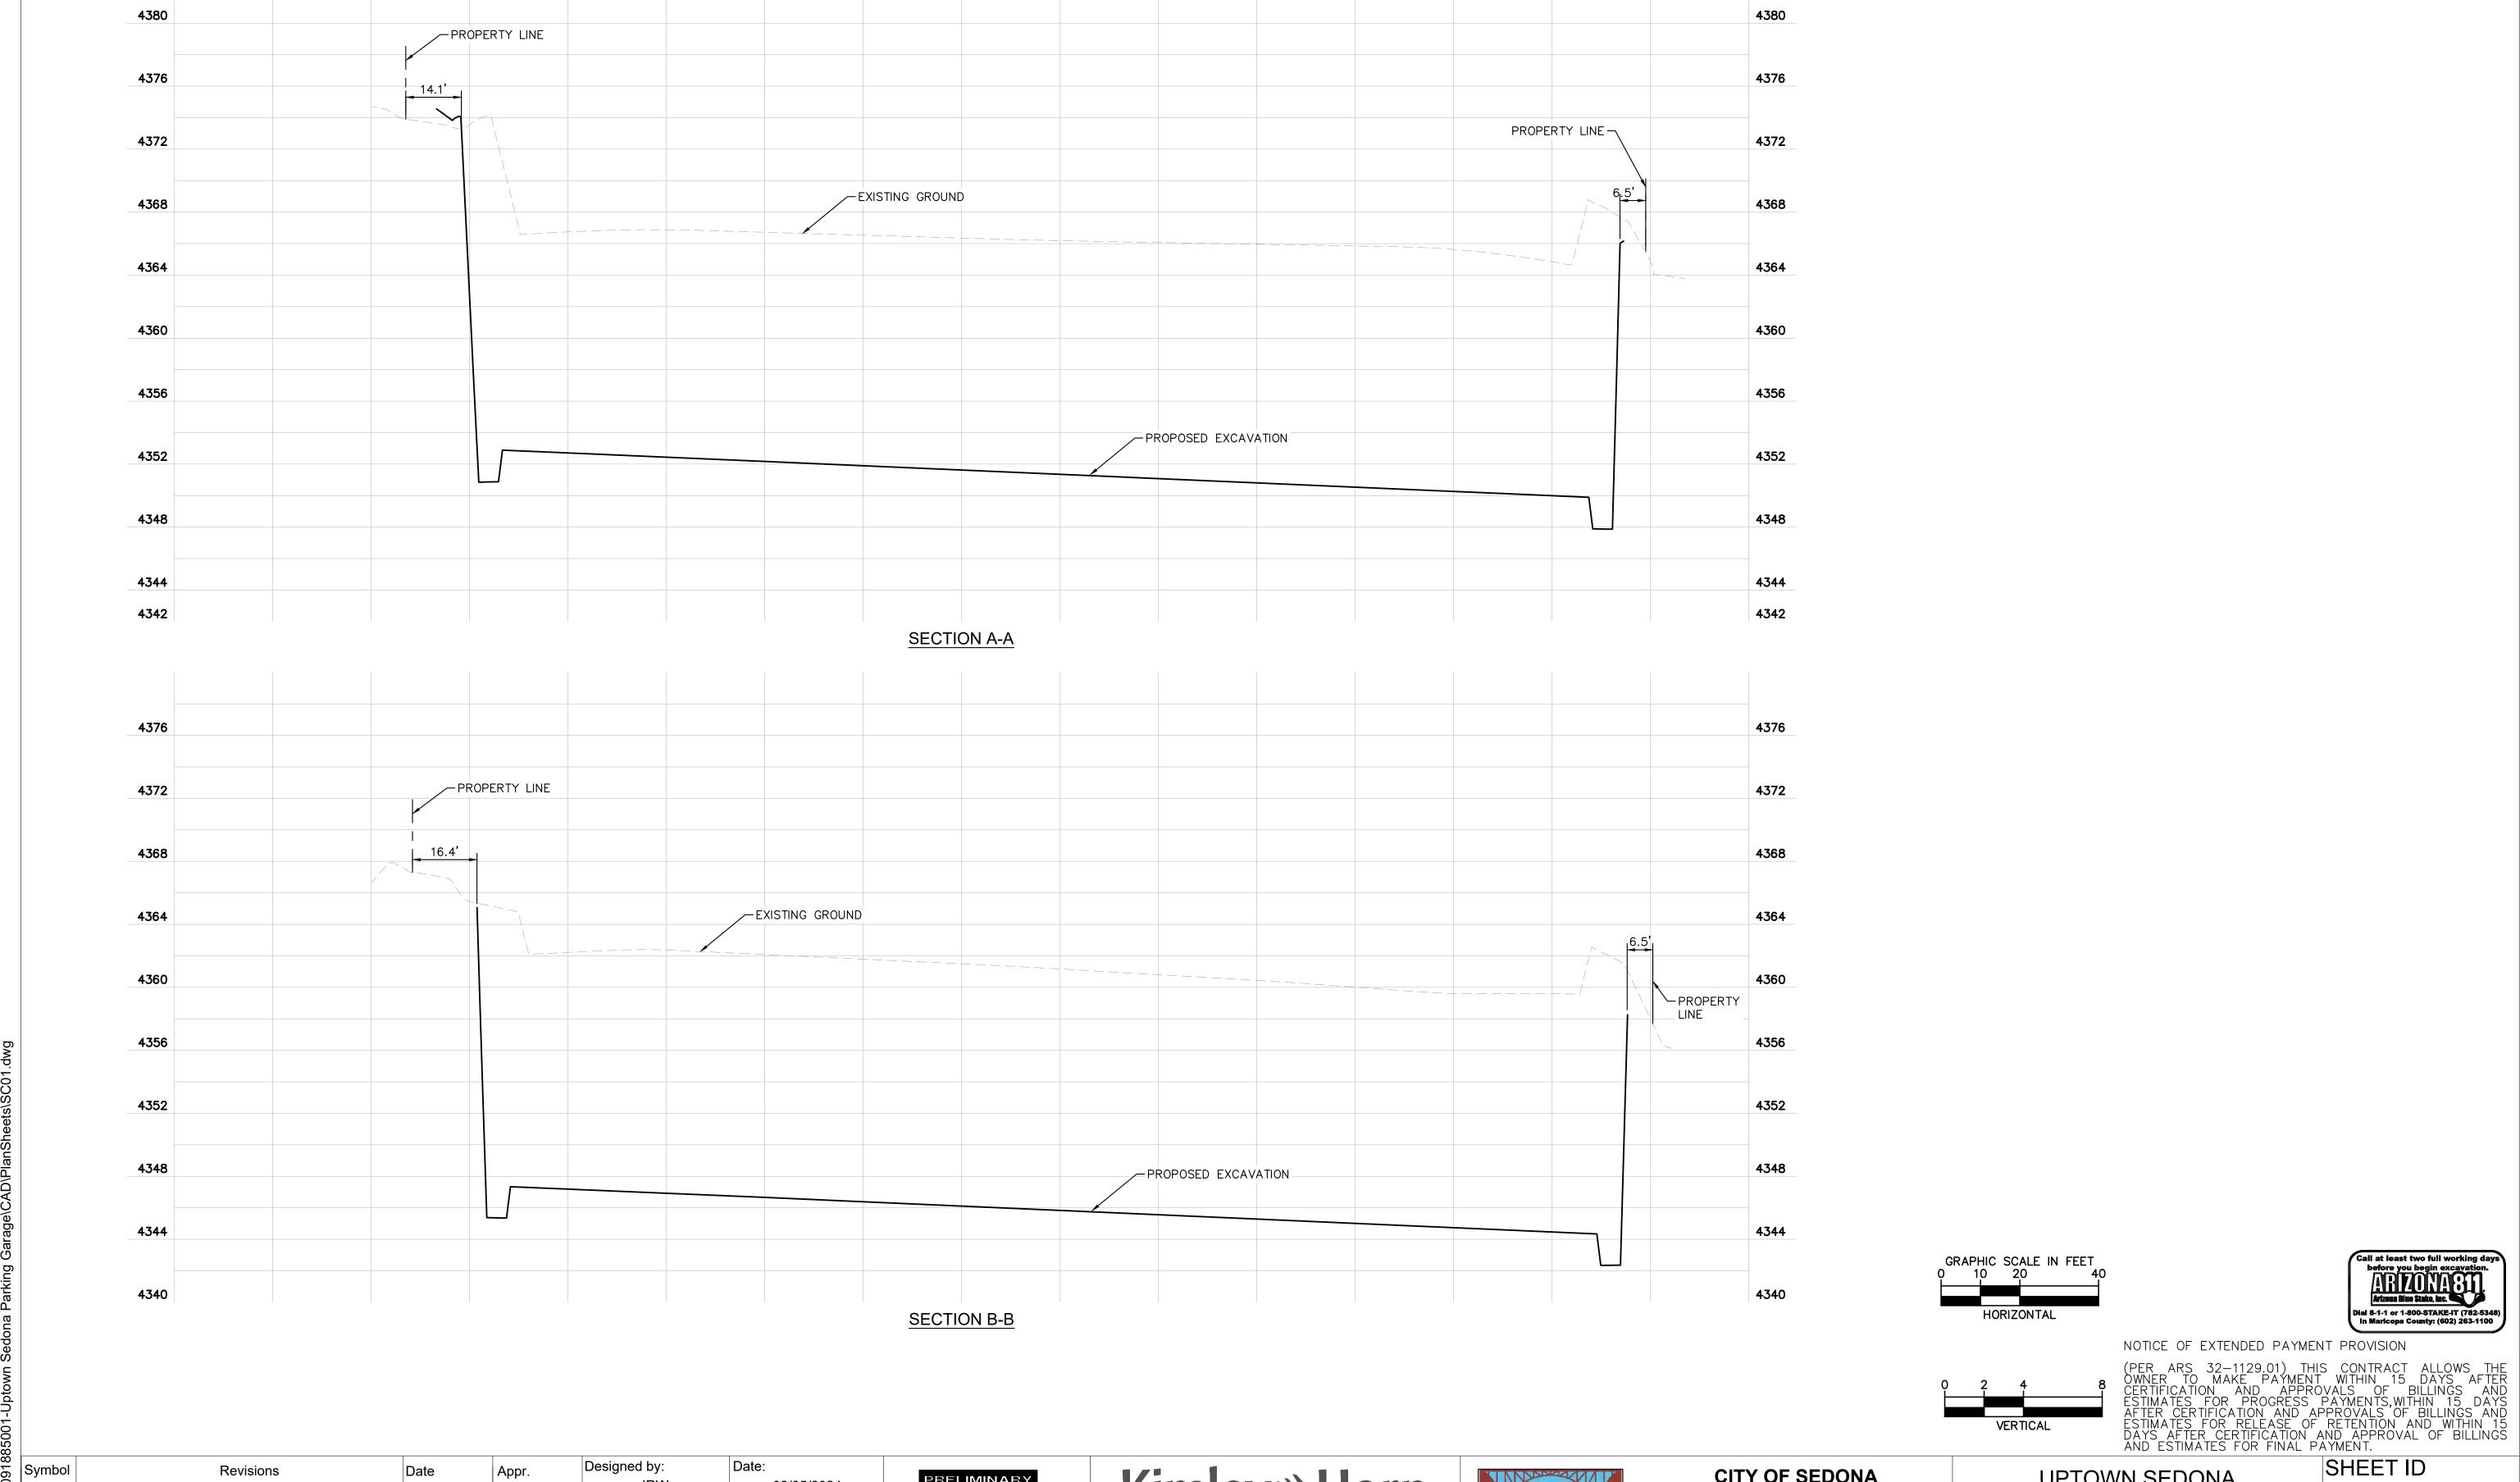






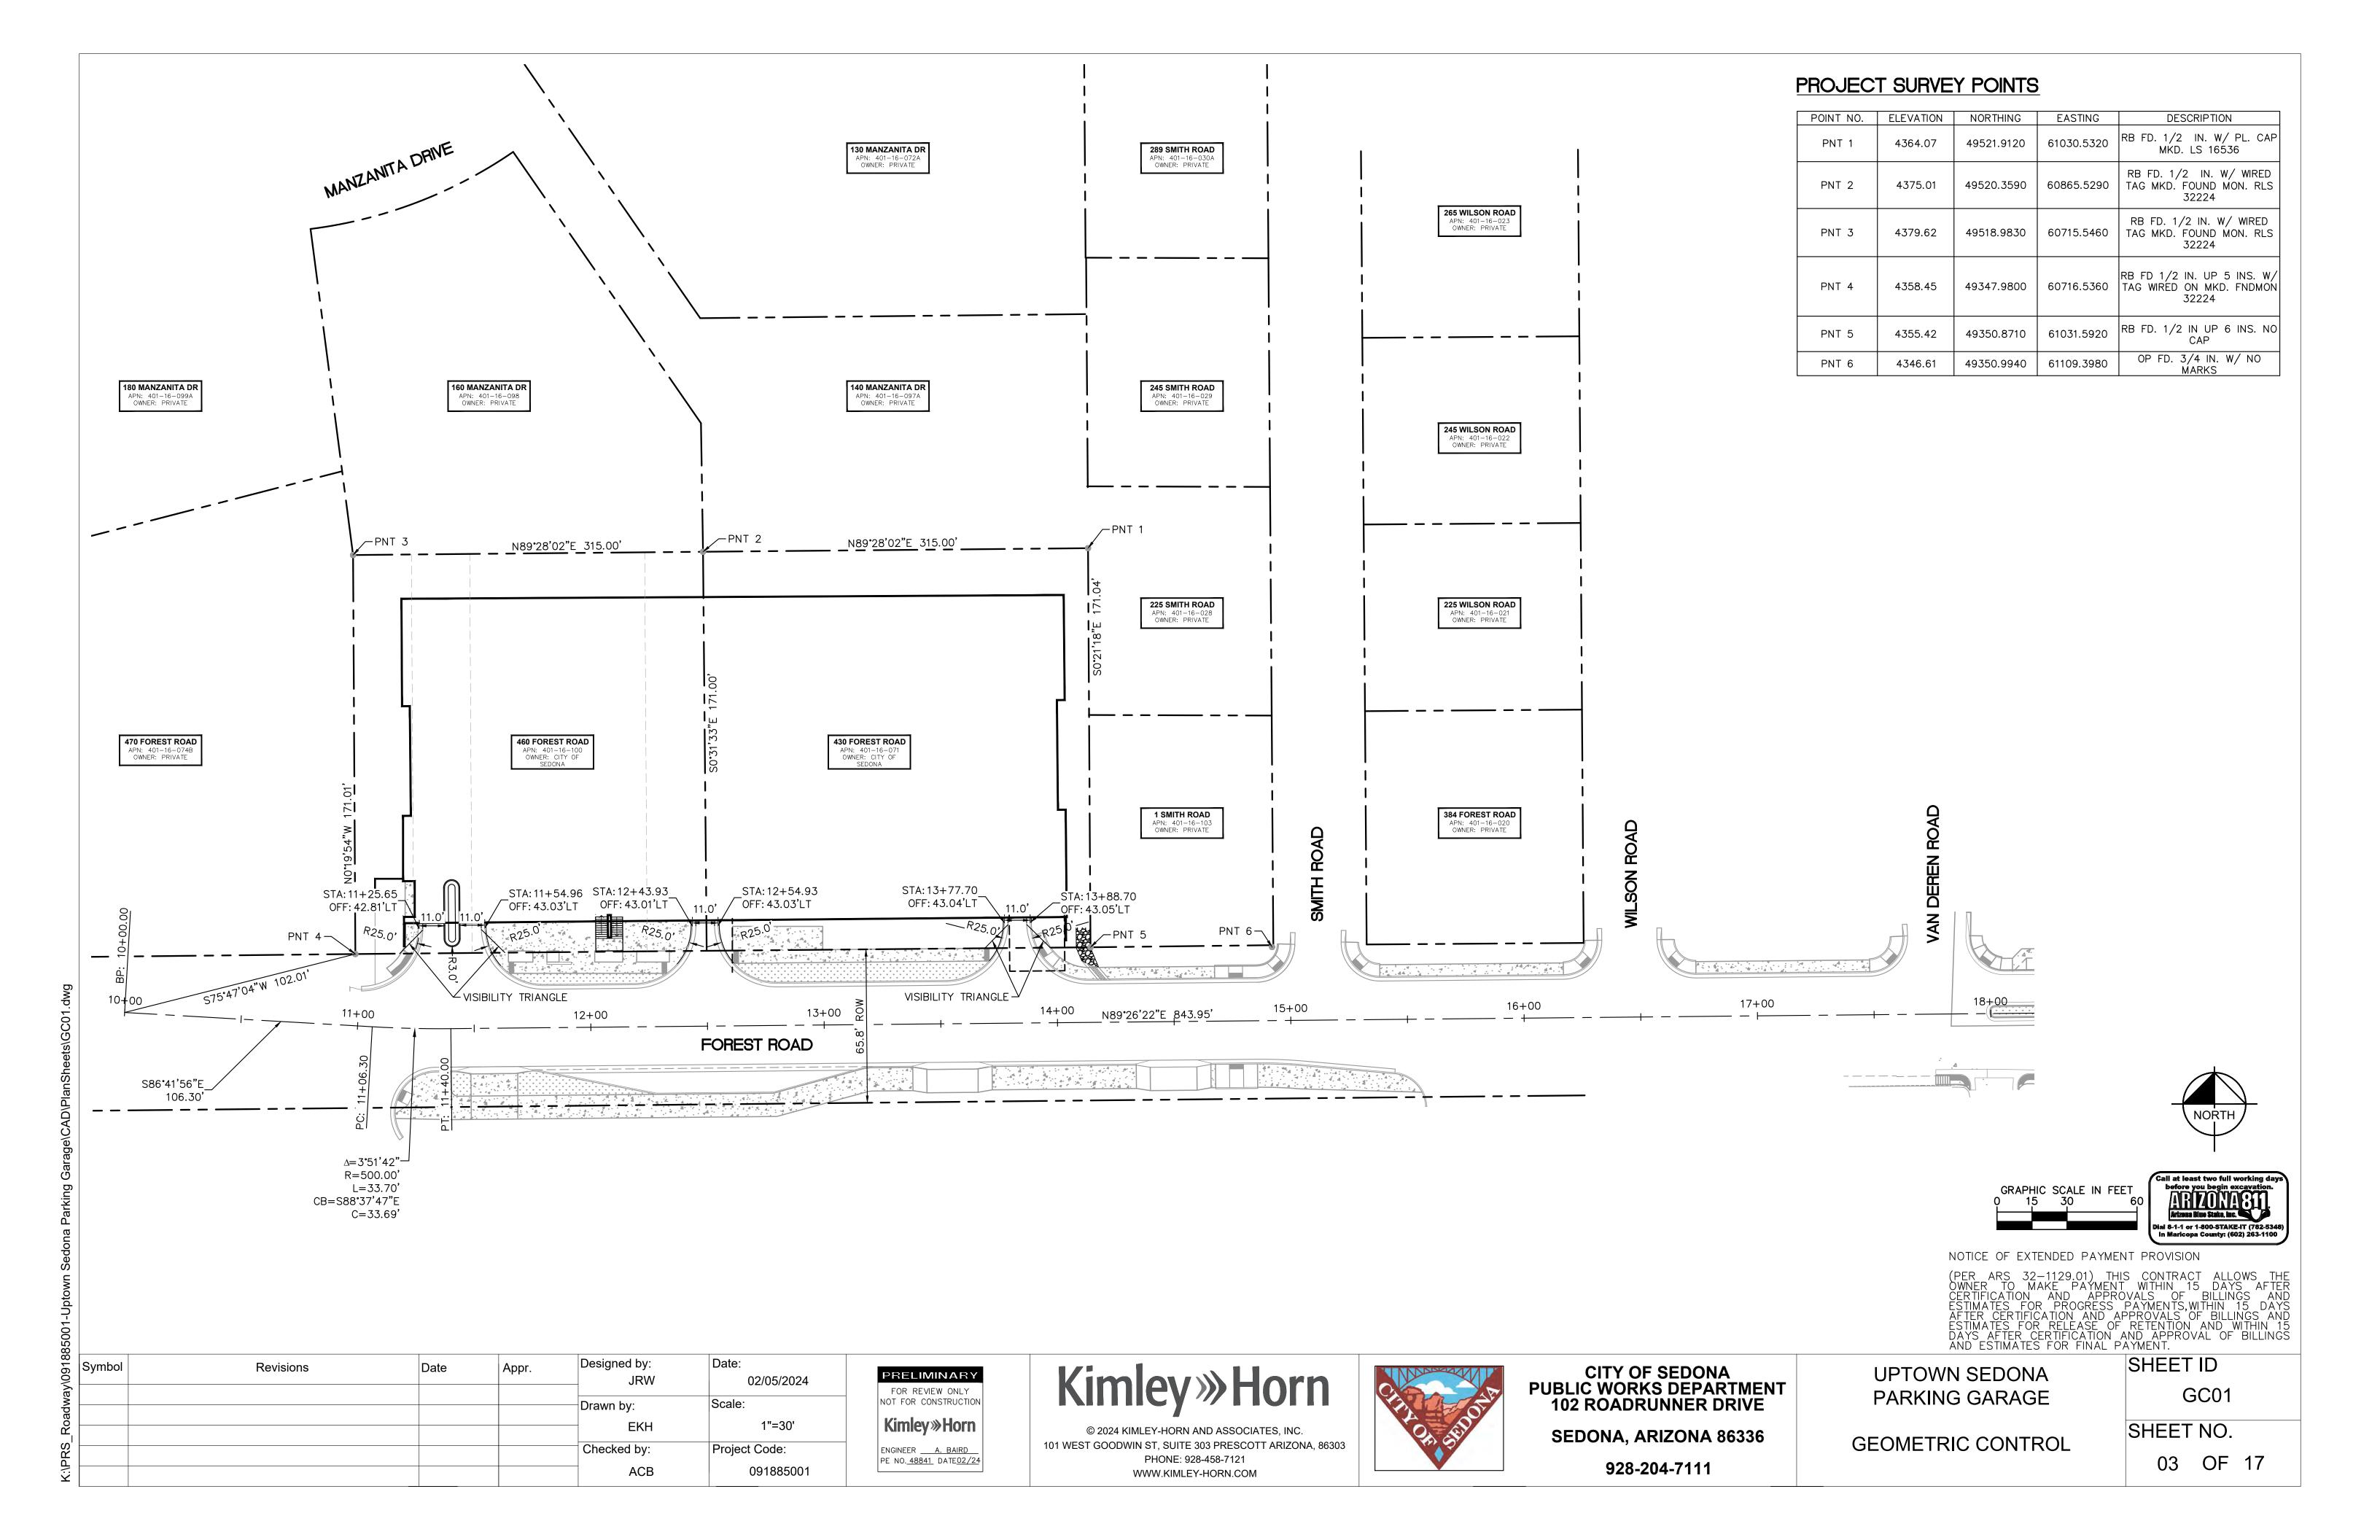

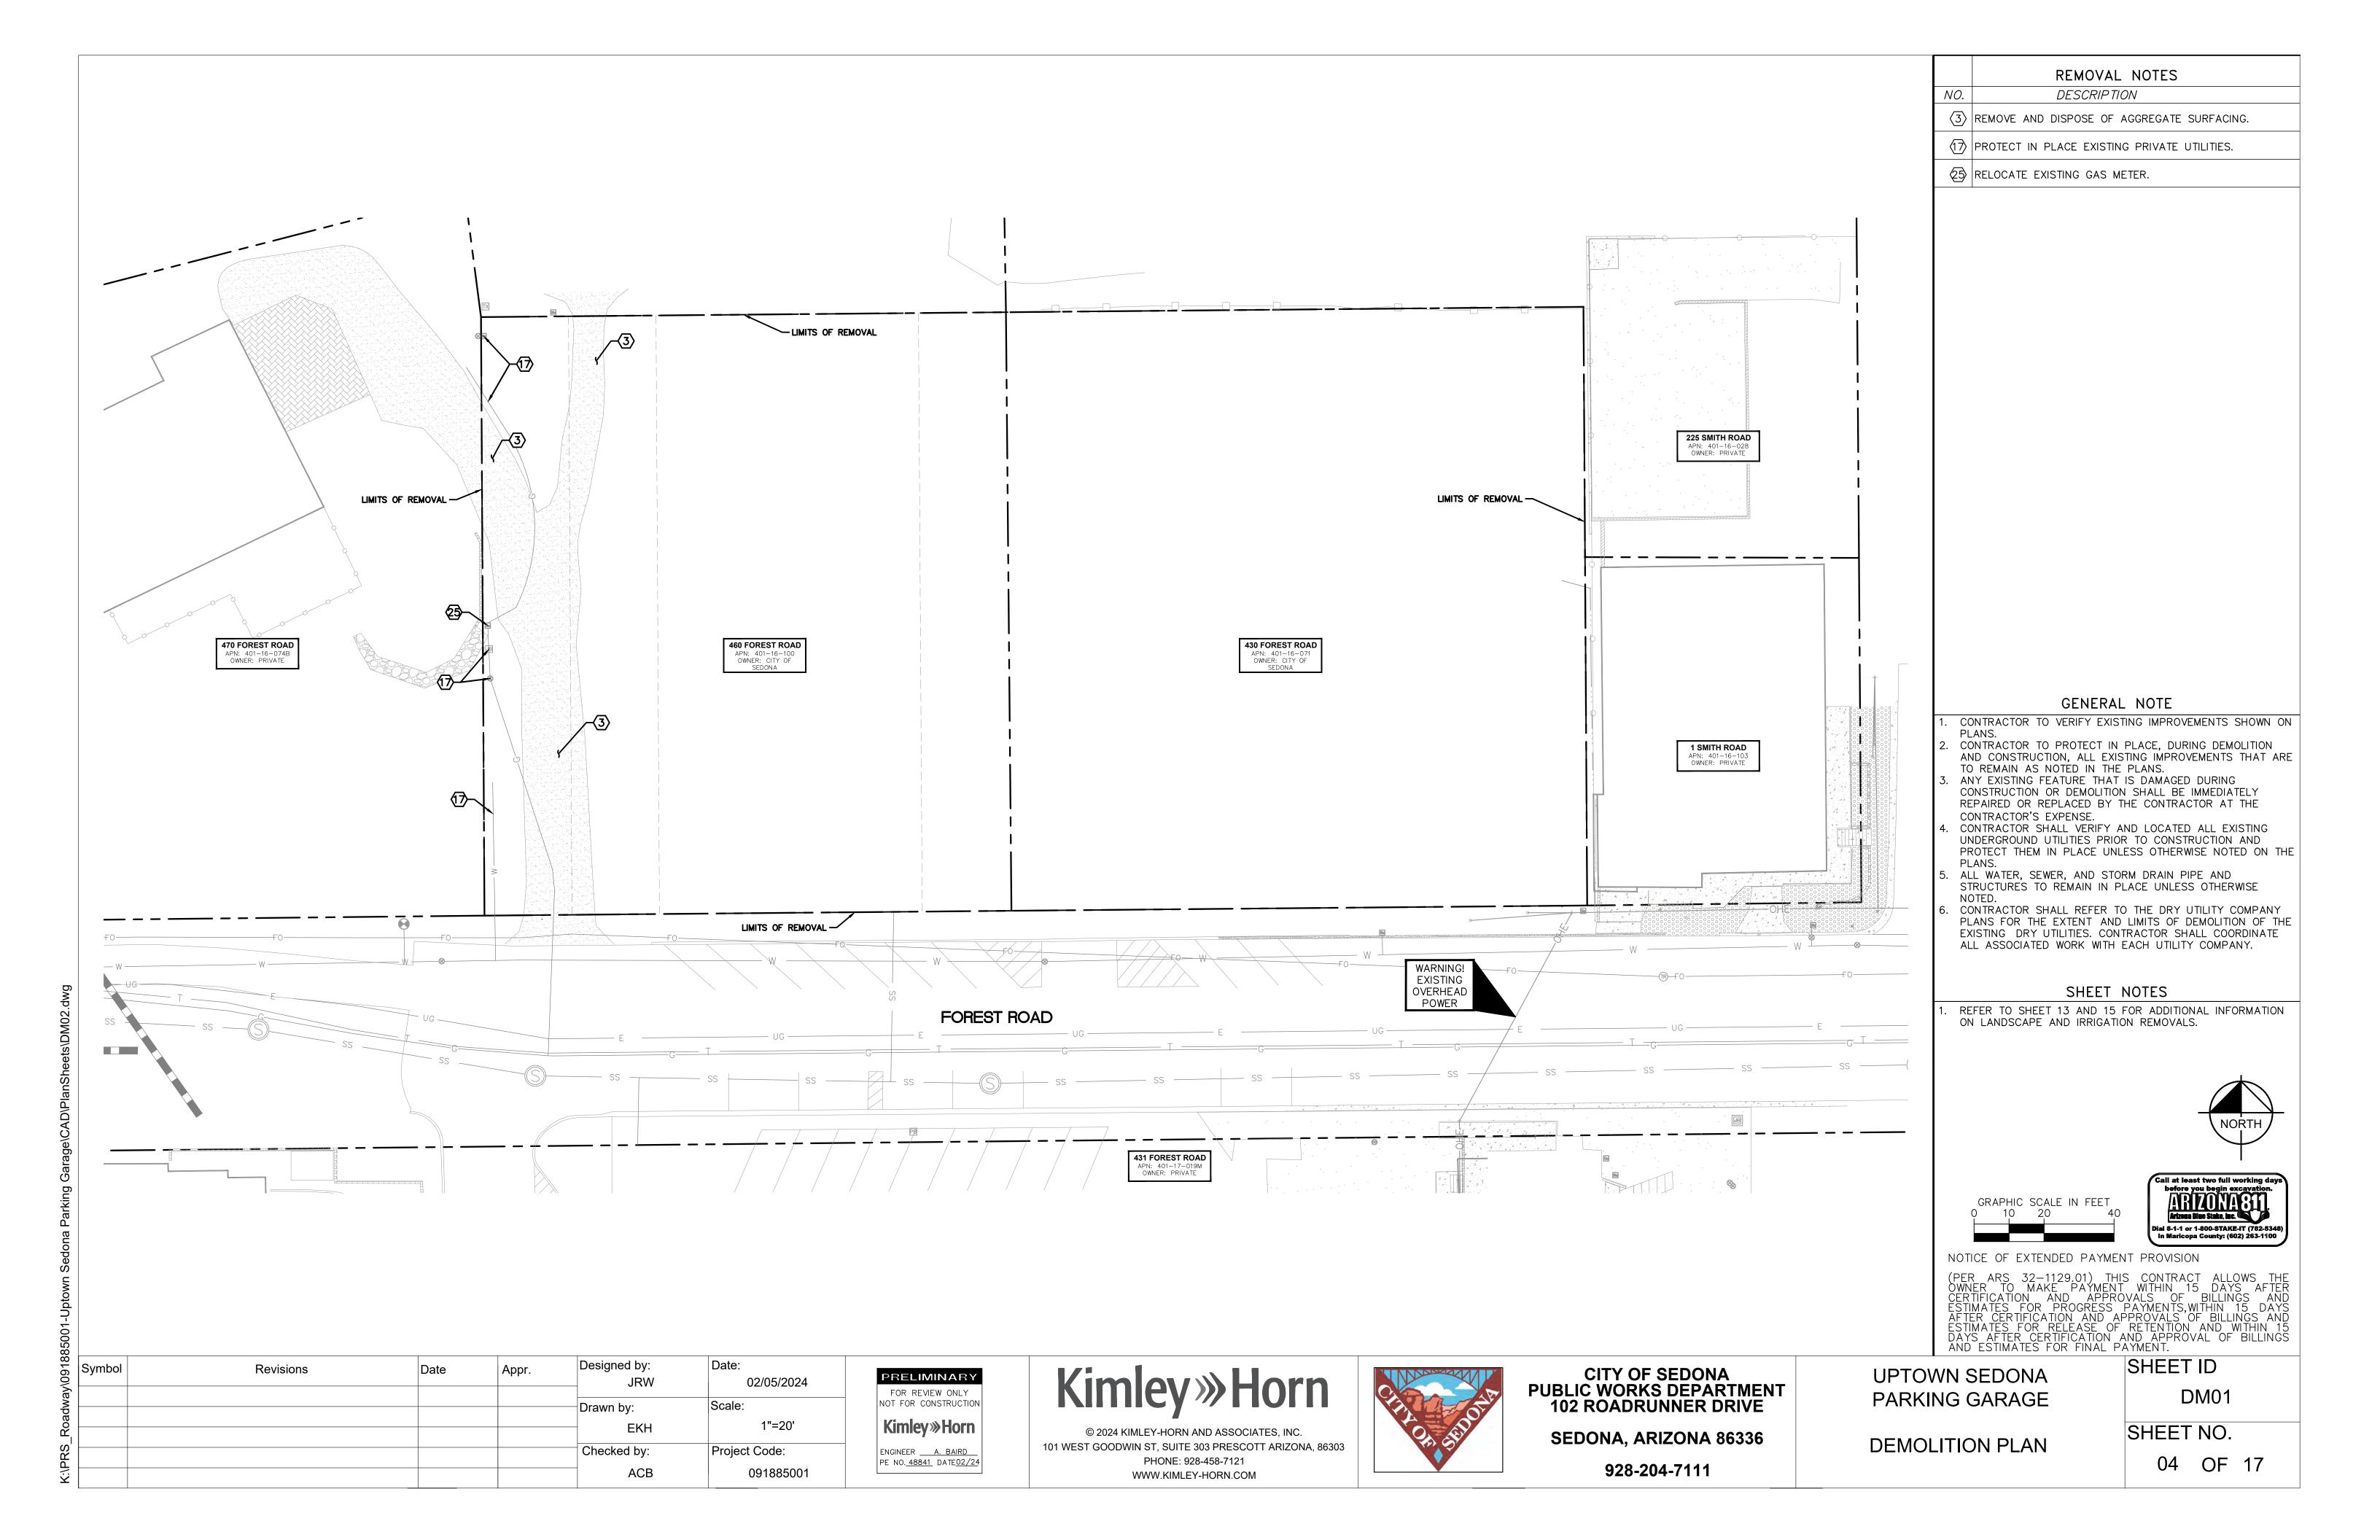

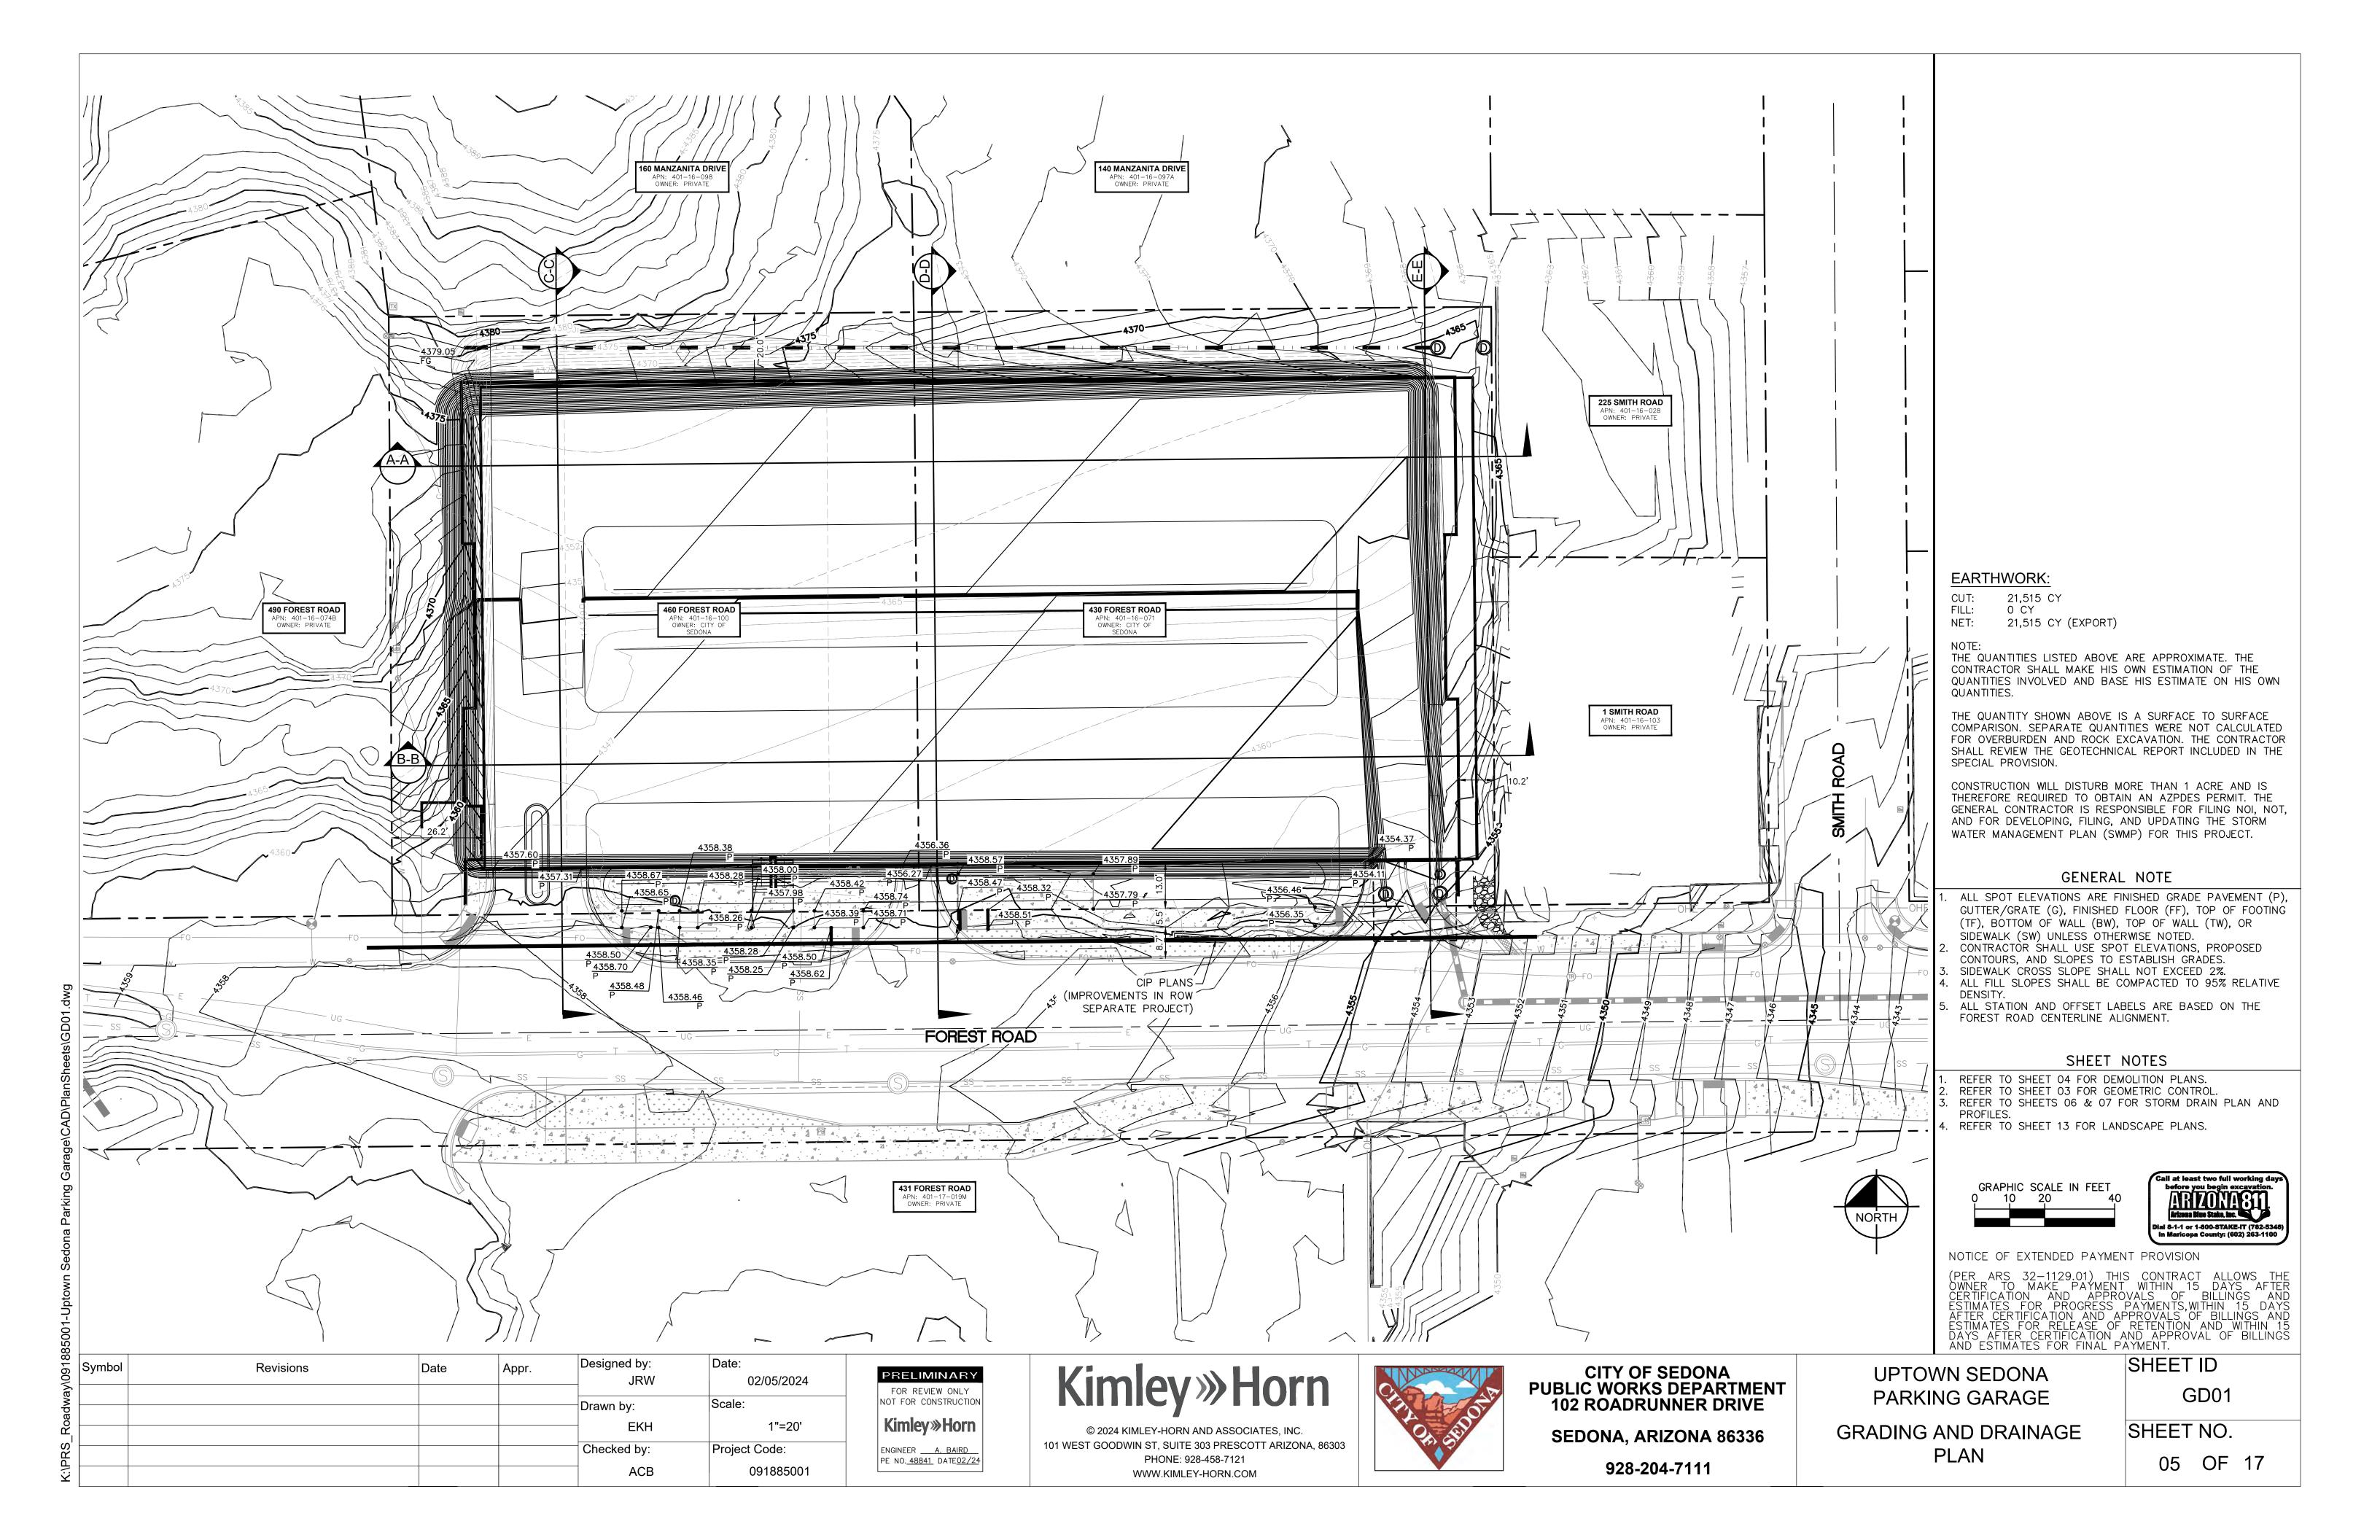

 Symbol
 Revisions
 Date
 Appr.
 Designed by: JRW
 Date: 02/05/2024

 Drawn by:
 Scale:
 EKH
 1"=20'

 Checked by:
 Project Code: 091885001


FOR REVIEW ONLY
NOT FOR CONSTRUCTION

Kimley Horn

ENGINEER A. BAIRD
PE NO. 48841 DATE 02/24

Kimley» Horn
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101 WEST GOODWIN ST, SUITE 303 PRESCOTT ARIZONA, 86303
PHONE: 928-458-7121

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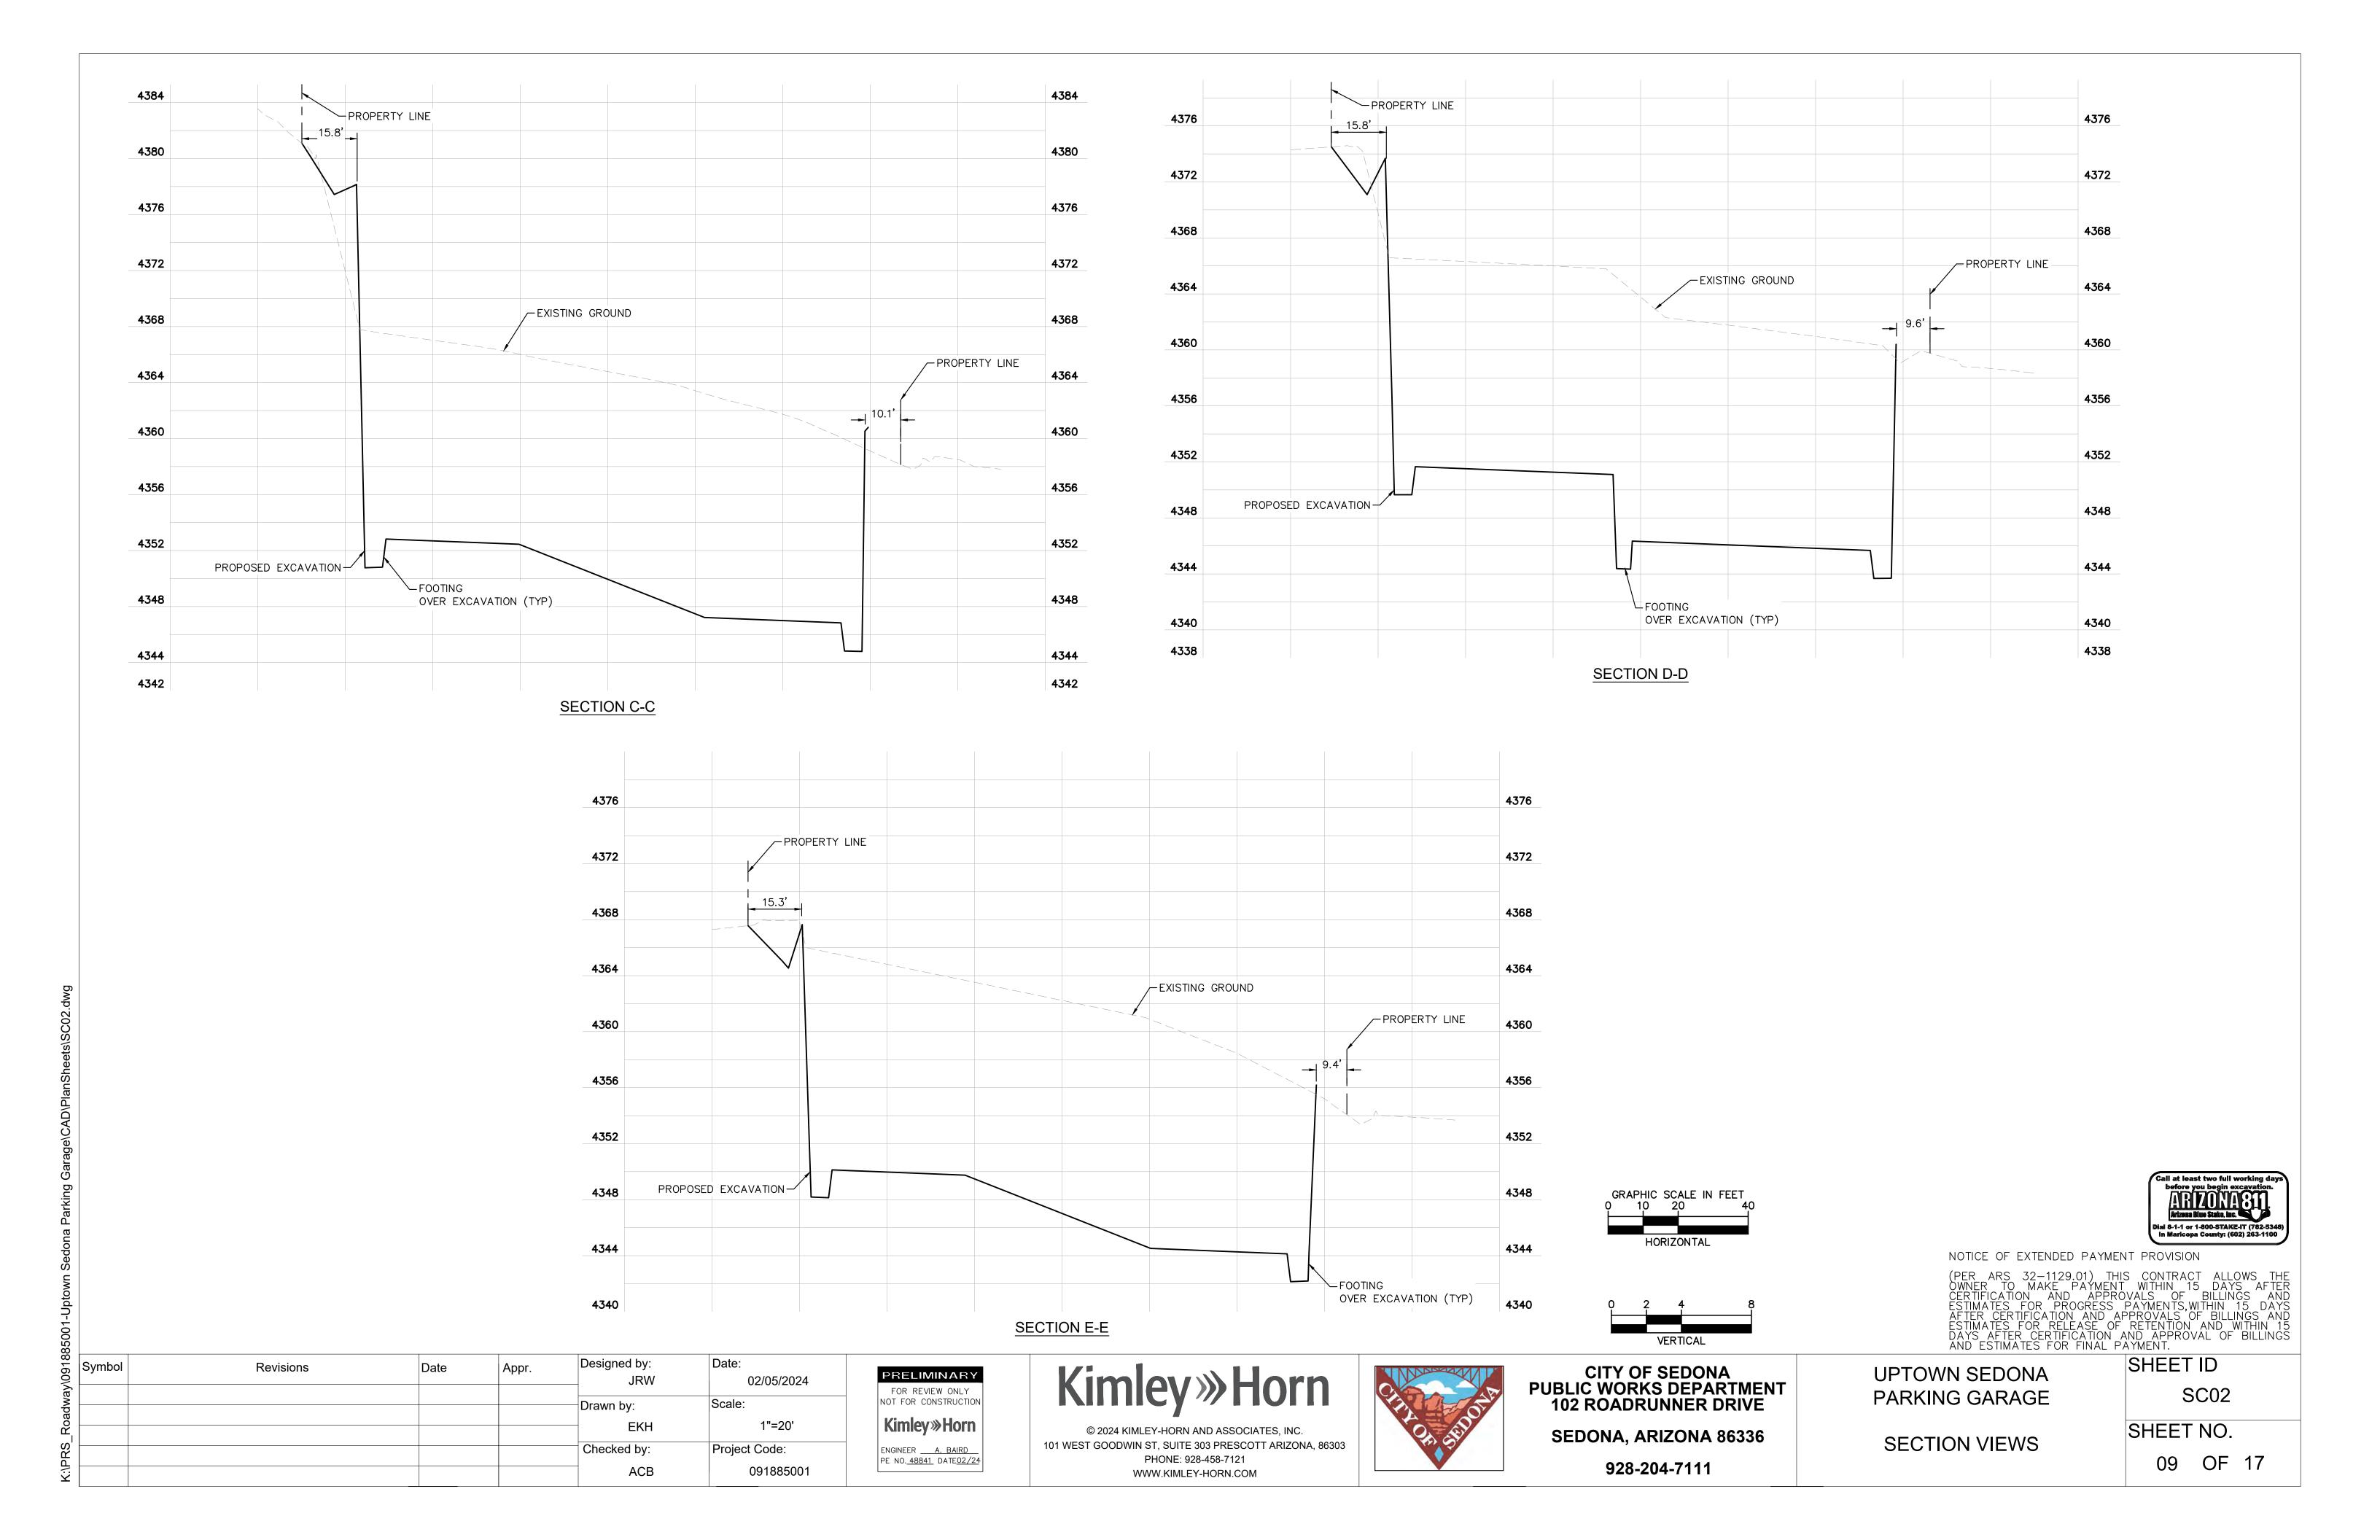


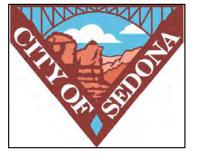
CITY OF SEDONA
PUBLIC WORKS DEPARTMENT
102 ROADRUNNER DRIVE
SEDONA, ARIZONA 86336
928-204-7111


UPTOWN SEDONA PARKING GARAGE

SECTION VIEWS

SHEET ID
SC01
SHEET NO.



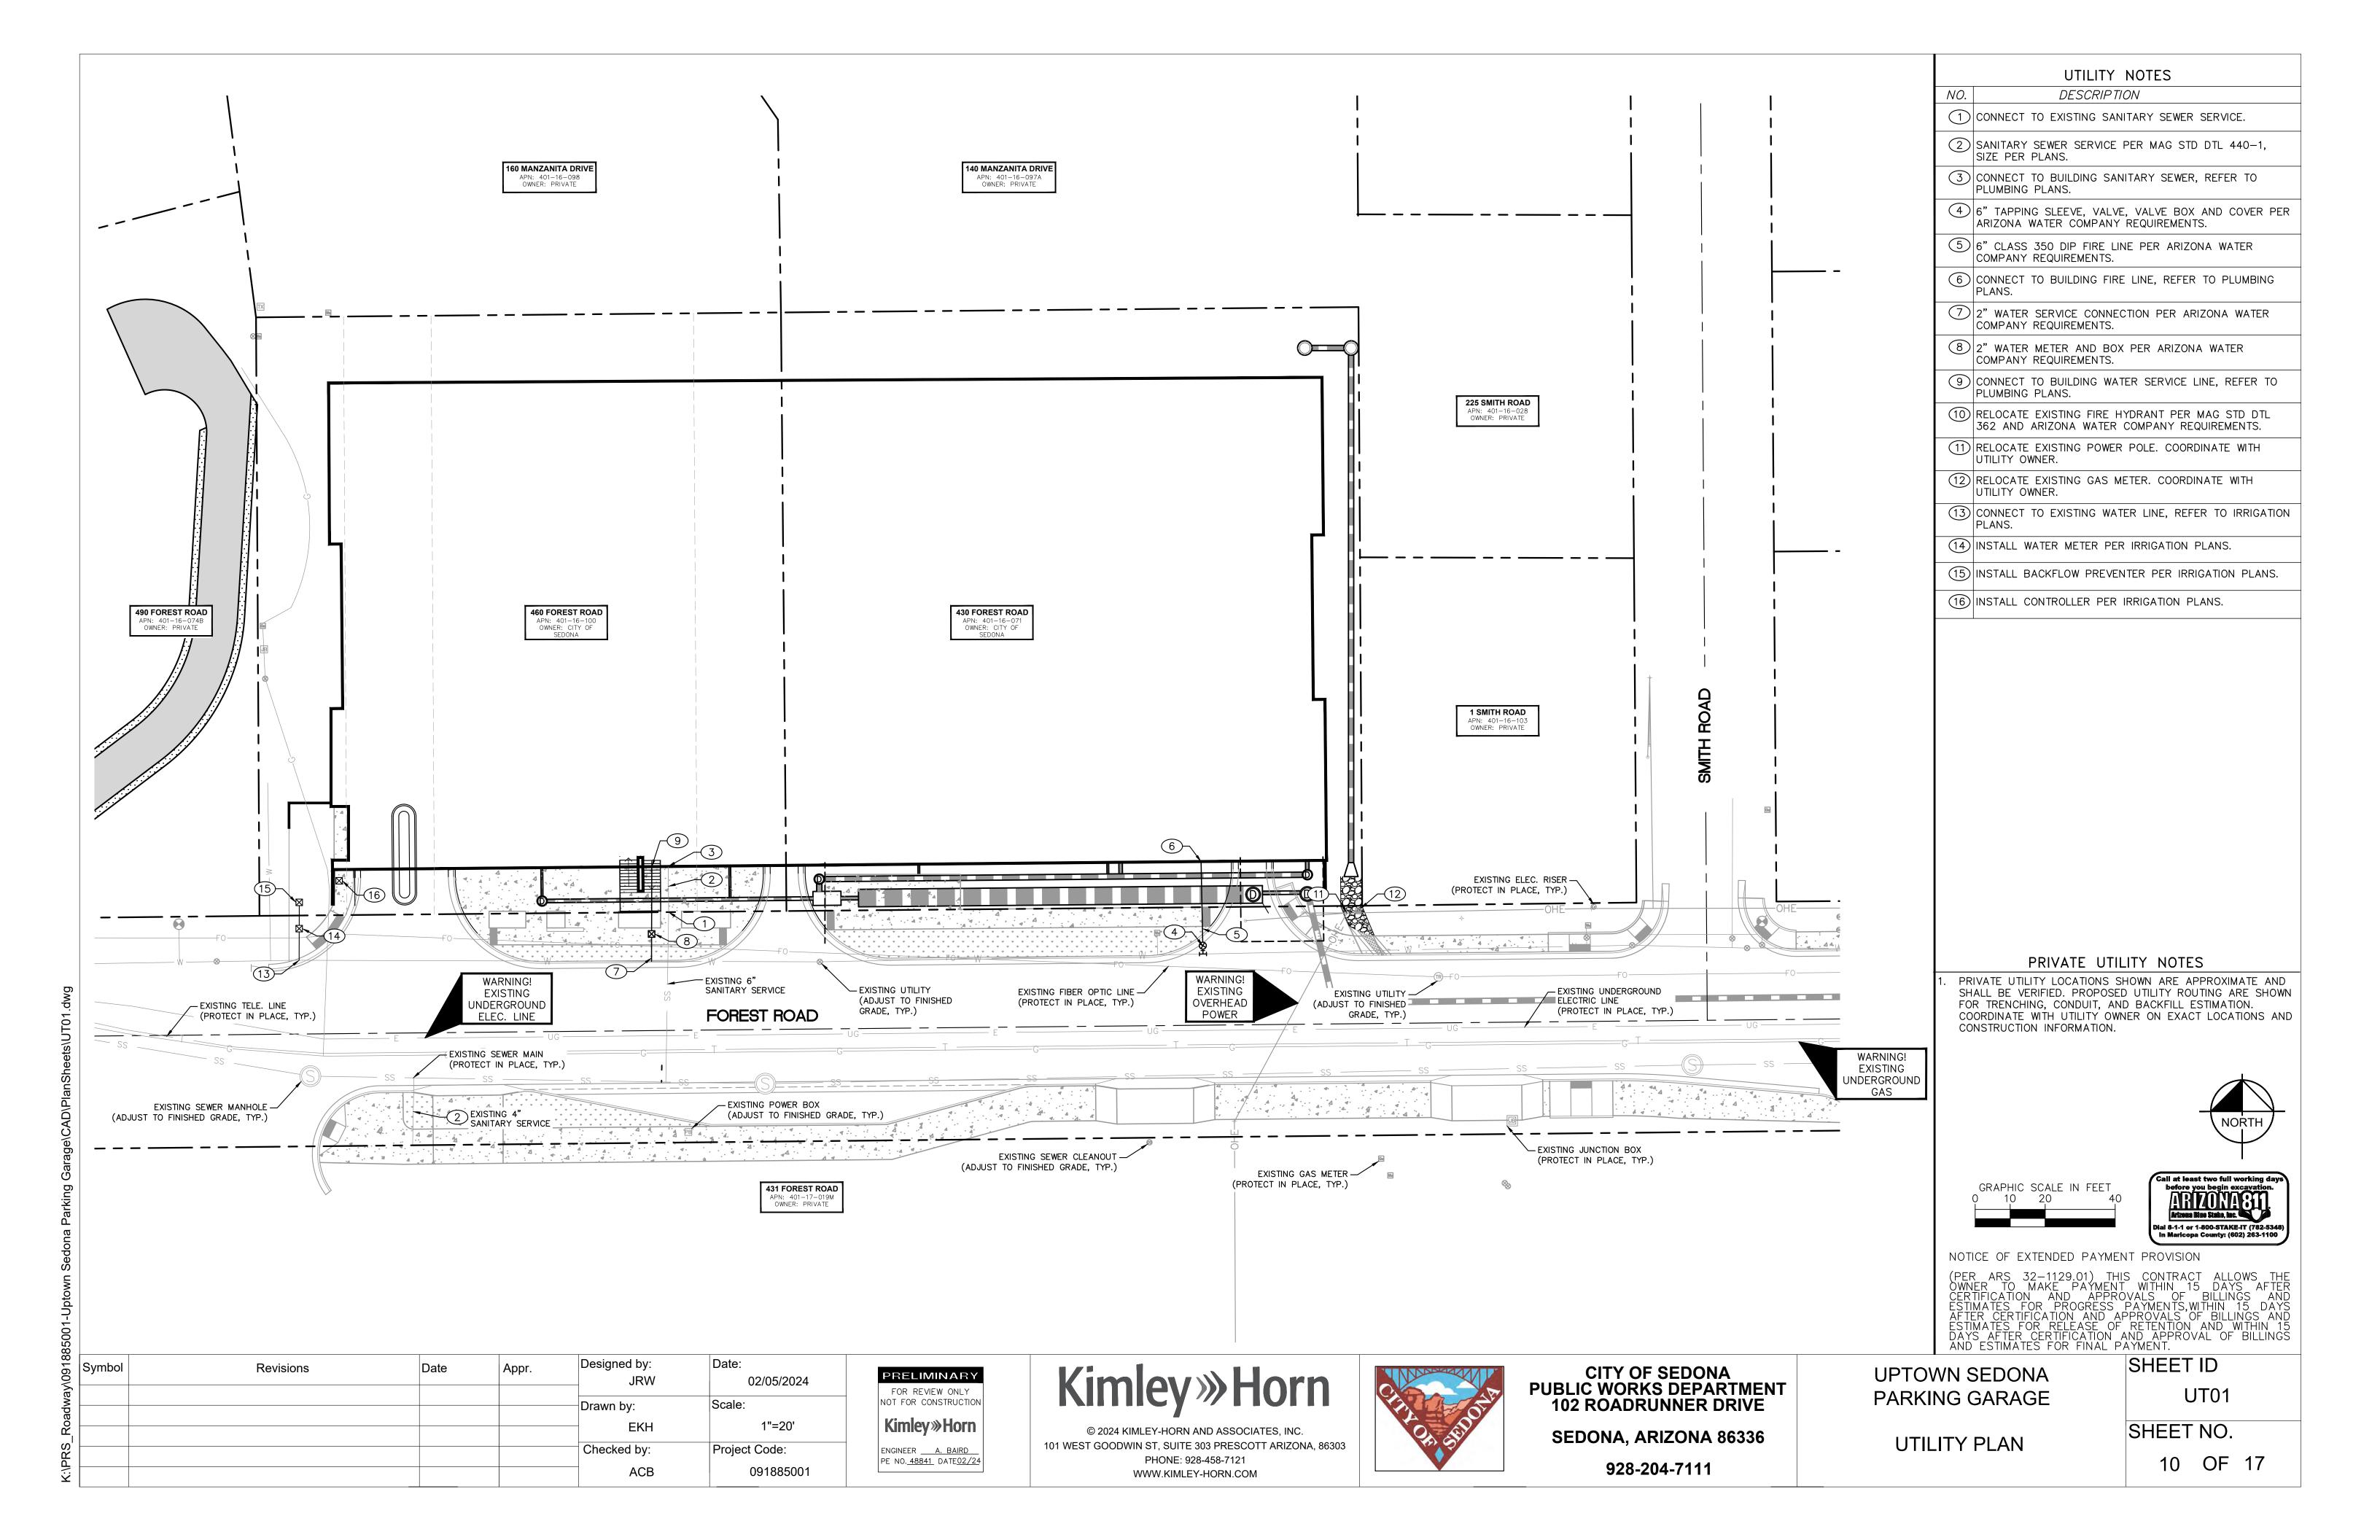

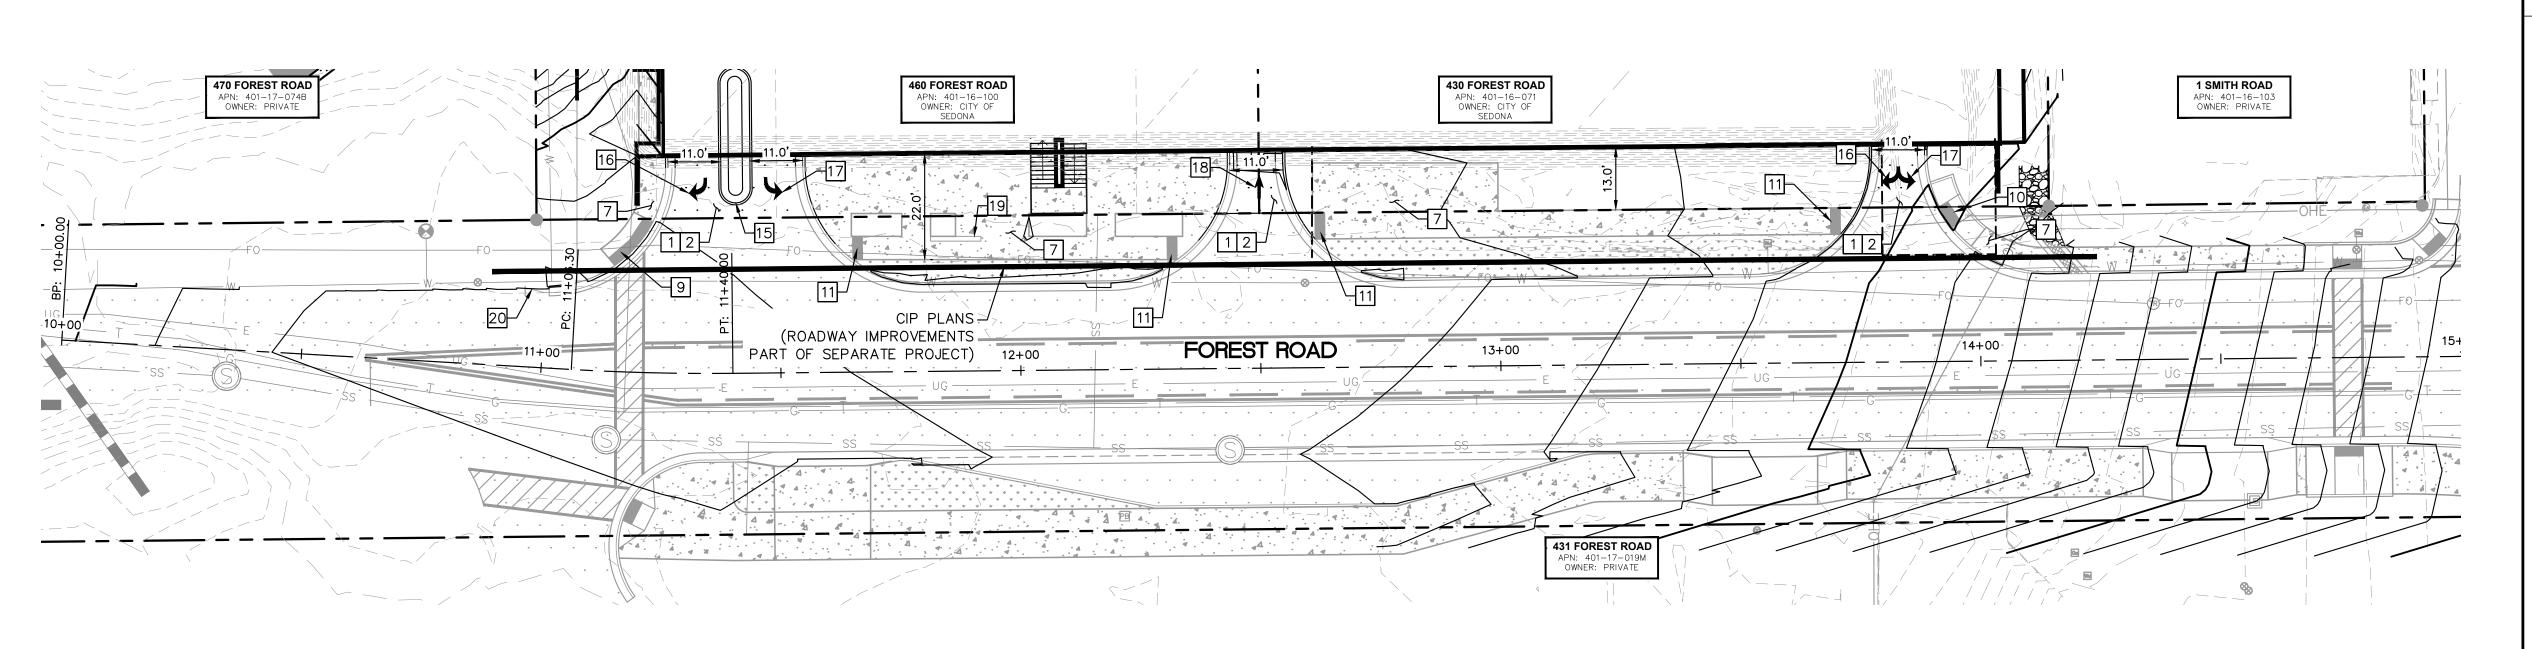

	ROADWAY NOTES						
NO. DESCRIPTION							
1	AC PAVEMENT PER STRUCTURAL SECTION NO. 1 ON SHEET 02.						
2	AGGREGATE SURFACE COURSE, 4" THICK.						
7	CONCRETE SIDEWALK PER MAG STD DTL 230, WIDTH SHOWN ON PLANS.						
9	CONCRETE RADIAL CURB RAMP PER MAG STD DTL 236-3.						
10	CONCRETE RADIAL PARALLEL CURB RAMP PER MAG STD DTL 236-5.						
11	CONCRETE PERPENDICULAR CURB RAMP PER MAG STD DTL 238-1.						
15	CONCRETE ROLL CURB AND GUTTER PER MAD STD DTL 220-1, TYPE 'D'.						
16	RIGHT ARROW PER ADOT STD DTL M-10 AND M-11.						
17	LEFT ARROW PER ADOT STD DTL M-10 AND M-11.						
18	PAINTED ARROW PER ADOT STD DTL M-10 AND M-11.						
19	CONCRETE BENCH PER ARCHITECTURAL PLANS.						
20	CURB TRANSITION PER MAG STD DTL 221.						



GRAPHIC SCALE IN FEET 0 10 20 40



NOTICE OF EXTENDED PAYMENT PROVISION

(PER ARS 32-1129.01) THIS CONTRACT ALLOWS THE OWNER TO MAKE PAYMENT WITHIN 15 DAYS AFTER CERTIFICATION AND APPROVALS OF BILLINGS AND ESTIMATES FOR PROGRESS PAYMENTS, WITHIN 15 DAYS AFTER CERTIFICATION AND APPROVALS OF BILLINGS AND ESTIMATES FOR RELEASE OF RETENTION AND WITHIN 15 DAYS AFTER CERTIFICATION AND APPROVAL OF BILLINGS AND ESTIMATES FOR FINAL PAYMENT.

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318	Symbol	Revisions	Date	Appr.	Designed by:	Date:	
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FOR REVIEW ONLY
NOT FOR CONSTRUCTION

Kimley Horn

ENGINEER A. BAIRD
PE NO. 48841 DATE 02/24



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PUBLIC WORKS DEPARTMENT
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SEDONA, ARIZONA 86336
928-204-7111

UPTOWN SEDONA PARKING GARAGE

SITE PLAN

SHEET ID
RD01

SHEET NO.
11 OF 17

- 2. SITE GRADING NECESSITATED BY THE WORK AS IT PROGRESSES AND NOT SPECIFICALLY CALLED OUT ON THE PLANS SHALL BE CONSIDERED INCIDENTAL WORK.
- 3. CONTRACTOR SHALL COORDINATE AND BE IN COMPLIANCE WITH ALL STATE AND LOCAL MUNICIPALITIES AS WARRANTED.
- 4. CONTRACTOR IS TO REVIEW PLANS, VERIFY SITE CONDITIONS AND PLANT QUANTITIES PRIOR TO INSTALLATION. ANY DISCREPANCIES FOUND BETWEEN THE DRAWINGS AND SPECIFICATIONS AND EXISTING SITE CONDITIONS OR ANY INCONSISTENCIES OR AMBIGUITIES IN DRAWINGS OR SPECIFICATIONS SHALL BE IMMEDIATELY REPORTED TO THE LANDSCAPE ARCHITECT, IN WRITING, WHO SHALL PROMPTLY ADDRESS SUCH INCONSISTENCIES OR AMBIGUITIES. WORK DONE BY THE CONTRACTOR AFTER HIS DISCOVERY OF SUCH DISCREPANCIES, INCONSISTENCIES, OR AMBIGUITIES SHALL BE DONE AT THE CONTRACTOR'S RISK.
- 5. DEVIATION FROM THESE PLANS AND NOTES WITHOUT THE PRIOR CONSENT OF THE OWNER, OR THE LANDSCAPE ARCHITECT, MAY BE CAUSE FOR THE WORK TO BE DESIGNATED UNACCEPTABLE.
- 6. THE CONTRACTOR ACKNOWLEDGES & AGREES THAT THE WORK IS ENTIRELY AT HIS RISK UNTIL SITE IS ACCEPTED, AND HE WILL BE HELD RESPONSIBLE FOR ITS SAFETY BY THE OWNER.
- 7. THE CONTRACTOR WILL BE HELD RESPONSIBLE FOR THE DAMAGE OR LOSS OF ANY REFERENCE POINTS AND HUBS DURING THE CONSTRUCTION OF HIS WORK, AND SHALL BEAR THE COST OF REPLACING SAME.
- 8. THE CONTRACTOR IS RESPONSIBLE FOR HORIZONTALLY AND VERTICALLY LOCATING AND PROTECTING ALL PUBLIC AND PRIVATE UTILITIES WHICH LIE IN OR ADJACENT TO THE CONSTRUCTION SITE AT LEAST 48 HOURS PRIOR TO ANY DEMOLITION, GRADING, OR CONSTRUCTION ACTIVITY.
- 9. THE CONTRACTOR SHALL SALVAGE AND PROTECT ALL EXISTING POWER POLES, SIGNS, MANHOLES, TELEPHONE RISERS, WATER VALVES, ETC., DURING ALL CONSTRUCTION PHASES UNLESS NOTED OTHERWISE. THE CONTRACTOR SHALL REPAIR. AT HIS OWN EXPENSE. ANY EXISTING UTILITIES DAMAGED DURING CONSTRUCTION.
- 10. ANY FOREIGN ITEM FOUND DURING CONSTRUCTION IS THE PROPERTY OF THE OWNER. THIS INCLUDES, BUT IS NOT LIMITED TO, PRECIOUS METALS, COINS, PAPER CURRENCY, ARTIFACTS AND ANTIQUITIES.
- 11. ALL SURPLUS EXCAVATION SHALL BE TAKEN TO A SITE DESIGNATED BY OWNER, AT NO ADDITIONAL COST TO THE OWNER. IF OWNER CHOOSES, THE CONTRACTOR MAY TAKE POSSESSION OF SURPLUS EXCAVATION MATERIAL.
- 12. CONTRACTOR IS RESPONSIBLE FOR VERIFYING AND OR OBTAINING ALL REQUIRED PERMITS AND APPROVALS PRIOR TO COMMENCING CONSTRUCTION.
- 13. CONTRACTOR IS TO MAINTAIN CONTROLLED PEDESTRIAN AND ADA ACCESS THROUGH ALL AREAS OF THE SITE THROUGHOUT CONSTRUCTION PERIOD.
- 14. MAINTAIN THE SITE IN A NEAT AND ORDERLY CONDITION AT ALL TIMES. DAILY, AND MORE OFTEN IF NECESSARY, INSPECT & AND PICK UP ALL SCRAP, DEBRIS, & WASTE MATERIAL.
- 15. IT IS THE RESPONSIBILITY OF THE CONTRACTOR TO REMOVE ALL MUD. DIRT, ROCK MULCH AND OTHER MATERIALS TRACKED ONTO ANY PRIVATE OR PUBLIC STREETS OR SIDEWALKS. THE CONTRACTOR MUST CLEAN THESE DAILY, IF NECESSARY. THE CONTRACTOR MUST USE WATER OR OTHER ACCEPTABLE METHODS TO KEEP AIRBORNE DUST TO A
- 16. PROVIDE PROTECTION TO ALL FINISHED WORK. MAINTAIN SURFACES CLEAN, UNMARRED, AND SUITABLY PROTECTED UNTIL ACCEPTANCE BY OWNER.
- 17. THE CONTRACTOR SHALL BE RESPONSIBLE FOR REPAIRING ANY DAMAGE RESULTING FROM CONSTRUCTION ACTIVITY TO EXISTING ELEMENTS THAT ARE TO REMAIN.
- 18. EROSION CONTROL MEASURES (IE: SILT FENCING AND SEDIMENT CONTROL) SHALL BE MAINTAINED BY THE CONTRACTOR PER CIVIL SPECIFICATIONS. ANY EROSION CONTROL MEASURES DAMAGED BY THE CONTRACTOR SHALL BE REPLACED PER CIVIL SPECIFICATIONS.
- 19. PLANT QUANTITIES LISTED IN THE PLANT LEGEND ARE FOR THE CONVENIENCE OF THE CONTRACTOR. THE CONTRACTOR SHALL DO THEIR OWN TAKE-OFFS AND BASE BID ACCORDINGLY.
- 20. ALL PLANT MATERIAL SHALL BE HEALTHY, VIGOROUS, WELL BRANCHED, AND DENSELY FOLIATED (WHEN IN-LEAF) AS IS TYPICAL FOR THE SPECIES. THEY SHALL HAVE HEALTHY, WELL DEVELOPED STANDARDS, AND FREE OF ANY BRUISES, CUTS OR OTHER ABNORMALITIES. PLANT MATERIAL SHALL BE SIZED IN ACCORDANCE WITH THE AMERICAN STANDARD FOR NURSERY STOCK, LATEST EDITION, PUBLISHED BY THE AMERICAN ASSOCIATION OF NURSERYMAN.
- 21. OWNERS REPRESENTATIVE RESERVES THE RIGHT TO REJECT ANY PLANT MATERIAL DEEMED UNACCEPTABLE.
- 22. LANDSCAPE CONTRACTOR TO TAG AND HOLD ALL PLANT MATERIAL A MINIMUM OF 30 DAYS PRIOR TO DATE OF INSTALLATION. ALL PLANT MATERIAL SUBSTITUTIONS MADE WITHIN THE 30 DAYS PRIOR TO INSTALLATION TO BE THE NEXT SIZE LARGER AT NO ADDITIONAL COST TO THE CLIENT.
- 23. INSTALL ALL CANOPY TREES WITH A MINIMUM OF 5 FT. SEPARATION FROM ALL UTILITIES. UNLESS A ROOT BARRIER IS UTILIZED.
- 24. THE LANDSCAPE CONTRACTOR SHALL MAINTAIN PLANTED AREAS BY MEANS OF CONTINUOUS WATERING, PRUNING, RAISING TREE ROOT BALLS WHICH SETTLE BELOW GRADE, APPLICATION OF SPRAYS WHICH ARE NECESSARY TO KEEP THE PLANTING FREE OF INSECTS AND DISEASES, FERTILIZING, WEEDING, MOVING, EDGING AND/OR OTHER OPERATIONS NECESSARY FOR PROPER CARE AND UPKEEP. MAINTENANCE PERIOD SHALL BE TWO (2) YEARS BEGINNING FROM DATE OF ACCEPTED FINAL COMPLETION.
- 25. ROCK MULCH: ALL AREAS LABELED ROCK MULCH ON THE PLANS ARE TO BE APPROVED BY OWNER. 2" MINIMUM DEPTH THROUGHOUT ENTIRE PROJECT. FINISH GRADE IN ALL AREAS TO BE SMOOTH AND EVEN AND 1" BELOW TOP OF CURB OR SIDEWALK.

### MAINTENANCE REQUIREMENTS

- 1. THE LANDSCAPE MAINTENANCE AND WARRANTY PERIOD SHALL BE SEVEN HUNDRED AND THIRTY (730) CONSECUTIVE CALENDAR DAYS. THE TIME PERIOD SHALL BEGIN AFTER WRITTEN NOTICE FROM THE PROJECT ENGINEER OF SUBSTANTIAL COMPLETION OF THE LANDSCAPE PORTION OF THE PROJECT AND WHEN THE ENGINEER IS ASSURED THAT THE WORK CAN BE PERFORMED IN A CONTINUOUS AND CONSISTENT MANNER WITHOUT RESTRICTING THE USE OF ANY FACILITIES BY THE TRAVELING PUBLIC.
- 2. THE CONTRACTOR SHALL SUBMIT A WORK SCHEDULE OF OPERATIONS FOR APPROVAL BY THE ENGINEER AND CITY OF SEDONA STAFF. THE WORK SCHEDULE SHALL INCLUDE CONTACT INFORMATION FOR THOSE RESPONSIBLE FOR MAINTENANCE.
- 3. PLANT MATERIALS NOT SURVIVING SHALL BE REPLACED WITHIN 30 DAYS OF ITS DEMISE.

### PLANT LEGEND

DECIDUOUS TREES			
SYMBOL	BOTANICAL NAME COMMON NAME	QUANTITY	SIZE
EVERGREEN TREES	CHILOPSIS LINEARIS 'HOPE'* HOPE DESERT WILLOW	6	2" CAL MIN.
SYMBOL	BOTANICAL NAME COMMON NAME	QUANTITY	SIZE
March Color of the	JUNIPERUS ARIZONICA* REDBERRY JUNIPER	25	8'HT MIN.
	JUNIPERUS SCOPULORUM* ROCKY MOUNTAIN JUNIPER	10	8' HT MIN.
SHRUBS/GROUNDCOVI	ERS		
SYMBOL	BOTANICAL NAME COMMON NAME	QUANTITY	SIZE
$\odot$	ASCLEPIAS TUBEROSA BUTTERFLY MILKWEED	32	5 GAL.**
0	BOUTELOUA GRACILIS 'BLONDE AMBITION' 'BLONDE AMBITION' BLUE GRAMA	43	1 GAL.
0	GUTIERREZIA SAROTHRAE* SNAKEWEED	58	5 GAL.**
O	MELAMPODIUM LEUCANTHUM BLACKFOOT DAISY	18	1 GAL.
$\odot$	NOLINA MICROCARPA* BEAR GRASS	18	5 GAL.**
6. 8. 8. 8. 8. 8. 8. 8. 8. 8. 8. 8. 8. 8.	RHUS TRILOBATA* THREE—LEAF SUMAC	14	5 GAL.**
SITE			
SYMBOL	NAME	QUANTITY	
	1"-3" ROCK MULCH, COLOR TBD	15,913 SQ FT	

\*NATIVE PLANT FROM THE CITY OF SEDONA APPROVED PLANT LIST. \*\*SHRUBS SHALL BE 2' HEIGHT, MINIMUM, AT TIME OF INSTALLATION.

### PLANTING REQUIREMENTS

TOTAL LANDSCAPE AREA: 16,094 SQ FT

TREE REQUIREMENTS: 1 TREE REQUIRED PER 400 SQ FT TREES REQUIRED: 41 TREES PROVIDED: 41

A MINIMUM OF 50% OF THE SPECIES SHALL BE NATIVE.

PERCENT OF NATIVE PLANTS PROVIDED: 52% NATIVE PLANTS PROVIDED

**SHRUB REQUIREMENTS:** 3 SHRUBS REQUIRED PER 400 SQ FT SHRUBS REQUIRED: 120 SHRUBS PROVIDED: 183

### **IRRIGATION NOTES**

- 1. CONTRACTOR SHALL REVIEW AND FIELD VERIFY LAYOUT OF ALL IRRIGATION SYSTEM COMPONENTS AND HAVE THE LAYOUT AND COMPONENTS APPROVED BY CITY OF SEDONA STAFF PRIOR TO STARTING INSTALLATION.
- 2. ALL PIPING AND WIRING PLACED UNDER PAVED AREAS SHALL BE SLEEVED PER PLAN DETAILS. SLEEVE INSTALLATIONS SHALL BE COMPLETED PRIOR TO THE START OF ANY PAVING OPERATIONS (SEE ENGINEERING PLANS).
- 3. THE CONTRACTOR SHALL BE RESPONSIBLE FOR INSTALLING, TESTING, MAINTAINING, REPAIRING, AND OPERATING A COMPLETE AND FULLY FUNCTIONAL IRRIGATION SYSTEM INCLUDING ALL LATERAL PIPING AND FITTINGS AS SPECIFIED AND AS DETAILED, WHETHER OR NOT PIPING IS SHOWN ON THE PLANS.
- 4. ANY SUBSTITUTIONS OR OMISSIONS OF IRRIGATION COMPONENTS AND EQUIPMENT MUST BE APPROVED IN WRITING BY CITY OF SEDONA STAFF PRIOR TO STARTING INSTALLATION.
- 5. CONTRACTOR TO FIELD VERIFY ALL WATER PRESSURE AND FLOWS PRIOR TO INSTALLATION OF SYSTEM. IF INSUFFICIENT PRESSURE IS ENCOUNTERED, NOTIFY OWNER IMMEDIATELY.
- 6. ALL EXISTING IRRIGATION COMPONENTS SHALL BE MAINTAINED IN CURRENT WORKING CONDITION. ALL EXISTING PLANTS SHALL ONTINUE RECEIVING IRRIGATION DURING CONSTRUCTION ACTIVITIES.

### IRRIGATION LEGEND

SYMBOL	EQUIPMENT	SIZE	PRODUCT
M	WATER METER — POTABLE	1"	REFER TO CIVIL PLANS
	CONTROLLER	8 STA	CALSENSE CS3000-8-S
B	BACKFLOW PREVENTER	1"	FEBCO 825Y
Δ	PRESSURE REGULATOR	1"	SENNINGER PMR-35MF
	REMOTE CONTROL VALVE ASSEMBLY — DRIP ZONES	1"	RAINBIRD-100-PESB
	MAINLINE	1"	PVC SCH 40
TT	TREE LATERAL LINE	3/4"	PVC SCH 40
<u> </u>	SHRUB LATERAL LINE	3/4"	PVC SCH 40
=====	SLEEVE UNDER STREET & PATHWAY	4"	PVC SCH 40
<del></del>	END CAP AUTOMATIC FLUSHING COMPRESSION END PLUG		
NOT SHOWN	EMITTER ASSEMBLY MULTI-PORT; (1 GPH & 2 GPH)		RAINBIRD XBT-10-6, XBT-20-6; 1 PER TREE; SHRUBS WITH SAME FLOW RATE TO SHARE

NOTICE OF EXTENDED PAYMENT PROVISION

(PER ARS 32-1129.01) THIS CONTRACT ALLOWS THE OWNER TO MAKE PAYMENT WITHIN 15 DAYS AFTER CERTIFICATION AND APPROVALS OF BILLINGS AND ESTIMATES FOR PROGRESS PAYMENTS, WITHIN 15 DAYS AFTER CERTIFICATION AND APPROVALS OF BILLINGS AND ESTIMATES FOR RELEASE OF RETENTION AND WITHIN 15 DAYS AFTER CERTIFICATION AND APPROVAL OF BILLINGS AND ESTIMATES FOR FINAL PAYMENT.


Symbol	Revisions	Date	Appr.	Designed by: MMP	Date: 02/05/2024
				Drawn by:	Scale:
				MMP	N/A
				Checked by:	Project Code:
				RVF	091885001

PRELIMINARY FOR REVIEW ONLY NOT FOR CONSTRUCTION **Kimley** » Horn ENGINEER \_\_\_\_A. BAIRD PE NO.<u>48841</u> DATE<u>02/24</u>



PHONE: 928-458-7121

WWW.KIMLEY-HORN.COM

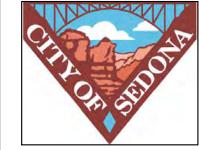

CITY OF SEDONA **PUBLIC WORKS DEPARTMENT** 102 ROADRUNNER DRIVE

**SEDONA, ARIZONA 86336** 928-204-7111

**UPTOWN SEDONA** PARKING GARAGE

LS01

LANDSCAPE NOTES


SHEET NO.

SHEET ID

12 OF 17

Dial 8-1-1 or 1-800-STAKE-IT (782-534


In Maricopa County: (602) 263-110

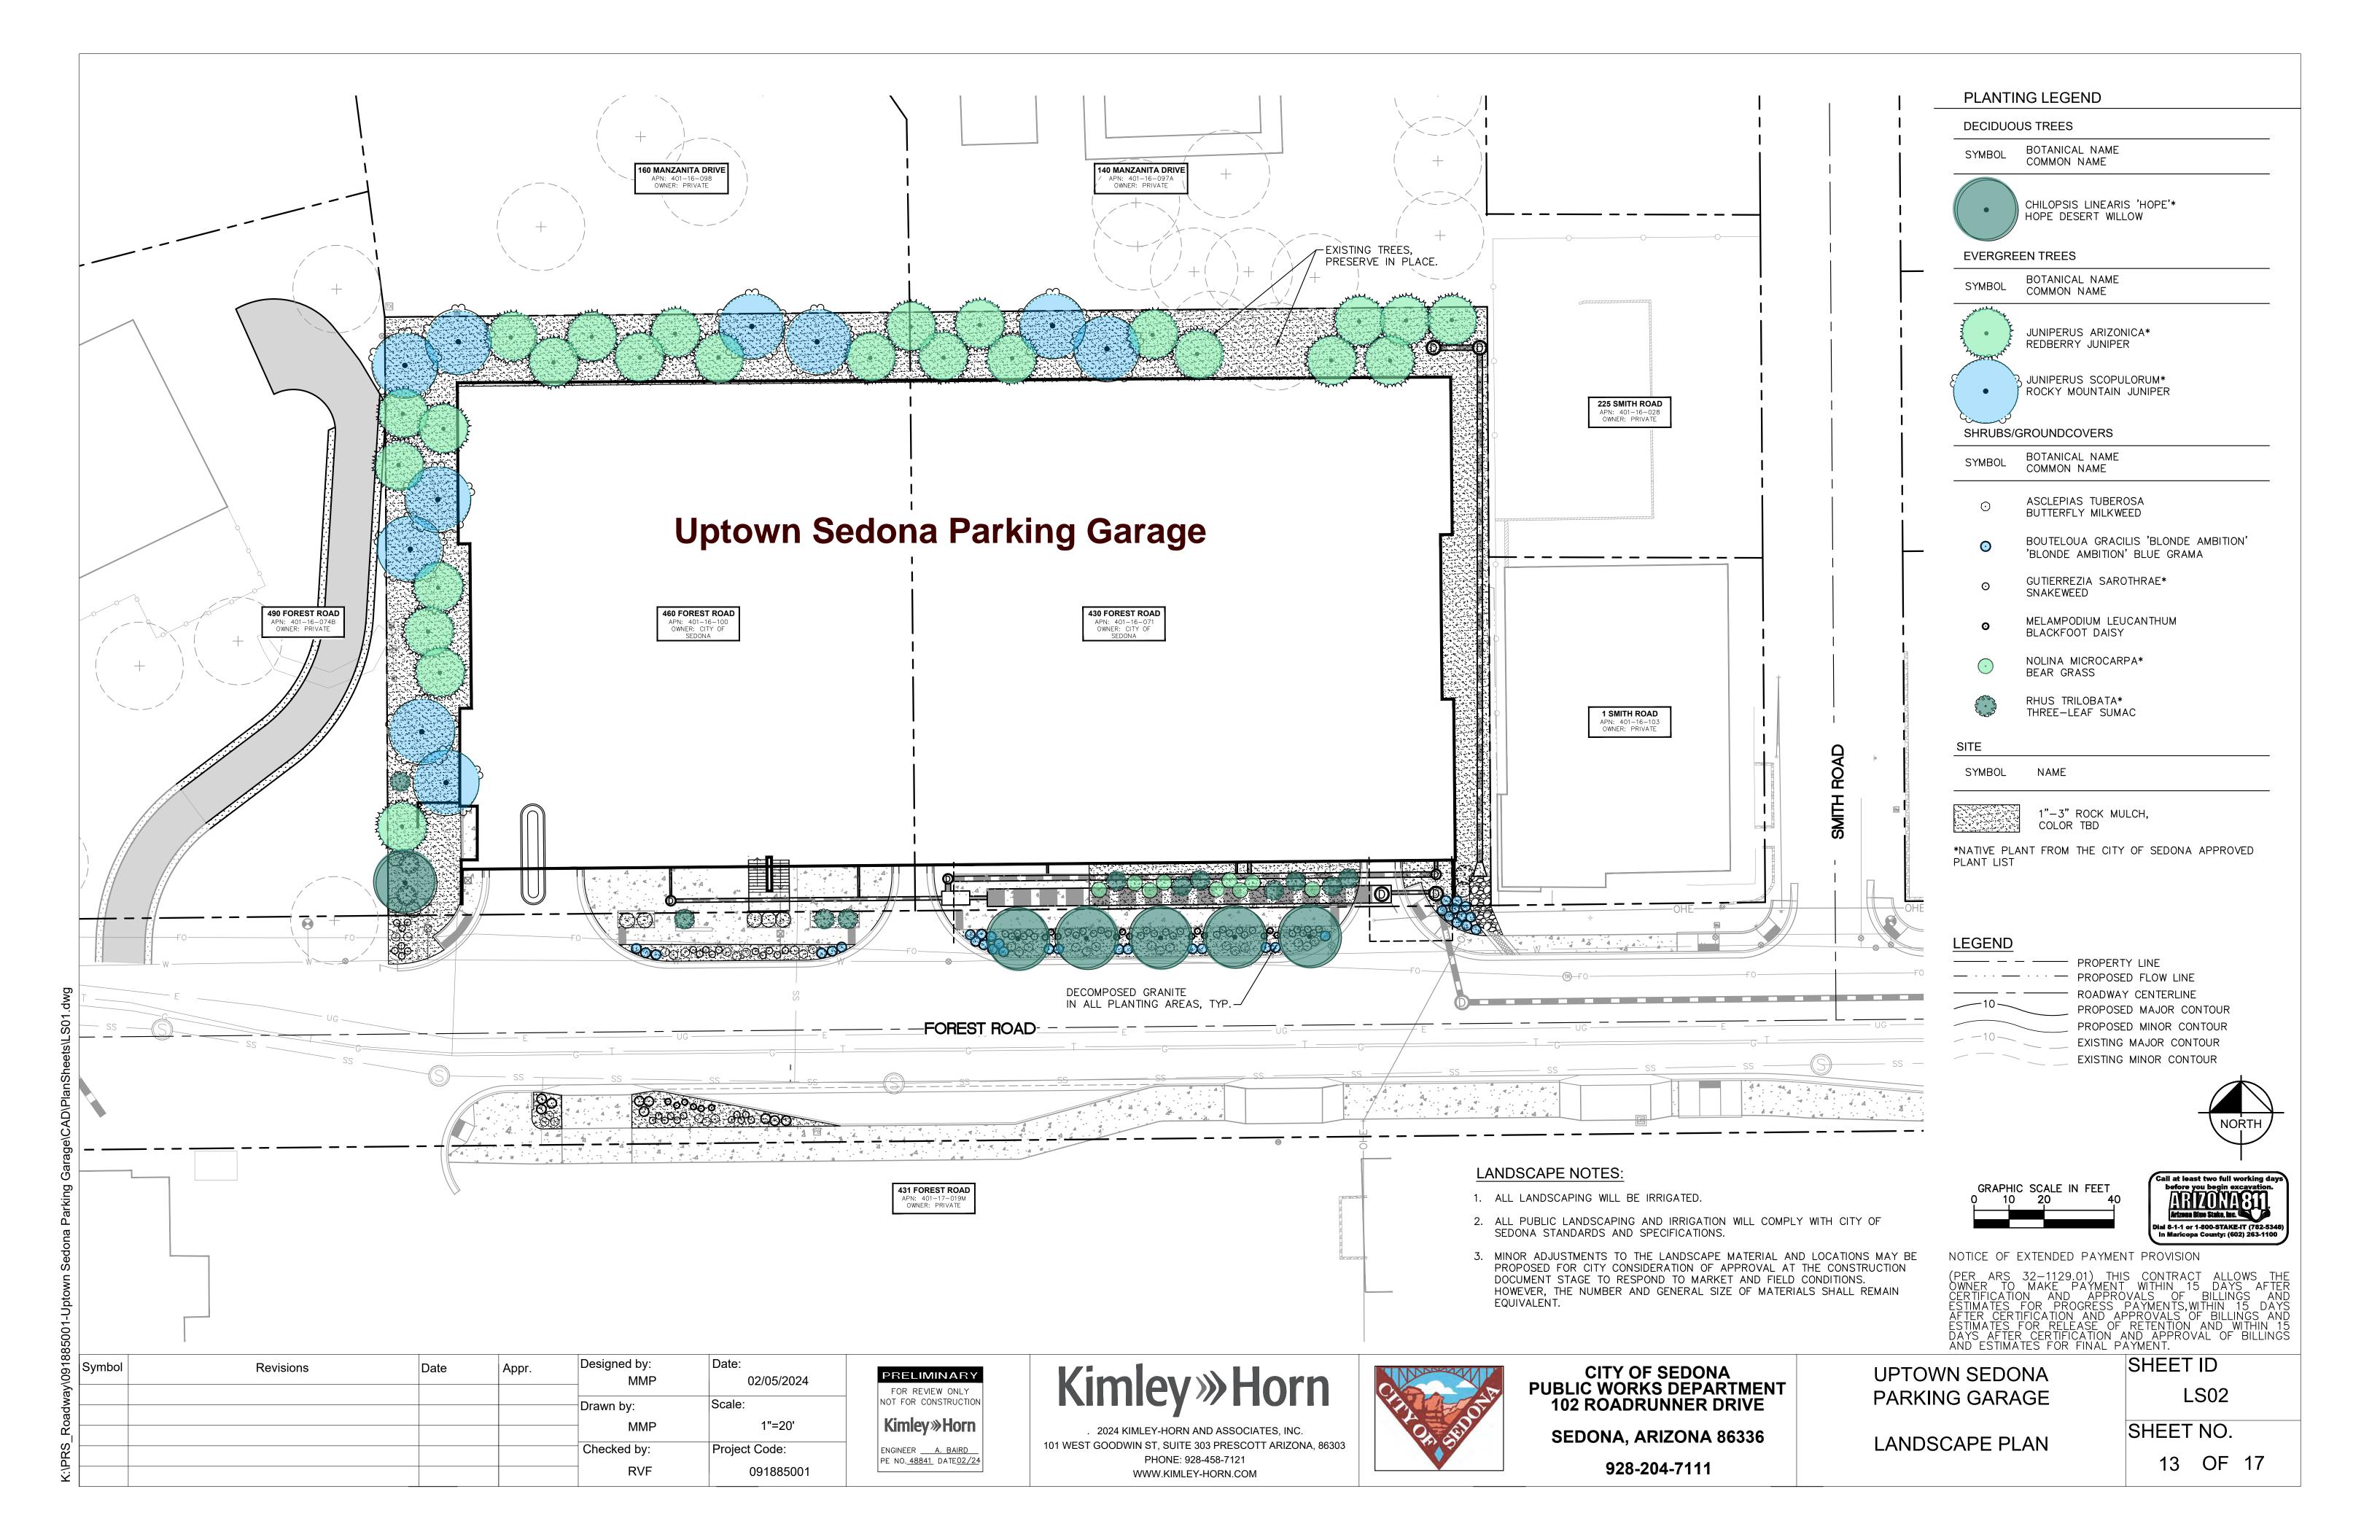

PRUNE ONLY DEAD, DAMAGED OR CROSSING BRANCHES THAT RUB. 2. IN AREAS OF HARD DIGGING CONDITIONS THE PLANTING HOLE SHALL BE OVEREXCAVATED TO MINIMUM DEPTH OF 36 INCHES AND A MINIMUM WIDTH OF 48 INCHES. TWENTY POUNDS OF GYPSUM SHALL BE EVENLYADDED TO THE BOTTOM OF THE PIT, AND THE PIT COMPLETELY BACKFILLED WITH PREPARED SOIL AND COMPACTED TO A MINIMUM DENSITY OF 85 PERCENT AND A MAXIMUM DENSITY OF 90 PERCENT. AFTER THE PIT HAS BEEN BACKFILLED AND COMPACTED, THE PLANTING PIT SHALL BE AUGURED. ONCE AUGURING HAS BEEN COMPLETED, THE PIT SHALL BE FILLED WITH WATER AND ALLOWED TO DRAIN. ONCE DRAINED, THE PIT SHALL BE FILLED A SECOND TIME AND AGAIN ALLOWED TO DRAIN PRIOR TO INSTALLATION OF THE PLANT. THE CONTRACTOR SHALL NOTIFY THE ENGINEER OF ANY PIT THAT DOES NOT DRAIN WITHIN 48 HOURS. ANY PIT WHICH HAS NOT FULLY DRAINED AFTER EACH FILLING WITHIN A TWELVE HOUR PERIOD SHALL BE DEEPENED UNTIL PROPER DRAINAGE IS ACHIEVED. IF PROPER DRAINAGE CANNOT BE ACHIEVED, THE PIT SHALL BE MOVED OR DELETED, AS DETERMINED BY THE ENGINEER. IF REQUIRED, THIS WORK SHALL BE PAID FOR AS PART OF THE UNIT PRICE BID.

TREE PLANTING

NTS

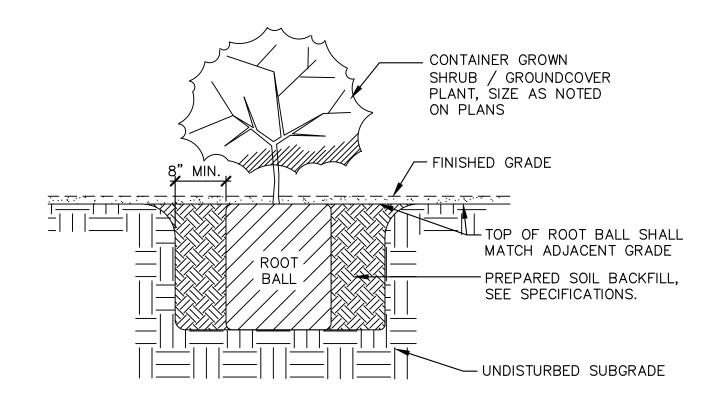

4:1 MAX. SLOPE \_1' TYP. 1% SLOPE — 2"-6" MULCH — SUBGRADE

FINISH GRADE

NTS

SHRUB/GROUND COVER PLANTING - 1, 5 & 15 GAL. SIZE NTS FINISH GRADE AT CURB AND PAVING

- ADJACENT PAVING

Dial 8-1-1 or 1-800-STAKE-IT (782-534) In Maricopa County: (602) 263-1100

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Designed by: Symbol Revisions Date Appr. 02/05/2024 Scale: Drawn by: N/A Project Code: Checked by: RVF 091885001

PRELIMINARY FOR REVIEW ONLY NOT FOR CONSTRUCTION **Kimley** »Horn ENGINEER <u>A. BAIRD</u> PE NO. <u>48841</u> DATE <u>02/24</u>

Kimley» Horn © 2024 KIMLEY-HORN AND ASSOCIATES, INC. 101 WEST GOODWIN ST, SUITE 303 PRESCOTT ARIZONA, 86303 PHONE: 928-458-7121

WWW.KIMLEY-HORN.COM



**CITY OF SEDONA PUBLIC WORKS DEPARTMENT 102 ROADRUNNER DRIVE SEDONA, ARIZONA 86336** 


**UPTOWN SEDONA** PARKING GARAGE


LANDSCAPE DETAILS


SHEET ID LS03


SHEET NO.

928-204-7111

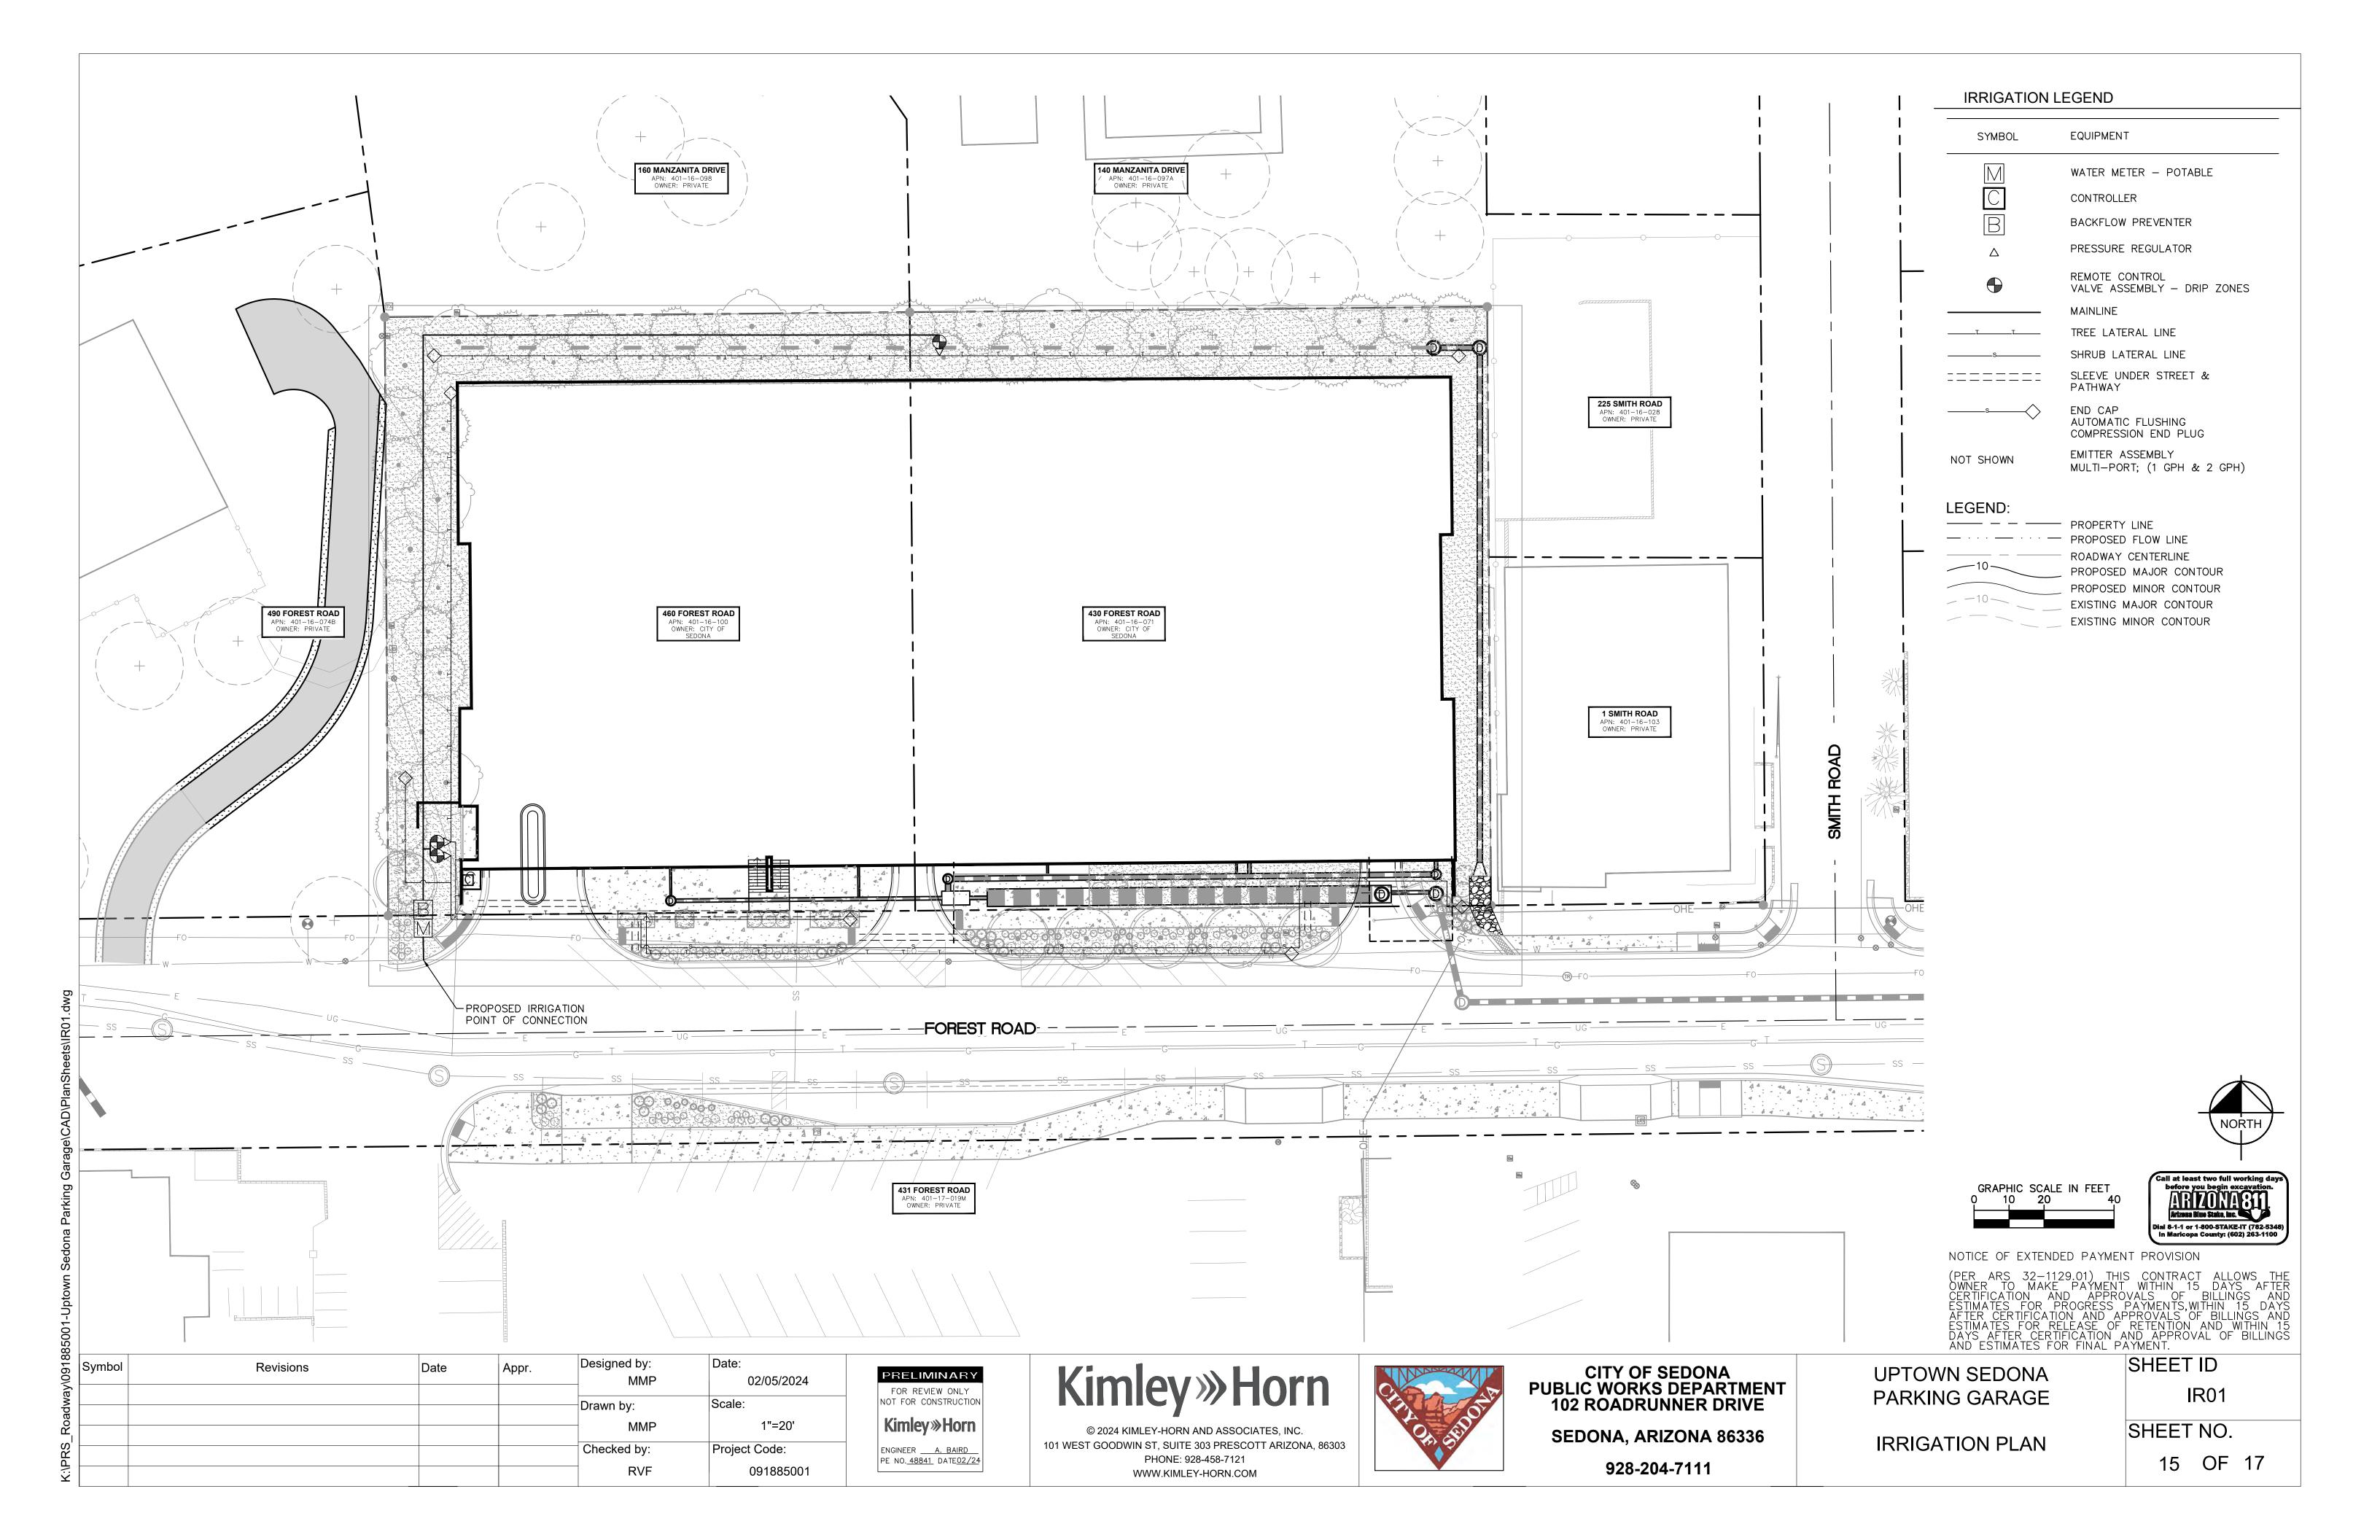


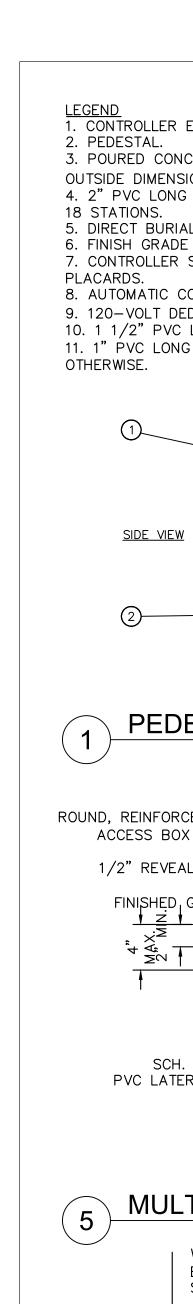

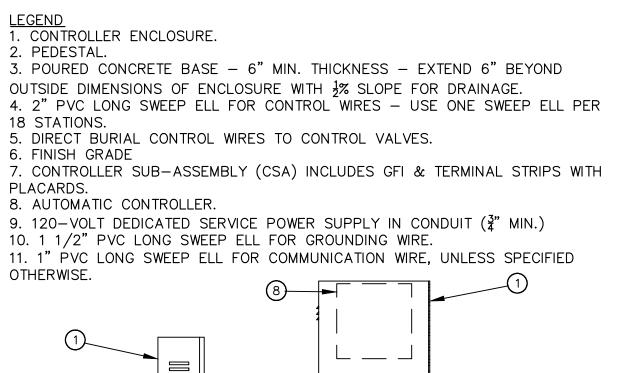


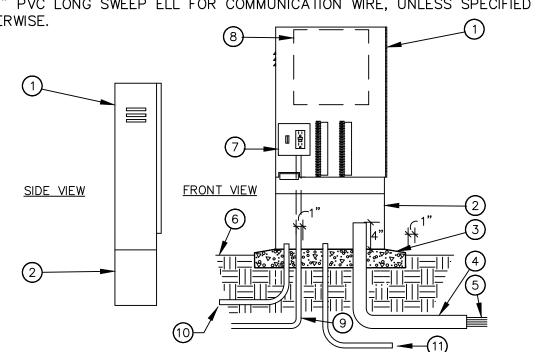



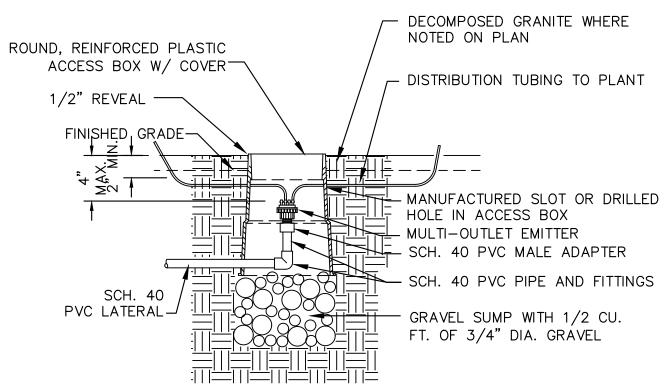


### MULTI OUTLET EMITTER - SIX OUTLET

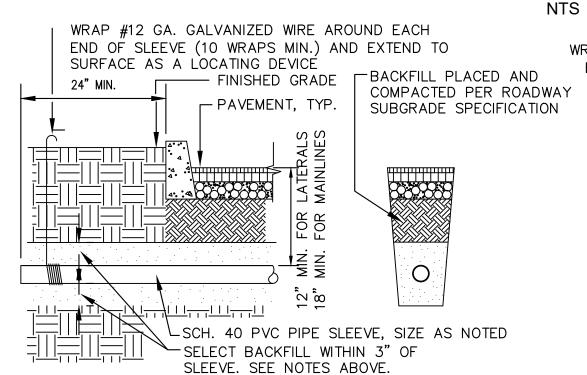


NOTE: BACKFILL WITHIN 3" OF SLEEVE SHALL BE FREE OF ROCKS AND STONES LARGER THAN 1/4"ø. IF ROCK CANNOT BE REMOVED FROM EXCAVATED SOIL, PROVIDE CLEAN SAND BEDDING.


SLEEVE UNDER STREET OR PARKING LOT NTS

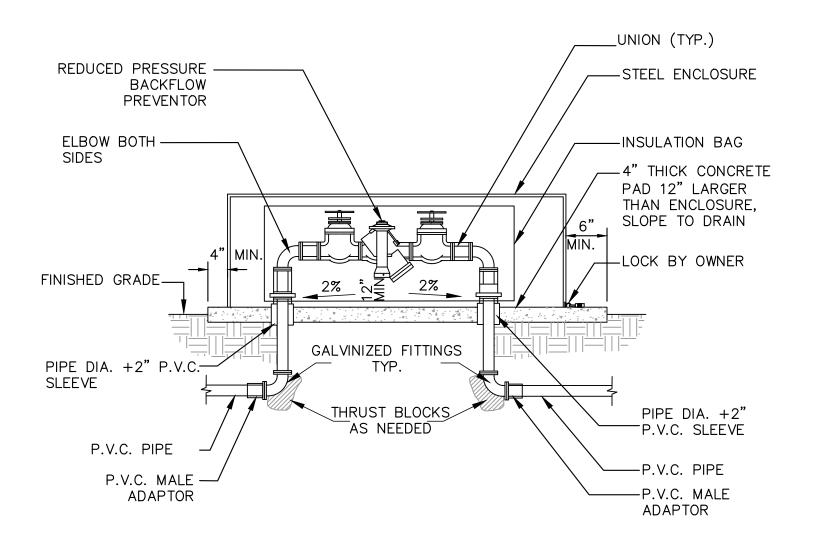



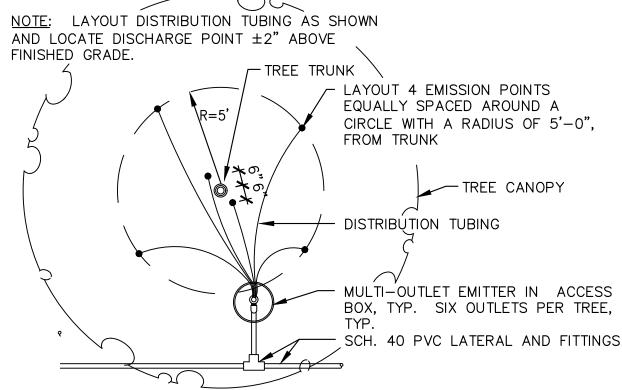


### **EMITTER DISTRIBUTION TUBING LAYOUT** AND TREE - SIX OUTLET

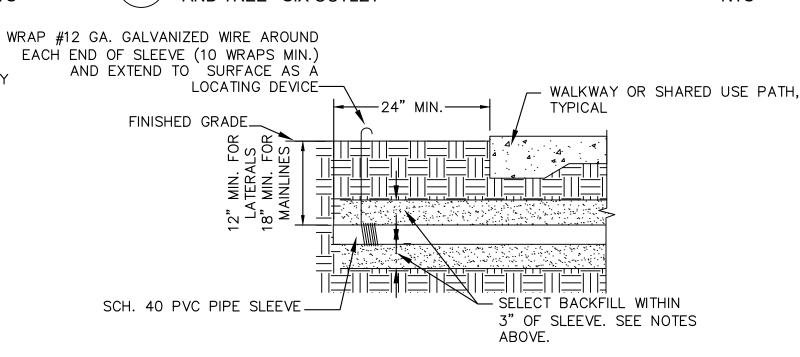


SLEEVES UNDER WALKWAYS SHALL BE SCHEDULE 40 PVC PIPE. SIZE SHALL BE AS NOTED ON PLANS.

BACKFILL WITHIN 3" OF SLEEVE SHALL BE FREE OF ROCKS AND STONES LARGER THAN 1/4" DIA. IF ROCK CANNOT BE REMOVED FROM EXCAVATED SOIL, PROVIDE CLEAN SAND BEDDING.

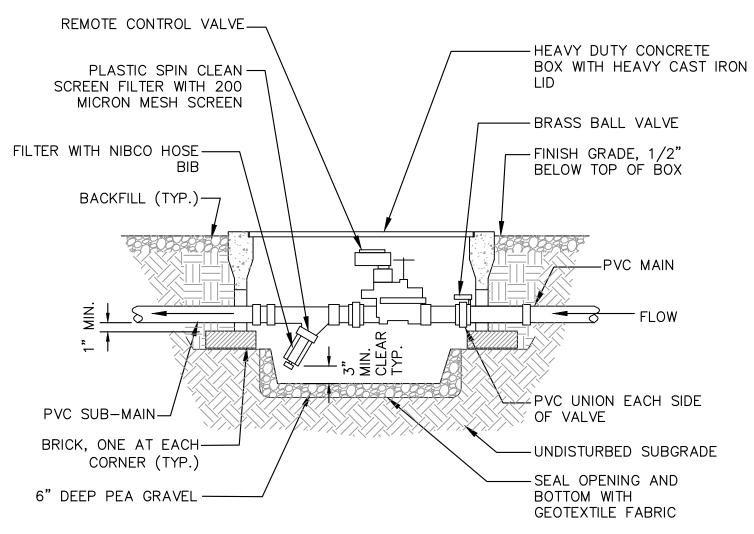



1. PROVIDE 2' FLEXIBLE HOSE WITH FILTER. INSTALL FILTER ON SIDE AT A SLIGHT DOWNWARD ANGLE.

### REMOTE CONTROL VALVE WITH FILTER NTS

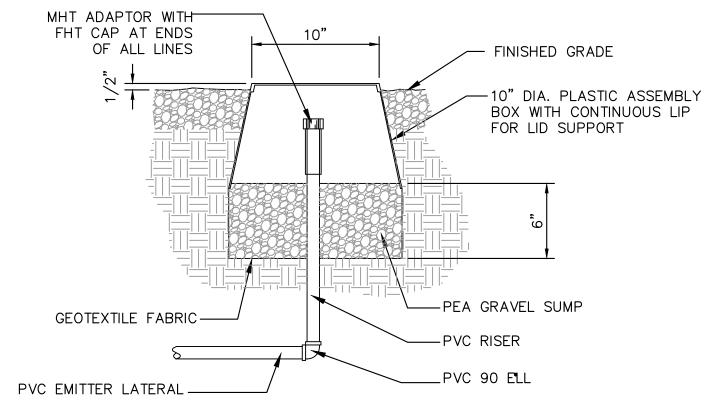

FLUSH END CAP (PVC LATERAL END CAP)

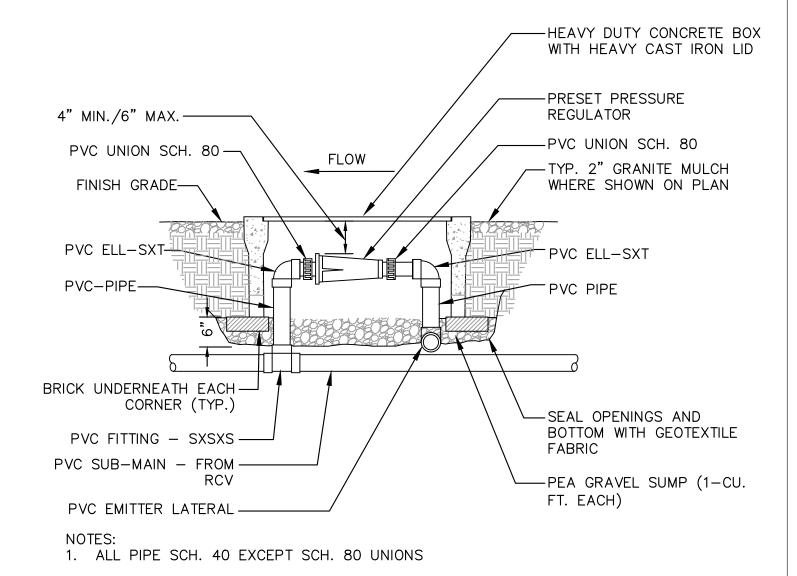

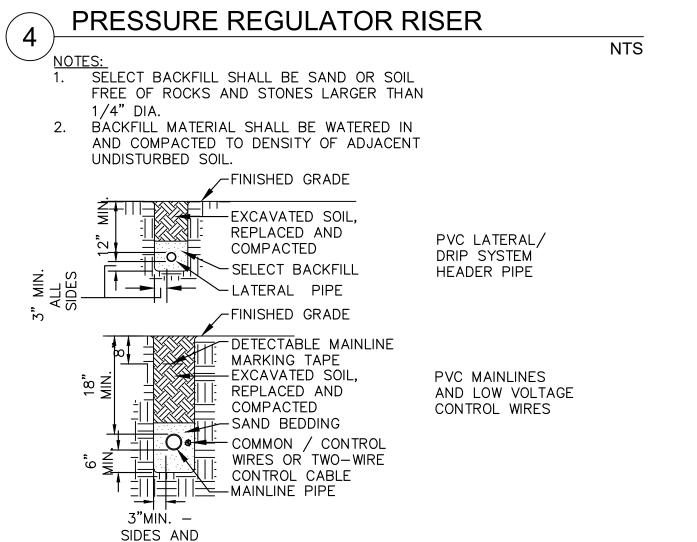

PIPE TRENCHING AND BACKFILL

MAINLINES, LATERALS, & MARKING TAPE

Dial 8-1-1 or 1-800-STAKE-IT (782-534) In Maricopa County: (602) 263-1100

NTS

NOTICE OF EXTENDED PAYMENT PROVISION

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SLEEVE UNDER WALKWAY

Symbol	Revisions	Date	Appr.	Designed by:  MMP	Date: 02/05/2024
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				Drawn by:	Scale:
				MMP	N/A
				Checked by:	Project Code:
				RVF	091885001


PRELIMINARY FOR REVIEW ONLY NOT FOR CONSTRUCTION **Kimley** »Horn ENGINEER <u>A. BAIRD</u> PE NO. 48841 DATE 02/24



PHONE: 928-458-7121

WWW.KIMLEY-HORN.COM

NTS

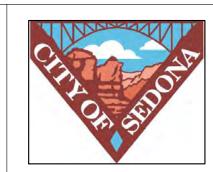

**CITY OF SEDONA PUBLIC WORKS DEPARTMENT 102 ROADRUNNER DRIVE** 


**SEDONA, ARIZONA 86336** 928-204-7111


**UPTOWN SEDONA** PARKING GARAGE

TOP OF PIPE

**IRRIGATION DETAILS** 

SHEET ID IR02 SHEET NO.

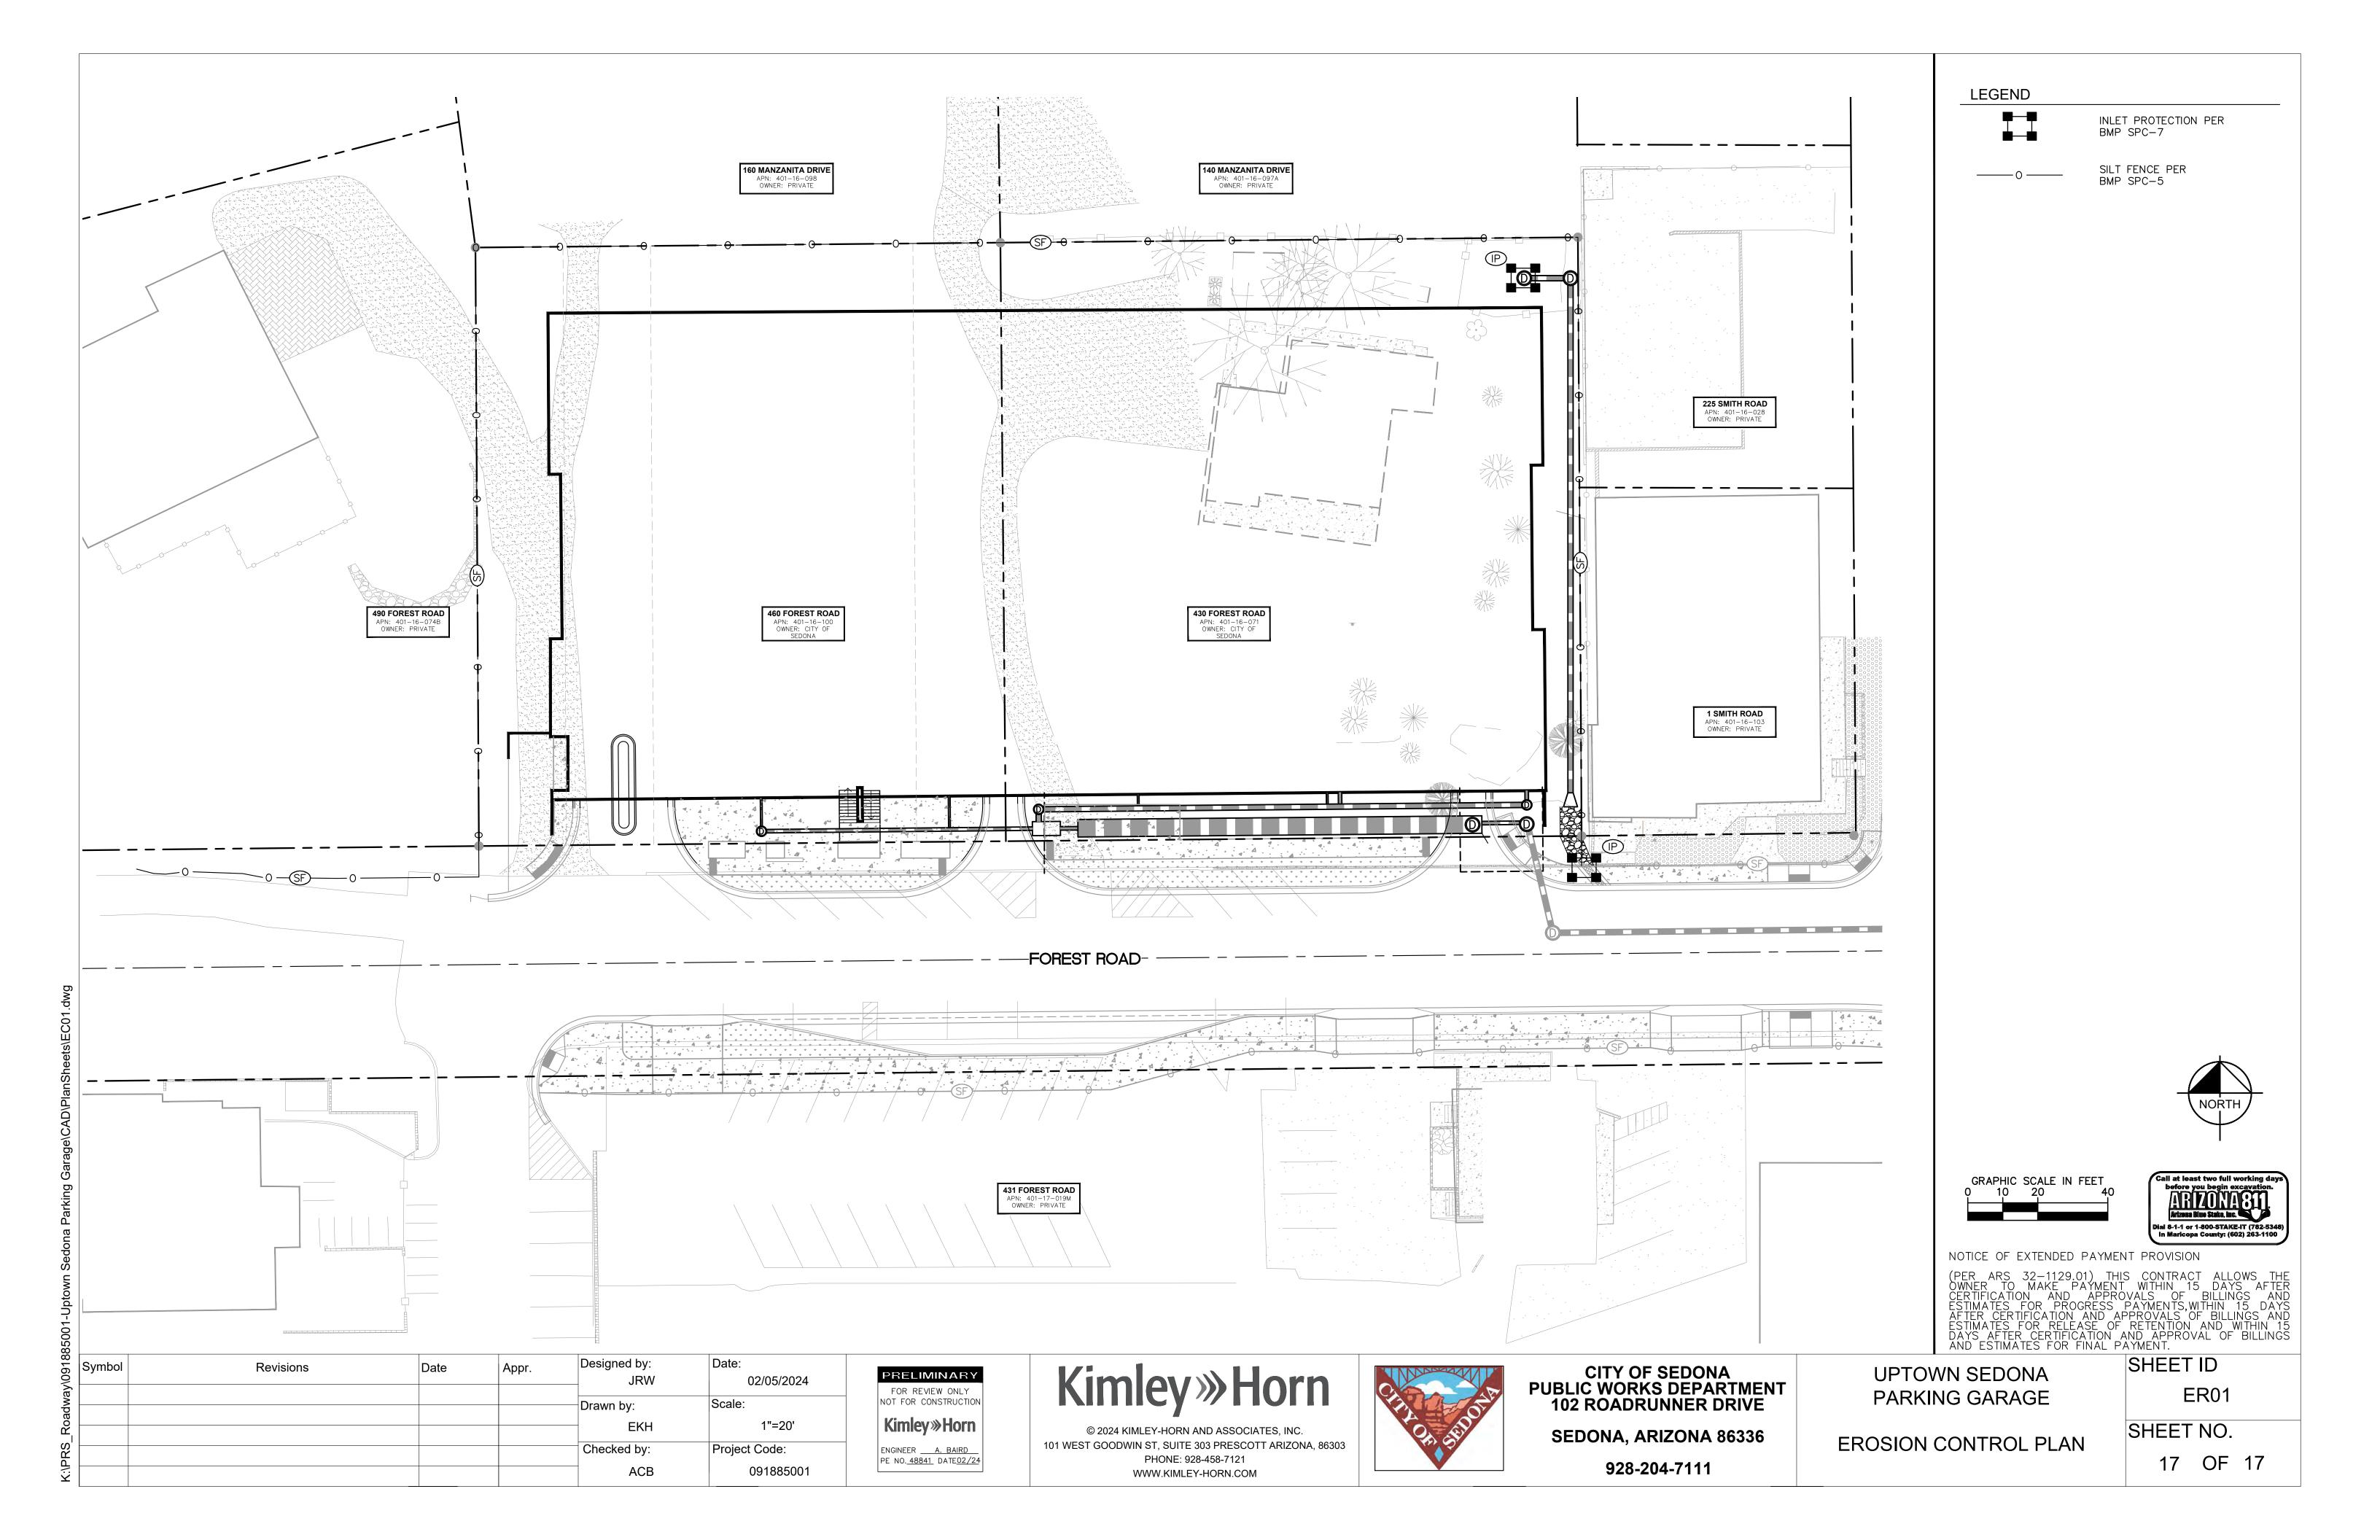

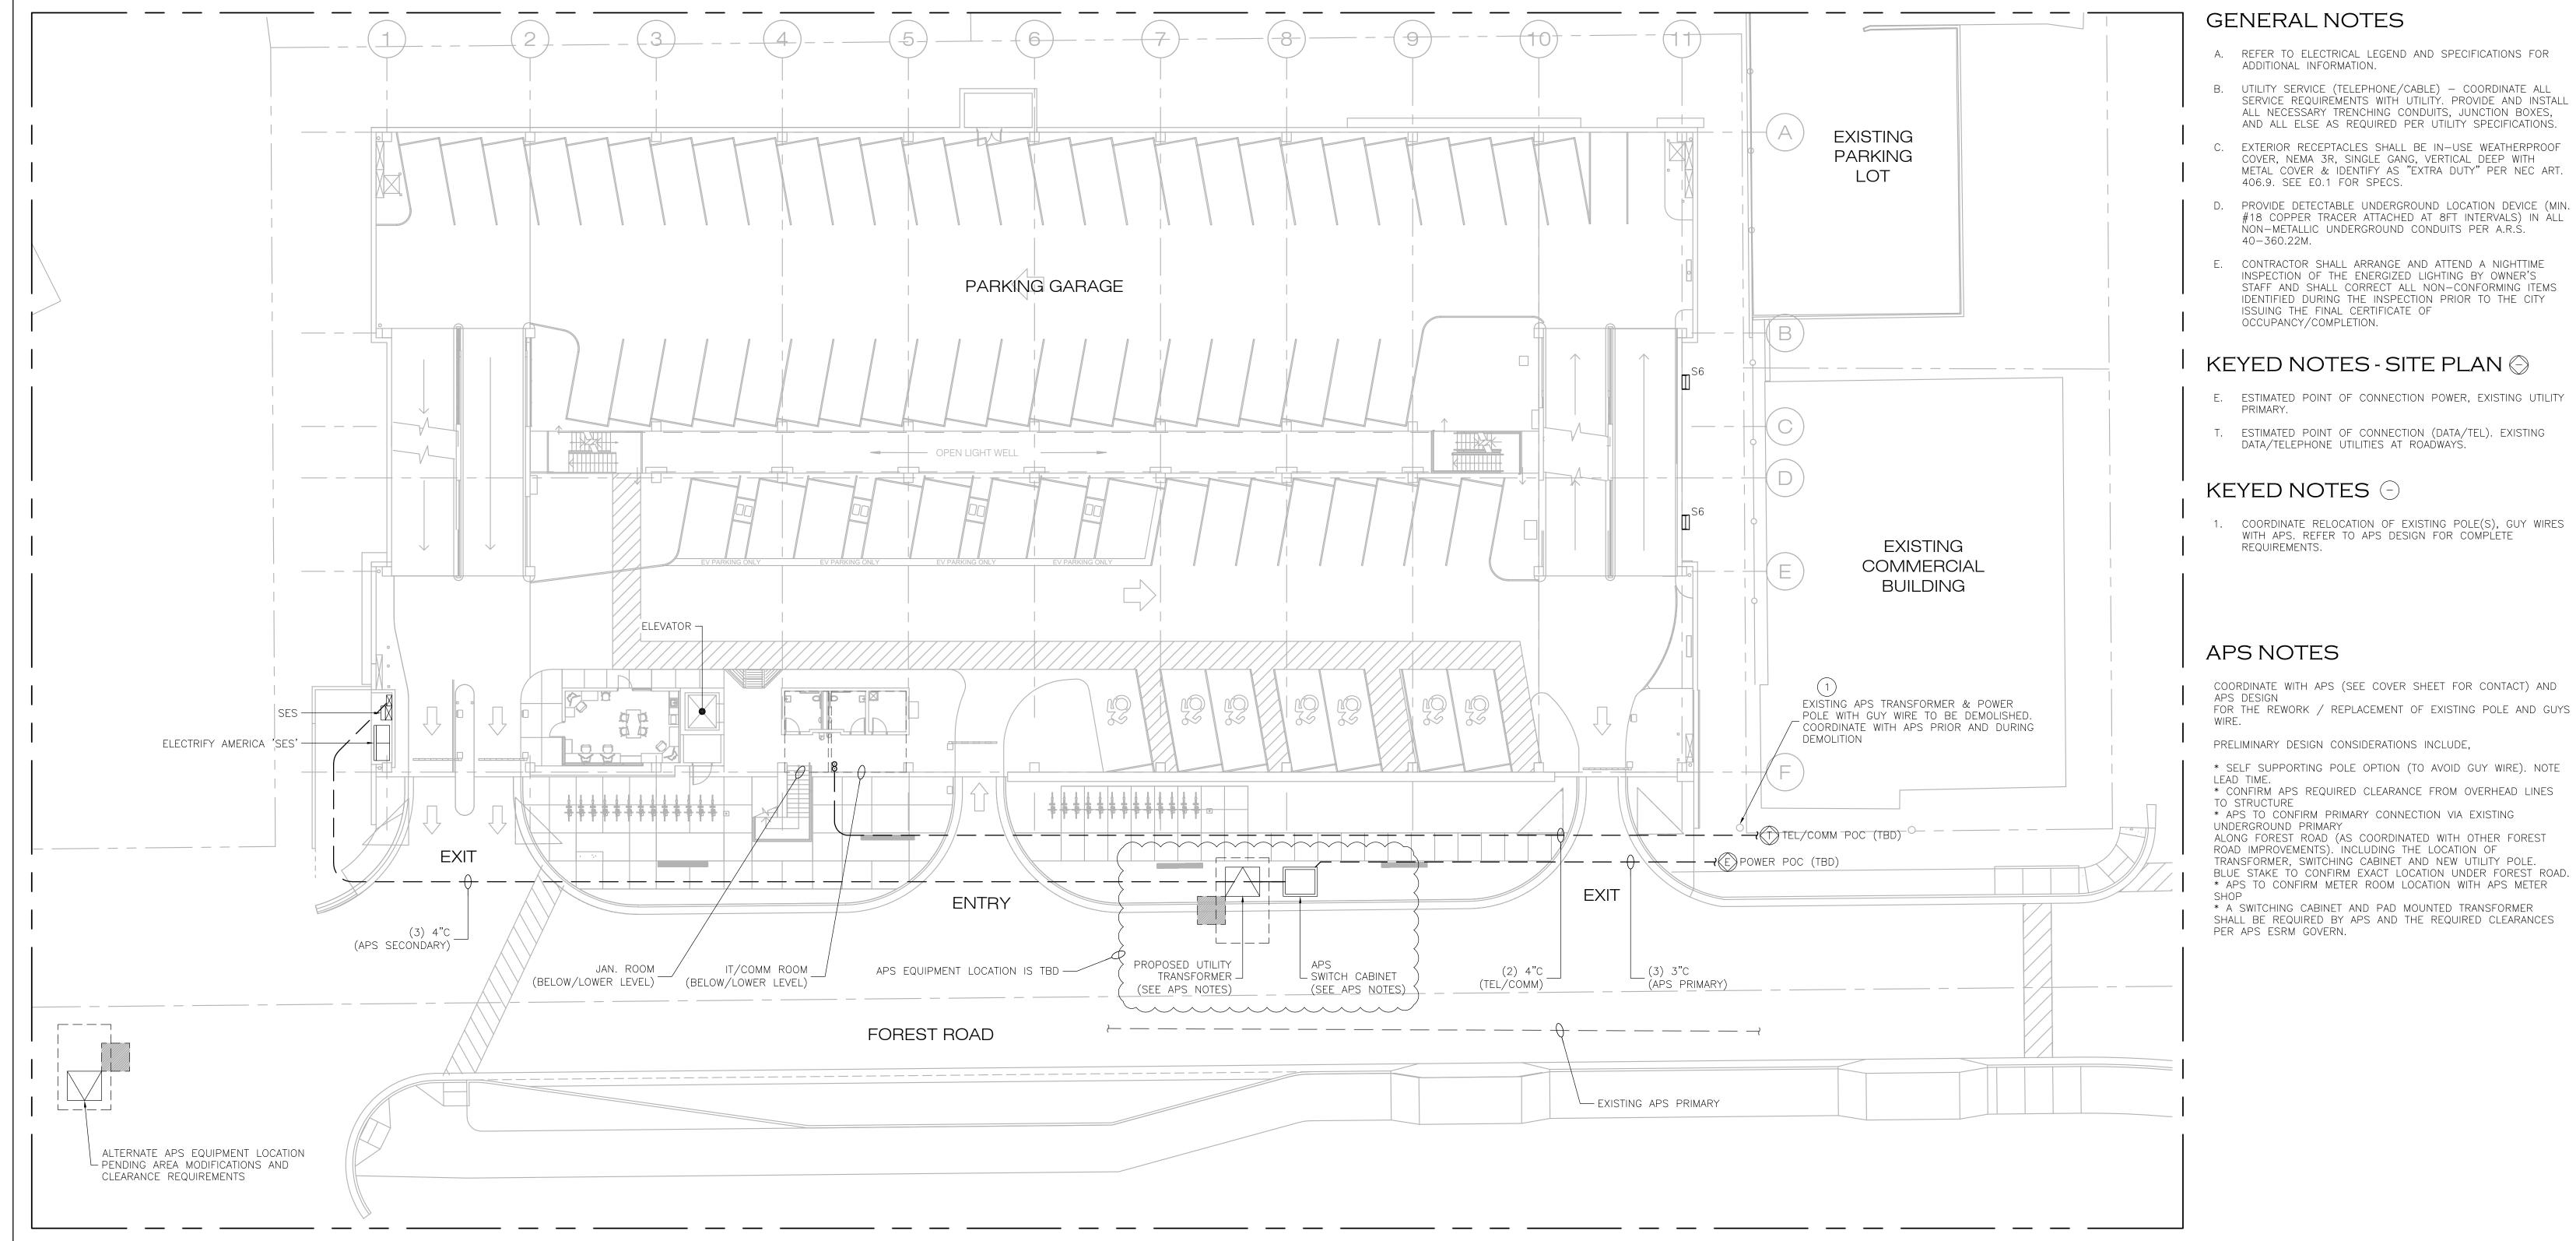

# ELECTRICAL SITE PLAN SCALE: 1/16"=1'-0"

NOTICE OF EXTENDED PAYMENT PROVISION

Symbol

(PER ARS 32-1129.01) THIS CONTRACT ALLOWS
THE OWNER TO MAKE PAYMENT WITHIN 15 DAYS
AFTER CERTIFICATION AND APPROVALS OF
BILLINGS AND ESTIMATES FOR PROGRESS PAYMENTS, WITHIN 15 DAYS AFTER CERTIFICATION
AND APPROVALS OF BILLINGS AND ESTIMATES
FOR RELEASE OF RETENTION AND WITHIN 15
DAYS AFTER CERTIFICATION AND APPROVAL OF
BILLINGS AND ESTIMATES FOR FINAL PAYMENT.

Revisions



2211=0 2800 S. RURAL RD. SUITE 101 TEMPE, AZ 85282 (480)968 3070

Date:

JOB NUMBER 21-020

Designed by:

1730 E. Northern Avenue, Ste . 120, Phoenix, AZ 85020 Tel. (480) 659-0511, VoltaUS.com

**GMP PROGRESS SET** 

NOT FOR CONSTRUCTION

OR RECORDING

gabor lorant architects

3326 n. 3rd avenue suite 200 phoenix, arizona 85013 tel: 602.667.9090 fax: 602.667.9133 gaborlorant.com



CITY OF SEDONA PUBLIC WORKS DEPARTMENT **102 ROADRUNNER DRIVE SEDONA, ARIZONA 86336** 

Uptown Sedona Parking Facility Electrical Site Plan

THIS SHEET, ADJUST SCALES ACCORDINGLY SHEET ID e1.0

IF NOT ONE INCH ON

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VERIFY SCALES 0 BAR IS ONE INCH ON

ORIGINAL DRAWING


SHEET NO.

- OF

WB 08 February 2024 Drawn by: ES Checked by: Project Code: GLA PROJECT NO. 20109 WB

Appr.

928-204-7111

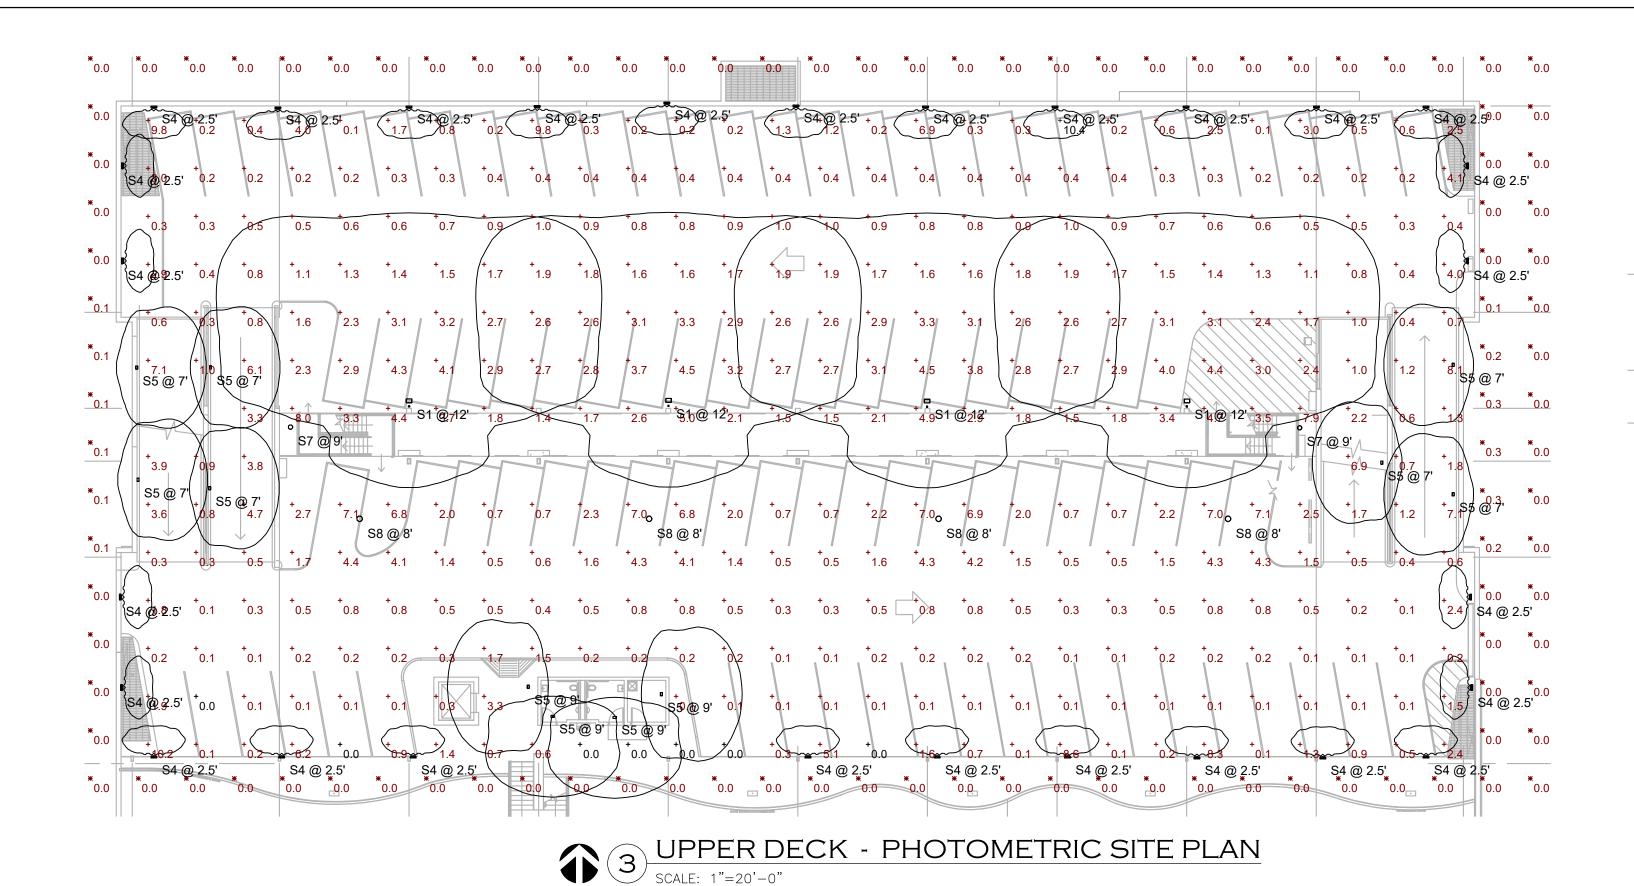


Schedule		T	I	T	I	T	I	I	
Symbol	Label	Quantity	Manufacturer	Catalog Number	Description	Lamp	Lumens Per Lamp	Light Loss Factor	Wattage
	S1	4	LITHONIA	DSX0 LED P3 27K 80CRI T4m MVOLT SPA NLTAIR2 FINISH / SSS 10'	D-SERIES SIZE 0 AREA LUMINAIRE P3 PERFORMANCE PACKAGE 3000K CCT 80 CRI TYPE 4 MEDIUM	LED - 2700K COLOR TEMP	7776	0.91	68.95
	S2	8	LITHONIA	VCPG LED P6 27K T5E MVOLT PM SPD10KV LDS36 NLTAIR2 FINISH	VCPG LED WITH P6 - PERFORMANCE PACKAGE, 2700K, T5E OPTIC TYPE	LED - 2700K COLOR TEMP	12877	0.91	107.69
	S3	59	LITHONIA	VCPG LED P6 27K T5W MVOLT PM SPD10KV LDS36 NLTAIR2 FINISH	VCPG LED WITH P6 - PERFORMANCE PACKAGE, 2700K, T5W OPTIC TYPE	LED - 2700K COLOR TEMP	12916	0.91	107.69
	S4	28	C.W.COLE	SL612W-AL-HO-15DEG-27K	3-3/4"L. X 14"W. X 4"H. LED STEPLIGHT 1 MODULE WITH 24 2700K LEDS WITH CLEAR TEMPERED GLASS LENS	LED - 2700K COLOR TEMP	300	0.91	19.54
	S5	16	LITHONIA	WDGE2 LED P1 27K 80CRI VW VOLTAGE SRM NLTAIR2 PIR FINISH	WDGE2 LED WITH P1 - PERFORMANCE PACKAGE, 2700K, 80CRI, VISUAL COMFORT WIDE OPTIC	LED - 2700K COLOR TEMP	1197	0.91	9.81
	S6	13	LITHONIA	WDGE2 LED P2 27K 80CRI VW VOLTAGE SRM NLTAIR2 PIR FINISH	WDGE2 LED WITH P2 - PERFORMANCE PACKAGE, 2700K, 80CRI, VISUAL COMFORT WIDE OPTIC	LED - 2700K COLOR TEMP	1927	0.91	14.53
	S7	10	LUMINAIRE LED	APX13 NODIM 25W 27K VOLTAGE FCL FINISH SHCAB	13" ROUND SURFACE MOUNT LUMINAIRE WITH FLAT FULL CUTOFF VANDAL RESISTANCE LENSE.	LED - 2700K COLOR TEMP	2523	0.91	25.3
	S8	4	LITHONIA	VCPG LED P2 27K T5R MVOLT PM SPD10KV LDS36 NLTAIR2 FINISH	VCPG LED WITH P2 - PERFORMANCE PACKAGE, 3000K, T5R OPTIC TYPE	LED - 2700K COLOR TEMP	4426	0.91	33.96


Statistics	atistics								
Description	Symbol	Avg	Max	Min	Max/Min	Avg/Min			
BASEMENT	+	7.8 fc	12.6 fc	1.9 fc	6.6:1	4.1:1			
GROUND FLR	+	9.3 fc	50.7 fc	2.0 fc	25.4:1	4.7:1			
GROUND FLR SITE FC AFG	X	2.2 fc	24.2 fc	0.0 fc	N/A	N/A			
TOP DECK	+	1.7 fc	10.4 fc	0.0 fc	N/A	N/A			
SPILL AT GRADE FROM UPPER DECK LIGHTS	<b>*</b>	0.0 fc	0.3 fc	0.0 fc	N/A	N/A			

### NOTICE OF EXTENDED PAYMENT PROVISION

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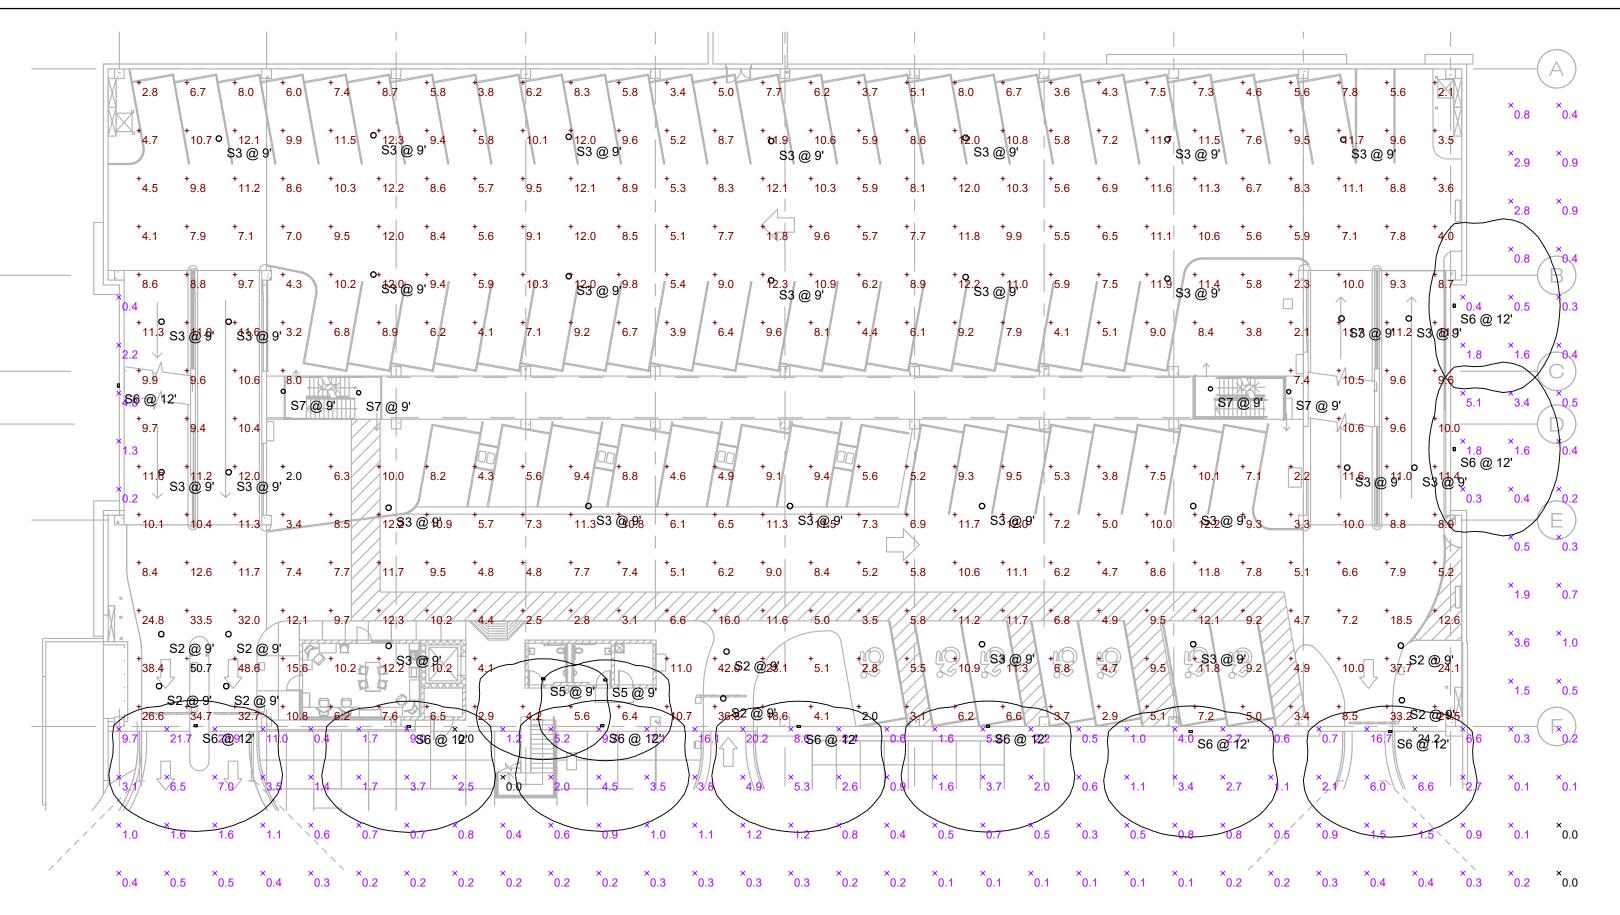
### PHOTOMETRIC NOTES

A. THE PHOTOMETRIC DATA ON THIS SHEET HAS BEEN REVIEWED BY THE ENGINEER FOR COMPLIANCE WITH APPLICABLE LIGHTING CODES. THE CALCULATIONS ARE PERFORMED BY LIGHTING SUPPLIER AND THE ENGINEER'S REVIEW IS NOT A GUARANTEE OF PERFORMANCE. SUBSTITUTIONS TO ANY FIXTURE WILL REQUIRE UPDATED PHOTOMETRICS WHICH WILL BE THE RESPONSIBILITY OF THE CONTRACTOR. THE FIXTURE SCHEDULE SHOWN ON THIS SHEET IS FOR CALCULATION PURPOSES ONLY. DO NOT USE AS A BILL-OF-MATERIAL. REFER TO THE PROJECT FIXTURE SCHEDULE.

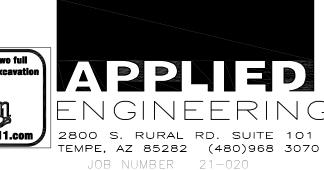
tel: 602.667.9090

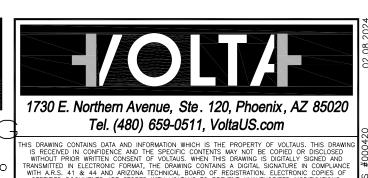fax: 602.667.9133


gaborlorant.com



# GROUND LEVEL PHOTOMETRIC SITE PLAN SCALE: 1"=20'-0"

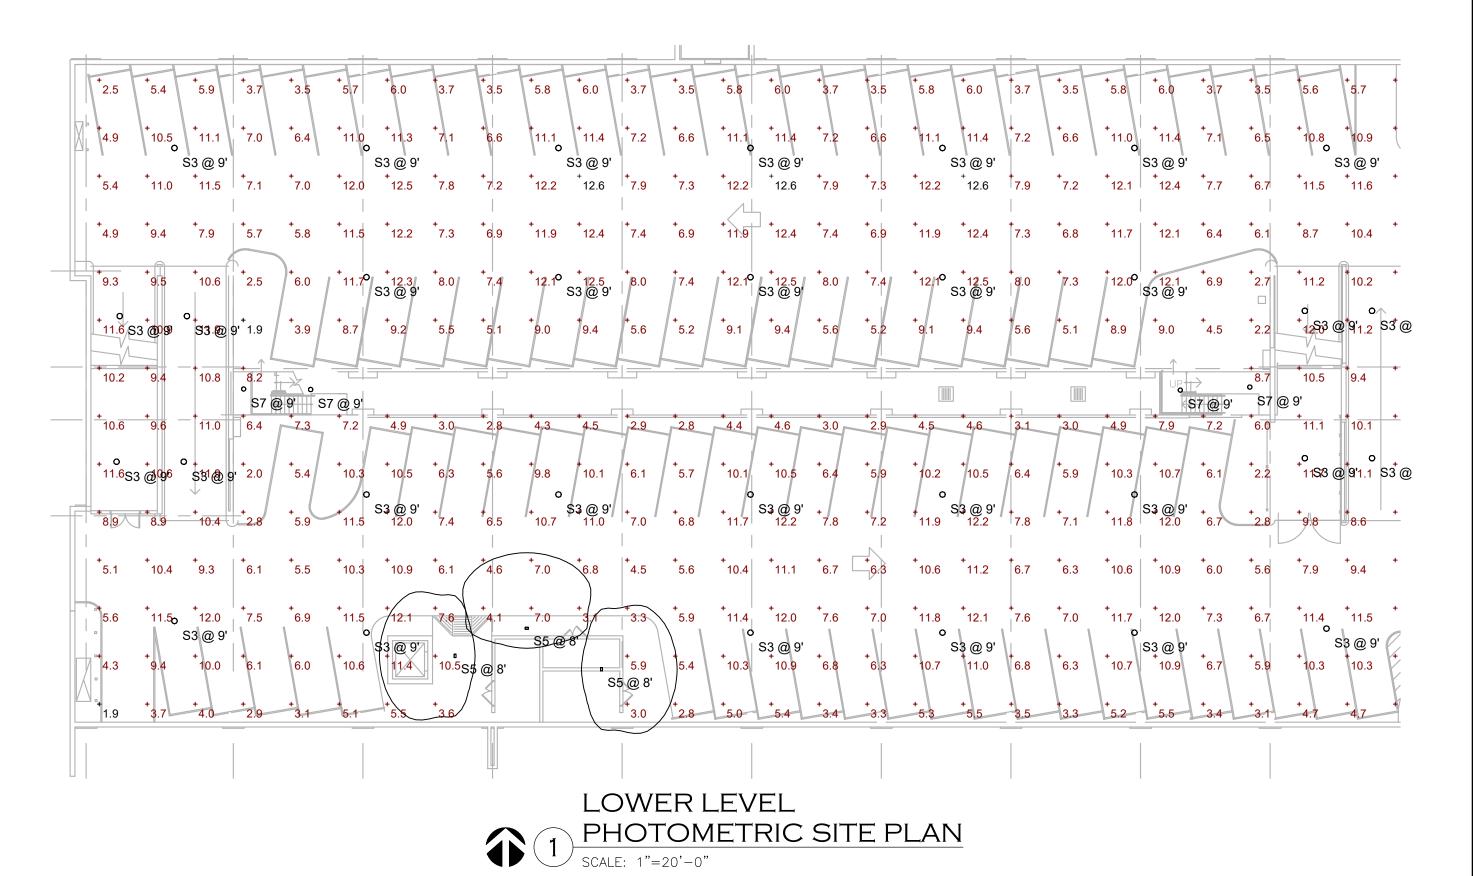

gabor lorant architects
3326 n. 3rd avenue suite 200
phoenix, arizona 85013
tal: 602 667 0000 l

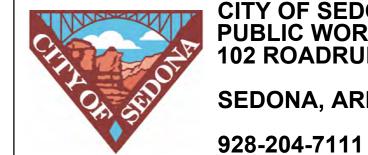

CITY OF SEDONA
PUBLIC WORKS DEPARTMENT
102 ROADRUNNER DRIVE
SEDONA, ARIZONA 86336

Uptown Sedona Parking Facility
Photometric Site Plan

THIS SHEET, ADJUST SCALES ACCORDINGLY

SHEET ID

e1.1

IF NOT ONE INCH ON

**VERIFY SCALES** 

BAR IS ONE INCH ON

ORIGINAL DRAWING

SHEET NO. - OF

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 Symbol
 Revisions
 Date
 Appr.
 Designed by: WB
 Date: WB
 08 February 2024

 Drawn by:
 ES
 ES
 Checked by: Project Code: WB
 GLA PROJECT NO. 20109

GMP PROGRESS SET NOT FOR CONSTRUCTION OR RECORDING