Project Application

fillable PDF available online at: www.sedonaaz.gov/projects



City Of Sedona Community Development Department

102 Roadrunner Drive Sedona, AZ 86336 (928) 282-1154 • www.sedonaaz.gov/cd

Application for (check all that apply):							
☐ Conceptual Review		☐ Comprehensive Review		☐ Appeal		☐ Time Extension	
☐ Community Plan Amendm		dment Development Review Conditional Use Perm			■ Subdivision t □ Variance		☐ Minor Modification
	Project Name	Bower	's Final Plat				
	Project Address	471 Forest Road		Parcel	rcel No. (APN) 401-38-		-012
Project Information	Primary Contact	Sefton Engineering		Primar	y Phone	928-20	2-3999
	Email	dn@sefengco.com		Alt. Phone			
	Address	40 Stutz Bearcat Dr		City/State/ZIP 86		86336	
Office Use Only	Application No			Date Received			
	Received by			Fee Paid			
Project Description							

Additional Contact Information: Please complete the following for all companies/people <u>authorized</u> to discuss the project with the City. Please attach additional sheets if necessary.

Contact #1	Company	Sefton Engineering	Contact Name	David Nicolella
	Project Role	Authorized Agent	Primary Phone	928-202-3999
	Email	dn@sefengco.com	Alt. Phone	
	Address	40 Stutz Bearcat Dr	City/State/ZIP	86336
Contact #2	Company		Contact Name	
	Project Role		Primary Phone	
	Email		Alt. Phone	
	Address		City/State/ZIP	
Contact #3	Company		Contact Name	
	Project Role		Primary Phone	
	Email		Alt. Phone	
	Address		City/State/ZIP	

Exhibit A: Conditions of Approval

PZ21-00020 (SUB) Bowers Subdivision



As recommended for approval by Planning and Zoning Commission, March 19, 2024

As approved by City Council, April 23, 2024

- 1. Development of the subject property shall be in substantial conformance with the applicant's representations of the project, including the Preliminary Plat dated January 4, 2024, letter of intent dated January 4, 2024, and all other supporting documents, as reviewed, modified and approved by the Planning and Zoning Commission and City Council.
- 2. Preliminary Plat approval shall expire 24 months from the date approved by the City Council, subject to the following:
 - i) It shall be the responsibility of the applicant to monitor elapsed time. (LDC Section 8.5.A(3)h.3)
- 3. Prior to City Council consideration of the Final Plat, the applicant shall satisfy the following conditions:
 - i) The Final Plat shall meet all requirements of Land Development Code (LDC) and the Design Review, Engineering, and Administrative Manual (Manual).
 - ii) Sewer line easements for all existing and new sewer lines shall be shown on the Final Plat.
 - iii) Drainage easements shall be provided to the satisfaction of the City Engineer and shall meet the minimum dimensions of the LDC and Manual.
 - iv) Provide the appropriate dedication language on the Plat. The dedication language shall be capitalized.
 - v) The Final Plat shall designate the location of any proposed subdivision sign and/or cluster mailbox, if proposed.
 - vi) The applicant shall submit a Final Grading and Drainage Report for review and approval by the City Engineer.
 - vii) Provide a Sewer Design Report.
 - viii) All requirements from the Sedona Fire District shall be met.
- 4. Prior to recording the Final Plat, the following shall be filed with the City Clerk (LDC Section 8.5.B(3)d.2):
 - i) The letter of agreement with serving utilities; and
 - ii) Financial assurance, cash, or letter of credit in an amount specified by the City Engineer and in a form acceptable to the City Attorney pursuant to LDC Section 8.5.B(3)d.3.
- 5. Prior to issuance of a grading or building permit, the following documents and details shall be provided to the City for review and approval:
 - i) Assurance bonds are required for all subdivision construction projects.
 - ii) Provide Final Grading and Drainage Plans. The Site Plan shall meet the requirements of Manual Chapter 3.1.
 - iii) Provide the Final Drainage Report.

- 6. Upon completion of the infrastructure for the project and prior to release of the required financial assurances, staff shall verify that all construction is in substantial accordance with the plans as submitted, reviewed, and approved by the Planning and Zoning Commission and the City Council, and the following conditions have been met:
 - i) All on-site improvements shall substantially conform to the plans on which the grading permit was issued.
 - ii) All new and existing utility lines shall be provided through underground installation.
 - iii) All requirements of the Sedona Fire District shall have been satisfied.
- 7. Within thirty days of approval of the Preliminary Plat, the property owner of record of the subject property voluntarily agrees to sign and record a waiver acknowledging their waiver of any right to claim just compensation for diminution in value under A.R.S. §12-1134 related to the granting of this Preliminary Plat approval.

Exhibit B: Legal Description

LEGAL DESCRIPTION

PARCEL NO. 1:

That part of the Northwest quarter of the Southeast quarter of Section 7, Township 17 North, Range 6 East, Gila and Salt River Base and Meridian, Coconino County, Arizona, described as follows:

BEGINNING at a point on the East line of the Northwest quarter of the Southeast quarter of said Section 7 bearing South 1°02'31" East a distance of 300.00 feet from the Northeast corner of the Northwest quarter of the Southeast quarter of said Section 7;

THENCE South 1°02'31" East, along the East line of the Northwest quarter of the Southeast quarter of said Section 7, a distance of 353.32 feet:

THENCE South 89°21'19" West, a distance of 328.17 feet:

THENCE North 1°02'31" West, a distance of 352.86 feet;

THENCE North 89°16'33" East, a distance of 328.18 feet to the POINT OF BEGINNING.

PARCEL NO. 2: DOES NOT REACH SUBJECT PROPERTY.

An easement for roadway and utilities, as created by instrument recorded in Docket 709, page 295, records of Coconino County, Arizona, over that part of the Northeast quarter of the Southeast quarter of Section 7, Township 17 North, Range 6 East, Gila and Salt River Base and Meridian, Coconino County, Arizona, described as follows:

The North 20 feet of the Northwest quarter of the Northeast quarter of the Southeast quarter of Section 7, Township 17 North, Range 6 East, Gila and Salt River Base and Meridian, Coconino County, Arizona;

EXCEPT the East 500 feet thereof.

PARCEL NO. 3: DOES NOT REACH SUBJECT PROPERTY.

An easement for ingress, egress and public utilities, as created by instrument recorded in Docket 1506, page 116, records of Coconino County, Arizona, over that part of the Northeast quarter of the Southeast quarter of Section 7, Township 17 North, Range 6 East, Gila and Salt River Base and Meridian, Coconino County, Arizona, described as follows: A strip of ground lying 8 feet East of and coincident with the following line:

BEGINNING at the Northwest corner of the Northeast quarter of the Southeast quarter of said Section 7;

THENCE South 01°02'31" East (Basis of Bearings is a deed recorded in 753, records of Coconino County, Arizona), a distance of 300.00 feet to the Northeast corner of a parcel as described in deed recorded in Docket 753, page 744-746, records of Coconino County, Arizona and the terminus of this line.

PARCEL NO. 4:

An easement for road and utility purposes, as reserved in instrument recorded in Docket 709, page 308, records of Coconino County, Arizona, over that part of the Northwest quarter of the Southeast quarter of Section 7, Township 17 North, Range 6 East, Gila and Salt River Base and Meridian, Coconino County, Arizona, described as follows: The East 25 feet of the North 300 feet of the following described property;

BEGINNING at the Southeast corner of the Northeast quarter of the Northwest quarter of the Southeast quarter of said Section 7;

THENCE along the South line of said Northeast quarter of the Northwest quarter of the Southeast quarter and the East half of the Northwest quarter of the Northwest quarter of the Southeast quarter, South 89°21'19" West a distance of 669.81 feet to the Northerly right-of-way line, 200 feet wide, of State Highway 89A;

THENCE along said right-of-way line, North 70°57'51" West (Highway bearing North 70°50'00" West), a distance of 317.85 feet to the West line of the East half of the Northwest quarter of the Northwest quarter of the Southeast quarter;

THENCE along said West line, North 0°49'37" West, a distance of 544.92 feet to the Southwest corner of Manzanita Hills Unit II:

THENCE along the South line of the said Manzanita Hills Units I and II, North 89°16'33" East, a distance of 966.30 feet to the Northeast corner of the Northeast quarter of the Southeast quarter;

THENCE along the East line of the Northeast quarter of the Northwest quarter of the Southeast quarter, South 1°02'31" East, a distance of 653.32 feet to the POINT OF BEGINNING;

EXCEPT that part of said easement which was abandoned by instrument recorded in Docket 1506, page 110, records of Coconino County, Arizona

When recorded, mail to:

City Cierk
City of Sedona
102 Roadrunner Road
Sedona, Arizona 86326

DEVELOPMENT AGREEMENT between the City of Sedona and 741 Forest Road, LLC

"Party" or collectively as the "Parties." Landowner are the only Parties to this Agreement, and may be referred to herein individually as a September, 2022, by and between the City of Sedona, an Arizona municipal corporation ("City"), and 741 Forest Road, LLC, an Arizona limited liability company ("Landowner"). The City and THIS DEVELOPMENT AGREEMENT ("Agreement") is entered into this 30th day of

RECITALS

- and provide other benefits to the City and its residents. "Project") in order to address traffic congestion, install utility improvements, address safety needs, The City is extending Forest Road from its current terminus to Highway 89A (the
- impose significant added wear and tear on the City streets. transportation of excavation material will have a major impact on traffic congestion and control, and and disposal offsite of excess excavation material, if necessary. The City also anticipates that which is required to support the roadway, and the City anticipates high costs related to transportation The Project is expected to generate a large amount of excavation material, some of
- as part of the Forest Road Extension Project ("Roadway") will traverse the Property and as a result of the City's taking, will divide the Remaining Property into two segments. which is more specifically described in Exhibit "A" (the "Property"). The roadway being installed Landowner is the owner of real property located at 741 Forest Road, Sedona, Arizona,
- consequences such as traffic, wear-and-tear, and the need to find a storage location(s) for the reduce the City's costs related to transportation and disposal, and mitigate other anticipated estimated amount of 20,000 cubic yards, would enhance the Roadway stability and visual impacts, of the Remaining Property to support the Roadway. Such placement of backfill material, in the excavation materials. The City desires to place materials from the Project as backfill on the lower segment
- E. Landowner does not oppose construction of the Project, which will increase the accessibility to the proposed Roadway in the lower segment of the Remaining Property. Landowner Remaining Property subject to and in accordance with the approved grading plan, which may assist in desires to accept placement of backfill materials from the Project on the lower segment of the the reduction of any adverse impact and improve accessibility to the Roadway.

SHEET INDEX

- 1 FINAL PLAT COVER SHEET
- 2 FINAL PLAT 3 LOT AREA

BOWERS FINAL PLAT

A SUBDIVISION OF PARCEL LOCATED WITHIN THE NW1/4 of the SE1/4 of OF SECTION 7, TOWNSHIP 17 NORTH, RANGE 6 EAST OF THE GILA AND SALT RIVER BASE AND MERIDIAN, WITHIN THE CITY OF SEDONA, COCONINO COUNTY, ARIZONA ORIGINAL ASSESSORS PARCEL NUMBER 401-38-012 CONTAINING ±2.68 ACRES ZONED SINGLE FAMILY RESIDENTIAL (RS-18)

DECLARATION AND DEDICATION

KNOW ALL MEN BY THESE PRESENTS:

741 FOREST ROAD, LLC, A LIMITED LIABILITY CORPORATION ("TRUSTEE"), HAS SUBDIVIDED UNDER THE NAME OF "BOWERS SUBDIVISION", A PORTION OF THENWY of the SEY of OF SECTION 7, TOWNSHIP 17 NORTH,RANGE 6 EAST OF THE GILA AND SALT RIVER BASE AND MERIDIAN, WITHIN THE CITY OF SEDONA, COCONINO COUNTY, ARIZONA, AS SHOWN PLATTED HEREON AND HEREBY PUBLISHES THIS PLAT AS AND FOR THE PLAT OF SAID "BOWERS SUBDIVISION" ("THE PLAT") "TRUSTEE" HEREBY DECLARES THAT "THE PLAT" SETS FORTH THE LOCATION AND GIVES THE DIMENSIONS OF THE LOTS, TRACTS, STREETS, AND EASEMENTS, AND THAT EACH SHALL BE KNOWN BY THE NUMBER, LETTER, OR NAME GIVEN HEREON.

"TRUSTEE" HEREBY DECLARES THAT THE EASEMENTS SHOWN UPON THIS PLAT SHALL BE ESTABLISHED AND RESERVED IN ACCORDANCE WITH THE NOTATION ON SAID PLAT AND SHAL PROVIDE TO THE PUBLIC THE USE THEREOF FOREVER FOR INGRESS, EGRESS PURPOSES AND FOR INSTALLATION, OPERATION, AND MAINTENANCE OF PUBLIC UTILITY LINES AND FACILITIES, INCLUDING WITHOUT LIMITATION, WATER, SANITARY SEWER, ELECTRIC, NATURAL GAS, TELEPHONE. CABLE SERVICES, WATERCOURSES AND/OR DRAINAGE FACILITIES.

LICENSE TO ACCESS UPON THE ESTABLISHED EASEMENTS AS DESCRIBED HEREON, FOR THE PURPOSE OF PERIODIC INSPECTION AND MAINTENANCE OF THE WATERCOURSES AND/OR DRAINAGE FACILITIES. THE MAINTENANCE OF THE DRAINAGE EASEMENTS AND FACILITIES SHALL BE THE RESPONSIBILITY OF THE INDIVIDUAL LOT OWNERS WITHIN THE SUBDIVISION.

IN WITNESS WHEREOF:

"TRUSTEE" HAS CAUSED THIS PLAT TO BE DULY EXECUTED AS OF THIS _____ DAY OF _____, 2024.

TRUST OFFICER


STATE OF ARIZONA

COUNTY OF COCONINO)

SUBSCRIBED AND SWORN BEFORE ME ON THIS _____ DAY OF _____, 2024

. MY COMMISSION EXPIRES

NOTARY PUBLIC

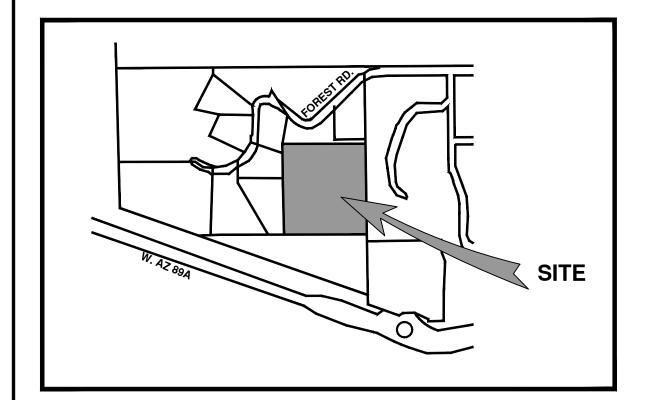

VICINITY MAP NOT TO SCALE

UTILITY COMPANIES

ARIZONA PUBLIC SERVICE COMPANY P.O. BOX 53920, STE. 9996

PHOENIX, ARIZONA 85072-3920

ARIZONA WATER COMPANY 3805 N. BLACK CANYON HIGHWAY

PHOENIX, AZ 8505-5351 SEWER: CITY OF SEDONA

PUBLIC WORKS DEPARTMENT 102 ROADRUNNER DRIVE SEDONA, AZ 86336

CABLE/PHONE: CENTURYLINK CENTURYLINK ENGINEERING 500 S. CALVARY WAY

> OPTIMUM INTERNET SERVICE. 2370 W SR 89A SEDONA

GAS: UNISOURCE ENERGY SERVICES UNS GAS, INC. P.O. BOX 80078

COTTONWOOD, AZ 86326

PRESCOTT, AZ 86304-8078

SOLID WASTE COLLECTION: PATRIOT DISPOSAL COLLECTION: 211 SMITH ROAD SEDONA, AZ 86336

DEVELOPER CONTACT INFORMATION

741 FOREST ROAD, LLC PO Box 3068, Sedona, AZ - 86336

PARCEL ZONING RS-18 SINGLE FAMILY RESIDENCE MIN LOT SIZE = 18,000 SQ. FT.

LOTS 1 - 4 SMALLEST LOT = 19,245 S.F. (0.44 AC) LARGEST LOT = 30,084 S.F. (0.69 AC)AVERAGE LOT SIZE = 24,664.5 S.F. (0.57 AC)

APN: 401-38-011A

PARCEL A: (LOT 1 & LOT 2)

LEGAL DESCRIPTION

BEGINNING AT A POINT ON THE EAST LINE OF THE NORTHWEST QUARTER OF THE SOUTHEAST QUARTER OF SAID SECTION 7, BEARING SOUTH 01° 02' 31" EAST, A DISTANCE OF 300.00 FEET FROM THE NORTHEAST CORNER OF THE NORTHWEST QUARTER OF THE SOUTHEAST QUARTER OF SAID SECTION 7 TO THE POINT BEGINNING

APN: 401-38-001J

THENCE SOUTH 1 DEGREES, 14 MINUTES, 53.45 SECONDS EAST, A DISTANCE OF 224.86 FEET;

APN: 401-38-003Q

APN: 401-38-011F

THENCE SOUTH 89 DEGREES, 59 MINUTES, 59.93 SECONDS WEST, A DISTANCE OF 17.11 FEET; THENCE NORTHWESTERLY THROUGH A CONCAVE CURVE WITH A LENGTH OF 125.71 FEET, A RADIUS OF 123.50 FEET, A DELTA OF 58 DEGREES, 19 MINUTES, 08 SECONDS;

THENCE SOUTH 74 DEGREES, 50 MINUTES, 06.85 SECONDS EAST, A DISTANCE OF 58.94 FEET; THENCE SOUTH 74 DEGREES, 50 MINUTES, 06.85 SECONDS WEST, A DISTANCE OF 63.60 FEET;

THENCE NORTHWESTERLY THROUGH A CONVEX CURVE WITH A LENGTH OF 137.54 FEET, A RADIUS OF 96.50 FEET, A DELTA OF 81 DEGREES, 39 MINUTES, 56 SECONDS; THENCE NORTH 89 DEGREES, 26 MINUTES, 39.76 SECONDS EAST, A DISTANCE OF 214.09 FEET;

THENCE NORTH 89 DEGREES, 26 MINUTES, 39.76 SECONDS EAST, A DISTANCE OF 77.58 FEET TO THE POINT OF BEGINNING.

BEGINNING AT A POINT ON THE EAST LINE OF THE NORTHWEST QUARTER OF THE SOUTHEAST QUARTER OF SAID SECTION 7, BEARING SOUTH 01° 02' 31" EAST, A DISTANCE OF 300.00 FEET FROM THE NORTHEAST CORNER OF THE NORTHWEST QUARTER OF THE SOUTHEAST QUARTER OF SAID SECTION 7

THENCE NORTH 89 DEGREES, 26 MINUTES, 39.76 SECONDS WEST, A DISTANCE OF 77.58 FEET;

THENCE NORTH 89 DEGREES, 26 MINUTES, 39.76 SECONDS WEST, A DISTANCE OF 214.09 FEET; THENCE SOUTH 03 DEGREES, 37 MINUTES, 02.29 SECONDS EAST, A DISTANCE OF 106.35 FEET;

THENCE SOUTHEASTERLY THROUGH A CONCAVE CURVE WITH A LENGTH OF 63.77 FEET, A RADIUS OF 130 FEET, A DELTA OF 28 DEGREES, 06 MINUTES, 16 SECONDS;

THENCE SOUTH 74 DEGREES, 50 MINUTES, 06.58 SECONDS EAST, A DISTANCE OF 76.71 FEET; THENCE SOUTH 74 DEGREES, 50 MINUTES, 06.58 SECONDS EAST, A DISTANCE OF 50.50 FEET

THENCE SOUTHEASTERLY THROUGH A SEMICIRCULAR CURVE WITH A LENGTH OF 258.30 FEET, A RADIUS OF 90 FEET, A DELTA OF 164 DEGREES, 26 MINUTES, 30 SECONDS;

THENCE SOUTH 89 DEGREES, 43 MINUTES, 32.79 SECONDS WEST, A DISTANCE OF 94.42 FEET; THENCE SOUTH 89 DEGREES, 43 MINUTES, 32.22 SECONDS WEST, A DISTANCE OF 100.36 FEET

THENCE NORTH 50 DEGREES, 23 MINUTES, 23.11 SECONDS WEST, A DISTANCE OF 241.98 FEET; THENCE NORTH 89 DEGREES, 54 MINUTES, 56.85 SECONDS EAST, A DISTANCE OF 43.37 FEET;

THENCE NORTH 03 DEGREES, 37 MINUTES, 02.29 SECONDS EAST, A DISTANCE OF 106.35 FEET THENCE NORTH 89 DEGREES, 26 MINUTES, 39.76 SECONDS EAST, A DISTANCE OF 214.09 FEET;

THENCE NORTH 89 DEGREES, 26 MINUTES, 39.76 SECONDS EAST, A DISTANCE OF 77.58 FEET TO THE POINT OF BEGINNING.

CERTIFICATE OF APPROVALS

SEDONA PUBLIC WORKS DEPARTMENT

SEDONA COMMUNITY DEVELOPMENT DEPARTMENT

DATE SEDONA FIRE DISTRICT

FIRE MARSHAL DATE

CITY ENGINEER SEDONA CITY COUNCIL

MAYOR OF SEDONA

PLAT NOTES

CITY CLERK

- NO STRUCTURE OF ANY KIND SHALL BE CONSTRUCTED OR PLACED WITHIN OR OVER ANY UTILITY EASEMENT EXCEPT WOOD, WIRE OR REMOVABLE SECTION TYPE FENCING, OR SUITABLE LANDSCAPING THAT DOES NOT INTERFERE WITH
- OVER THE DRAINAGE EASEMENT EXCEPT STONE, GRAVEL, PAVEMENT, HORIZONTAL IMPROVEMENTS OR OTHER DRAINAGE CHANNEL MATERIALS OR SUITABLE LANDSCAPING THAT DOES NOT INTERFERE WITH THE INTENDED
- FRONT PROPERTY LINES FOR LOTS 1 & 2 ARE THE BACK OF THE CURB AND
- 4. ALL FRONT BUILDING SETBACKS SHALL BE MEASURED FROM THE RIGHT OF
- LOT CORNERS WITHIN THE SUBDIVISION SHALL BE SET WITHIN 90 DAYS OF THI APPROVAL AND RECORDATION OF THE FINAL PLAT AND WILL BE MONUMENTED IN ACCORDANCE WITH THE ARIZONA BOUNDARY SURVEY MINIMUM STANDARDS BY THE REGISTERED LAND SURVEYOR OF RECORD. THE MONUMENTS SHALL B 1/2" REBARS SET WITH PLASTIC CAPS INSCRIBED WITH "LS----" AT EACH NÉW LOT CORNER OR MISSING CORNER. ADDITIONALLY, LOT CORNERS LOCATED IN THE ROADWAY ASPHALT SHALL BE SET WITH 3" ALUMINUM CAPS INSCRIBED WITH "CITY OF SEDONA - LS----"
- 6. THE FOUND MONUMENTS SHOWN HEREON ARE FROM THE NOTES OF THE ACTUAL FIELD SURVEY CONDUCTED BY _____ RLS #___ ON
- 7. ALL RECORDED EASEMENTS ARE SHOWN AS PART OF THESE DOCUMENTS
- THE WORD "CERTIFICATION", AS SHOWN HEREON, MEANS AN EXPRESSION OF PROFESSIONAL OPINION REGARDING THE FACTS DEPICTED ON THIS PLAT AND DOES NOT CONSTITUTE A WARRANT OR GUARANTEE, EITHER EXPRESSED OR
- THE LAND BEING SUBDIVIDED HEREON IN NOT WITHIN A SPECIAL FLOOD HAZARD AREA.

BASIS OF BEARINGS


THE BASIS OF BEARINGS FOR THIS PLAT IS SOUTH 89 DEGREES, 10 MINUTES, 00 SECONDS, EAST (PER B.L.M. PLAT) ALONG THE NORTH LINE OF THE NORTHWEST QUARTER OF SECTION 30, TOWNSHIP 17 NORTH, RANGE 6 EAST G.&S.R.M., COCONINO COUNTY, ARIZONA.

LAND SURVEYOR CERTIFICATION

THIS FINAL PLAT AND SURVEY ON WHICH IT IS BASED WHERE CONDUCTED UNDER MY DIRECT SUPERVISION AND IS TRUE AND ACCURATE TO THE BEST OF MY KNOWLEDGE AND BELIEF. THIS MAP IS PUBLISHED SUBJECT TO ALL CONDITIONS, RESERVATIONS AND RESTRICTIONS OF THE PUBLIC RECORD ON THIS

TIM HAMMES



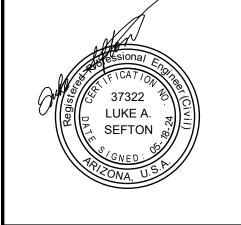


DRAWN BY: SCALE: NTS DATE:

ROJECT NO: 220219

HEET NO.



05/18/2024

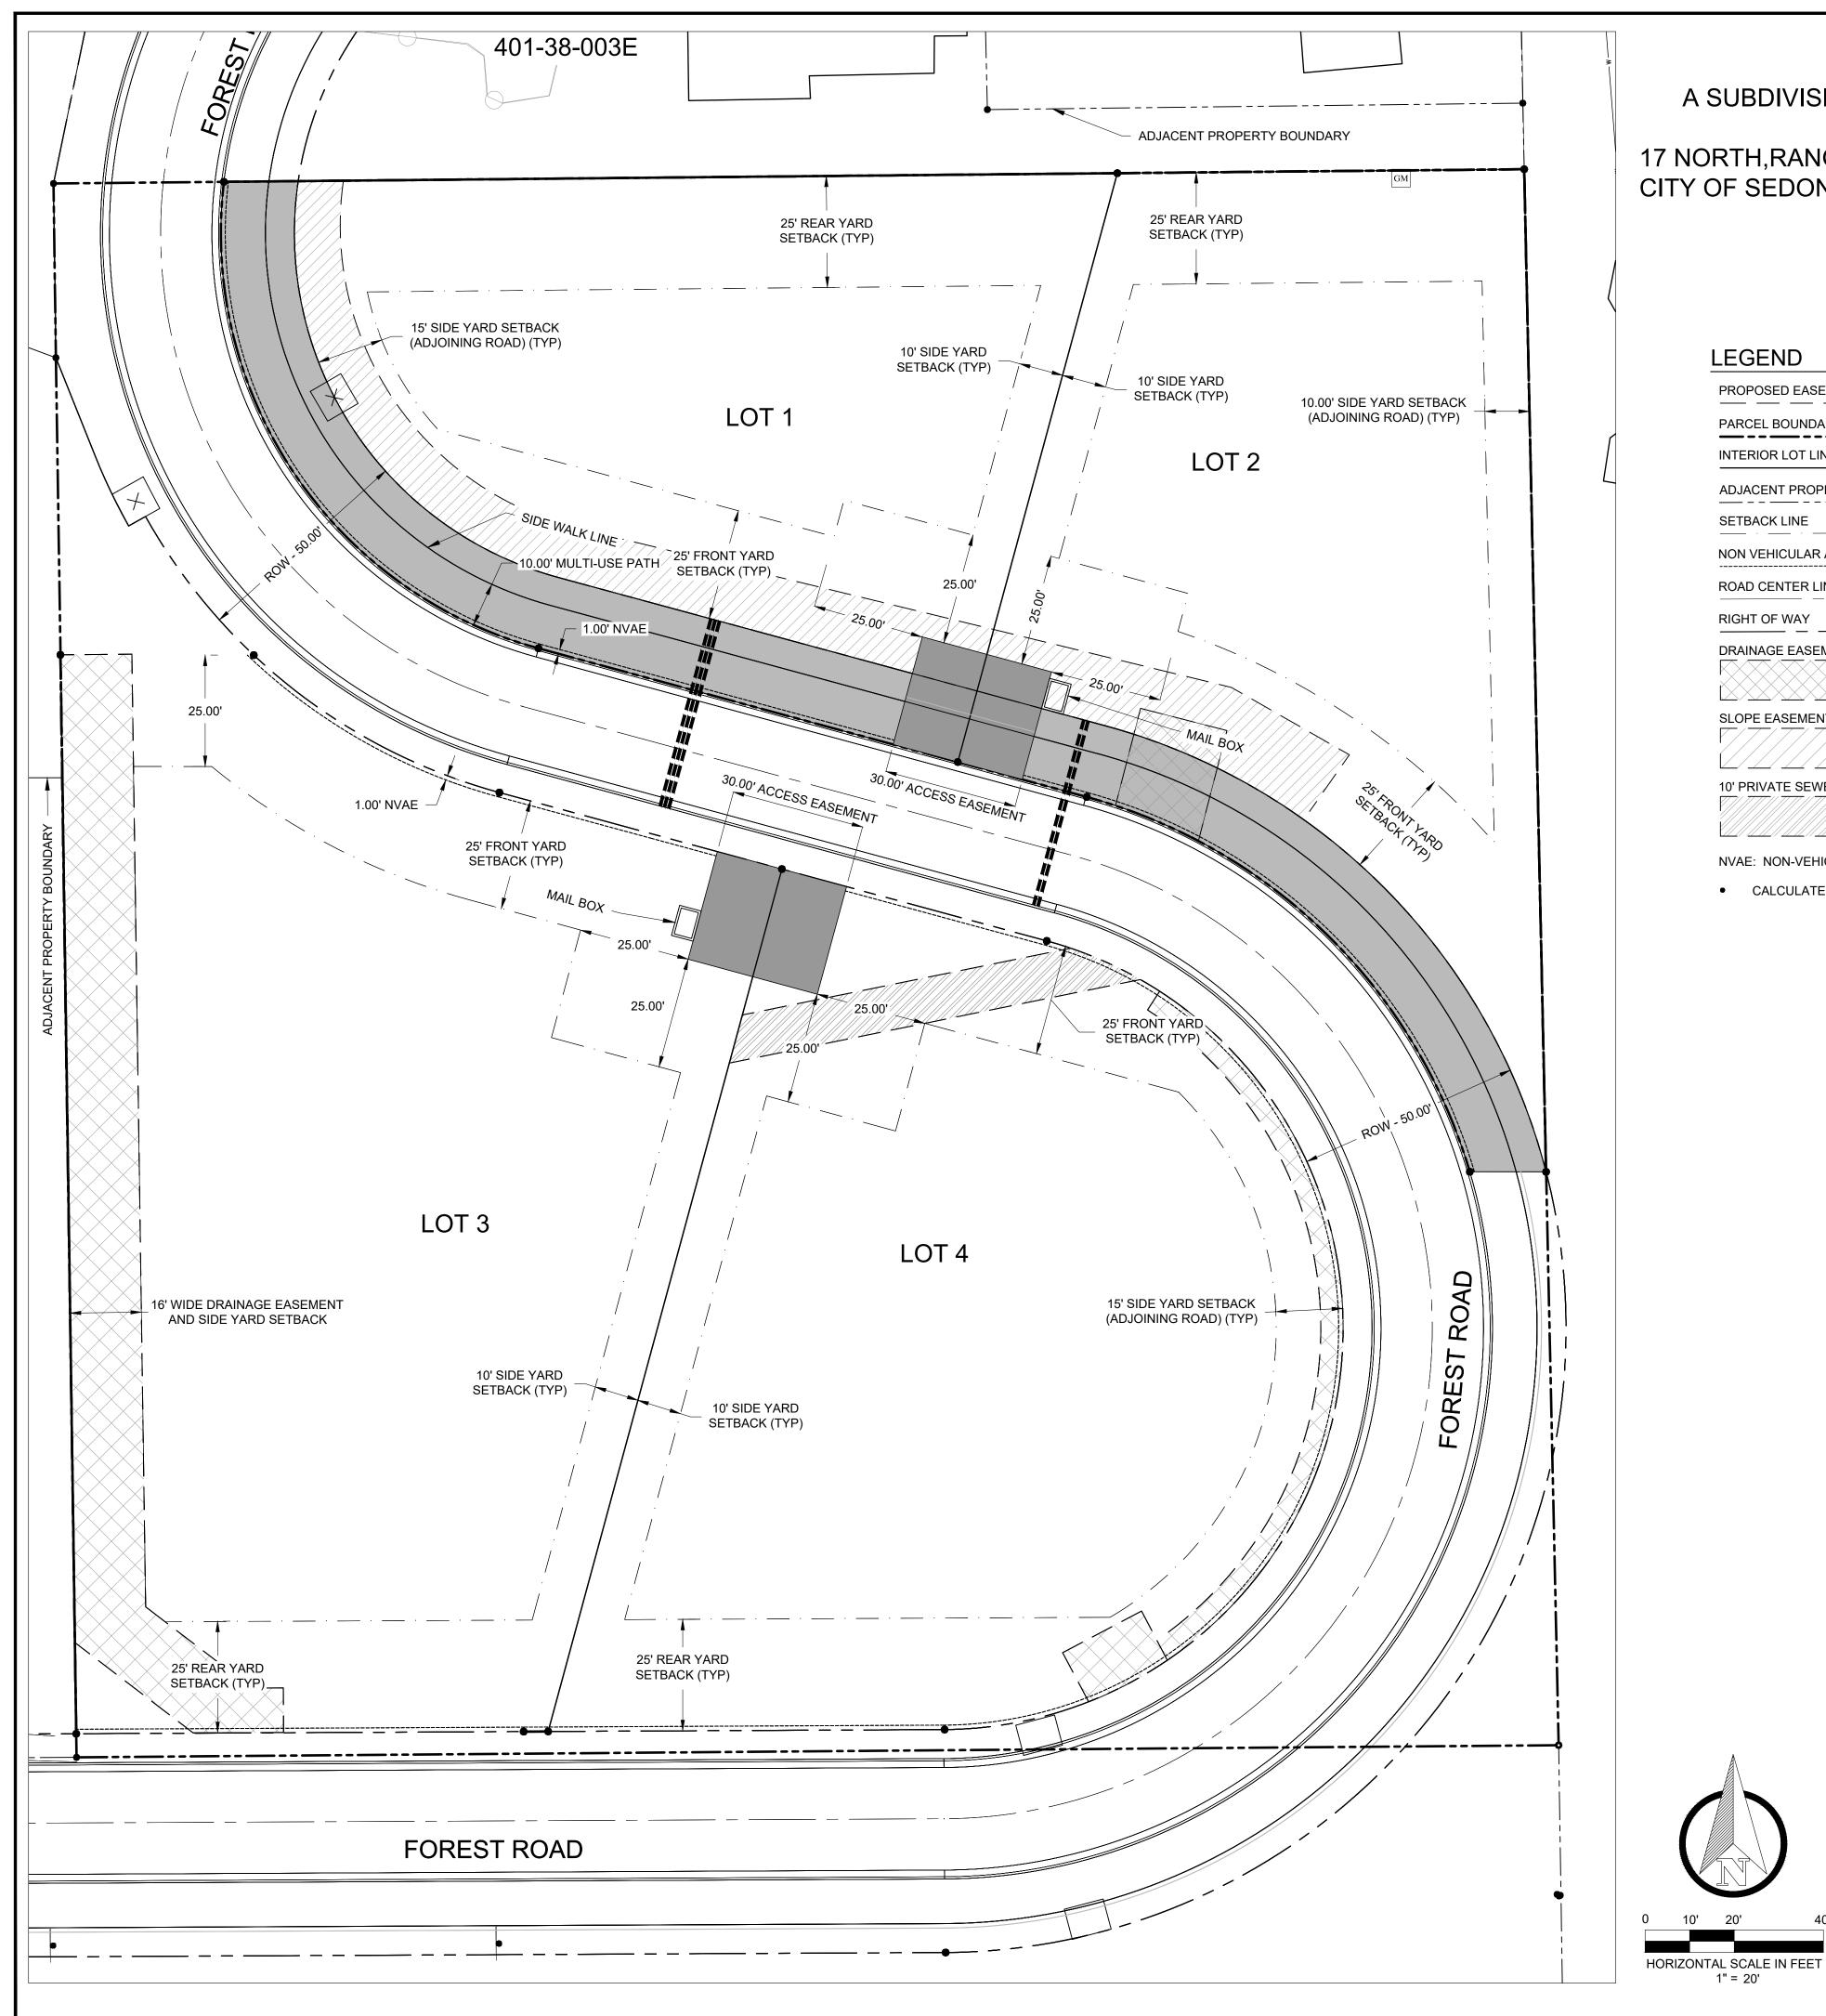


BOWERS SUBDIVISION

A SUBDIVISION OF PARCEL LOCATED WITHIN THE NW1/4 of the SE1/4 of OF SECTION 7, TOWNSHIP

17 NORTH, RANGE 6 EAST OF THE GILA AND SALT RIVER BASE AND MERIDIAN, WITHIN THE CITY OF SEDONA, COCONINO COUNTY, ARIZONA ORIGINAL ASSESSORS PARCEL NUMBER 401-38-012 CONTAINING ±2.68 ACRES

ZONED SINGLE FAMILY RESIDENTIAL (RS-18)

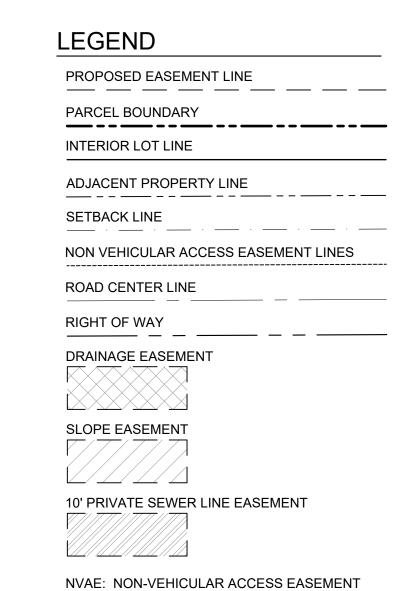


CALCULATED POINT ON EASEMENT





DRAWN BY: SCALE: 1" = 20' 05/18/2024 PROJECT NO: SHEET NO.

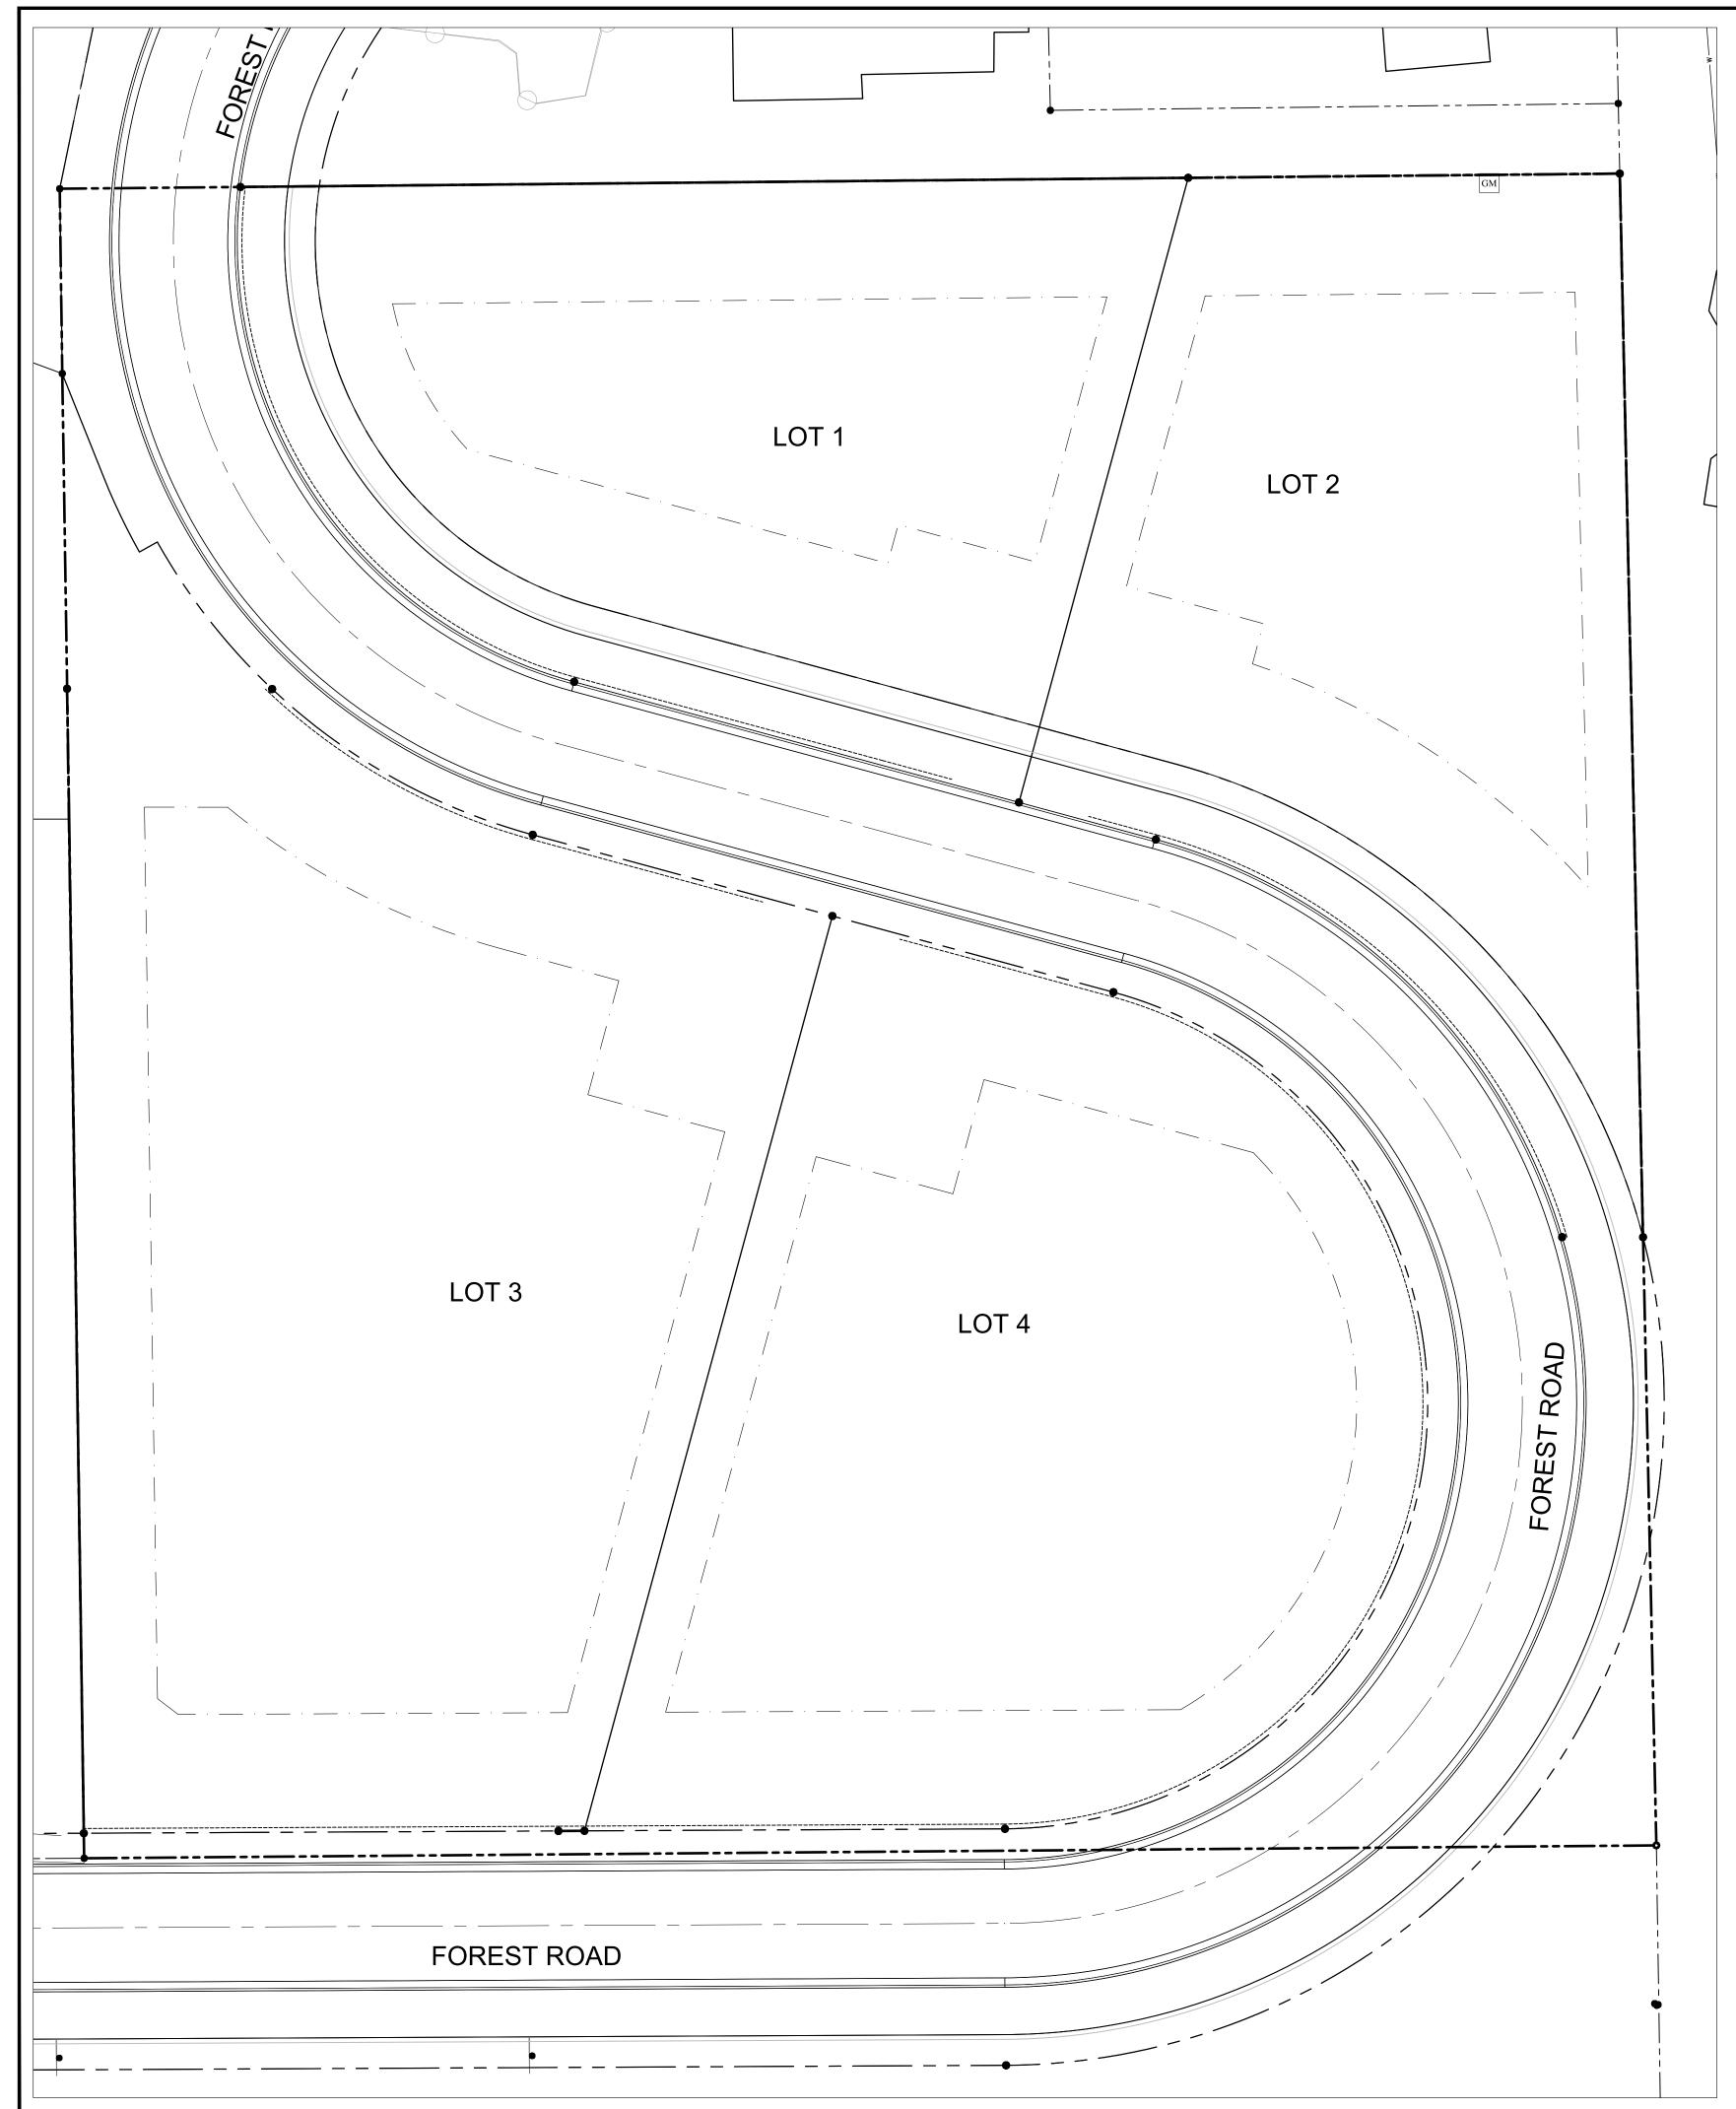

BOWERS SUBDIVISION

A SUBDIVISION OF PARCEL LOCATED WITHIN THE NW1/4 of the SE1/4 of OF SECTION 7, TOWNSHIP

17 NORTH, RANGE 6 EAST OF THE GILA AND SALT RIVER BASE AND MERIDIAN, WITHIN THE CITY OF SEDONA, COCONINO COUNTY, ARIZONA ORIGINAL ASSESSORS PARCEL NUMBER 401-38-012 CONTAINING ±2.68 ACRES

ZONED SINGLE FAMILY RESIDENTIAL (RS-18)

LOT AREAS							
LOT GROSS		EXCLUDING NVAE	BUILDING ENVELOPE				
1	19245.47	19011.14	6198.15				
2	19256.60	19100.47	7949.13				
3	30084.24	29848.05	17789.34				
4	24563.35	24156.14	14602.77				



PROPOSED EASEMENT LINE INTERIOR LOT LINE ADJACENT PROPERTY LINE NON VEHICULAR ACCESS EASEMENT LINES RIGHT OF WAY

CALCULATED POINT ON EASEMENT






1" = 20' 05/18/2024

PROJECT NO:

SHEET NO.

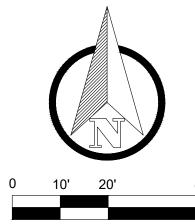

SHEET INDEX

V-1 BOWERS UTILITY CONNECTIONS V-2 SEWER HOOK UP LOCATIONS V-3 WATER HOOK UP LOCATIONS V-4 GAS HOOK UP LOCATIONS V-5 APS HOOK UP LOCATIONS V-6 COMMUNICATION HOOK UP LOCATIONS

BOWERS UTILITIES

A SUBDIVISION OF PARCEL LOCATED WITHIN THE NW1/4 of the SE1/4 of OF SECTION 7, TOWNSHIP 17 NORTH, RANGE 6 EAST OF THE GILA AND SALT RIVER BASE AND MERIDIAN, WITHIN THE CITY OF SEDONA, COCONINO COUNTY, ARIZONA ORIGINAL ASSESSORS PARCEL NUMBER 401-38-012 CONTAINING ±2.68 ACRES ZONED SINGLE FAMILY RESIDENTIAL (RS-18)

SEDONA, AZ 86336 CABLE/PHONE: CENTURYLINK

UTILITY COMPANIES

CENTURYLINK ENGINEERING 500 S. CALVARY WAY COTTONWOOD, AZ 86326

ARIZONA PUBLIC SERVICE COMPANY

PHOENIX, ARIZONA 85072-3920

3805 N. BLACK CANYON HIGHWAY

P.O. BOX 53920, STE. 9996

ARIZONA WATER COMPANY

PUBLIC WORKS DEPARTMENT

PHOENIX, AZ 8505-5351

102 ROADRUNNER DRIVE


OPTIMUM INTERNET SERVICE. 2370 W SR 89A SEDONA


UNISOURCE ENERGY SERVICES UNS GAS, INC.

P.O. BOX 80078 PRESCOTT, AZ 86304-8078


SOLID WASTE COLLECTION: PATRIOT DISPOSAL 211 SMITH ROAD

SEDONA, AZ 86336

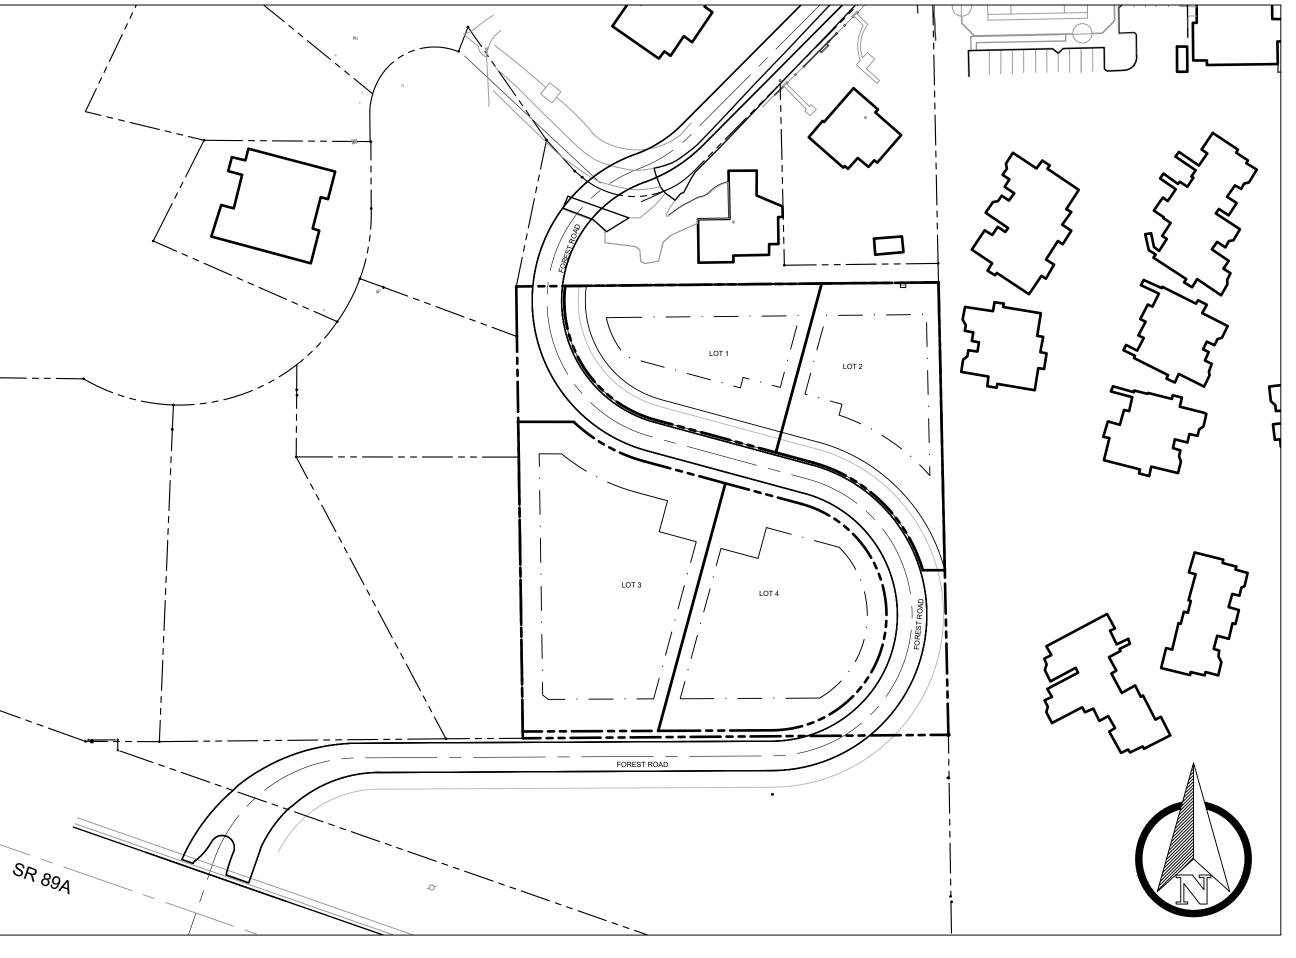

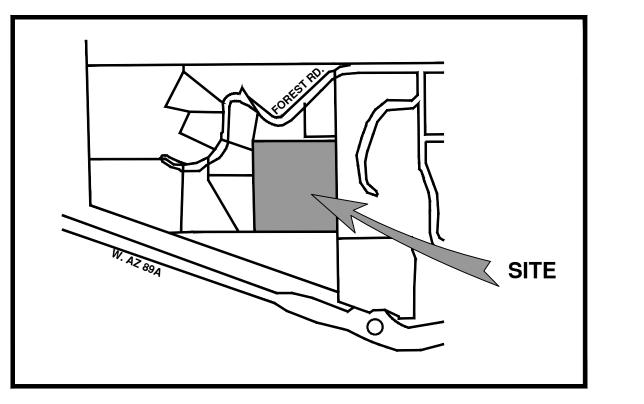

VICINITY MAP NOT TO SCALE

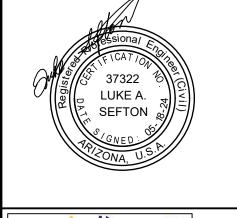



OWNER/DEVELOPER

CONTACT INFORMATION

741 FOREST ROAD, LLC

PO Box 3068, Sedona, AZ — 86336

Phone No. - 310 849 0812

email — davidhbowers@hotmail.com

ENGINEERING INFORMATION

SEFTON ENGINEERING

CONSULTANTS

40 STUTZ BEARCAT DR.

SEDONA, ARIZONA 86336

PHONE: (928) 202-3999 LUKE A. SEFTON, P.E. 37322


TIMOTHY HUSKETT, P.E. 58609

DRAWN BY: 05/18/2024

PROJECT NO:

Contact Arizona 811 at least two full working days before you begin excavatio Call 811 or click Arizona811.com

220219

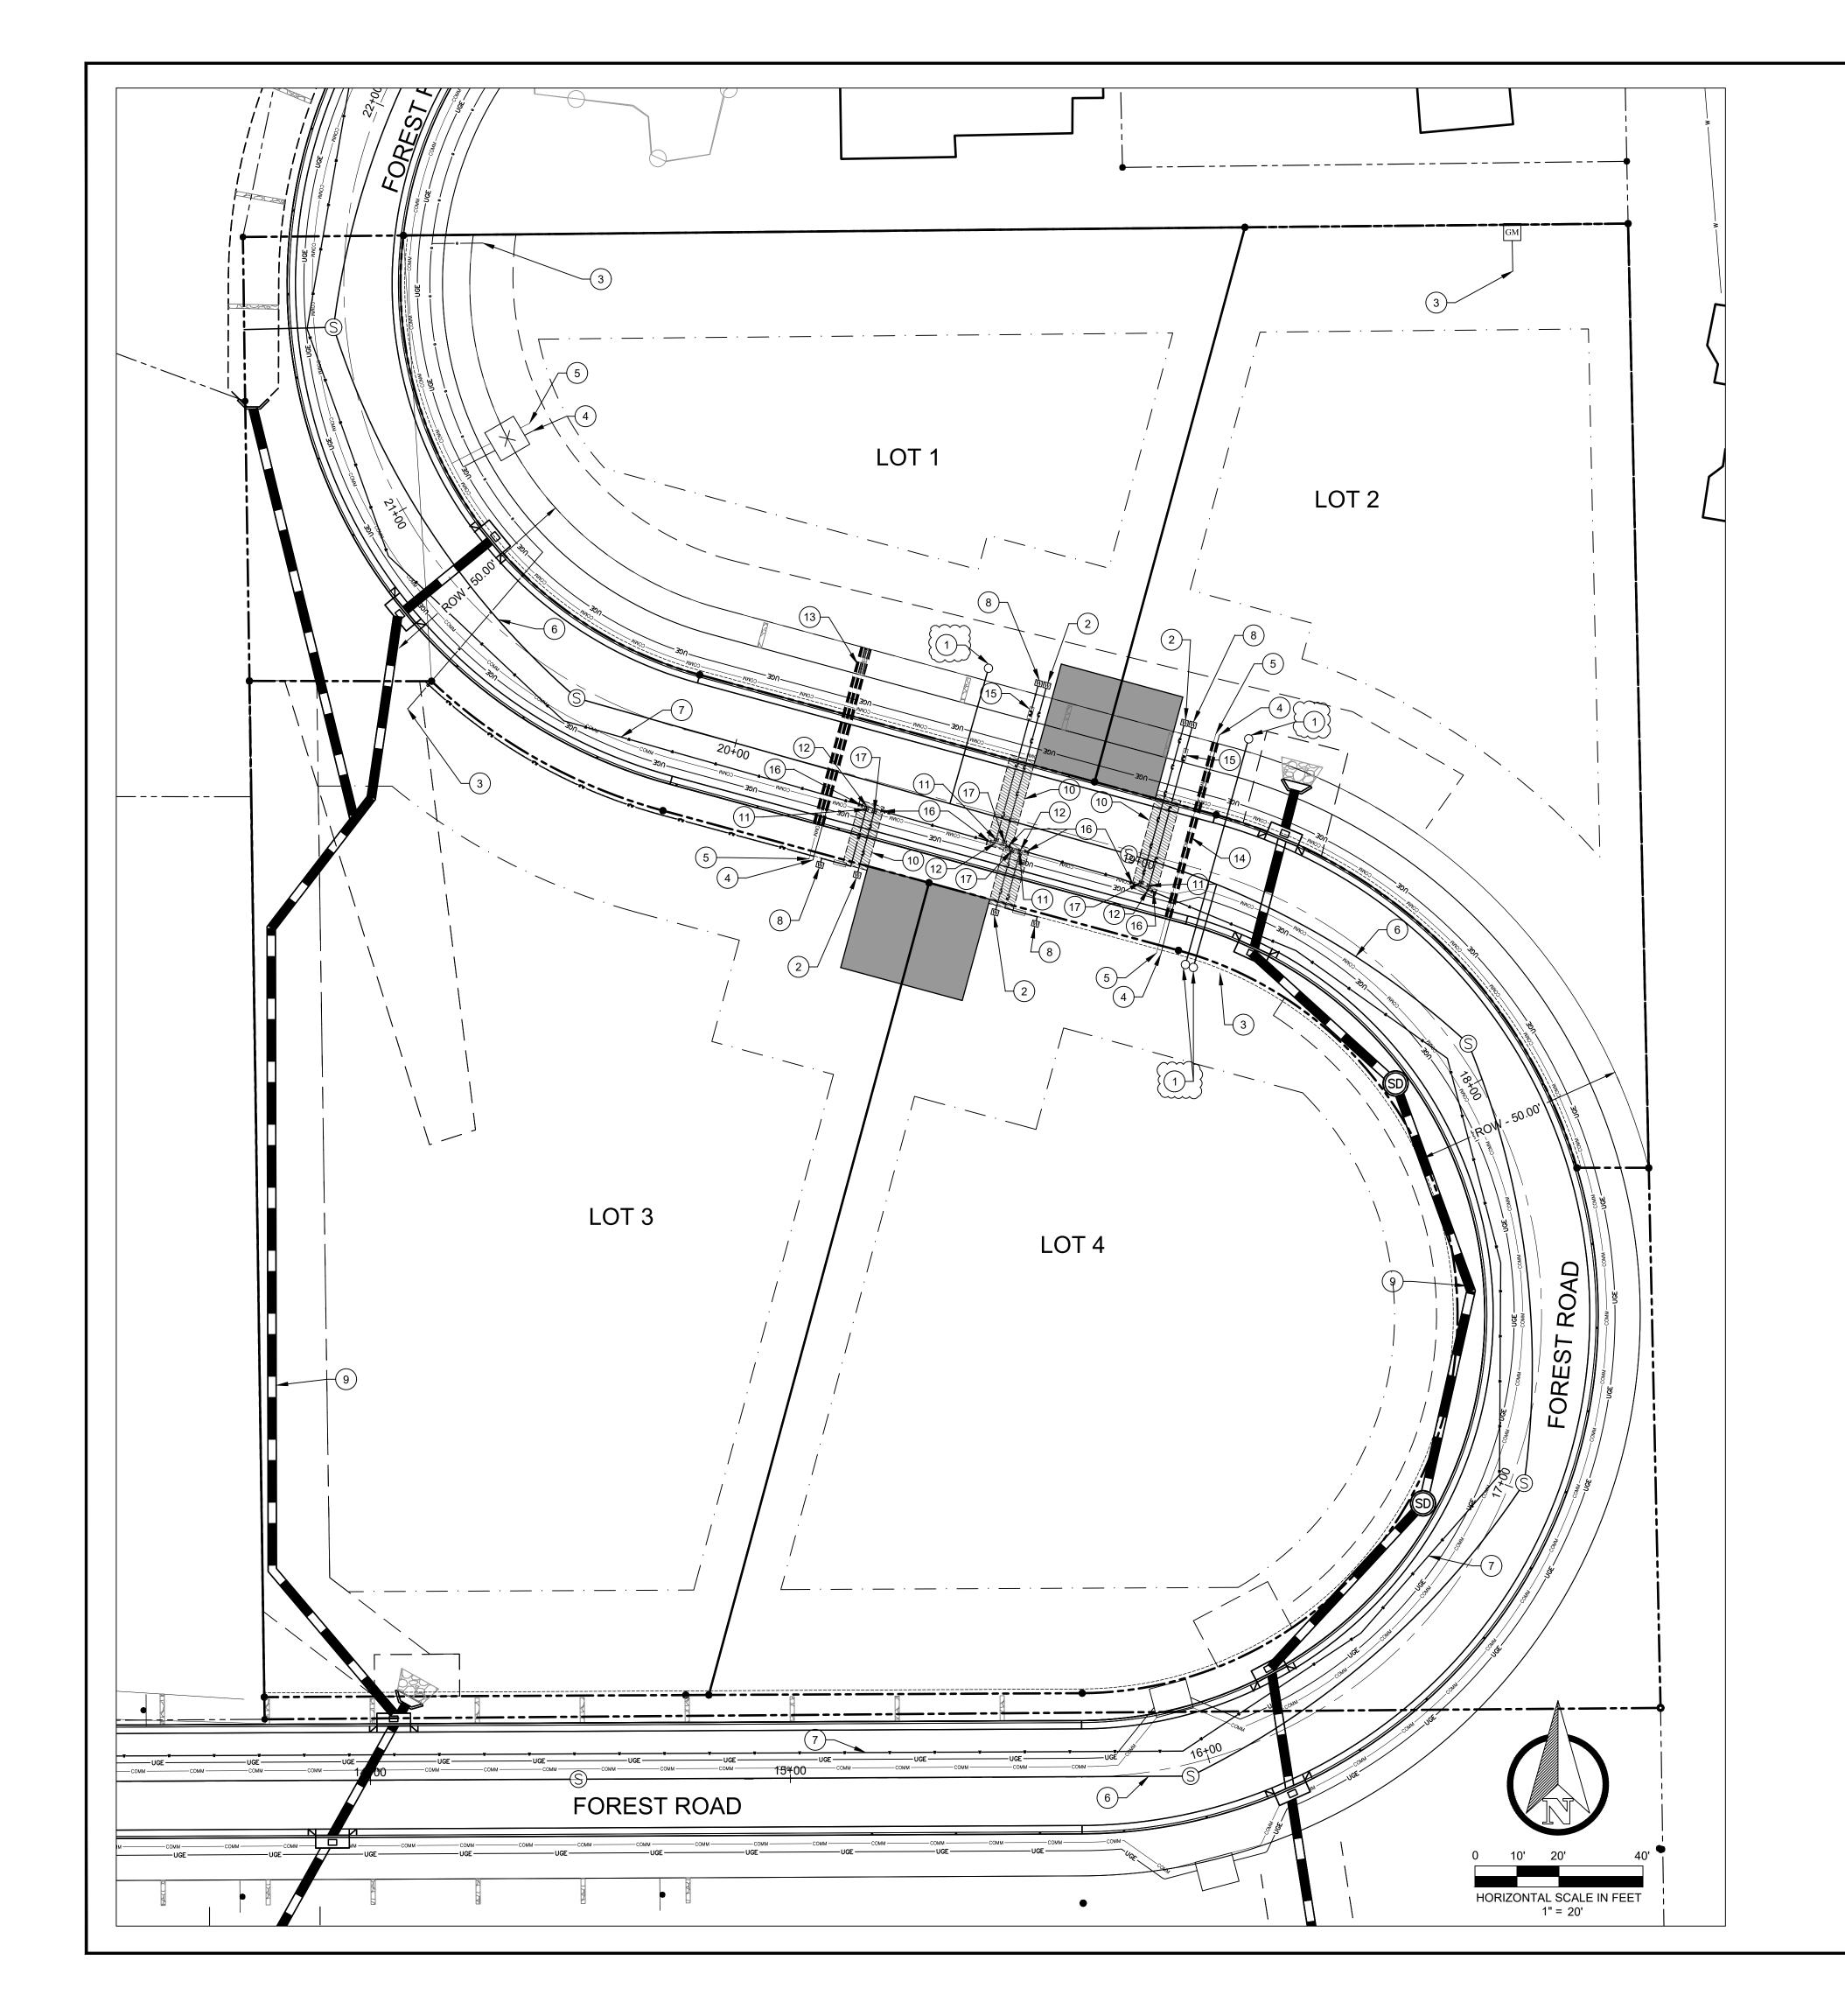

PROPOSED STORM SEWER LINE PROPOSED GAS LINE PROPOSED 16" DIP WATER SERVICE ROAD CENTERLINE PROPOSED 8" SANITARY SERVICE PARCEL BOUNDARY & RIGHT-OF-WAY LINE ______ 8"SS _____ PROPOSED EASEMENT LINE PROPOSED LOT LINE PROPOSED 6" SANITARY SERVICE BUILDING SETBACK LINE ______ 6"SS _____ PROPOSED 2" WATER SERVICE PROPOSED 6" FIRE LINE SERVICE

KEY NOTES: (PRIVATE)

_____2"W ______2"W _____

- 6" SEWER SERVICE LINE WITH CLEANOUT
- 2 INSTALL 2" SOFT TYPE "K" COPPER PIPE DOMESTIC WATER SERVICE AND 2" METER. METER NEED TO BE 2' OFF PROPERTY LINE. (PER AWC STD DTL E-9-11-1, SEE SHEET V-6) ADD 3" SLEEVE ON SERVICES. (FROM TIE IN POINT TO METER AWC SCOPE OF WORK)

----- 6"W -----

- 8 INSTALL 6" DIP CLASS 350 FIRE LINE WITH POLYWRAP. INSTALL CAPP ON 6" DIP PRIVATE CLASS 350 FIRE LINE PRIOR TO AWC ESTABLISHING WATER SERVICE. SEE SHEET V-6, DETAIL E-9-13-2. (FROM TIE IN POINT TO METER AWC SCOPE OF WORK)
- (10) WATER TRENCH (SEE SHEET V-6, DETAIL E-9-28-1)
- (11) INSTALL 6" GATE VALVE PER AWC STANDARD DETAIL E-9-2-1 & E-9-4-1
- (12) INSTALL 16" X 6" MJ TEE & VALVES FOR 6" FIRE LINE
- (13) 3 6" CONDUITS SPACED AT 1' CLEAR DISTANCE
- (14) 2 6" CONDUITS SPACED AT 1' CLEAR DISTANCE
- (15) INSTALL 6" APPROVED AND COMPLIANT BACK FLOW PREVENTION ASSEMBLY PER AWC STANDARD SEE DETAIL E-9-13-2 (SEE SHEET V-6) TO BE INSTALLED, MAINTAINED AND TESTED BY THE CUSTOMER. INSTALL THRUST BLOCK PER AWC STANDARD DETAIL E-9-5-1, SEE SHEET V-6
- (16) INSTALL 16" GATE VALVE PER AWC STANDARD DETAIL E-9-2-1 & E-9-4-1, SEE SHEET V-6
- (17) INSTALL 2" GATE VALVE PER AWC STANDARD DETAIL E-9-2-1 & E-9-4-1, SEE SHEET V-6

KEY NOTES: (PUBLIC)

- (3) GAS SERVICE LINE
- (4) UNDERGROUND ELECTRIC SERVICE
- (5) COMMUNICATION LINE
- (6) 8" SANITARY SEWER MAIN
- PROPOSED 16" DIP AWC WATER MAIN MUST BE IN SERVICE PRIOR TO SERVICE INSTALLATION (AWC SCOPE OF WORK)
- 9 PROPOSED STORM SEWER LINE






DRAWN BY: SCALE: 1" = 20' 05/18/2024

PROJECT NO: 220219

SHEET NO.

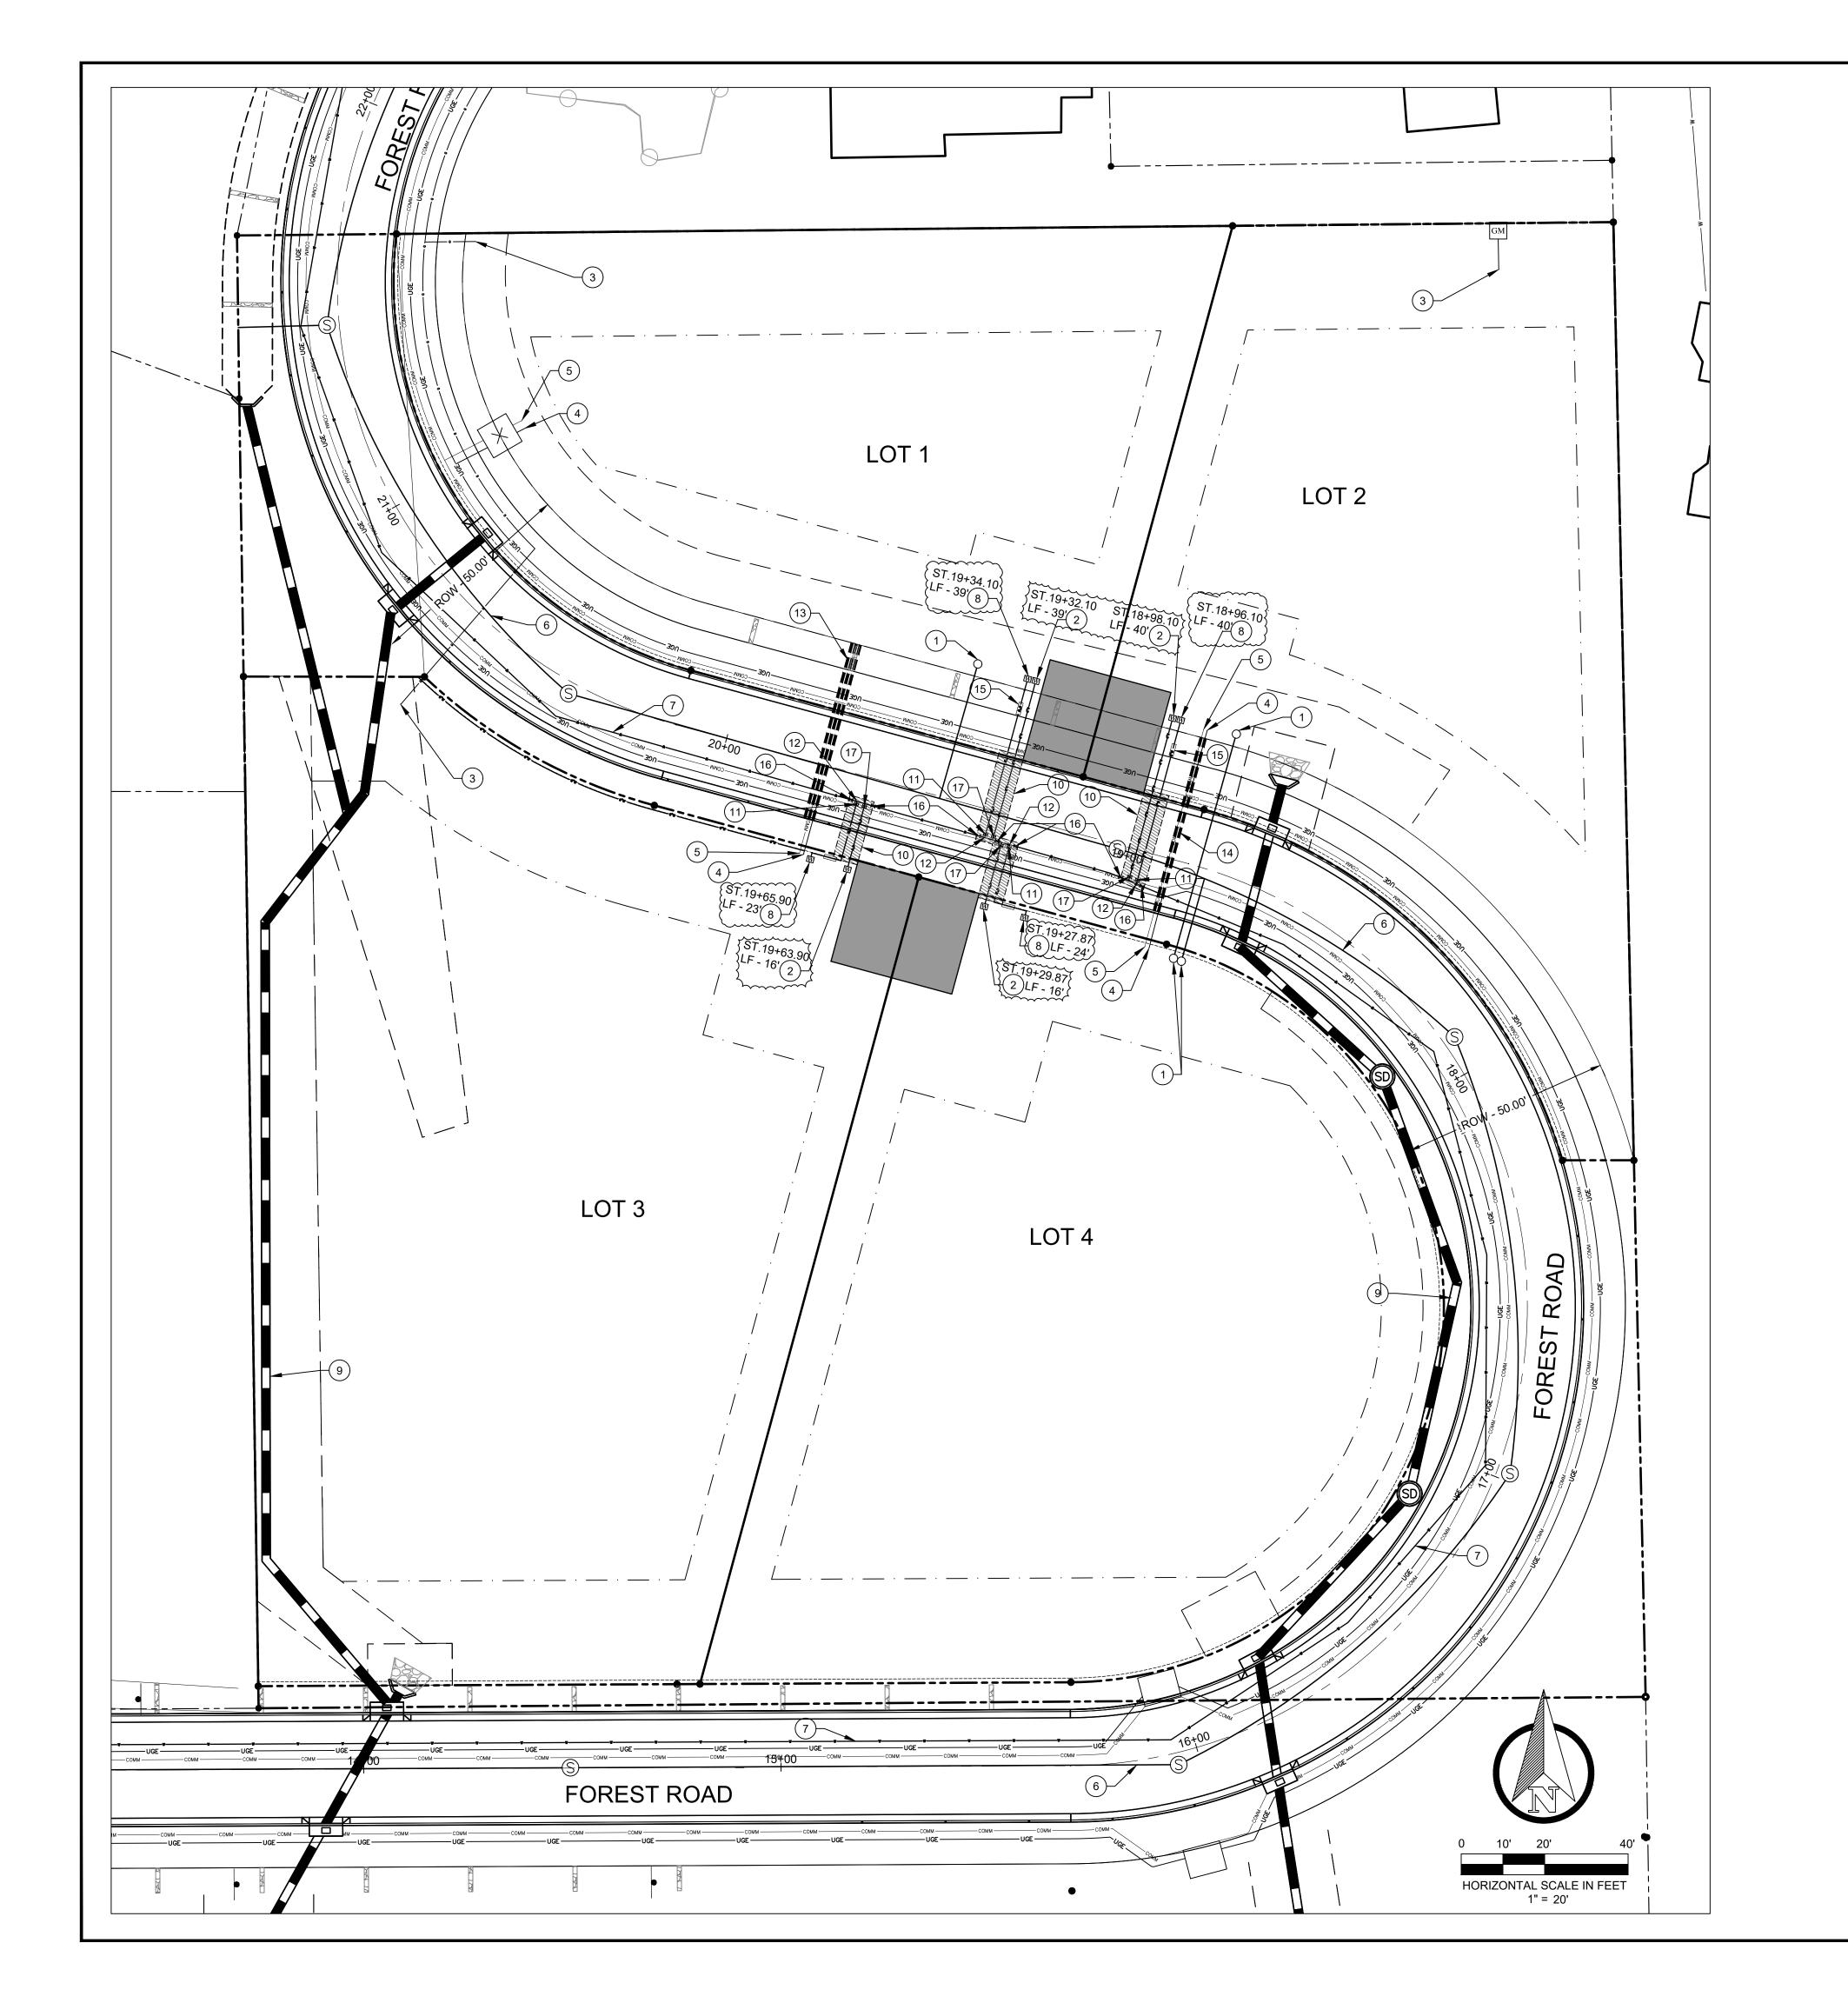

PROPOSED STORM SEWER LINE PROPOSED GAS LINE PROPOSED 16" DIP WATER SERVICE ROAD CENTERLINE PROPOSED 8" SANITARY SERVICE PARCEL BOUNDARY & RIGHT-OF-WAY LINE PROPOSED LOT LINE PROPOSED EASEMENT LINE PROPOSED 6" SANITARY SERVICE BUILDING SETBACK LINE ______ 6"SS ____

KEY NOTES: (PRIVATE)

PROPOSED 2" WATER SERVICE

_____2"W ______2"W _____


- (1) 6" SEWER SERVICE LINE WITH CLEANOUT
- INSTALL 2" SOFT TYPE "K" COPPER PIPE DOMESTIC WATER SERVICE AND 2" METER. METER NEED TO BE 2' OFF PROPERTY LINE. (PER AWC STD DTL E-9-11-1, SEE SHEET V-6) ADD 3" SLEEVE ON SERVICES. (FROM TIE IN POINT TO METER AWC SCOPE OF WORK)


PROPOSED 6" FIRE LINE SERVICE ----- 6"W -----

- (8) INSTALL 6" DIP CLASS 350 FIRE LINE WITH POLYWRAP. INSTALL CAPP ON 6" DIP PRIVATE CLASS 350 FIRE LINE PRIOR TO AWC ESTABLISHING WATER SERVICE. SEE SHEET V-6, DETAIL E-9-13-2. (FROM TIE IN POINT TO METER AWC SCOPE OF WORK)
- (10) WATER TRENCH (SEE SHEET V-6, DETAIL E-9-28-1)
- (11) INSTALL 6" GATE VALVE PER AWC STANDARD DETAIL E-9-2-1 & E-9-4-1
- (12) INSTALL 16" X 6" MJ TEE & VALVES FOR 6" FIRE LINE
- (13) 3 6" CONDUITS SPACED AT 1' CLEAR DISTANCE
- (14) 2 6" CONDUITS SPACED AT 1' CLEAR DISTANCE
- (15) INSTALL 6" APPROVED AND COMPLIANT BACK FLOW PREVENTION ASSEMBLY PER AWC STANDARD SEE DETAIL E-9-13-2 (SEE SHEET V-6) TO BE INSTALLED, MAINTAINED AND TESTED BY THE CUSTOMER. INSTALL THRUST BLOCK PER AWC STANDARD DETAIL E-9-5-1, SEE SHEET V-6
- (16) INSTALL 16" GATE VALVE PER AWC STANDARD DETAIL E-9-2-1 & E-9-4-1, SEE SHEET V-6
- (17) INSTALL 2" GATE VALVE PER AWC STANDARD DETAIL E-9-2-1 & E-9-4-1, SEE SHEET V-6

KEY NOTES: (PUBLIC)

- (3) GAS SERVICE LINE
- (4) UNDERGROUND ELECTRIC SERVICE
- (5) COMMUNICATION LINE
- 6) 8" SANITARY SEWER MAIN
- PROPOSED 16" DIP AWC WATER MAIN MUST BE IN SERVICE PRIOR TO SERVICE INSTALLATION (AWC SCOPE OF WORK)
- 9 PROPOSED STORM SEWER LINE

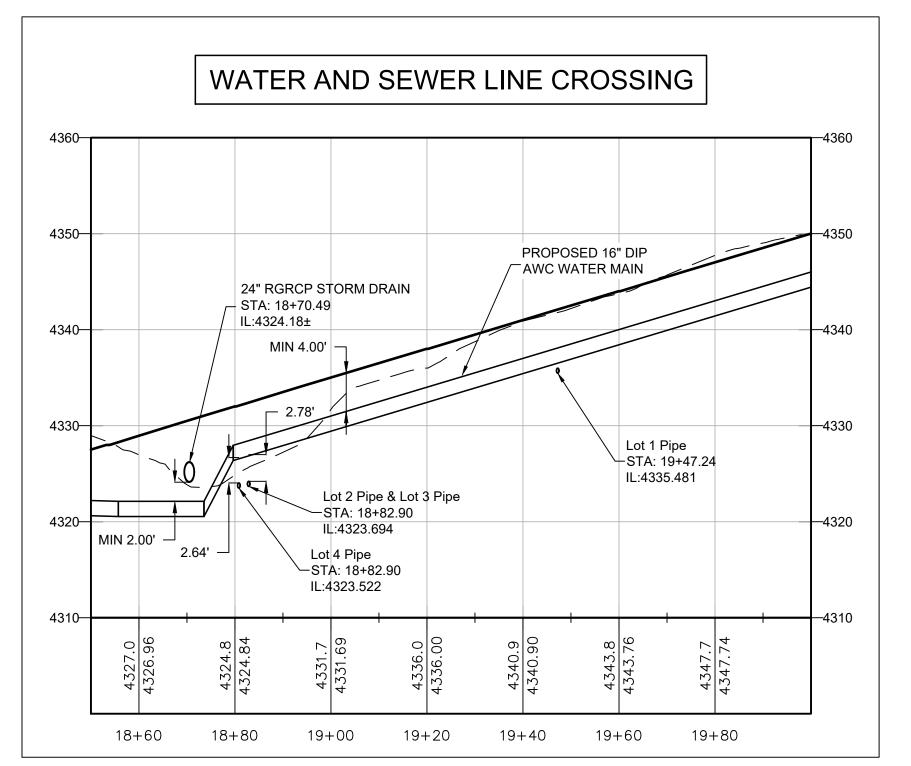

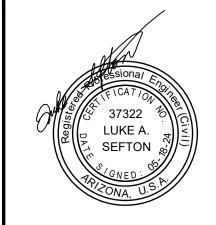




WATER HOOK UP LO

DRAWN BY: SSS SCALE: 1" = 20' 05/18/2024 PROJECT NO: 220219

SHEET NO.

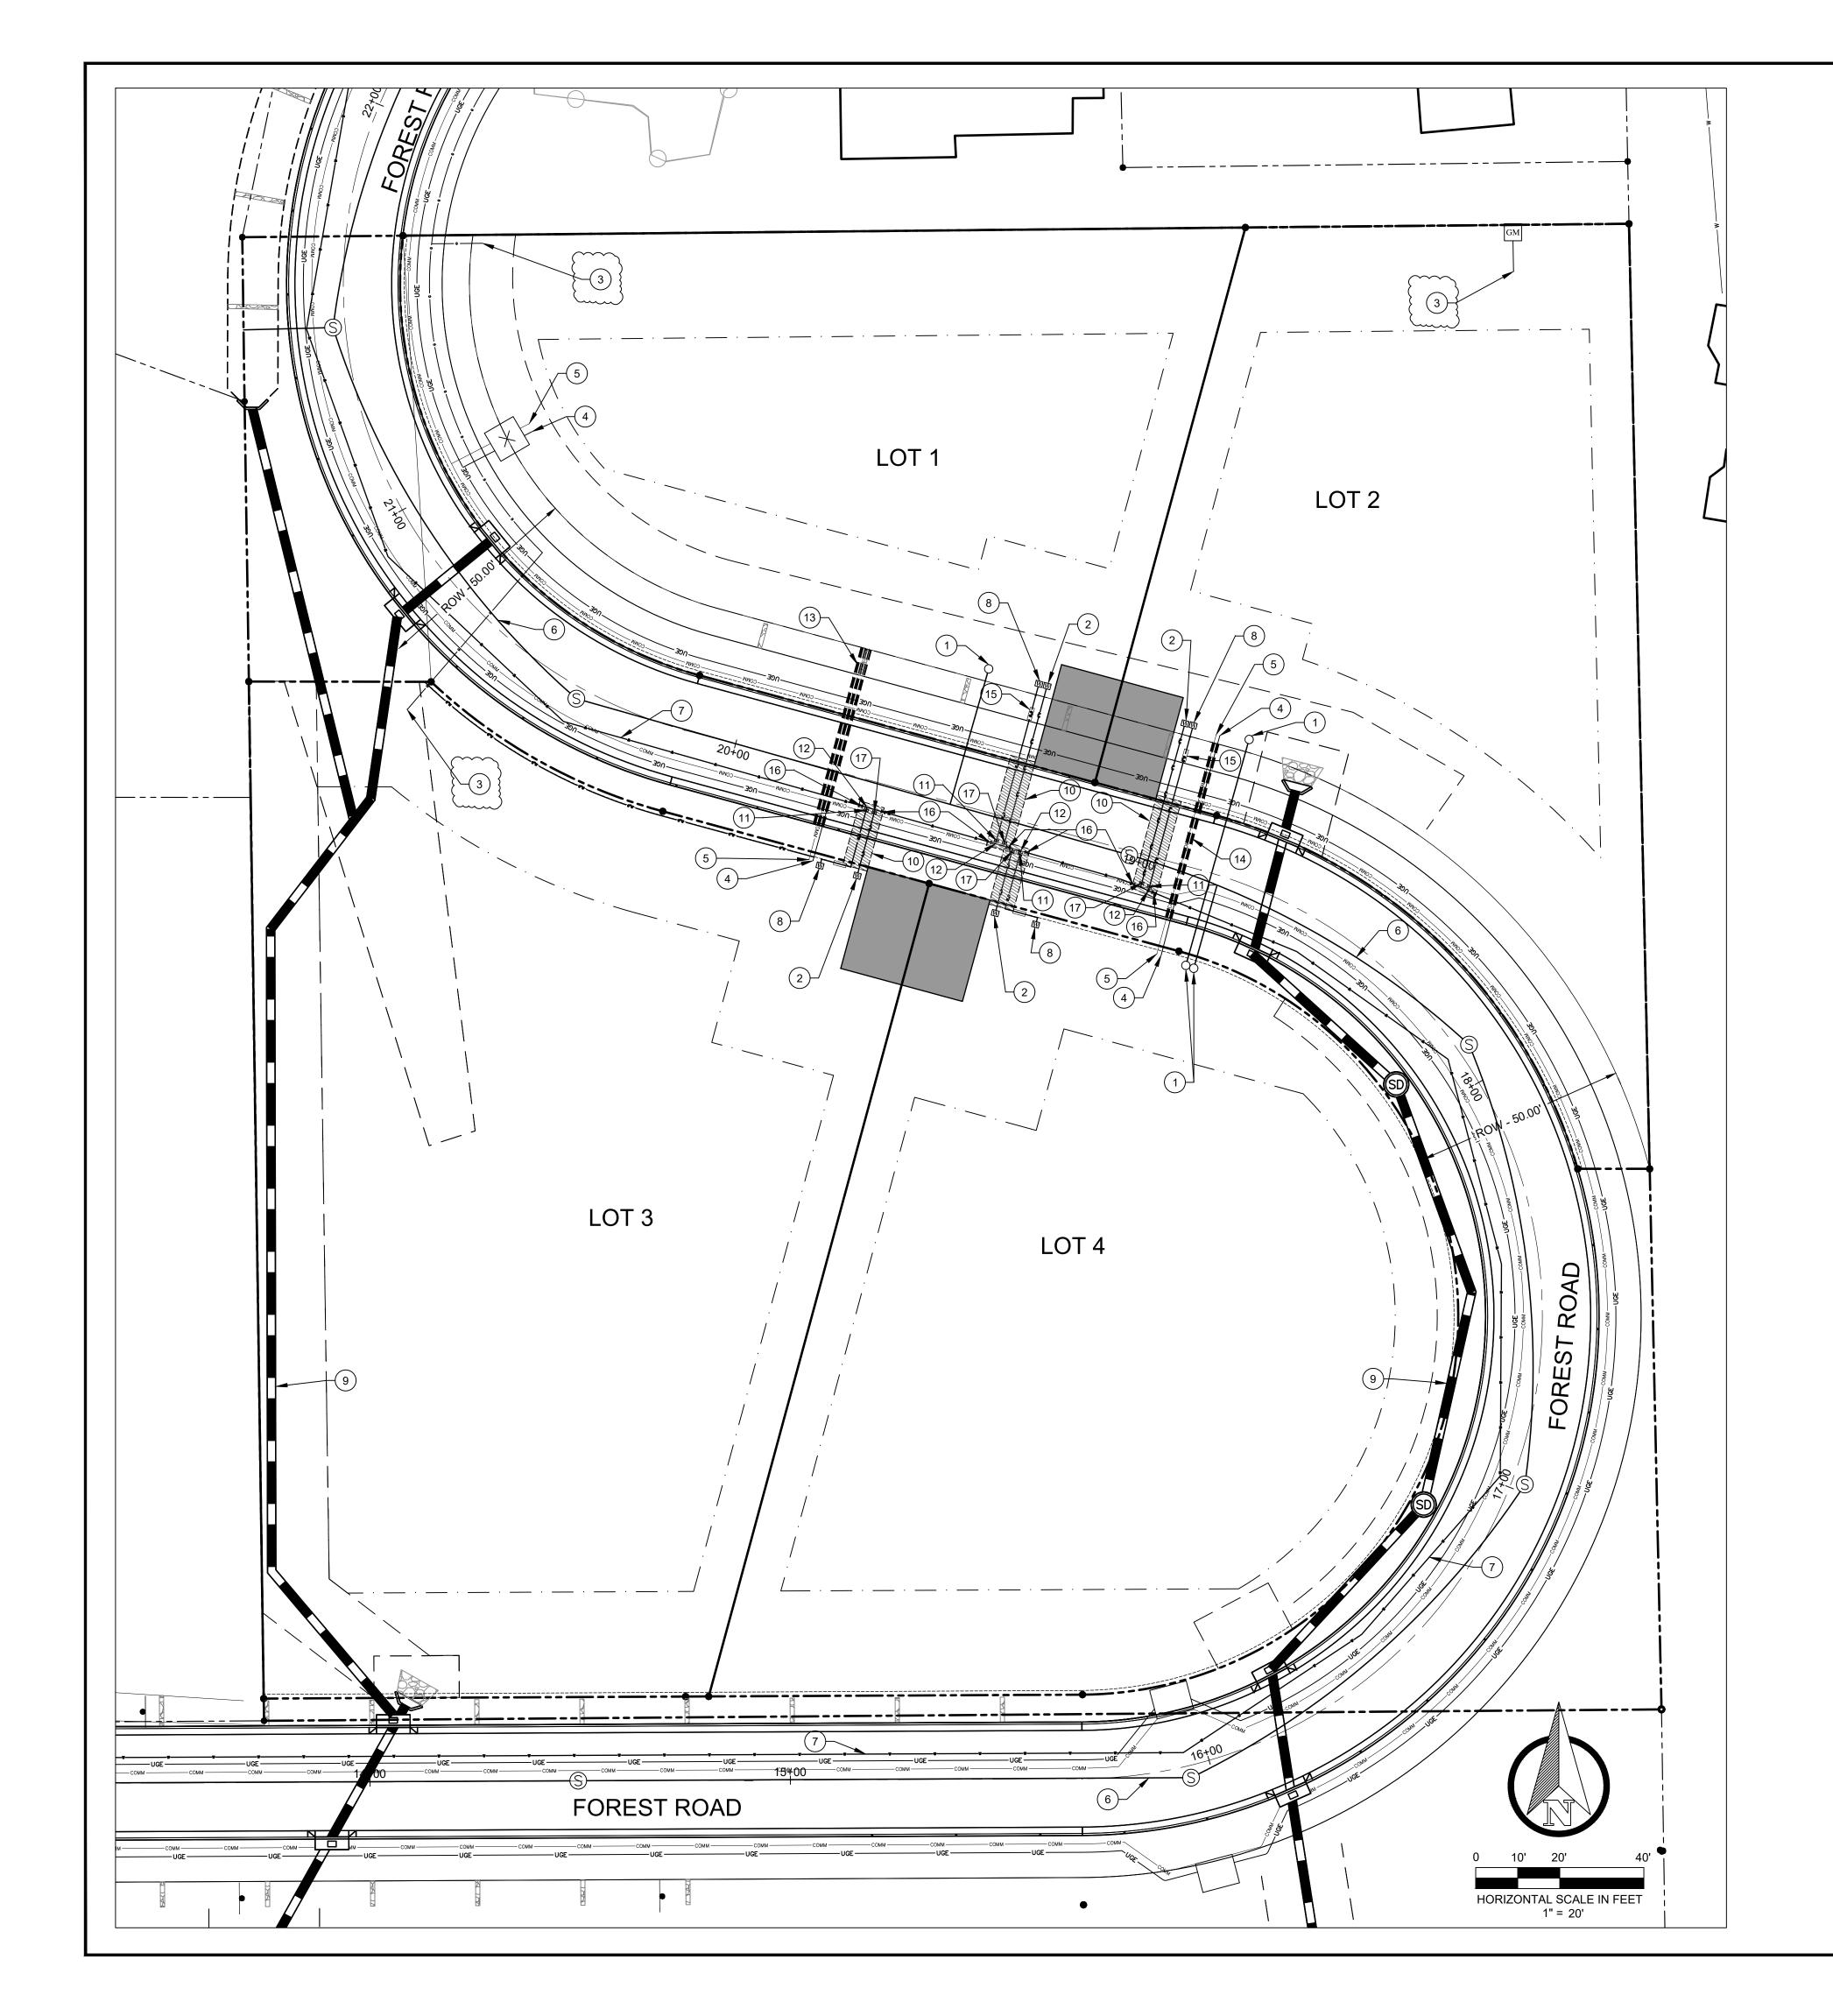

PROPOSED STORM SEWER LINE PROPOSED GAS LINE PROPOSED 16" DIP WATER SERVICE ROAD CENTERLINE PROPOSED 8" SANITARY SERVICE PARCEL BOUNDARY & RIGHT-OF-WAY LINE ______ 8"SS _____ PROPOSED EASEMENT LINE PROPOSED LOT LINE PROPOSED 6" SANITARY SERVICE BUILDING SETBACK LINE ______ 6"SS _____ PROPOSED 2" WATER SERVICE PROPOSED 6" FIRE LINE SERVICE ----- 6"W -----_____2"W ______2"W _____


KEY NOTES: (PRIVATE)

- (1) 6" SEWER SERVICE LINE WITH CLEANOUT
- 2 INSTALL 2" SOFT TYPE "K" COPPER PIPE DOMESTIC WATER SERVICE AND 2" METER. METER NEED TO BE 2' OFF PROPERTY LINE. (PER AWC STD DTL E-9-11-1, SEE SHEET V-6) ADD 3" SLEEVE ON SERVICES. (FROM TIE IN POINT TO METER AWC SCOPE OF WORK)
- 8 INSTALL 6" DIP CLASS 350 FIRE LINE WITH POLYWRAP. INSTALL CAPP ON 6" DIP PRIVATE CLASS 350 FIRE LINE PRIOR TO AWC ESTABLISHING WATER SERVICE. SEE SHEET V-6, DETAIL E-9-13-2. (FROM TIE IN POINT TO METER AWC SCOPE OF WORK)
- (10) WATER TRENCH (SEE SHEET V-6, DETAIL E-9-28-1)
- (11) INSTALL 6" GATE VALVE PER AWC STANDARD DETAIL E-9-2-1 & E-9-4-1
- (12) INSTALL 16" X 6" MJ TEE & VALVES FOR 6" FIRE LINE
- (13) 3 6" CONDUITS SPACED AT 1' CLEAR DISTANCE
- (14) 2 6" CONDUITS SPACED AT 1' CLEAR DISTANCE
- (15) INSTALL 6" APPROVED AND COMPLIANT BACK FLOW PREVENTION ASSEMBLY PER AWC STANDARD SEE DETAIL E-9-13-2 (SEE SHEET V-6) TO BE INSTALLED, MAINTAINED AND TESTED BY THE CUSTOMER. INSTALL THRUST BLOCK PER AWC STANDARD DETAIL E-9-5-1, SEE SHEET V-6
- (16) INSTALL 16" GATE VALVE PER AWC STANDARD DETAIL E-9-2-1 & E-9-4-1, SEE SHEET V-6
- (17) INSTALL 2" GATE VALVE PER AWC STANDARD DETAIL E-9-2-1 & E-9-4-1, SEE SHEET V-6

KEY NOTES: (PUBLIC)

(3) GAS SERVICE LINE

- (4) UNDERGROUND ELECTRIC SERVICE
- (5) COMMUNICATION LINE
- 6 8" SANITARY SEWER MAIN
- 7 PROPOSED 16" DIP AWC WATER MAIN MUST BE IN SERVICE PRIOR TO SERVICE INSTALLATION (AWC SCOPE OF WORK)
- 9 PROPOSED STORM SEWER LINE

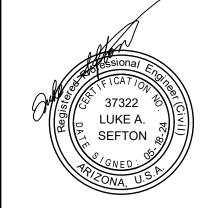




GAS HOOK UP LOC

DRAWN BY:

SCALE: 1" = 20' 05/18/2024

PROJECT NO: 220219

SHEET NO.

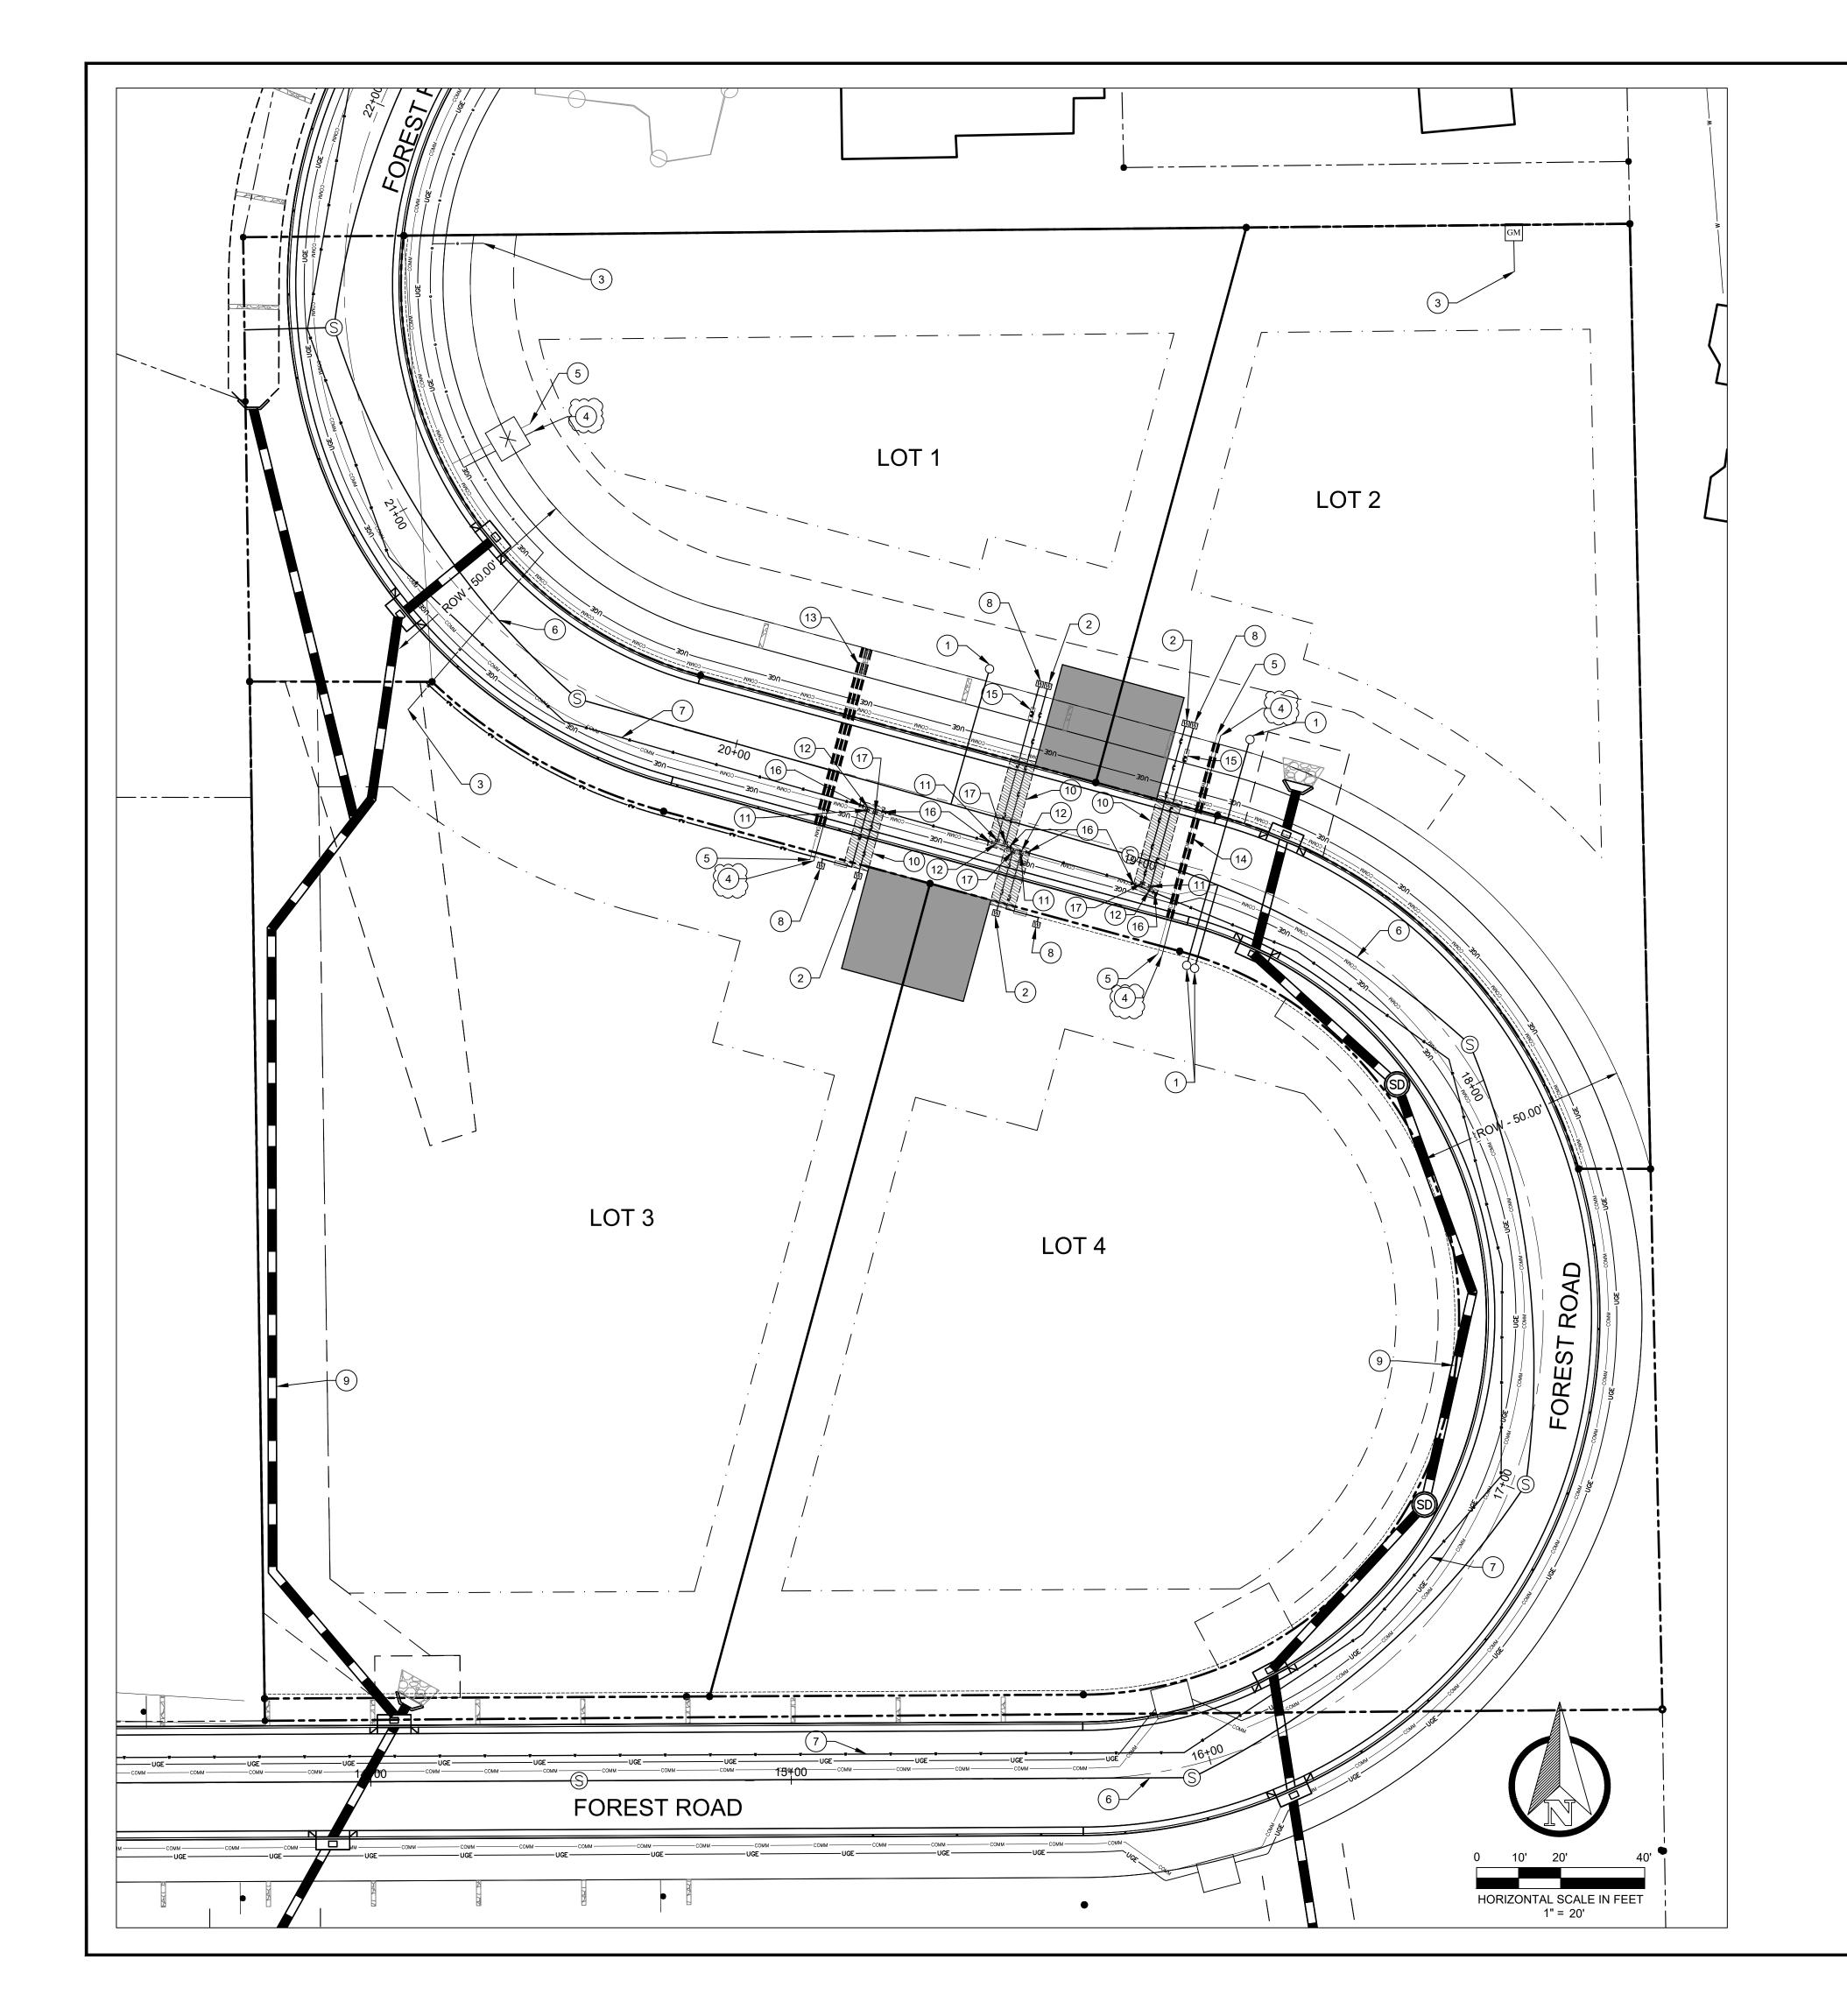

PROPOSED STORM SEWER LINE PROPOSED GAS LINE PROPOSED 16" DIP WATER SERVICE ROAD CENTERLINE PROPOSED 8" SANITARY SERVICE PARCEL BOUNDARY & RIGHT-OF-WAY LINE ______ 8"SS _____ PROPOSED EASEMENT LINE PROPOSED LOT LINE PROPOSED 6" SANITARY SERVICE BUILDING SETBACK LINE ______ 6"SS _____ PROPOSED 2" WATER SERVICE PROPOSED 6" FIRE LINE SERVICE ----- 6"W -----_____2"W ______2"W _____

KEY NOTES: (PRIVATE)

- 1) 6" SEWER SERVICE LINE WITH CLEANOUT
- 2 INSTALL 2" SOFT TYPE "K" COPPER PIPE DOMESTIC WATER SERVICE AND 2" METER. METER NEED TO BE 2' OFF PROPERTY LINE. (PER AWC STD DTL E-9-11-1, SEE SHEET V-6) ADD 3" SLEEVE ON SERVICES. (FROM TIE IN POINT TO METER AWC SCOPE OF WORK)
- 8 INSTALL 6" DIP CLASS 350 FIRE LINE WITH POLYWRAP. INSTALL CAPP ON 6" DIP PRIVATE CLASS 350 FIRE LINE PRIOR TO AWC ESTABLISHING WATER SERVICE. SEE SHEET V-6, DETAIL E-9-13-2. (FROM TIE IN POINT TO METER AWC SCOPE OF WORK)
- (10) WATER TRENCH (SEE SHEET V-6, DETAIL E-9-28-1)
- (11) INSTALL 6" GATE VALVE PER AWC STANDARD DETAIL E-9-2-1 & E-9-4-1
- (12) INSTALL 16" X 6" MJ TEE & VALVES FOR 6" FIRE LINE
- (13) 3 6" CONDUITS SPACED AT 1' CLEAR DISTANCE
- (14) 2 6" CONDUITS SPACED AT 1' CLEAR DISTANCE
- (15) INSTALL 6" APPROVED AND COMPLIANT BACK FLOW PREVENTION ASSEMBLY PER AWC STANDARD SEE DETAIL E-9-13-2 (SEE SHEET V-6) TO BE INSTALLED, MAINTAINED AND TESTED BY THE CUSTOMER. INSTALL THRUST BLOCK PER AWC STANDARD DETAIL E-9-5-1, SEE SHEET V-6
- (16) INSTALL 16" GATE VALVE PER AWC STANDARD DETAIL E-9-2-1 & E-9-4-1, SEE SHEET V-6
- (17) INSTALL 2" GATE VALVE PER AWC STANDARD DETAIL E-9-2-1 & E-9-4-1, SEE SHEET V-6

KEY NOTES: (PUBLIC)

- (3) GAS SERVICE LINE
- (4) UNDERGROUND ELECTRIC SERVICE
- (5) COMMUNICATION LINE
- 6 8" SANITARY SEWER MAIN
- 7 PROPOSED 16" DIP AWC WATER MAIN MUST BE IN SERVICE PRIOR TO SERVICE INSTALLATION (AWC SCOPE OF WORK)
- 9 PROPOSED STORM SEWER LINE






APS HOOK UP LOC

DRAWN BY: SCALE: 1" = 20' 05/18/2024

PROJECT NO: 220219 SHEET NO.

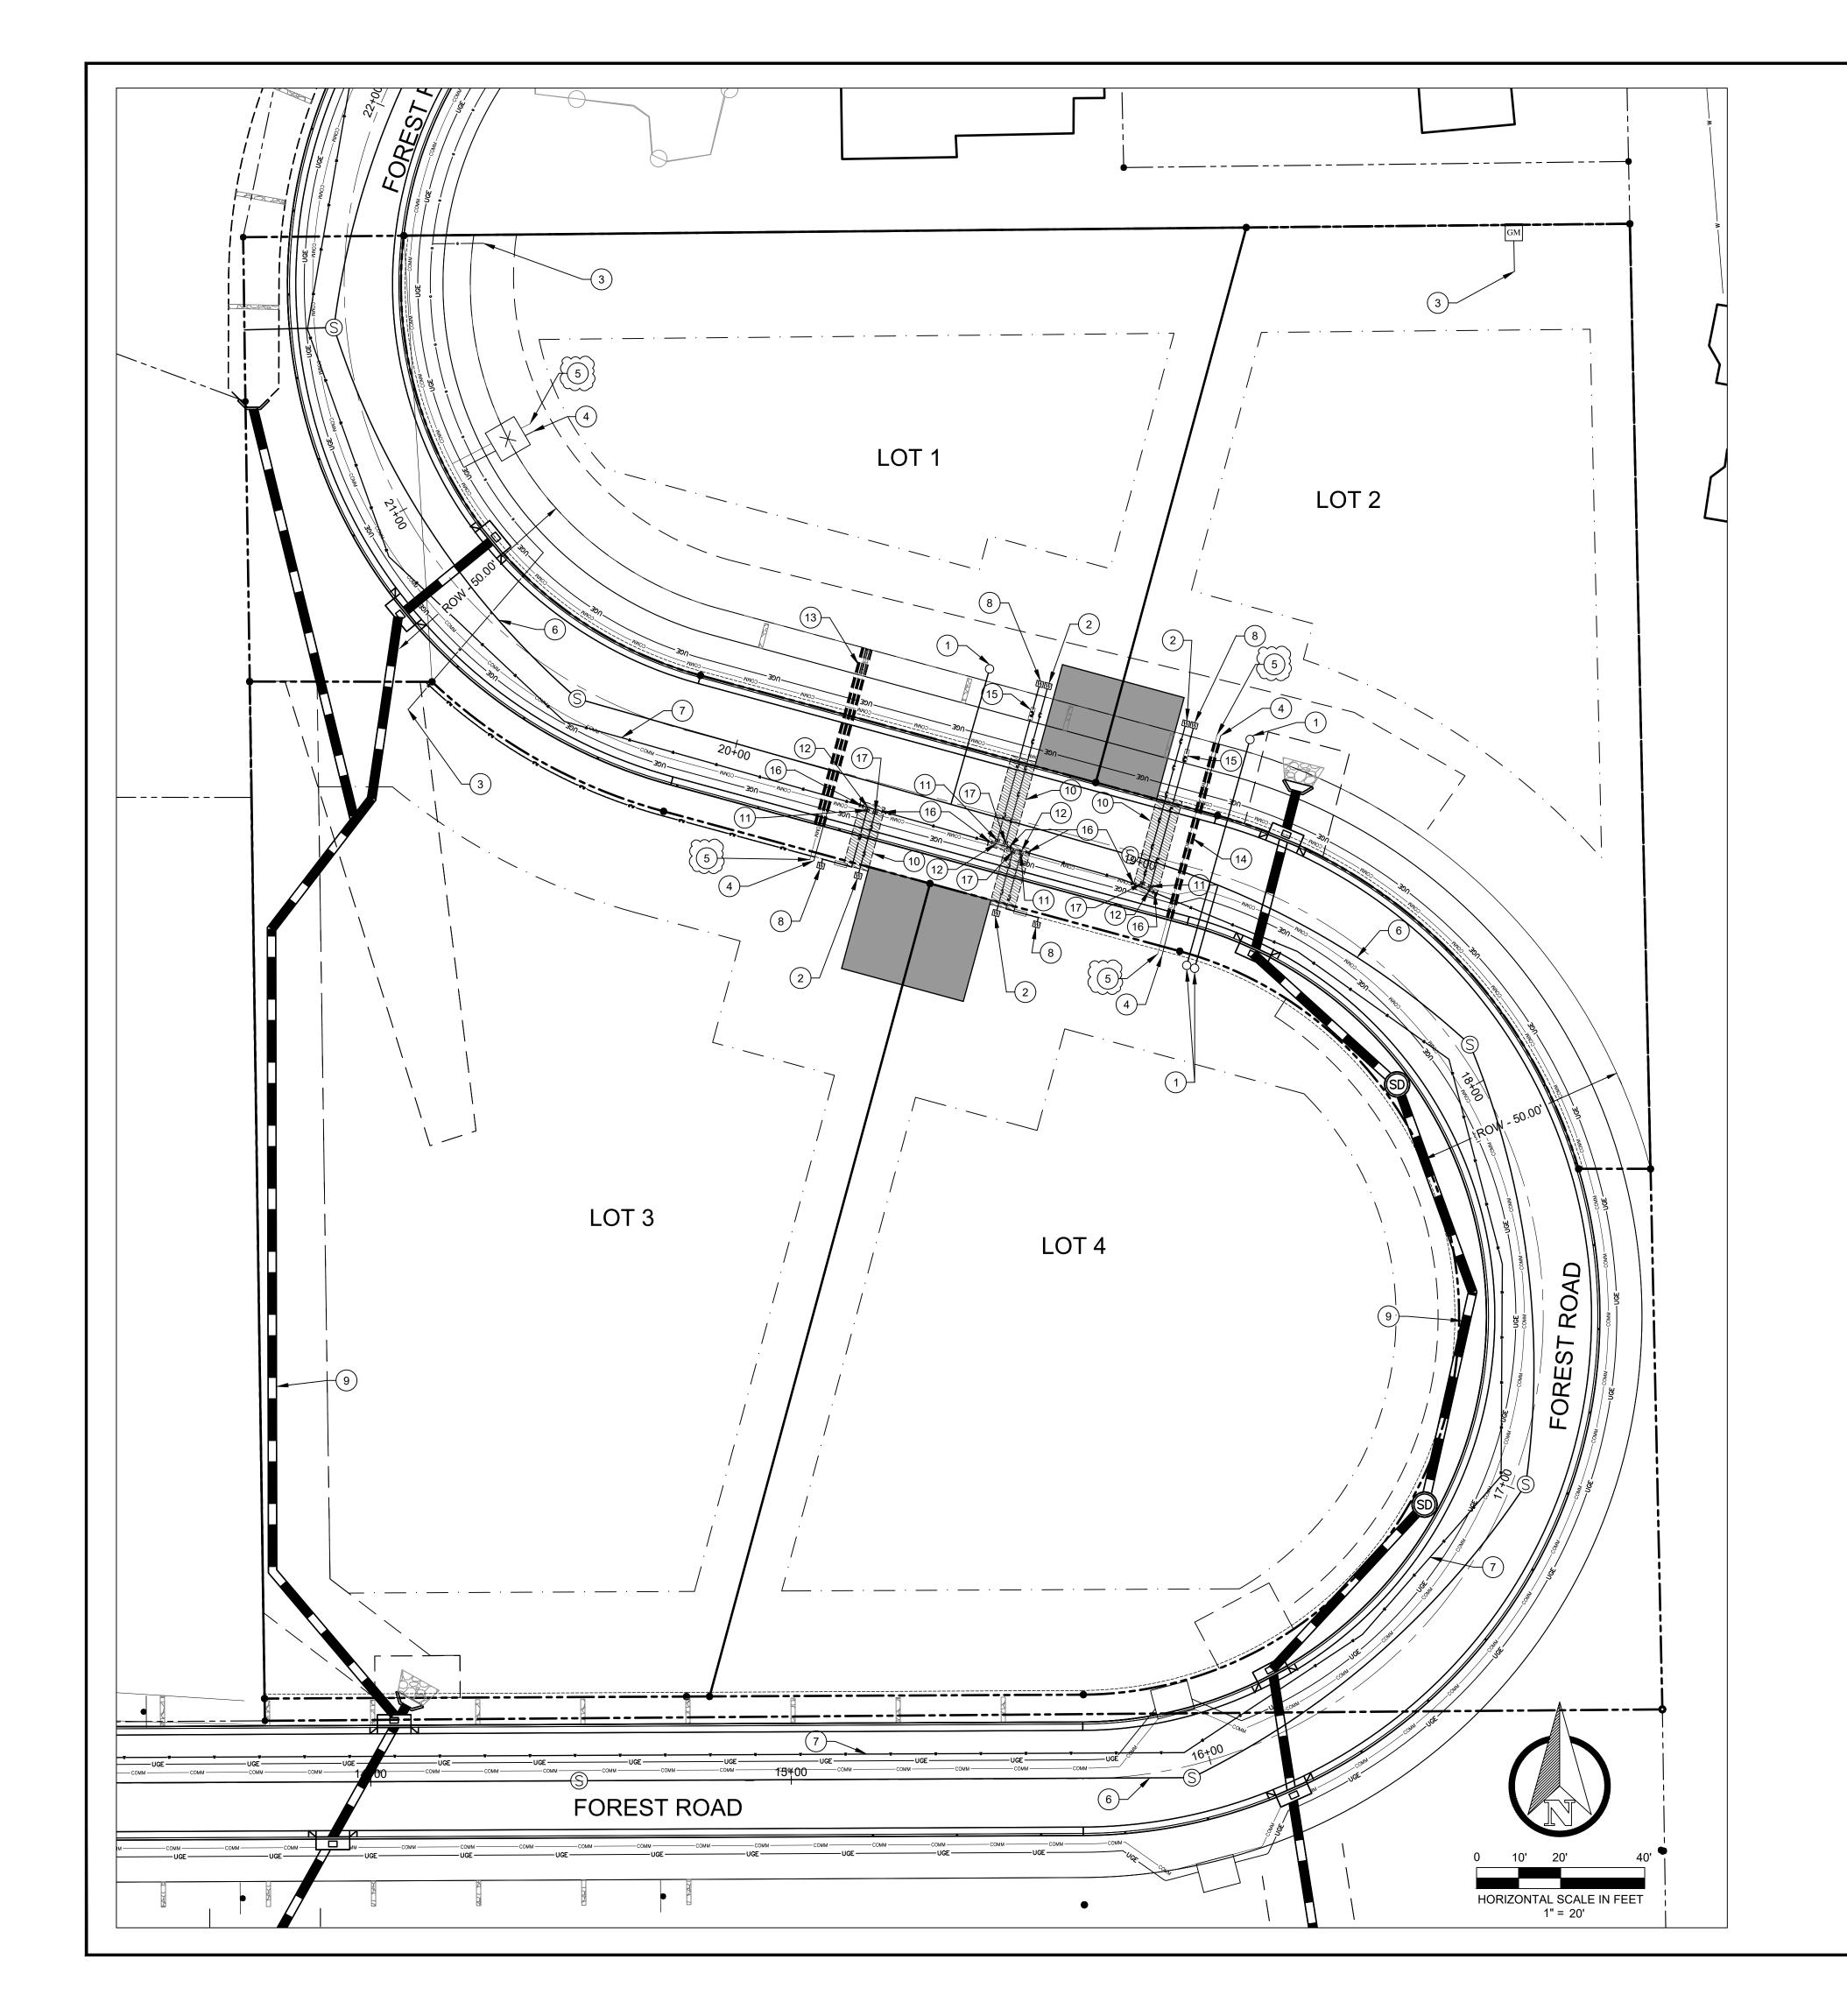

PROPOSED STORM SEWER LINE

PROPOSED GAS LINE

ROAD CENTERLINE

PROPOSED 8" SANITARY SERVICE

PROPOSED 8" SANITARY SERVICE

PROPOSED EASEMENT LINE

BUILDING SETBACK LINE

PROPOSED 6" SANITARY SERVICE

PROPOSED 6" SANITARY SERVICE

PROPOSED 6" FIRE LINE SERVICE

KEY NOTES: (PRIVATE)

(1) 6" SEWER SERVICE LINE WITH CLEANOUT

_____2"W ______2"W _____

2 INSTALL 2" SOFT TYPE "K" COPPER PIPE DOMESTIC WATER SERVICE AND 2" METER. METER NEED TO BE 2' OFF PROPERTY LINE. (PER AWC STD DTL E-9-11-1, SEE SHEET V-6) ADD 3" SLEEVE ON SERVICES. (FROM TIE IN POINT TO METER AWC SCOPE OF WORK)

----- 6"W -----

- 8 INSTALL 6" DIP CLASS 350 FIRE LINE WITH POLYWRAP. INSTALL CAPP ON 6" DIP PRIVATE CLASS 350 FIRE LINE PRIOR TO AWC ESTABLISHING WATER SERVICE. SEE SHEET V-6, DETAIL E-9-13-2. (FROM TIE IN POINT TO METER AWC SCOPE OF WORK)
- (10) WATER TRENCH (SEE SHEET V-6, DETAIL E-9-28-1)
- (11) INSTALL 6" GATE VALVE PER AWC STANDARD DETAIL E-9-2-1 & E-9-4-1
- (12) INSTALL 16" X 6" MJ TEE & VALVES FOR 6" FIRE LINE
- (13) 3 6" CONDUITS SPACED AT 1' CLEAR DISTANCE
- (14) 2 6" CONDUITS SPACED AT 1' CLEAR DISTANCE
- (15) INSTALL 6" APPROVED AND COMPLIANT BACK FLOW PREVENTION ASSEMBLY PER AWC STANDARD SEE DETAIL E-9-13-2 (SEE SHEET V-6) TO BE INSTALLED, MAINTAINED AND TESTED BY THE CUSTOMER. INSTALL THRUST BLOCK PER AWC STANDARD DETAIL E-9-5-1, SEE SHEET V-6
- (16) INSTALL 16" GATE VALVE PER AWC STANDARD DETAIL E-9-2-1 & E-9-4-1, SEE SHEET V-6
- (17) INSTALL 2" GATE VALVE PER AWC STANDARD DETAIL E-9-2-1 & E-9-4-1, SEE SHEET V-6

KEY NOTES: (PUBLIC)

- (3) GAS SERVICE LINE
- 4) UNDERGROUND ELECTRIC SERVICE
- (5) COMMUNICATION LINE
- 6 8" SANITARY SEWER MAIN
- 7 PROPOSED 16" DIP AWC WATER MAIN MUST BE IN SERVICE PRIOR TO SERVICE INSTALLATION (AWC SCOPE OF WORK)
- 9 PROPOSED STORM SEWER LINE





Your Id

Z21-0002 2

EDONA, AZ

SEDONA

PROJECT TITLE:

COMMUNICATION HOOK

PROJECT NO: 220219

SHEET NO.